

# CITY OF ALBUQUERQUE

Planning Department

Suzanne Lubar, Director



Mayor Richard J. Berry

March 29, 2016

David Soule, P.E.  
Rio Grande Engineering  
PO Box 93924  
Albuquerque, New Mexico 87199

RE: **Las Ventanas at San Isidro**  
**3735 San Isidro NW**  
**Grading and Drainage Plan**  
**Engineers Stamp Date 3/23/16 (G13D031)**

Dear Mr. Soule,

PO Box 1293

Based upon the information provided in your submittal received 3/24/16, this plan is approved for Grading Permit and Building Permit.

Albuquerque

Please inform the owner/contractor to attach a copy of this approved plan to the construction sets in the permitting process prior to sign-off by Hydrology.

New Mexico 87103

Prior to Certificate of Occupancy release, Engineer Certification per the DPM checklist will be required.

[www.cabq.gov](http://www.cabq.gov)

If you have any questions, please contact me at 924-3986 or Rudy Rael at 924-3977.

Sincerely,

Abiel Carrillo, P.E.  
Principal Engineer, Hydrology  
Planning Department

RR/AC  
C: File



# City of Albuquerque

Planning Department

Development & Building Services Division

## DRAINAGE AND TRANSPORTATION INFORMATION SHEET (REV 09/2015)

**Project Title:** \_\_\_\_\_ **Building Permit #:** \_\_\_\_\_ **City Drainage #:** \_\_\_\_\_

**DRB#:** \_\_\_\_\_ **EPC#:** \_\_\_\_\_ **Work Order#:** \_\_\_\_\_

**Legal Description:** \_\_\_\_\_

**City Address:** \_\_\_\_\_

**Engineering Firm:** \_\_\_\_\_ **Contact:** \_\_\_\_\_

**Address:** \_\_\_\_\_

**Phone#:** \_\_\_\_\_ **Fax#:** \_\_\_\_\_ **E-mail:** \_\_\_\_\_

**Owner:** \_\_\_\_\_ **Contact:** \_\_\_\_\_

**Address:** \_\_\_\_\_

**Phone#:** \_\_\_\_\_ **Fax#:** \_\_\_\_\_ **E-mail:** \_\_\_\_\_

**Architect:** \_\_\_\_\_ **Contact:** \_\_\_\_\_

**Address:** \_\_\_\_\_

**Phone#:** \_\_\_\_\_ **Fax#:** \_\_\_\_\_ **E-mail:** \_\_\_\_\_

**Other Contact:** \_\_\_\_\_ **Contact:** \_\_\_\_\_

**Address:** \_\_\_\_\_

**Phone#:** \_\_\_\_\_ **Fax#:** \_\_\_\_\_ **E-mail:** \_\_\_\_\_

Check all that Apply:

**DEPARTMENT:**

- ☐ HYDROLOGY/ DRAINAGE  
☐ TRAFFIC/ TRANSPORTATION  
☐ MS4/ EROSION & SEDIMENT CONTROL

**TYPE OF SUBMITTAL:**

- ☐ ENGINEER/ ARCHITECT CERTIFICATION
- ☐ CONCEPTUAL G & D PLAN  
☐ GRADING PLAN  
☐ DRAINAGE MASTER PLAN  
☐ DRAINAGE REPORT  
☐ CLOMR/LOMR
- ☐ TRAFFIC CIRCULATION LAYOUT (TCL)  
☐ TRAFFIC IMPACT STUDY (TIS)  
☐ EROSION & SEDIMENT CONTROL PLAN (ESC)
- ☐ OTHER (SPECIFY) \_\_\_\_\_

**CHECK TYPE OF APPROVAL/ACCEPTANCE SOUGHT:**

- ☐ BUILDING PERMIT APPROVAL  
☐ CERTIFICATE OF OCCUPANCY
- ☐ PRELIMINARY PLAT APPROVAL  
☐ SITE PLAN FOR SUB'D APPROVAL  
☐ SITE PLAN FOR BLDG. PERMIT APPROVAL  
☐ FINAL PLAT APPROVAL  
☐ SIA/ RELEASE OF FINANCIAL GUARANTEE  
☐ FOUNDATION PERMIT APPROVAL  
☐ GRADING PERMIT APPROVAL  
☐ SO-19 APPROVAL  
☐ PAVING PERMIT APPROVAL  
☐ GRADING/ PAD CERTIFICATION  
☐ WORK ORDER APPROVAL  
☐ CLOMR/LOMR
- ☐ PRE-DESIGN MEETING  
☐ OTHER (SPECIFY) \_\_\_\_\_

IS THIS A RESUBMITTAL?: ☐ Yes ☐ No


**DATE SUBMITTED:** \_\_\_\_\_ **By:** \_\_\_\_\_

COA STAFF: \_\_\_\_\_ ELECTRONIC SUBMITTAL RECEIVED: \_\_\_\_\_



EROSION CONTROL NOTES:

1. CONTRACTOR IS RESPONSIBLE FOR OBTAINING A TOPSOIL DISTURBANCE PERMIT PRIOR TO BEGINNING WORK.
2. CONTRACTOR IS RESPONSIBLE FOR MAINTAINING RUN-OFF ON SITE DURING CONSTRUCTION.
3. CONTRACTOR IS RESPONSIBLE FOR CLEANING ALL SEDIMENT THAT GETS INTO EXISTING RIGHT-OF-WAY.
4. REPAIR OF DAMAGED FACILITIES AND CLEANUP OF SEDIMENT ACCUMULATIONS ON ADJACENT PROPERTIES AND IN PUBLIC FACILITIES IS THE RESPONSIBILITY OF THE CONTRACTOR.
5. ALL EXPOSED EARTH SURFACES MUST BE PROTECTED FROM WIND AND WATER EROSION PRIOR TO FINAL (CITY) ACCEPTANCE OF ANY PROJECT.

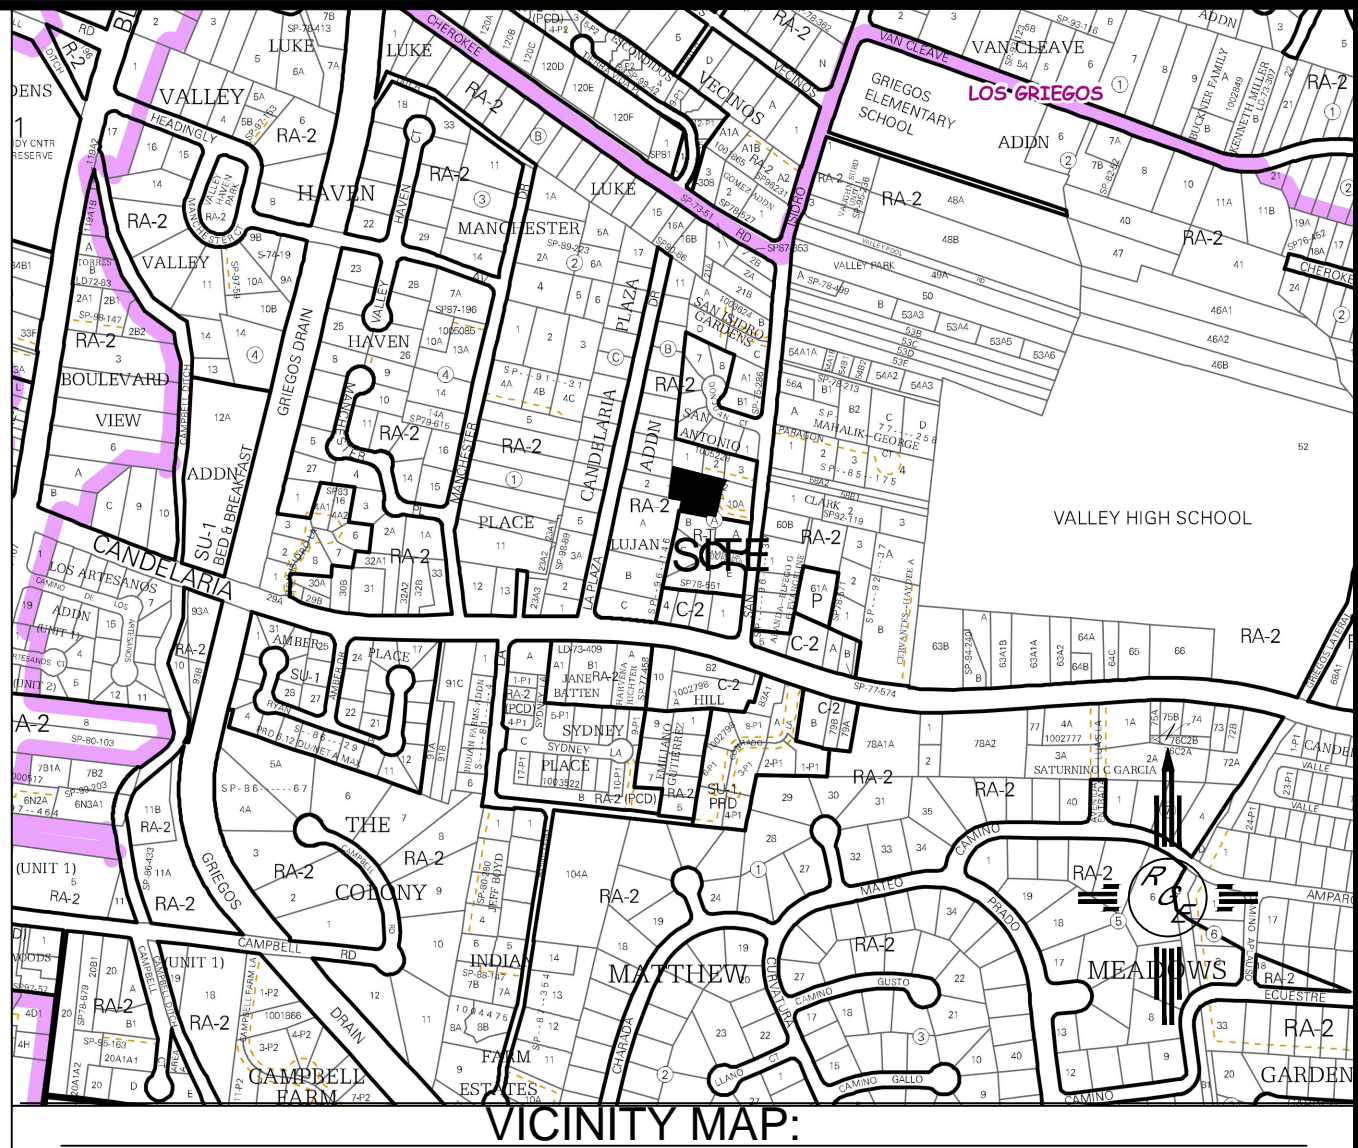

FIRM MAP: FM35043C2125D

LEGAL DESCRIPTION:


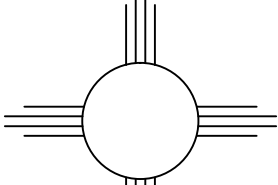
LOT 10B1 AND 10B2, CANDELARIA PLAZA ADDITION


NOTES:

1. ALL SPOT ELEVATIONS REPRESENT FLOWLINE ELEVATION UNLESS OTHERWISE NOTED.
2. TOPOGRAPHIC SURVEY INFORMATION SHOWN ON THIS PLAN WAS OBTAINED BY CARTESIAN SURVEYS DATED JULY 2015


LEGEND

- 5411--- EXISTING CONTOUR
- 5410--- EXISTING INDEX CONTOUR
- 5411--- PROPOSED CONTOUR
- 5410--- PROPOSED INDEX CONTOUR

ENGINEER'S SEAL  DAVID SOULE P.E. #14522	LOT 10B1 AND LOT B2 CANDELARIA PLAZA ADDITION	DRAWN BY JDG
	GRADING AND DRAINAGE PLAN	DATE 03-23-06
 Rio Grande Engineering 1606 CENTRAL AVENUE SE SUITE 201 ALBUQUERQUE, NM 87106 (505) 872-0999		SHEET # 1 OF 1
		JOB #

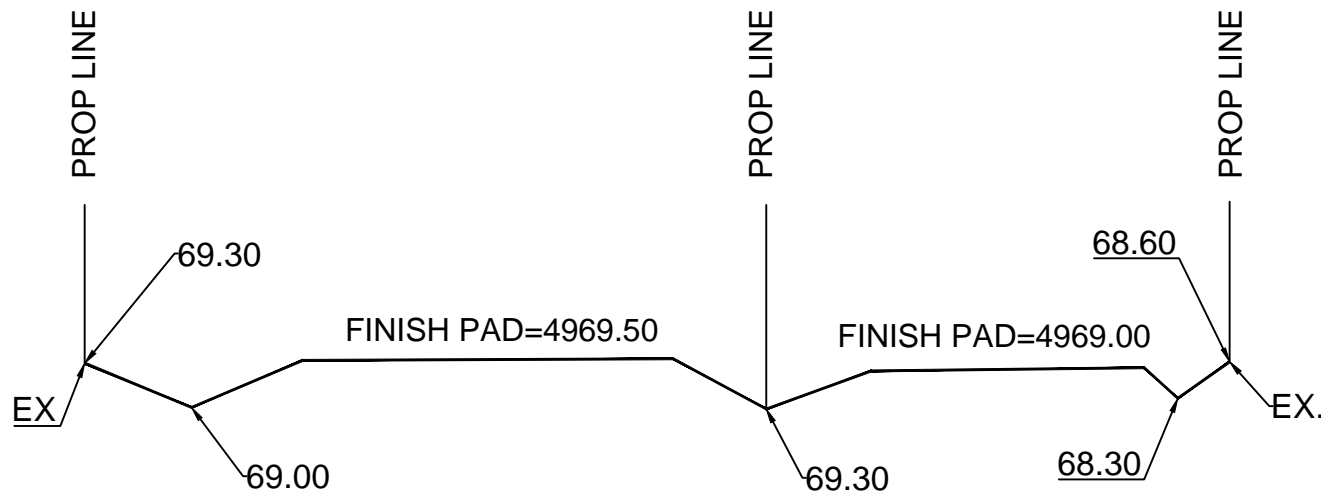


SECTION A

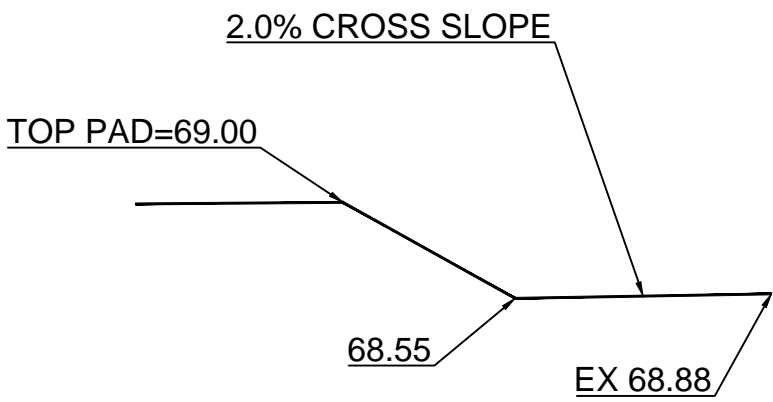


SECTION B

ACS Monument " 6-C13AR "  
NAD 1983 CENTRAL ZONE  
X=1515743.949  
Y=1500719.134  
Z=N/A (NAVD 1988)  
G-C=0.999684045  
Mapping Angle=-00°14'23.60"

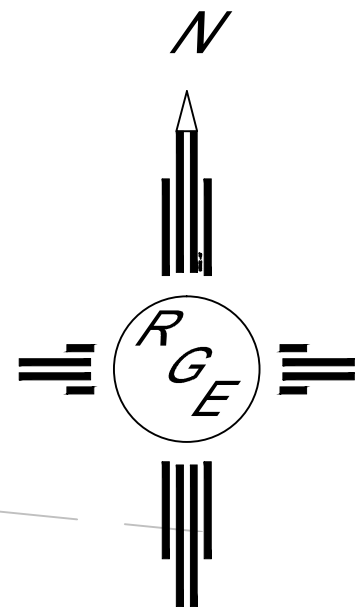

GRAPHIC SCALE

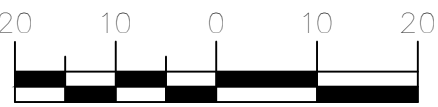

SCALE: 1"=20'



**David Soule**

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**Subject:** FW: Candelaria Plaza Addition

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**From:** Rael, Rudy E. [mailto:RRael@cabq.gov]  
**Sent:** Tuesday, March 22, 2016 9:27 AM  
**To:** 'David Soule (david@riograndeengineering.com)'  
**Subject:** Candelaria Plaza Addition

Hello David:

This email is being sent in lieu of an attached comment letter in order to expedite the response for initial reviews. Responses to comments should continue to be included in the re-submittal. A reply to this email with responses to comments will not be considered a re-submittal.

Based upon the information provided in your submittal received 1-13-2016, the above referenced Grading and Drainage Plan cannot be approved for Site Plan for Building Permit, Building Permit, or ESC Permit (Grading Permit), until the following items are addressed:

1. Drainage calcs were omitted ( [WE HAVE ADDED TO THE PLAN](#))
2. New spot elevations to cluttered, remove majority of spots. ([WE HAVE REMOVED MOST EXISTING ELEVATIONS TO ELIMINAT](#)
3. FF for lot 10-B1 should be at 4969.50. ( [WE HAVE ADDED THE FINISHED FLOOR ELEVATIONS TO ALL LOTS](#))
4. Label existing buildings. ([WE HAVE LABELED](#))
5. Show roof flows. ([WE HAVE SHOWN](#))
6. What is E note at existing buildings? ( [WE HAVE REMOVED THE KEY NOTE](#)

*Rudy E. Rael, CE, CFM*  
Engineer Associate, Hydrology  
Planning Department  
600 2nd St. NW Suite 201  
Albuquerque NM 87102  
(505) 924-3977

### Weighted E Method

Basin	Area (sf)	Area (acres)	Treatment A		Treatment B		Treatment C		Treatment D		100-Year, 6-hr.			100 yr 10-day
			%	(acres)	%	(acres)	%	(acres)	%	(acres)	Weighted E (ac-ft)	Volume (ac-ft)	Flow cfs	Volume (ac-ft)
historical	34590.00	0.794	0%	0	40%	0.318	20%	0.159	40%	0.318	1.386	0.092	2.72	0.134
basin 10b1	10466.00	0.240	0%	0	35%	0.084	15%	0.036	50%	0.120	1.503	0.030	0.87	0.046
basin 10b2	10655.00	0.245	0%	0	35%	0.086	15%	0.037	50%	0.122	1.503	0.031	0.89	0.047
basin 10a1	13469.00	0.309	0%	0	35%	0.108	15%	0.046	50%	0.155	1.503	0.039	1.12	0.059
PROPOSED	34590.00	0.794	0%	0	35%	0.278	15%	0.119	50%	0.397	1.503	0.099	2.87	0.152

#### Equations:

Weighted E =  $E_a \cdot A_a + E_b \cdot A_b + E_c \cdot A_c + E_d \cdot A_d$  / (Total Area)

Volume = Weighted D \* Total Area

First flush requirement 490.025 cubic feet

Flow =  $Q_a \cdot A_a + Q_b \cdot A_b + Q_c \cdot A_c + Q_d \cdot A_d$

Where for 100-year, 6-hour storm(zone2)

Ea= 0.53	Qa= 1.56
Eb= 0.78	Qb= 2.28
Ec= 1.13	Qc= 3.14
Ed= 2.12	Qd= 4.7

Developed Condions

FLAT GRADING SCHEME

VOLUME GENERATED

10-day

EXISTING	2.72 CFS	0.134 AC-FT	5839.945 CF
PROPOSED(ex lot 10a1)	0.87 CFS	0.152 AC-FT	6636.95625 CF
ALLOWED	2.18 CFS		

PONDING PROVIDED

GENERATED

POND	10b1	2054	2044
POND	10b2	2041	2008

This site is an redevelopment of an existing lot. The structure on lot 10a1 will remain. The structure on lots 10b1 and 10b2 was recently demolishec

The site lies within the valley , where the flat land gradigng scheme is allowed. The rear two lots will retain the entire 100-year, 10-day volume and the existing lot will remain unchanged. The site is ringed by existing block walls, therefore no cross lot drainage exists. The new gravel drive will funtion as an emergency overflow.