## CITY OF ALBUQUERQUE

*Planning Department* David Campbell, Director



Mayor Timothy M. Keller

June 21, 2019

Åsa Nilsson-Weber, P.E. Isaacson & Arfman, P.A. 128 Monroe St. N.E Albuquerque, NM 87108

RE: Campbell Compound Request for Pad Certification (Lots 2 and 3): - Accepted Drainage Report Stamp Date: 10/10/17 Grading Plan Stamp Date: 3/6/18 (G13D032) Certification Dated: 6/20/19

Dear Ms. Nilsson-Weber:

PO Box 1293 Based on the submittal received on 6/20/19, the certification is accepted for Building Permit for Lots 5 and 6.

Prior to Hydrology approval for Release of Financial Guarantee (For Information):

Albuquerque

NM 87103

- 1. The Drainage Covenants must be recorded with Bernalillo County and a copy included with the drainage certification.
- If you have any questions, please contact me at 924-3695 or dpeterson@cabq.gov.

www.cabq.gov

Sincerely,

Dana Peterson, P.E. Senior Engineer, Planning Dept. Development Review Services



### City of Albuquerque

Planning Department Development & Building Services Division DRAINAGE AND TRANSPORTATION INFORMATION SHEET (REV 11/2018)


Project Title: Campbell Compound	Building Permit #:	Hydrology File #:G13D032		
DRB#: <u>1011223</u>	_ EPC#:	Work Order#: <u>708882</u>		
Legal Description: <u>Campbell Compound</u>				
City Address:				
Applicant: Isaacson & Arfman, PA		Contact: Åsa Nilsson-Weber		
Address: 128 Monroe Street NE - Albuc	uerque, NM 87108			
Phone#: (505) 268-8828	_Fax#:	E-mail: <u>asaw@iacivil.com</u>		
Owner: Las Ventanas NM, Inc.		Contact: Scott Ashcraft		
Address: 8330-A Washington Place NE	- Albuquerque, NM 87113			
Phone#: (505) 362-6824	Fax#:	E-mail:		
IS THIS A RESUBMITTAL?: Yo <b>DEPARTMENT:</b> TRAFFIC/ TRANSPOR Check all that Apply: <b>TYPE OF SUBMITTAL:</b> X ENGINEER ARCHITECT CERTIFICATION CONCEPTUAL G & D PLAN	TATION <u>X</u> HYDROLOGY/ DRAI <b>TYPE OF APPROV</b> <u>X</u> BUILDING PER CERTIFICATE PRELIMINARY	AL/ACCEPTANCE SOUGHT: RMIT APPROVAL LOTS 2 & 3 OF OCCUPANCY ( PLAT APPROVAL		
GRADING PLAN GRADING PLAN DRAINAGE MASTER PLAN DRAINAGE REPORT FLOODPLAIN DEVELOPMENT PERMIT A ELEVATION CERTIFICATE CLOMR/LOMR TRAFFIC CIRCULATION LAYOUT (TCL) TRAFFIC IMPACT STUDY (TIS) OTHER (SPECIFY) PRE-DESIGN MEETING?	FINAL PLAT A SIA/ RELEASE FOUNDATION GRADING PER SO-19 APPROV PAVING PERM GRADING/ PAJ CLOMR/LOMR FLOODPLAIN	<ul> <li>SITE PLAN FOR BLDG. PERMIT APPROVAL</li> <li>FINAL PLAT APPROVAL</li> <li>SIA/ RELEASE OF FINANCIAL GUARANTEE</li> <li>FOUNDATION PERMIT APPROVAL</li> <li>GRADING PERMIT APPROVAL</li> <li>SO-19 APPROVAL</li> <li>PAVING PERMIT APPROVAL</li> <li>GRADING/ PAD CERTIFICATION</li> <li>WORK ORDER APPROVAL</li> <li>CLOMR/LOMR</li> <li>FLOODPLAIN DEVELOPMENT PERMIT</li> <li>OTHER (SPECIFY)</li> </ul>		

DATE SUBMITTED: June 20, 2019 By: Åsa Nilsson-Weber

COA STAFF:

ELECTRONIC SUBMITTAL RECEIVED:

FEE PAID:

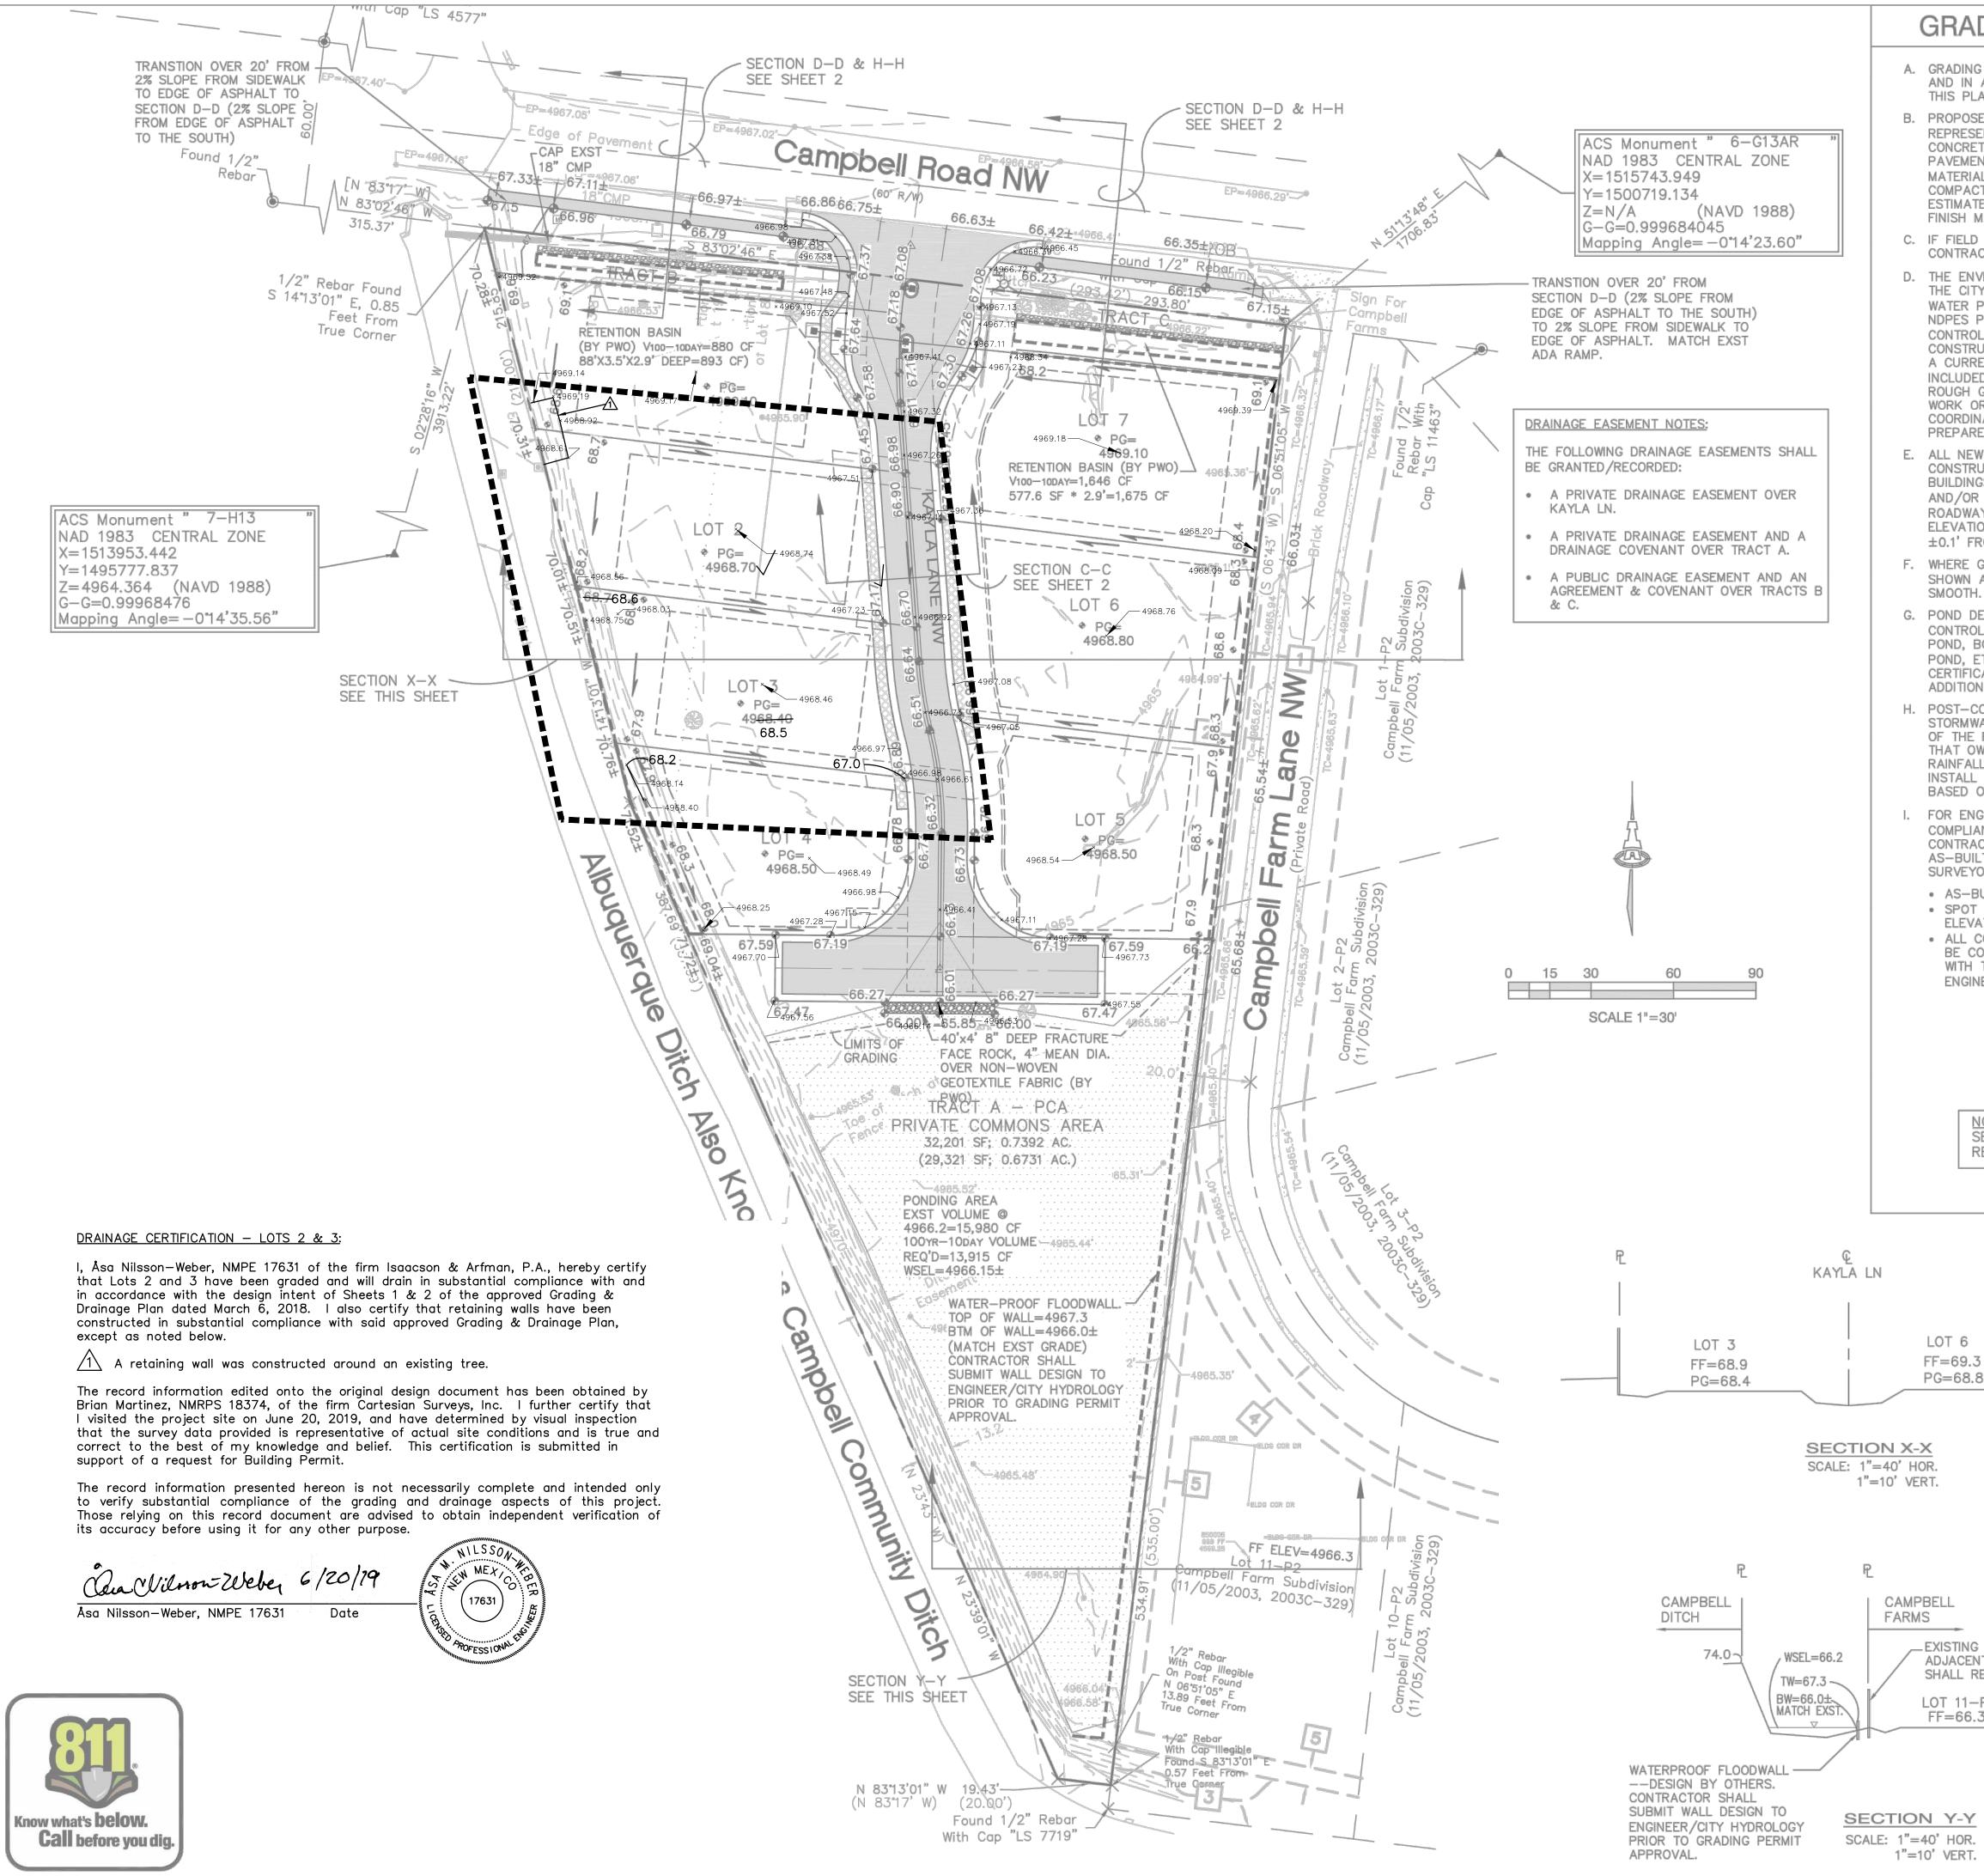

# **GRADING GENERAL NOTES**

A. GRADING SHALL BE PERFORMED AT THE ELEVATIONS AND IN ACCORDANCE WITH THE DETAILS SHOWN ON THIS PLAN.

B. PROPOSED SPOT AND CONTOUR ELEVATIONS SHOWN REPRESENT TOP OF FINISH MATERIAL (I.E. TOP OF CONCRETE, TOP OF CONCRETE BUILDING PAD, TOP OF PAVEMENT MATERIAL, TOP OF LANDSCAPING MATERIAL, ETC.). CONTRACTOR SHALL GRADE, COMPACT SUBGRADE AND DETERMINE EARTHWORK ESTIMATES BASED ON ELEVATIONS SHOWN MINUS FINISH MATERIAL THICKNESSES.

C. IF FIELD GRADE ADJUSTMENTS ARE REQUIRED, THE CONTRACTOR SHALL NOTIFY THE ENGINEER.

D. THE ENVIRONMENTAL PROTECTION AGENCY (EPA) AND THE CITY OF ALBUQUERQUE REQUIRE A STORM WATER POLLUTION PREVENTION PLAN (SWPPP), AN NDPES PERMIT, AND AN EROSION AND SEDIMENT CONTROL (ESC) PERMIT FOR PROJECTS WHERE CONSTRUCTION ACTIVITIES MEET THE EPA THRESHOLD. A CURRENT CITY-APPROVED ESC PERMIT MUST BE INCLUDED WITH THE CONTRACTOR'S SUBMITTAL FOR A ROUGH GRADING, GRADING, PAVING, BUILDING, OR WORK ORDER PERMIT. CONTRACTOR SHALL COORDINATE WITH OWNER TO DETERMINE WHO WILL PREPARE SWPPP AND INSPECT REQUIRED ELEMENTS.

E. ALL NEW PAVEMENT SURFACES SHALL BE CONSTRUCTED WITH POSITIVE SLOPE AWAY FROM BUILDINGS AND POSITIVE SLOPE TOWARD EXISTING AND/OR PROPOSED DRAINAGE PATHS. PAVING AND ROADWAY GRADES SHALL BE ±0.1' FROM PLAN ELEVATIONS. BUILDING PAD ELEVATION SHALL BE ±0.1' FROM PLAN ELEVATION.

F. WHERE GRADES BETWEEN NEW AND EXISTING ARE SHOWN AS 'MATCH' OR '±', TRANSITIONS SHALL BE SMOOTH.

G. POND DESIGN PARAMETERS AND STORMWATER CONTROL MEASURES SHOWN ON THIS PLAN (TOP OF POND, BOTTOM OF POND, SIZE OF ORIFICE, AREA OF POND, ETC.) TO BE STRICTLY ADHERED TO FOR CERTIFICATION PURPOSES. SEE DETAIL SHEET FOR ADDITIONAL INFORMATION.

 WATER-PROOF FLOODWALL. POST-CONSTRUCTION MAINT TOP OF WALL=4967.3 STORMWATER FACILITIES WILLBTM OF WALL=4966.0±
 OF THE FACILITIES OWNER. I(MATCH EXST GRADE) THAT OWNER INSPECT SITE CONTRACTOR SHALL
 RAINFALL TO IDENTIFY NEW SUBMIT WALL DESIGN TO INSTALL ADDITIONAL EROSIO ENGINEER/CITY HYDROLOGY BASED ON ACTUAL OCCURRIPRIOR TO GRADING PERMIT

I. FOR ENGINEER'S CERTIFICATION OF OCCUPANCY) COMPLIANCE (FOR CERTIFICATE OF OCCUPANCY) CONTRACTOR SHALL PROVIDE AN AUTOCAD FORMAT AS-BUILT SURVEY PREPARED BY A LICENSED SURVEYOR WHICH INCLUDES:

AS-BUILT PAD GRADE

 SPOT ELEVATIONS AT EACH DESIGN SPOT ELEVATION SHOWN ON THE APPROVED PLAN;
 ALL CONSTRUCTION SHOWN ON THIS PLAN MUST BE CONSTRUCTED IN SUBSTANTIAL COMPLIANCE WITH THE APPROVED PLAN IN ORDER TO RECEIVE ENGINEER'S CERTIFICATION.

NOTE; SEE SHEET 2 FOR DETAILS AND RETAINING WALL PLAN		LEGEND		
	4966	EXISTING CONTOUR		
	<del>⊕</del> 78.3	PROPOSED ELEVATI	ON	
	PG=4968.5	PAD GRADE ELEVA	TION	
f		PROPOSED RETAININ		
CAMPBELL   CAMPBELL COMPOUND   FARMS	· ·	(DESIGN BY OTHER: PROPOSED GARDEN		g wall
		FLOW ARROW		
69.3 NEW RET. 68.8 WALL FF=66.4±				
EASEMENT NOTE: EXISTING PRIVATE 3' FENCE EASEMENT BENEFITING & MAINTAINED BY THE OWNERS OF LOTS 1—P2 AND 2—P2, CAMPBELL FARM, AND LOT 18, ALVARADO GARDENS (11/05/2003, 2003C—329)	ADFESSION BE	Consu Ph	lting Engin 128 Monro Albuquerque, Na . 505-268-8828	RFMAN, P.A. eering Associates e Street N.E. ew Mexico 87108 www.iacivil.com Mar 07,2018
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TING WALL ACENT TO TRACT A LL REMAIN.	CAMPBELL COMPOUND			
11-P2 =66.3±	LAS VENTANAS NM, INC.			
	GRADING & DRAINAGE PLAN			
	Date: No. Revision Sept 2017	n:	Date:	Job No. 2224
IOR.	Drawn By: ÅNW			G-13
ERT.	Ckd By:			зн.1о⊨ 2

# **VICINITY MAP** SNE BUT 1"=750'± G-13-Z **PROJECT DATA** LEGAL DESCRIPTION: CAMPBELL COMPOUND BEING A RE-PLAT OF PORTION OF LOTS 18 & 19, ALVARADO GARDENS, UNIT 3 SITE AREA: 2.0808 AC. DISTURBED AREA: 1.30 AC.± BENCHMARK: ACS MONUMENT "7-H13" ELEVATION: 4964.364 (NAVD 1988) ENGINEER: ÅSA NILSSON-WEBER ISAACSON & ARFMAN, P.A. 128 MONROE ST NE, ABQ. NM 87108 PHONE: (505) 268-8828 SURVEYOR: BRIAN MARTINEZ CARTESIAN SURVEYS, INC. PO BOX 44414 RIO RANCHO, NM 87174 PHONE: (505) 896-3050. FLOOD ZONE: BASED UPON SCALING, THIS PROPERTY LIES WITHIN FLOOD ZONE X WHICH IS DEFINED AS AREAS OF 0.2% ANNUAL CHANCE; AREA OF 1% ANNUAL CHANCE FLOOD WITH AVERAGE DEPTHS OF LESS THAN 1 FOOT OR WITH DRAINAGE AREAS LESS THAN 1 SQUARE MILE; AND AREAS PROTECTED BY LEVEES FROM 1% ANNUAL CHANGE FLOOD. AS DETERMINED BY F.E.M.A. AND SHOWN ON FLOOD INSURANCE RATE MAP DATE AUGUST 16, 2012, MAP NO. 35001C0331H.

