# CITY OF ALBUQUERQUE

Planning Department Brennon Williams, Director



March 16, 2020

David Soule, P.E. Rio Grande Engineering P.O. Box 93924 Albuquerque, NM 87199

RE: 1414 Los Arboles Ave., NW **Grading and Drainage Plan** Engineer's Stamp Date: 02/23/20

**Hydrology File: G13D037** 

Dear Mr. Soule:

PO Box 1293

Albuquerque

www.cabq.gov

Based upon the information provided in your submittal received 02/24/20, the Grading and

Drainage Plan is approved for Building Permit.

Once the grading is complete, a pad certification will be required prior to release of Building Permit. Please attach a copy of this approved plan in the construction sets for Building Permit

processing along with a copy of this letter and the pad certification approval letter.

Prior to approval in support of Permanent Release of Occupancy by Hydrology, Engineer NM 87103

Certification per the DPM checklist will be required.

If you have any questions, please contact me at 924-3995 or rbrissette@cabq.gov.

Sincerely,

Renée C. Brissette, P.E. CFM Senior Engineer, Hydrology

Renée C. Brissette

Planning Department



# City of Albuquerque

#### Planning Department

#### Development & Building Services Division

### DRAINAGE AND TRANSPORTATION INFORMATION SHEET (REV 6/2018)

Project Title: 1414 los Arboles	_Building Permit #	: Hydrol	ogy File #:
DRB#:	_ EPC#:	Work (	Order#:
Legal Description. LOT 28 LIVINGS	ron place		
City Address: 1414 los arboles			
Applicant: MR. LUJAN		Contact:	
Address: 1414 LOS ARBOLES			
Phone#:	_ Fax#:	E-mail:	
Other Contact: RIO GRANDE ENGINE	EERING	Contact:	DAVID SOULE
Address: PO BOX 93924 ALB NM			
Phone#: 505.321.9099		999 E-mail: d	avid@riograndeengineering.com
TYPE OF DEVELOPMENT: PLAT			
Check all that Apply:			
DEPARTMENT:  X HYDROLOGY/ DRAINAGE TRAFFIC/ TRANSPORTATION  TYPE OF SUBMITTAL: ENGINEER/ARCHITECT CERTIFICATION PAD CERTIFICATION CONCEPTUAL G & D PLAN X GRADING PLAN DRAINAGE REPORT DRAINAGE MASTER PLAN FLOODPLAIN DEVELOPMENT PERMIT A ELEVATION CERTIFICATE CLOMR/LOMR TRAFFIC CIRCULATION LAYOUT (TCL) TRAFFIC IMPACT STUDY (TIS) STREET LIGHT LAYOUT OTHER (SPECIFY) PRE-DESIGN MEETING?  IS THIS A RESUBMITTAL?: Yes X NOT THE SUBMITTED.	APPLIC —	YPE OF APPROVAL/ACCEI  BUILDING PERMIT APPR CERTIFICATE OF OCCUP  PRELIMINARY PLAT APPR SITE PLAN FOR SUB'D A SITE PLAN FOR BLDG. P FINAL PLAT APPROVAL  SIA/ RELEASE OF FINAN FOUNDATION PERMIT APPR SO-19 APPROVAL PAVING PERMIT APPRO GRADING/ PAD CERTIFI WORK ORDER APPROVAL CLOMR/LOMR FLOODPLAIN DEVELOPM	PROVAL APPROVAL PERMIT APPROVAL PERMIT APPROVAL PERMIT APPROVAL POLICIAL GUARANTEE APPROVAL POVAL POLICIAL GUARANTEE APPROVAL GUARANTEE APP
DATE SUBMITTED:	*		
COA STAFF:	ELECTRONIC SUBMI	TTAL RECEIVED:	

FEE PAID:\_\_\_\_\_

Weighted E Method

											100-	-Year, 6-hr		100 yr 24-l
Basin	Area	Area	Treat	ment A	Trea	tment B	Treat	ment C	Treati	ment D	Weighted E	Volume	Flow	Volume
	(sf)	(acres)	%	(acres)	%	(acres)	%	(acres)	%	(acres)	(ac-ft)	(ac-ft)	cfs	(ac-ft)
EXISTING	33073.00	0.759	0%	0	48%	0.364	31%	0.235	21%	0.159	1.170	0.074	2.32	0.0
PROPOSED	33073.00	0.759	0%	0	44%	0.334	30%	0.228	26%	0.197	1.233	0.078	2.40	0.08

Weighted E = Ea\*Aa + Eb\*Ab + Ec\*Ac + Ed\*Ad / (Total Area)

Volume = Weighted D \* Total Area

Flow = Qa \* Aa + Qb \* Ab + Qc \* Ac + Qd \* Ad

Where for 100-year, 6-hour storm(zone2 Ea= 0.53

Eb= 0.78 Ed= 2.12

**Developed Conditions** TOTAL VOLUME

HISTORICAL GENERATION 3455.85 CF PROPOSED GENERATION 3685.99 CF 4769 CF

This project is an addition redevelopment of an existing developed lot. The site will conform to the valley flat area drainage scheme. The site will retain the 100-year 24-hour volume The ponds will overlow to the irrigation ditch in the event of a storm exceeding the 100-year event. The surrounding are is flat, minor offsite flows are allowed to enter the and pass thru to the right of way. The first flush volume is retained on site. The ponding volume occurs in currently flood irrigated grass areas.

RETENTION PROVIDED

4966.99 **(s89°11'0¢"w)** TBM 4966.59 ELEVATION=4966.99 EX CONCRETE DRIVEW INV=4966.60 INV=4966.47 4966.75 EXISTING RESIDENCE FF = 4968.42HARVEST SWALE \_\_\_ TOP=66.75 - -4968— — BOTTOM = 66.50PORCH F **≒**6967.0 FF=4967.52 FP=4967.02 INV=4966.54 4966.90 4966,40 **4**967.05 EX. ONSITERETENTION POND AVERAGE TOP=4966.90 AVERAGE BOTTOM=4966.50 VOLUME=4769 CU. FT. MAINTAIN EXISTING FLOOD IRRIGATION PATTERN

4967.43

(125.00')

4967.24

4967,78 4967,48 4967,06.

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(----)

INV=4966.44

—————<del>4</del>967.34

INV=4966.35

EROSION CONTROL NOTES:


1. CONTRACTOR IS RESPONSIBLE FOR OBTAINING A TOPSOIL DISTURBANCE PERMIT PRIOR TO BEGINNING WORK.

2. CONTRACTOR IS RESPONSIBLE FOR MAINTAINING RUN-OFF ON SITE DURING CONSTRUCTION.

3. CONTRACTOR IS RESPONSIBLE FOR CLEANING ALL SEDIMENT THAT GETS INTO EXISTING RIGHT-OF-WAY.

4. REPAIR OF DAMAGED FACILITIES AND CLEANUP OF SEDIMENT ACCUMULATIONS ON ADJACENT PROPERTIES AND IN PUBLIC FACILITIES IS THE RESPONSIBILITY OF THE CONTRACTOR.

5. ALL EXPOSED EARTH SURFACES MUST BE PROTECTED FROM WIND AND WATER EROSION PRIOR TO FINAL ACCEPTANCE OF ANY PROJECT.

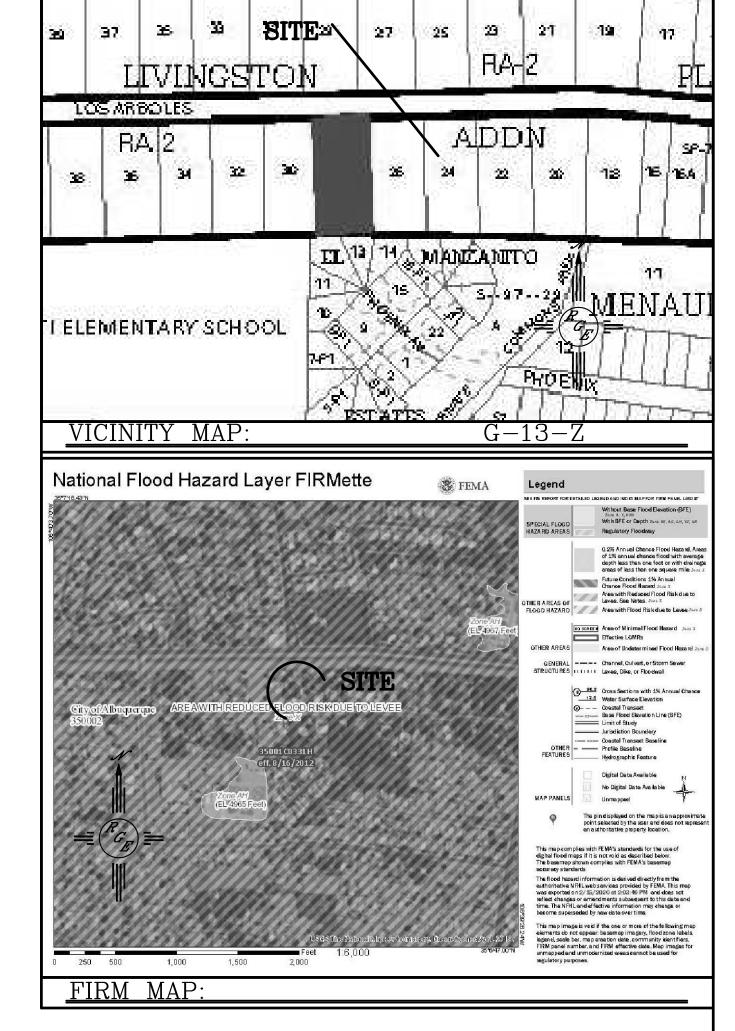


LEGAL DESCRIPTION: LOT 2-P1, COVERED WAGON

1. ALL SPOT ELEVATIONS REPRESENT FLOWLINE ELEVATION UNLESS OTHERWISE

2. ALL SLOPES SHALL BE 3:1 MAX. AND GRAVEL OR NATIVE SEEDING PRIOR TO CO.

### LEGEND

---- Existing contour ---- EXISTING INDEX CONTOUR PROPOSED CONTOUR - PROPOSED INDEX CONTOUR SLOPE TIE EXISTING SPOT ELEVATION × XXXX \* XXXX PROPOSED SPOT ELEVATION ——————————————BOUNDARY CENTERLINE - RIGHT-OF-WAY  $\equiv \equiv \text{ EXISTING CURB AND GUTTER}$ EXISTING CMU SCREEN WALL

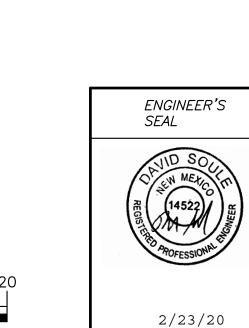

SCALE: 1"=20'

1414 LOS ARBOLES DRAWN BY WCWJ 2-23-20 GRADING AND DRAINAGE PLAN 2102015-LAYOUT-2-23-2 SHEET # Rio Grande \_\_\_

Lingineering 1606 CENTRAL AVENUE SE SUITE 201 ALBUQUERQUE, NM 87106 (505) 872-0999

JOB #

2102015

DAVID SOULE P.E. #14522

CAUTION:

EXISTING UTILITIES ARE NOT SHOWN. IT SHALL BE THE SOLE RESPONSIBILITY OF THE CONTRACTOR TO CONDUCT ALL NECESSARY FIELD INVESTIGATIONS PRIOR TO ANY EXCAVATION TO DETERMINE THE ACTUAL LOCATION OF UTILITIES & OTHER IMPROVEMENTS.