NOTICE TO CONTRACTORS

1. AN EXCAVATION/CONSTRUCTION PERMIT WILL BE REQUIRED BEFORE BEGINNING ANY WORK WITHIN CITY RIGHT-OF-WAY.

2. ALL WORK DETAILED ON THESE PLANS TO BE PERFORMED, EXCEPT AS OTHERWISE STATED OR PROVIDED HEREON, SHALL BE CONSTRUCTED IN ACCORDANCE WITH CITY OF ALBUQUERQUE INTERIM STANDARD SPECIFICATIONS FOR PUBLIC WORKS CONSTRUCTION,

3. TWO WORKING DAYS PRIOR TO ANY EXCAVATION, CONTRACTOR MUST CONTACT LINE LOCATING SERVICE, 765-1234, FOR LOCATION OF EXISTING UTILITIES.

4. PRIOR TO CONSTRUCTION, THE CONTRACTOR SHALL EXCAVATE AND VERIFY THE HORIZONTAL AND VERTICAL LOCATIONS OF ALL CONSTRUCTIONS. SHOULD A CONFLICT EXIST, THE CONTRACTOR SHALL NOTIFY THE ENGINEER SO THAT THE CONFLICT CAN BE RESOLVED WITH A MINIMUM AMOUNT OF DELAY.

5. BACKFILL COMPACTION SHALL BE ACCORDING TO TRAFFIC/STREET USE.

6. MAINTENANCE OF THESE FACILITIES SHALL BE THE RESPONSIBILITY OF THE OWNER OF THE PROPERTY SERVED.

7. WORK ON ARTERIAL STREETS SHALL BE PERFORMED ON A 24-HOUR BASIS.

Lot 17-A-2, Pappe Additions, contains +/- 0.333 acre and is loated at 3440 2ND Street, NW. See attached portion of the Vicinity Map for exact location.

Purpose

The purpose of this drainage report is to present a grading and drainage solution to replace existing improvements with this new

Existing Drainage Conditions

There is existing slab on site which covert more than 40% of site. No offiste runoff enters the site. the site drain east to west and north to south. Based on the FIRM Map 35001C0332G (revised September 26, 2008) the site does not fall within a 100-year

Proposed Conditions and On-Site Drainage Management Plan The runoff generated from this site will be <u>retained on-site</u>. A pond is designed to hold the 100-yr/24-day volume. Since the runoff from the entire site is being retain on site, the first flush will be retained within the proposed retention pond as well.


City of Albuquerque, Development Process Manuel, Section 22.2, Hydrology Section, was used for runoff calculations. See this plan for AHYMO input and Summary output files.

* ZONE 2	**************
* 100-YEAR. 24	4-HR STORM (UNDER EXISITING CONDITIONS) *
START TI RAINFALL TY RA	ME=0.0 PE=1 RAIN QUARTER=0.0 IN AIN ONE=2.01 IN RAIN SIX=2.35 IN AIN DAY=2.75 IN DT=0.03333 HR
* ON-SITE COMPUTE NM HYD PE TF	ID=1 HYD NO=100.0 AREA=0.000521 SQ MI ER A=60.00 PER B=0.00 PER C=0.00 PER D=40.00 P=0.1333 HR MASS RAINFALL=-1
*********	+*************************************
*********	**************************************
RAINFALL TY	ME=0.0 PE=1 RAIN QUARTER=0.0 IN AIN ONE=1.34 IN RAIN SIX=1.57 IN AIN DAY=1.83 IN DT=0.03333 HR
COMPUTE NM HYD I PE TP	D=1 HYD NO=110.0 AREA=0.000521 SQ MI CR A=60.00 PER B=0.00 PER C=0.00 PER D=40.00 P=0.1333 HR MASS RAINFALL=-1

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RAINFALL TYI	ME=0.0 PE=1 RAIN QUARTER=0.0 IN NIN ONE=2.01 IN RAIN SIX=2.35 IN NIN DAY=2.75 IN DT=0.03333 HR
* ON-SITE	M DAT-2:73 N DT-0:03333 FIR
PE	D=1 HYD NO=100.1 AREA=0.000521 SQ MI R A=0.00 PER B=7.50 PER C=7.50 PER D=85.00 =0.1333 HR MASS RAINFALL=-1

* 10-YEAR, 24	-HR STORM (UNDER PROPOSED CONDITIONS) *
*************	**************
START TIME RAINFALL TYPE RA	**************************************
START TIME RAINFALL TYPE RAINF	**************************************

FINISH

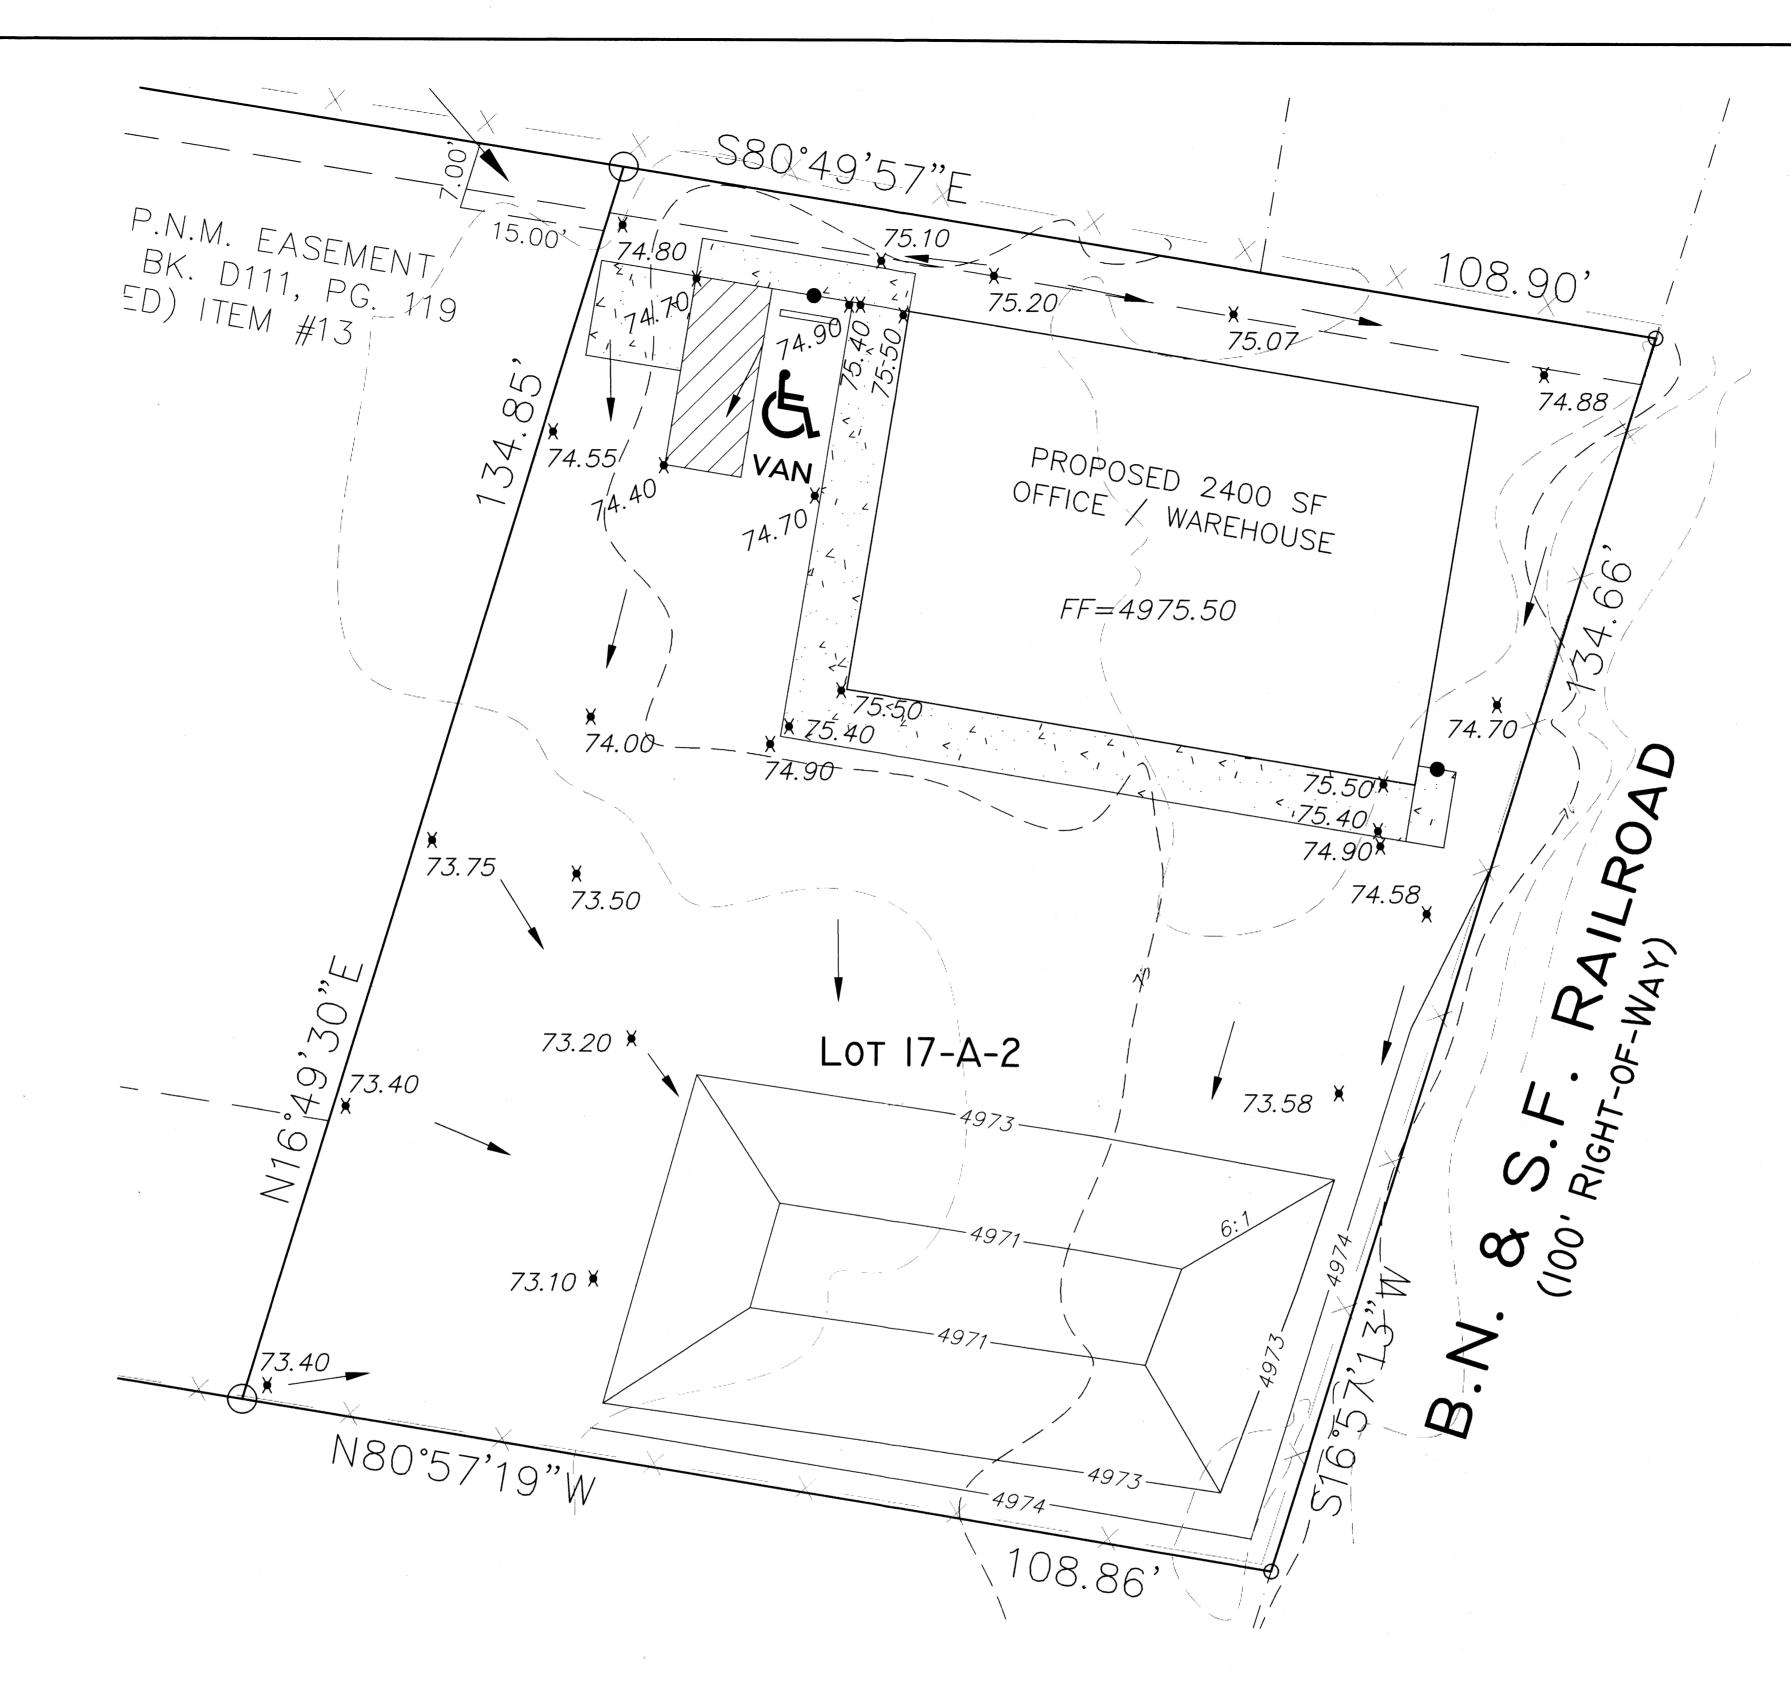

AHYMO PROGRAI INPUT FILE = 21	M SUM ND-24	IMARY TABLE .TXT	E (AH)	YMO_9	97) –		- VERSION:		RUN D USER NO.=	ATE (MON/ AHYMO-I-	/DAY/YR) 9702c010	=11/23/ 000R31-AH	′201 1
COMMAND		YDROGRAPH TIFICATION	FROM ID NO.	TO ID NO.	AREA (SQ MI)	PEAK DISCHARGE (CFS)	RUNOFF VOLUME (AC-FT)	RUNOF (INCHES) (TIME TO F PEAK (HOURS)		PAGI NOTATIO	- · · · · ·	
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START				•	.55552	.43	.017	.01010	1.500	1.478 PE	R IMP= TIME=	40.00 .00	
RAINFALL TYPE	•										RAIN6=	2.350	
COMPUTE NM HY	/D	100.10	-	1	.00052	1.48	.054	1.93856	1.500		R IMP=	85.00	
START RAINFALL TYPE:	_ 1					and the same of the same of					ПМЕ=	.00	
COMPUTE NM HY		110.10		1	00050	0.5					=9NIAS	1.570	
FINISH	U	110.10	_	1	.00052	.95	.033	1.19416	1.500	2.862 PE	R IMP=	85.00	

POND CALCULATION A

BOTTOM AREA = 457.56 SF, TOP AREA = 2,309.33 SF, DEPTH = 2.0' VOLUME PROVIDED = $(457.56 + 2,309.33)/2 \times 2 = 2,766.89 \text{ CF}$ 100 YR/24-HR STORM REQUIRED = 0.062 AC-FT = 2,700.72 CF

4 = 0.34 IN FT (0.40 (.333 AC) 43560 = 164 CF < 2767 =



LEGAL DESCRIPTION:

LOT 17-A-2, PAPPE ADDITION, CONTAININ 0.3334 ACRE

GENERAL NOTES:

1: CONTOUR INTERVAL IS HALF (1.00) FOOT. 2: ELEVATIONS ARE BASED ON CITY OF ALBUQUERQUE CONTROL STATION

9_D15, HAVING AN ELEVATION OF <u>4988.802</u> FEET ABOVE SEA LEVEL.

3: UTILITIES SHOWN HEREON ARE IN THEIR APPROXIMATE LOCATION BASED ONLY ON ABOVE GROUND EVIDENCE FOUND IN THE FIELD AND AS—BUILT INFORMATION PROVIDED BY THE CLIENT. UTILITIES SHOWN HEREON, WHETHER INDICATED AS ABANDONED OR NOT, SHALL BE VERIFIED BY OTHERS FOR EXACT LOCATION AND/ OR DEPTH PRIOR TO EXCAVATION OR DESIGN CON-

4: THIS IS NOT A BOUNDARY SURVEY, BEARINGS ARE ASSUMED, DISTANCES AND FOUND PROPERTY CORNERS ARE FOR INFORMATIONAL PURPOSES ONLY.

5: SLOPES ARE AT 3:1 MAXIMUM.

—————————————————————————————————————	EXISTING CONTOUR (MAJOR) EXISTING CONTOUR (MINOR)
	BOUNDARY LINE
¥ <i>85.46</i>	PROPOSED SPOT ELEVATION
× 4986.40	EXISTING GRADE
Mannamanamanamanama	PROPOSED BERM



GRAPHIC SCALE



REZA AFAGHPOUR P.E. #11814

LAND DEVELOPMENT SECTION

SBS CONSTRUCTION AND ENGINEERING, LLC

10209 SNOWFLAKE CT., NW ALBUQUERQUE, NEW MEXICO 87114

3440 2ND STREET, NW GRADING AND DRAINAGE PLAN						
DRAWING:	DRAWN BY:	DATE:	SHEET#			
201424-GR.DWG	SH-B	10-22-2014	1			

NOTICE TO CONTRACTORS

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There is existing slab on site which covert more than 40% of site. No offiste runoff enters the site. the site drain east to west and north

Proposed Conditions and On-Site Drainage Management Plan The runoff generated from this site will be retained on-site. A pond is designed to hold the 100-yr/24-day volume.


FINISH

City of Albuquerque, Development Process Manuel, Section 22.2, Hydrology Section, was used for runoff calculations. See this plan for AHYMO input and Summary output files.

* 100-YEAR,	

START RAINFALL	TIME=0.0
KAINFALL	TYPE=2 RAIN QUARTER=0.0 IN RAIN ONE=2.01 IN RAIN SIX=2.35 IN
	RAIN ONE=2.01 IN RAIN SIX=2.35 IN RAIN DAY=2.75 IN DT=0.03333 HR ID=1 HYD NO=100.0 AREA=0.000521 SQ MI PER A=100.00 PER R=0.00 PER C=0.00 PER D=0.00
* ON-SITE	~ ~ ~ ~ ~ ~ ~ ~ ~ ~ ~ ~ ~ ~ ~ ~ ~ ~ ~
COMPUTE NM HYD	ID=1 HYD NO=100.0 AREA=0.000521 SQ MI
	FER A-100.00 FER B-0.00 FER C=0.00 FER D=0.00
	TP=0.1333 HR MASS RAINFALL=-1

TU-YEAR,	24—HR STORM (UNDER HISTORICAL CONDITIONS) * ***********************************
START	TIME=0.0
RAINFALL	TYPE=2 RAIN QUARTER=0.0 IN
	RAIN ONE=1.34 IN RAIN SIX=1.57 IN
	RAIN DAY=1.83 IN DT=0.03333 HR
ON-SITE	
COMPUTE NM HYD	ID=1 HYD NO=110.0 AREA=0.000521 SQ MI
	PER A=100.00 PER B=0.00 PER C=0.00 PER D=0.00
*********	TP=0.1333 HR MASS RAINFALL=-1
* 100-YFAR	24-HR STORM (LINDER PROPOSED CONDITIONS) *
*	24-HR STORM (UNDER PROPOSED CONDITIONS) * ***********************************
*********	24-HR STORM (UNDER PROPOSED CONDITIONS) * ***********************************
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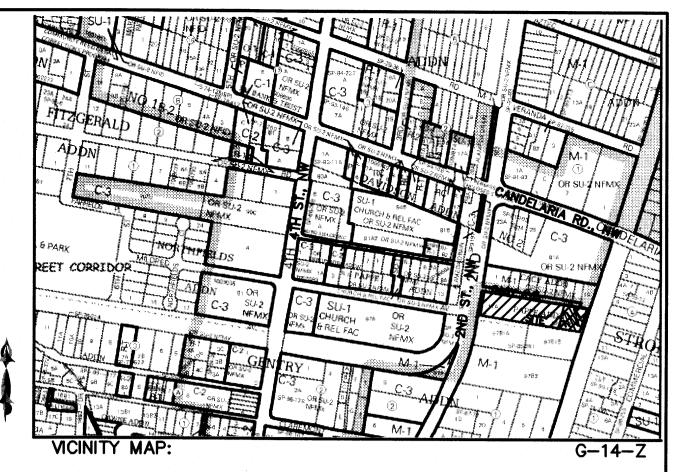


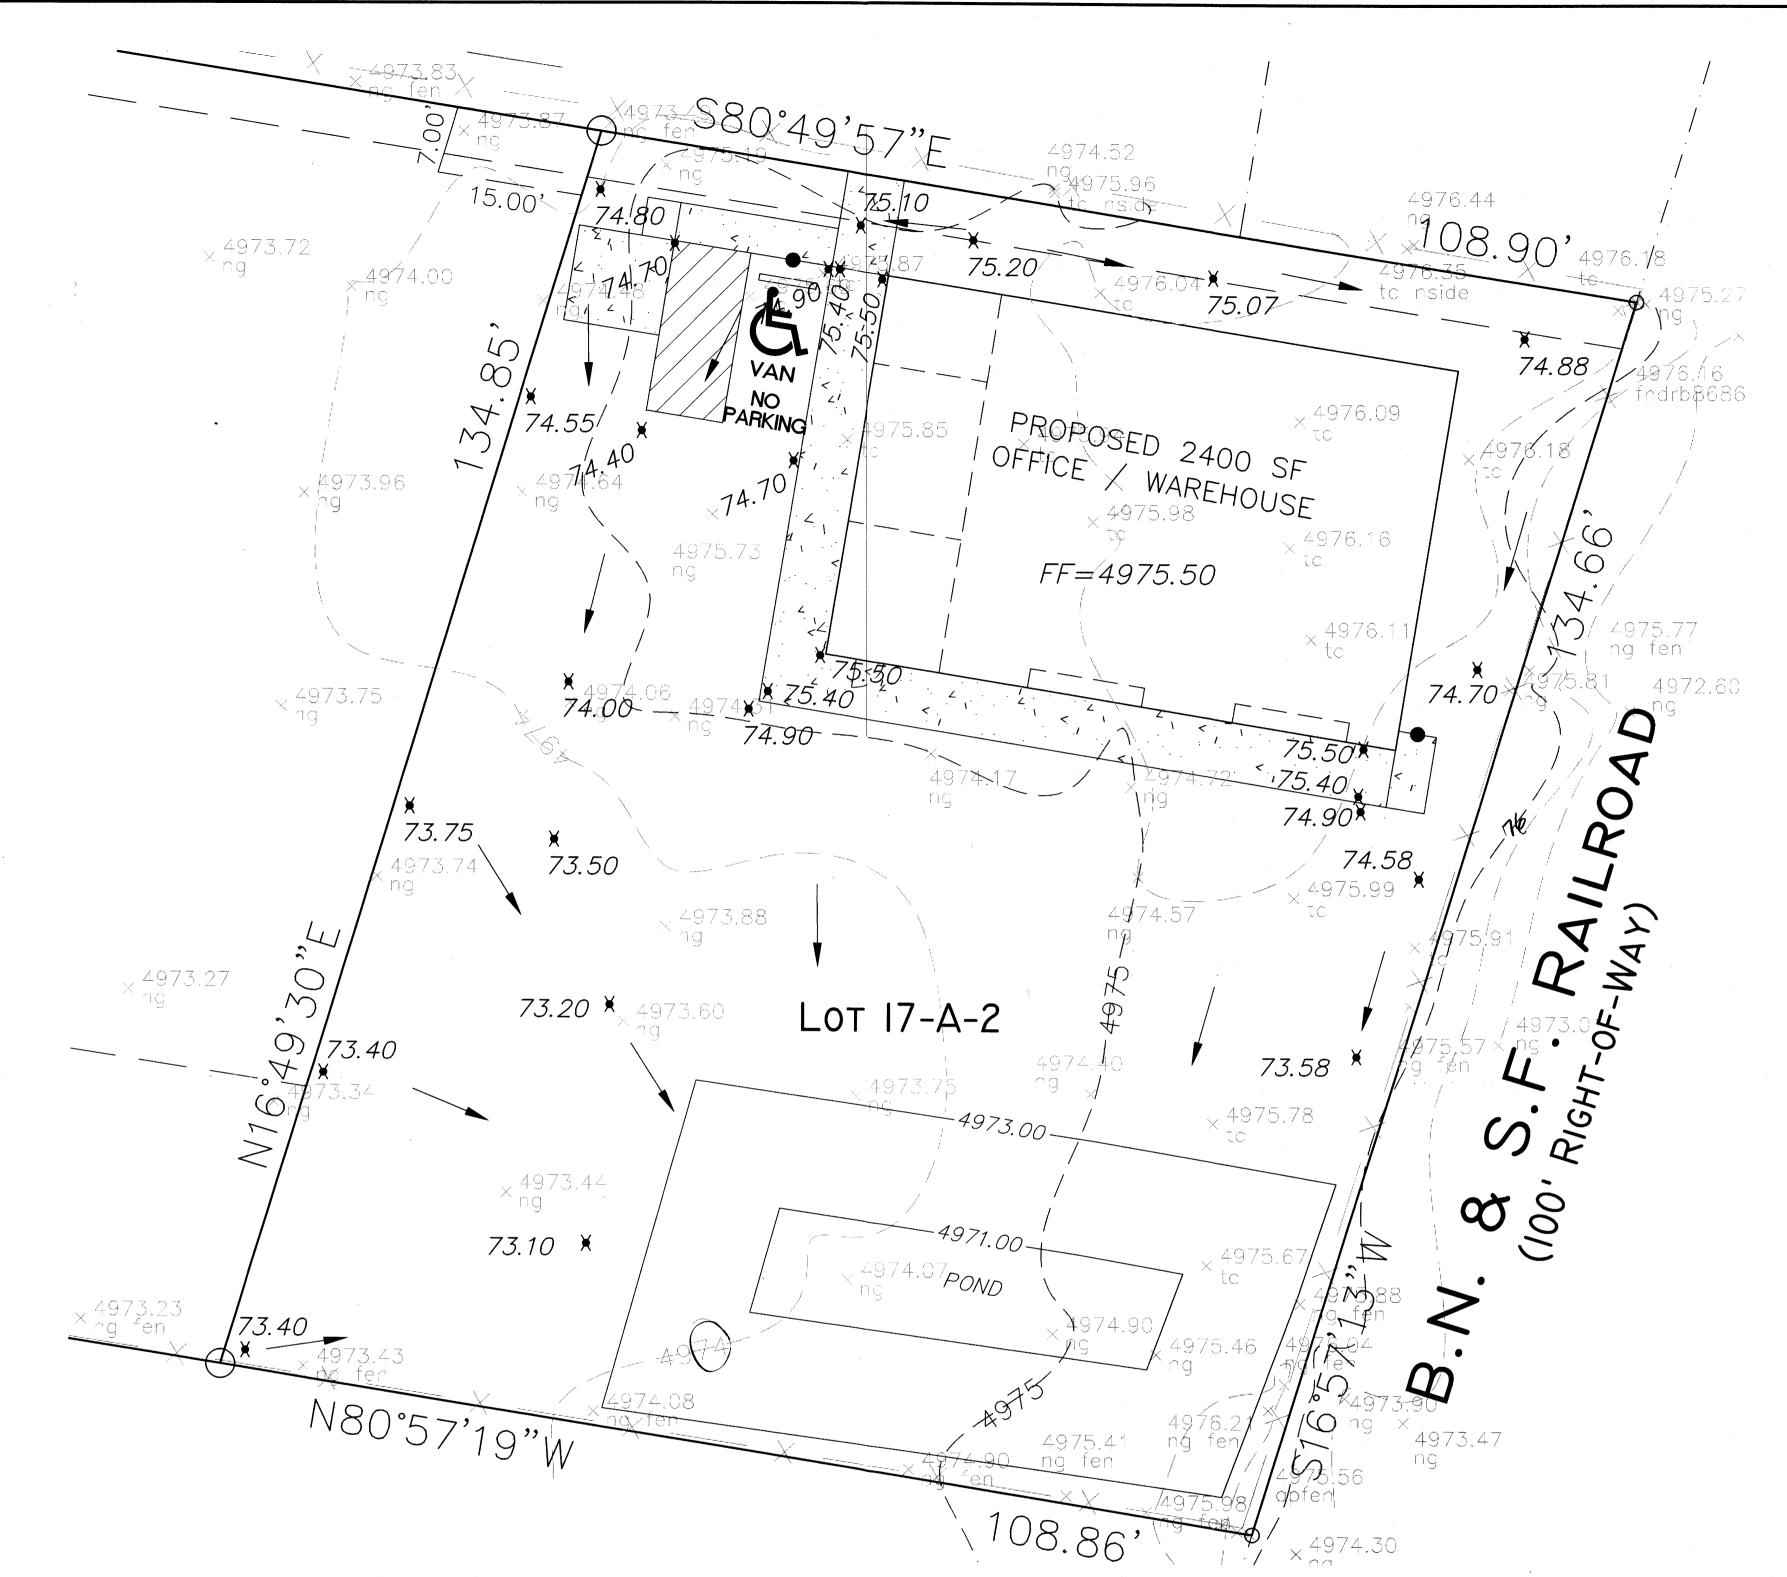AHYMO PROGRAM INPUT FILE = 2ND	SUMMARY TABLI 0-24.TXT	E (AH)	YMO_97)) –	- v	ERSION: 199	7.02d US	RUN DATE (SER NO.= AI	(MON/DAY HYMO—I—9	/YR) =10/ 702c01000l	29/2014 R31-AH
COMMAND	HYDROGRAPH IDENTIFICATION	FROM ID NO.	TO ID NO.	AREA (SQ MI)	PEAK DISCHARGE (CFS)	RUNOFF VOLUME (AC-FT)	RUNOF	TIME TO F PEAR (HOURS)		PAGE NOTATION	
START RAINFALL TYPE= COMPUTE NM HYD START	100.00	, -	1	.00052	.53	.015	.53121	1.533	1.577 F	TIME= RAIN24= PER IMP= TIME=	.00 2.750 .00 .00
RAINFALL TYPE= COMPUTE NM HYD START	110.00	<u> </u>	1	.00052	.13	.003	.12517	1.533	.378 F	RAIN24= PER IMP= TIME=	1.830 .00
RAINFALL TYPE= COMPUTE NM HYD START	100.10	_	1	.00052	1.48	.062	2.21973	1.500	4.451 F	RAIN24=	2.750 85.00 .00
RAINFALL TYPE=	_	_	1	00052	05	079	1 77005	4.500		RAIN24=	1.830

COMPUTE NM HYD

POND CALCULATION A

BOTTOM AREA = 457.56 SF, TOP AREA = 2,309.33 SF, DEPTH = 2.0' VOLUME PROVIDED = $(457.56 + 2,309.33)/2 \times 2 = 2,766.89 \text{ CF}$ 100 YR/24-HR STORM REQUIRED = 0.062 AC-FT = 2,700.72 CF



LEGAL DESCRIPTION:

LOT 17-A-2, PAPPE ADDITION, CONTAININ 0.3334 ACRE

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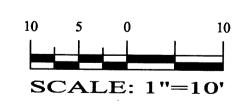
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5: SLOPES ARE AT 3:1 MAXIMUM.

-5100----- EXISTING CONTOUR (MAJOR) EXISTING CONTOUR (MINOR) BOUNDARY LINE PROPOSED SPOT ELEVATION EXISTING GRADE PROPOSED BERM



GRAPHIC SCALE






REZA AFAGHPOUR P.E. #11814


EGEIVE OCT 3 1 2014 SBS CONSTRAIGNET FOR INSECTION AND ENGINEERING, LLC

10209 SNOWFLAKE CT., NW ALBUQUERQUE, NEW MEXICO 87114 (505)804-5013

	3440 2ND STREET, NW GRADING AND DRAINAGE PLAN						
	DRAWING:	DRAWN BY:	DATE:	SHEET#			
••••	201424-GR.DWG	SH-B	10-25-2014	C102			

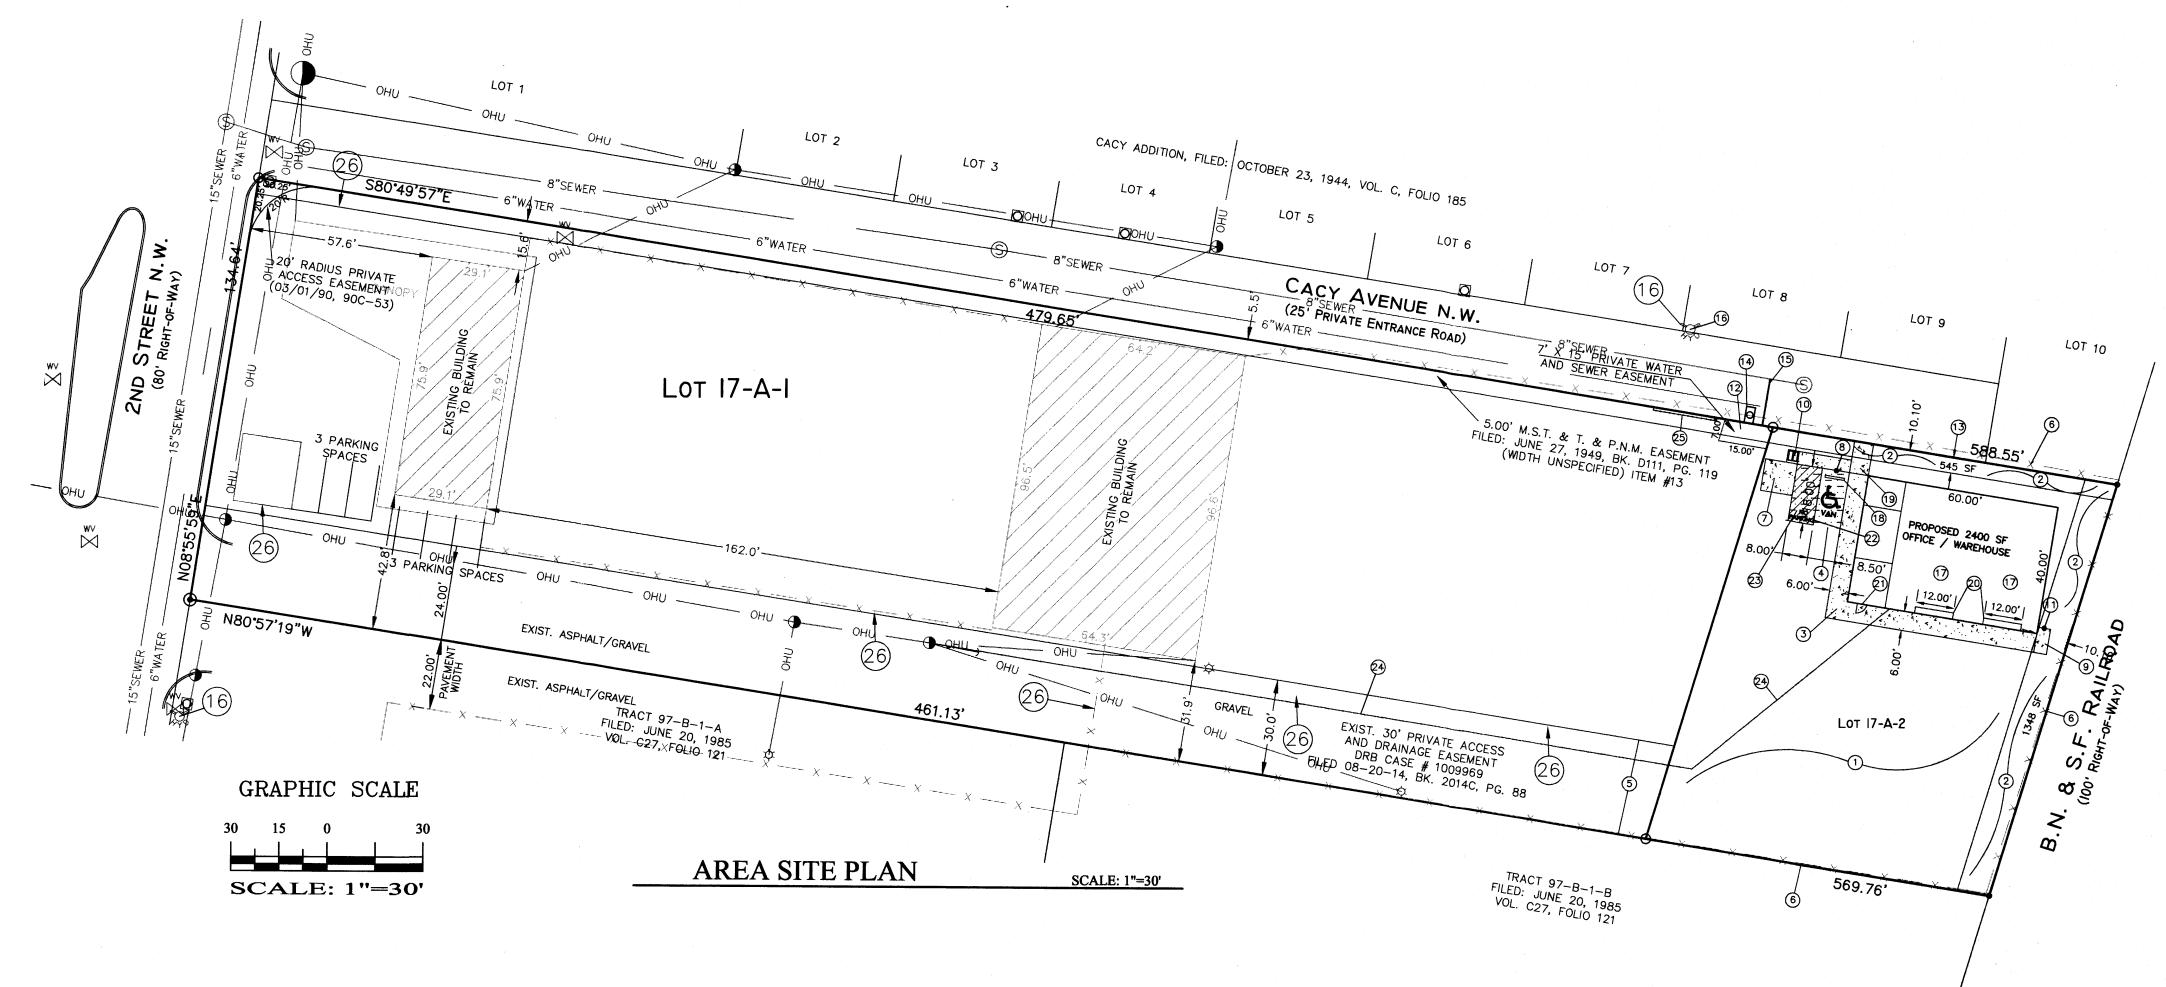


SPECIFICATION FOR SWANSON COLLECTION SITE

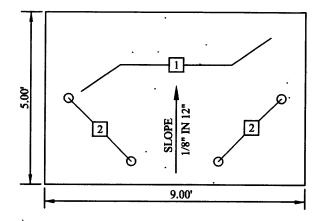

KEYED NOTES:

- 1. CONCRETE SLAB, 4" THICK 3000 PSI (28 DAYS) WITH 3/4" AGGREGATE AND 4X4X1.4 WWF.
- 2. 4" O.D. STEEL PIPE FILLED WITH CONCRETE AND ENCASED IN 6" THICK CONCRETE MINIMUM ALL AROUND BELOW GRADE. CONCRETTE TO BE MINIMUM 30" BELOW GRADE AND POSTS TO BE ABOVE SLAB.

REFUSE BIN SLAB

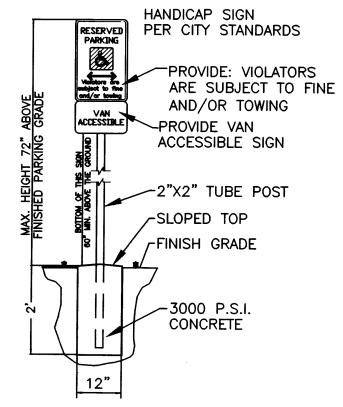

LOCATE SIGN 2' FROM FACE OF CURB OR SW

HANDICAP SIGN DETAIL



- 1. RECYCLED ASPHALT OR GRAVEL AREA, TYP.
- 2. LANDSCAPING AREA. 3. NEW 6' CONCRETE OR ASPHALT (3" THICK) SIDEWALK
- 4. 8.5' WIDE X 18' DEEP HC PARKING SPACE, 3" THICK ASPHALT.
- 5. EXISTING 30' ACCESS EASEMENT
- 6. EXISTING CHAIN LINK FENCE
- 7. 10' BY 10' REFUSE SLAB FOR SWANSON TYPE BIN, PER COA STANDARDS
- 8. HANDICAP SIGN PER COA STANDARDS, MUST HAVE REQUIRED LANGUAGE PER 66-7-352.4C NMSA 1978, "VIOLATORS ARE SUBJECT TO FINE AND/OR TOWING"
- 9. NEW MOTORCYCLE PARKING (4'X8')
- 10. BICYCLE RACK
- 11. MOTORCYCLE PARKING SIGN PER COA STANDARDS
- 12. EXISTING 7' X 15' PRIVATE WATER AND SEWER EASEMENT
- 13. EXISTING 5.00' M.S.T. & T. & P.N.M. EASEMENT
- 14. NEW 3/4" WATER SERVICE (ALREADY INSTALLED) 15. NEW 4" SANITARY SEWER SERVICE (ALREADY INSTALLED)
- 16. EXISTING FIRE HYDRANT
- 17. TWO PARKING SPACE PROVIDED INSIDE THE BUILDING, MIN. 8' BY 18'
- 18. CONCRETE BUMPER INSTALLS
- 19. 4' ASPHALT OR CONCRETE PAD FOR HC ACCESS
- 20. 12' WIDE OVERHEAD DOOR
- 21. PROPOSED OFFICE ENTRY DOOR, 3' WIDE
- 22. "NO PARKING" WORDS IN CAPITAL LETTERS, EACH MIN. 1 FOOT HIGH AND MIN. 2" WIDE
- 23. 8' WIDE X 18' DEEP HC ACCESSIBLE SPACE, 3" THICK ASPHALT.
- 24. PROPOSED UNDER GROUND PNM ELECTRIC LINE
- 25. EMERGENCY ACCESS GATE MIN. 20' WIDE FOR FIRE MARSHAL USE ONLY WITH KNOX BOX.

26. ACCESS LOCATIONS FOR LOT 17-A-1



GRAPHIC SCALE

SCALE: 1"=20"

PROPERTY SITE PLAN

Public Infrastructure shown on these plans for information only and not part of approval.
Separate DRC/Permit approval
and Work Order required.

108.90'


\(\frac{0}{2}\)

PROPOSED 2400 SF OFFICE / WAREHOUSE

Lot 17-A-2

108.86

SCALE: 1"=20'

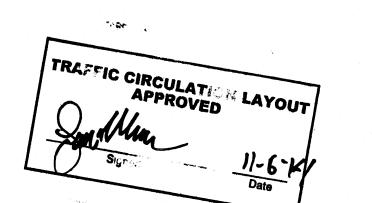



LEGAL DESCRIPTION:

LOT 17-A-2, PAPPE ADDITION CONTAINING 14,521.42 S.F. (0.3334 ACRE) ZONING: M-1

SITE DATA

PROPOSED USAGE: LOT AREA:

OFFICE/WAREHOUSE 14,521.42 S.F. (0.3334 ACRE)

OFFICE AREA: 400.00 S.F. WAREHOUSE AREA: 2,000.00 S.F. TOTAL 2,400.00 S.F.

LANDSCAPE CALCULATIONS: NET LOT AREA (14,521-2400) LANDSCAPING REQUIRED:

12,121.00 SF ± 1,818.15 SF ± 15% OF 18,200.00 SF LANDSCAPE PROVIDED 1,893.00 SF ±

PARKING CALCULATIONS

PARKING REQUIRED: OFFICE:

WAREHOUSE:

400 SF/200 = 2 SPACES 2000 SF/2000 = 1 SPACES TOTAL 3 SPACES

TOTAL PARKING REQUIRED: 3 SPACES TOTAL PARKING PROVIDED: (10UTSIDE AND 2 INSIDE) 3 SPACES

HC PARKING REQUIRED: 1 SPACES (1 VAN) HC PARKING PROVIDED: 1 SPACES (1 VAN)

MOTORCYCLE SPACES REQUIRED: MOTORCYCLE SPACES PROVIDED:

LEGEND

BOUNDARY LINE EASEMENT LINE EXISTING OVERHEAD UTILITY EXISTING CURB & GUTTER EXISTING CHAIN LINK FENCE ----X EXISTING SIDEWALK EXISTING FIRE HYDRANT X 0 EXISTING WATER SERVICE EXISTING DROP INLET PROPOSED SIDEWALK PROPOSED 3" THICK ASPHALT AREA



REZA AFAGHPOUR P.E. #11814

SBS CONSTRUCTION AND ENGINEERING, LLC

1 SPACES

1 SPACES

10209 SNOWFLAKE CT., NW ALBUQUERQUE, NEW MEXICO 87114 (505)804-5013


3440 2ND STREET, NW SITE PLAN FOR BUILDING PERMIT DRAWING:


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201424-SP.DWG SH-B

10-05-2014

C101




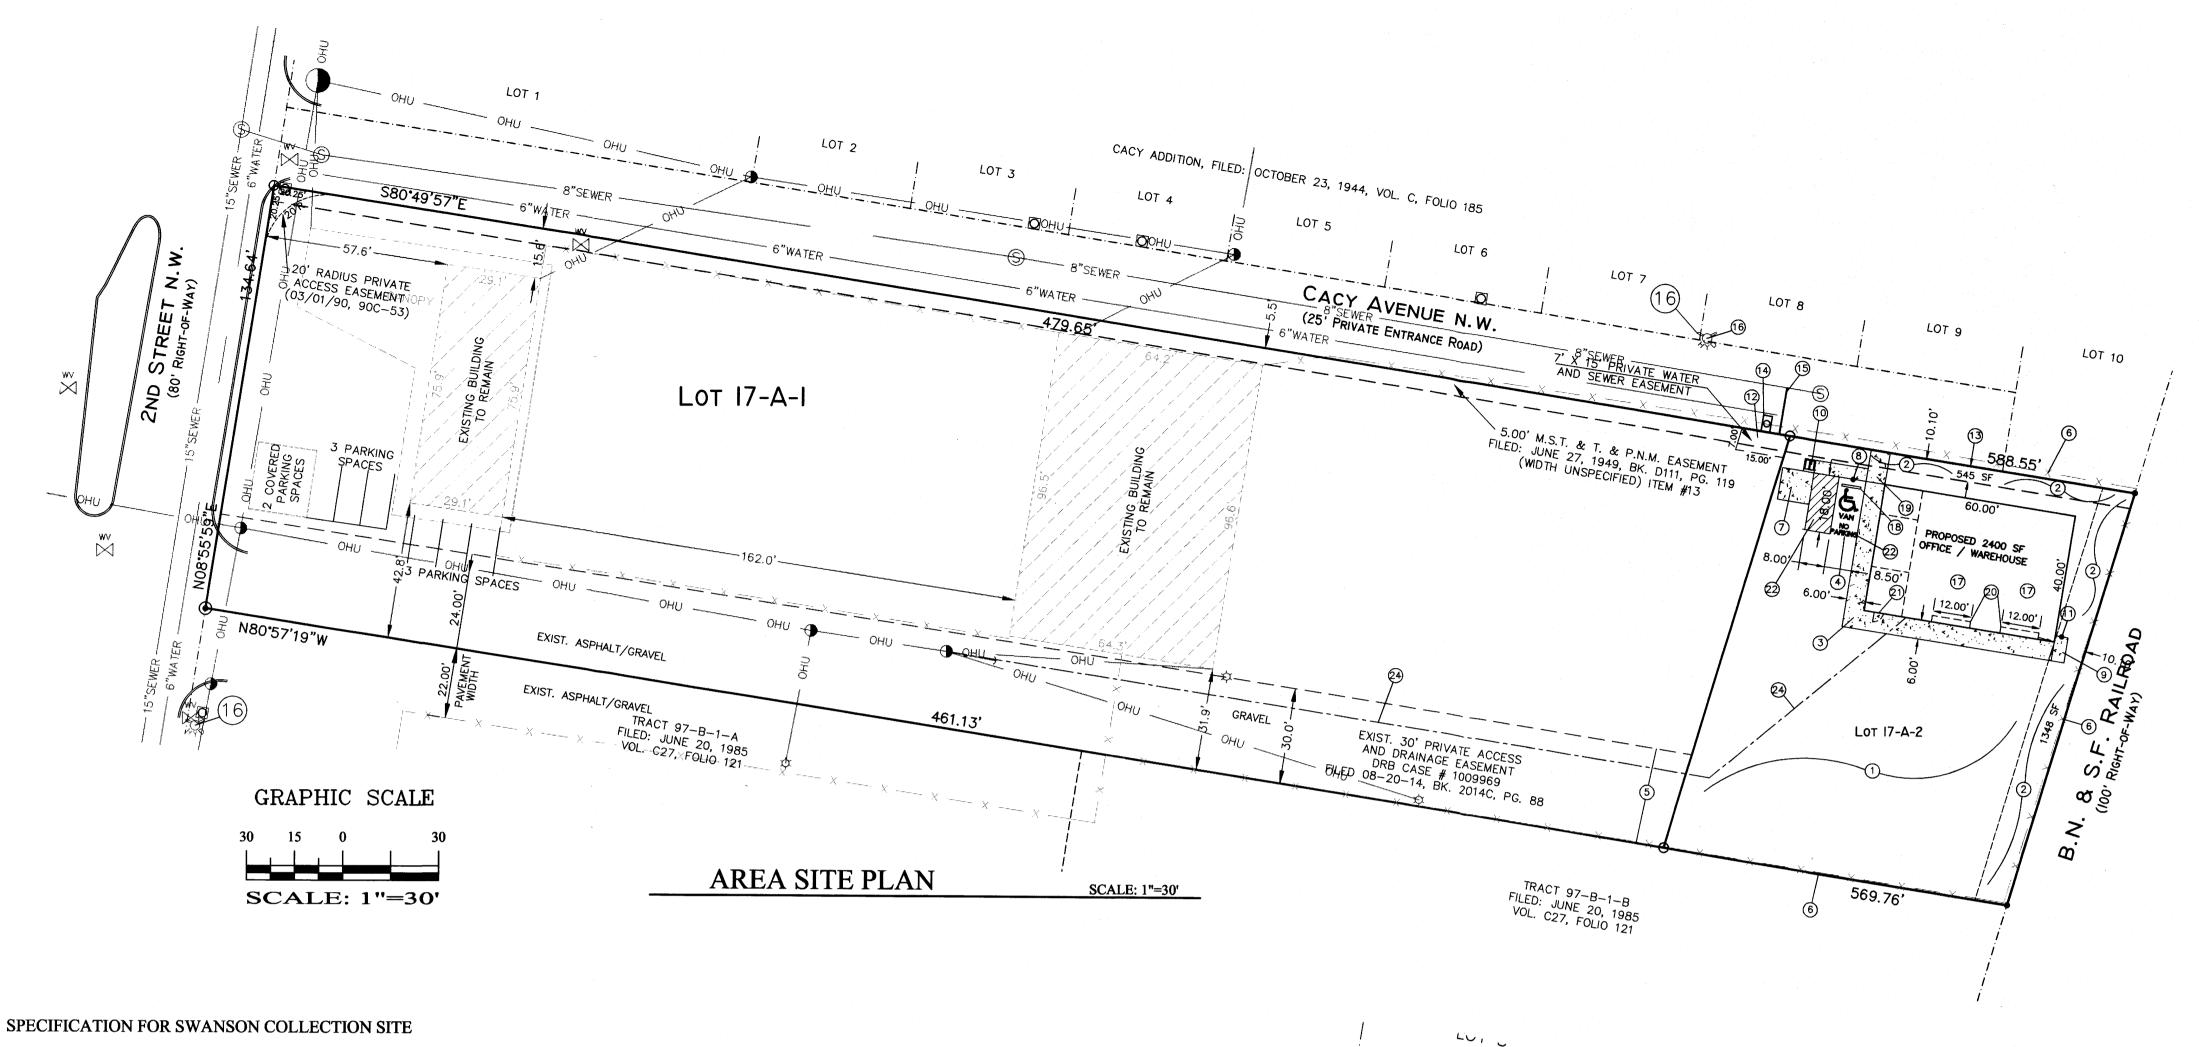

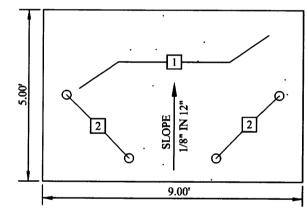KEYED NOTES:

- 1. CONCRETE SLAB, 4" THICK 3000 PSI (28 DAYS) WITH 3/4" AGGREGATE AND 4X4X1.4 WWF.
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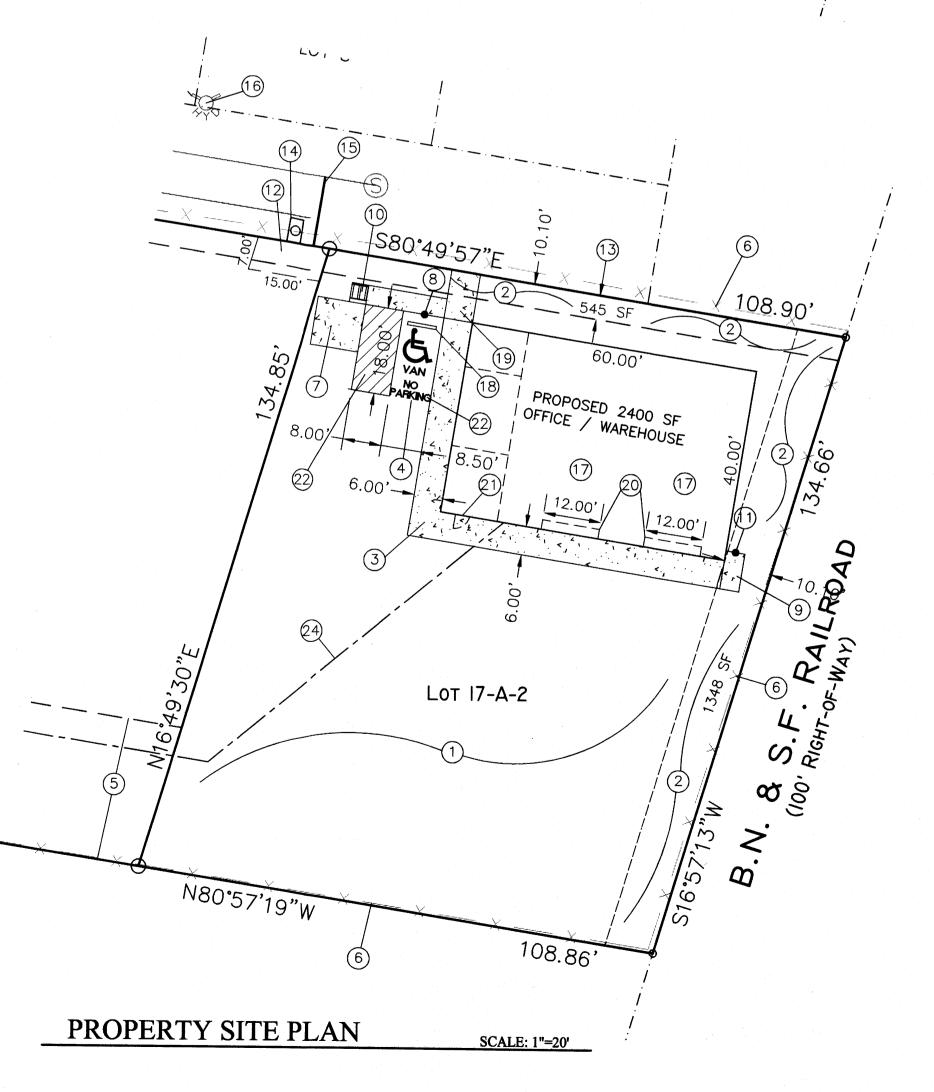
REFUSE BIN SLAB

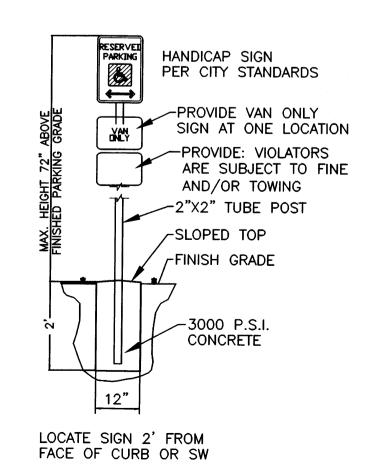


HANDICAP SIGN DETAIL

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SCALE: 1"=20'



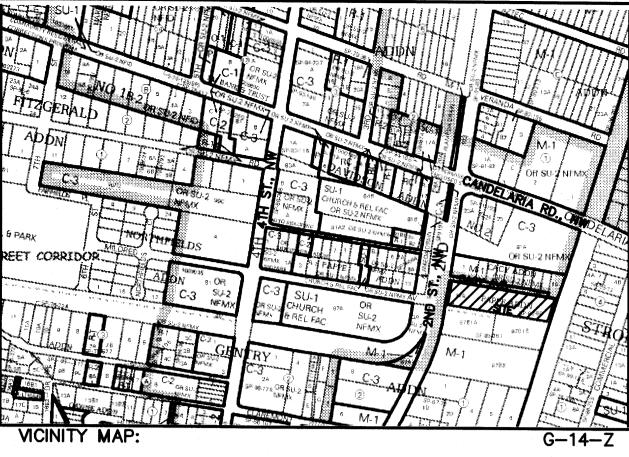

LEGAL DESCRIPTION:

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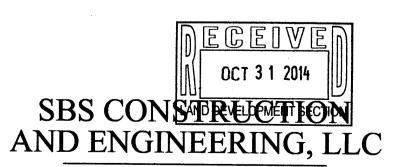
LEGEND

BOUNDARY LINE EASEMENT LINE ______ EXISTING OVERHEAD UTILITY EXISTING CURB & GUTTER ____ x ___ x ___ x ___ x ___ x ___ EXISTING CHAIN LINK FENCE EXISTING SIDEWALK EXISTING FIRE HYDRANT [፬] EXISTING WATER SERVICE EXISTING DROP INLET PROPOSED SIDEWALK



REZA AFAGHPOUR P.E. #11814

LAST REVISION: 10-31-14




1 SPACES


1 SPACES

10209 SNOWFLAKE CT., NW ALBUQUERQUE, NEW MEXICO 87114 (505)804-5013

3440 2ND STREET, NW SITE PLAN FOR BUILDING PERMIT DRAWING: DRAWN BY: DATE:

C101 201424-SP.DWG SH-B 10-05-2014

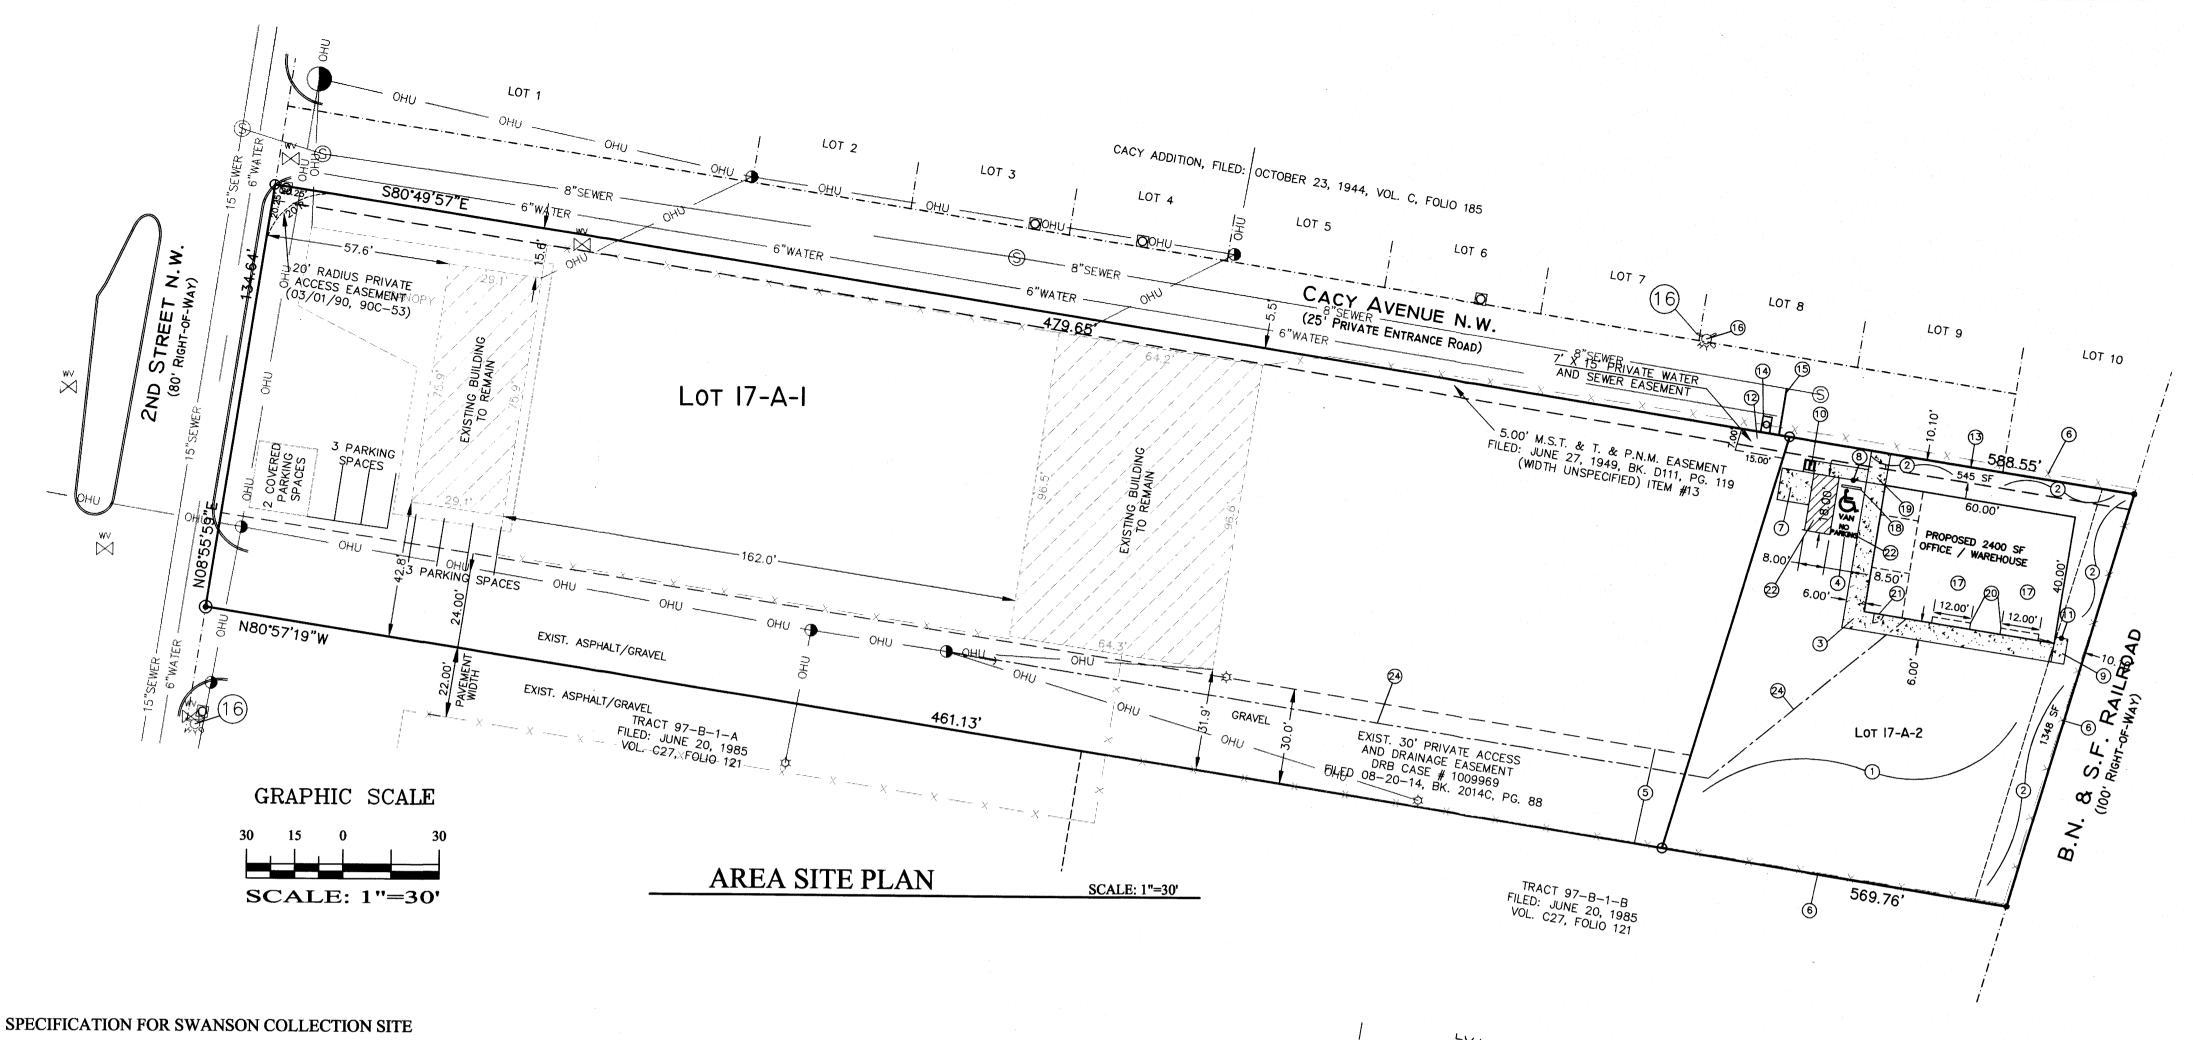


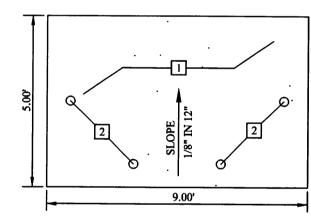


KEYED NOTES: □

- 1. CONCRETE SLAB, 4" THICK 3000 PSI (28 DAYS) WITH 3/4" AGGREGATE AND 4X4X1.4 WWF.
- 2. 4" O.D. STEEL PIPE FILLED WITH CONCRETE AND ENCASED IN 6" THICK CONCRETE MINIMUM ALL AROUND BELOW GRADE. CONCRETTE TO BE MINIMUM 30" BELOW GRADE AND POSTS TO BE ABOVE SLAB.

REFUSE BIN SLAB

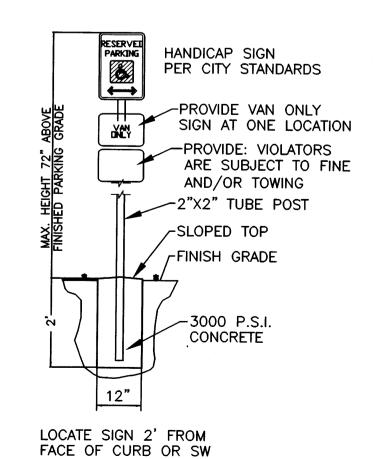

HANDICAP SIGN DETAIL

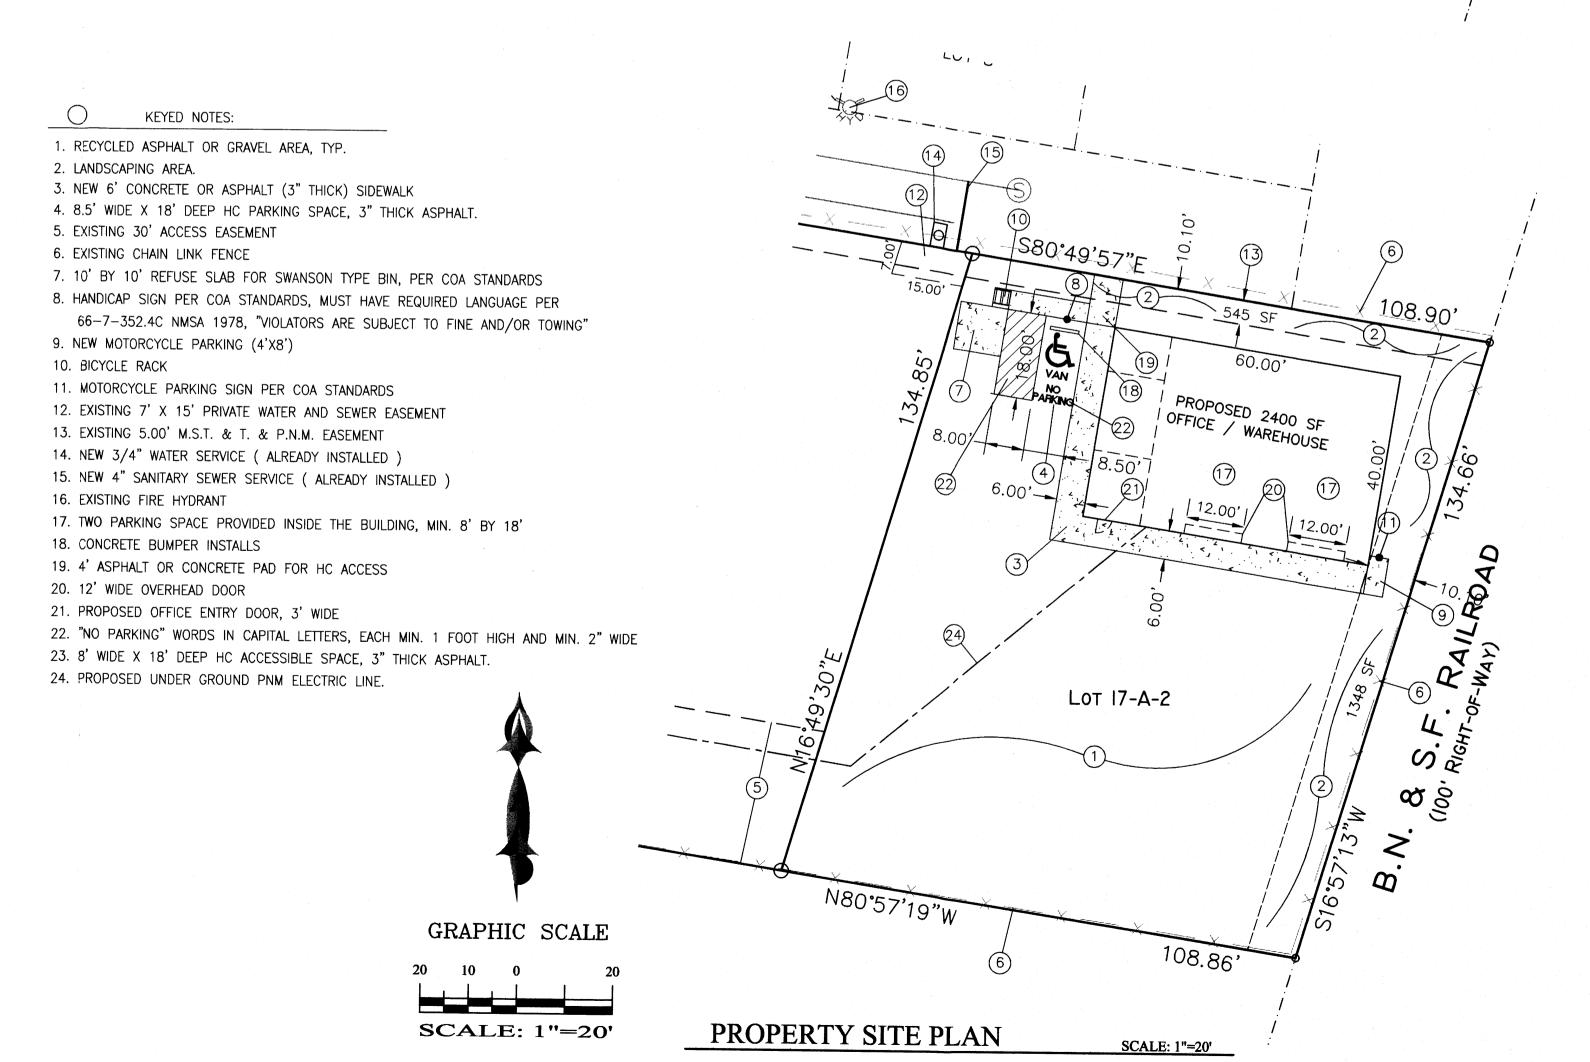



LEGAL DESCRIPTION: LOT 17-A-2, PAPPE ADDITION

CONTAINING 14,521.42 S.F. (0.3334 ACRE) ZONING: M-1

SITE DATA

PROPOSED USAGE: OFFICE/WAREHOUSE LOT AREA: 14,521.42 S.F. (0.3334 ACRE) OFFICE AREA: 400.00 S.F. WAREHOUSE AREA: 2,000.00 S.F. TOTAL 2,400.00 S.F.

LANDSCAPE CALCULATIONS: NET LOT AREA (14,521-2400) 12,121.00 SF ± LANDSCAPING REQUIRED: 1,818.15 SF ± 15% OF 18,200.00 SF LANDSCAPE PROVIDED 1,893.00 SF ±

PARKING CALCULATIONS:

PARKING REQUIRED:

OFFICE: 400 SF/200 = 2 SPACES WAREHOUSE: 2000 SF/2000 = 1 SPACES TOTAL 3 SPACES TOTAL PARKING REQUIRED: 3 SPACES TOTAL PARKING PROVIDED: (10UTSIDE AND 2 INSIDE) 3 SPACES HC PARKING REQUIRED: 1 SPACES (1 VAN) HC PARKING PROVIDED: 1 SPACES (1 VAN) MOTORCYCLE SPACES REQUIRED: 1 SPACES

LEGEND

MOTORCYCLE SPACES PROVIDED:

BOUNDARY LINE EASEMENT LINE EXISTING OVERHEAD UTILITY EXISTING CURB & GUTTER EXISTING CHAIN LINK FENCE EXISTING SIDEWALK EXISTING FIRE HYDRANT [2] EXISTING WATER SERVICE EXISTING DROP INLET PROPOSED SIDEWALK



REZA AFAGHPOUR P.E. #11814


ECEIVE OCT 3 1 2014 SBS CONSTRUCTION AND ENGINEERING, LLC

1 SPACES


10209 SNOWFLAKE CT., NW ALBUQUERQUE, NEW MEXICO 87114 (505)804-5013

3440 2ND STREET, NW SITE PLAN FOR BUILDING PERMIT

DRAWING: DRAWN BY: DATE: SHEET# C101 201424-SP.DWG SH-B 10-05-2014

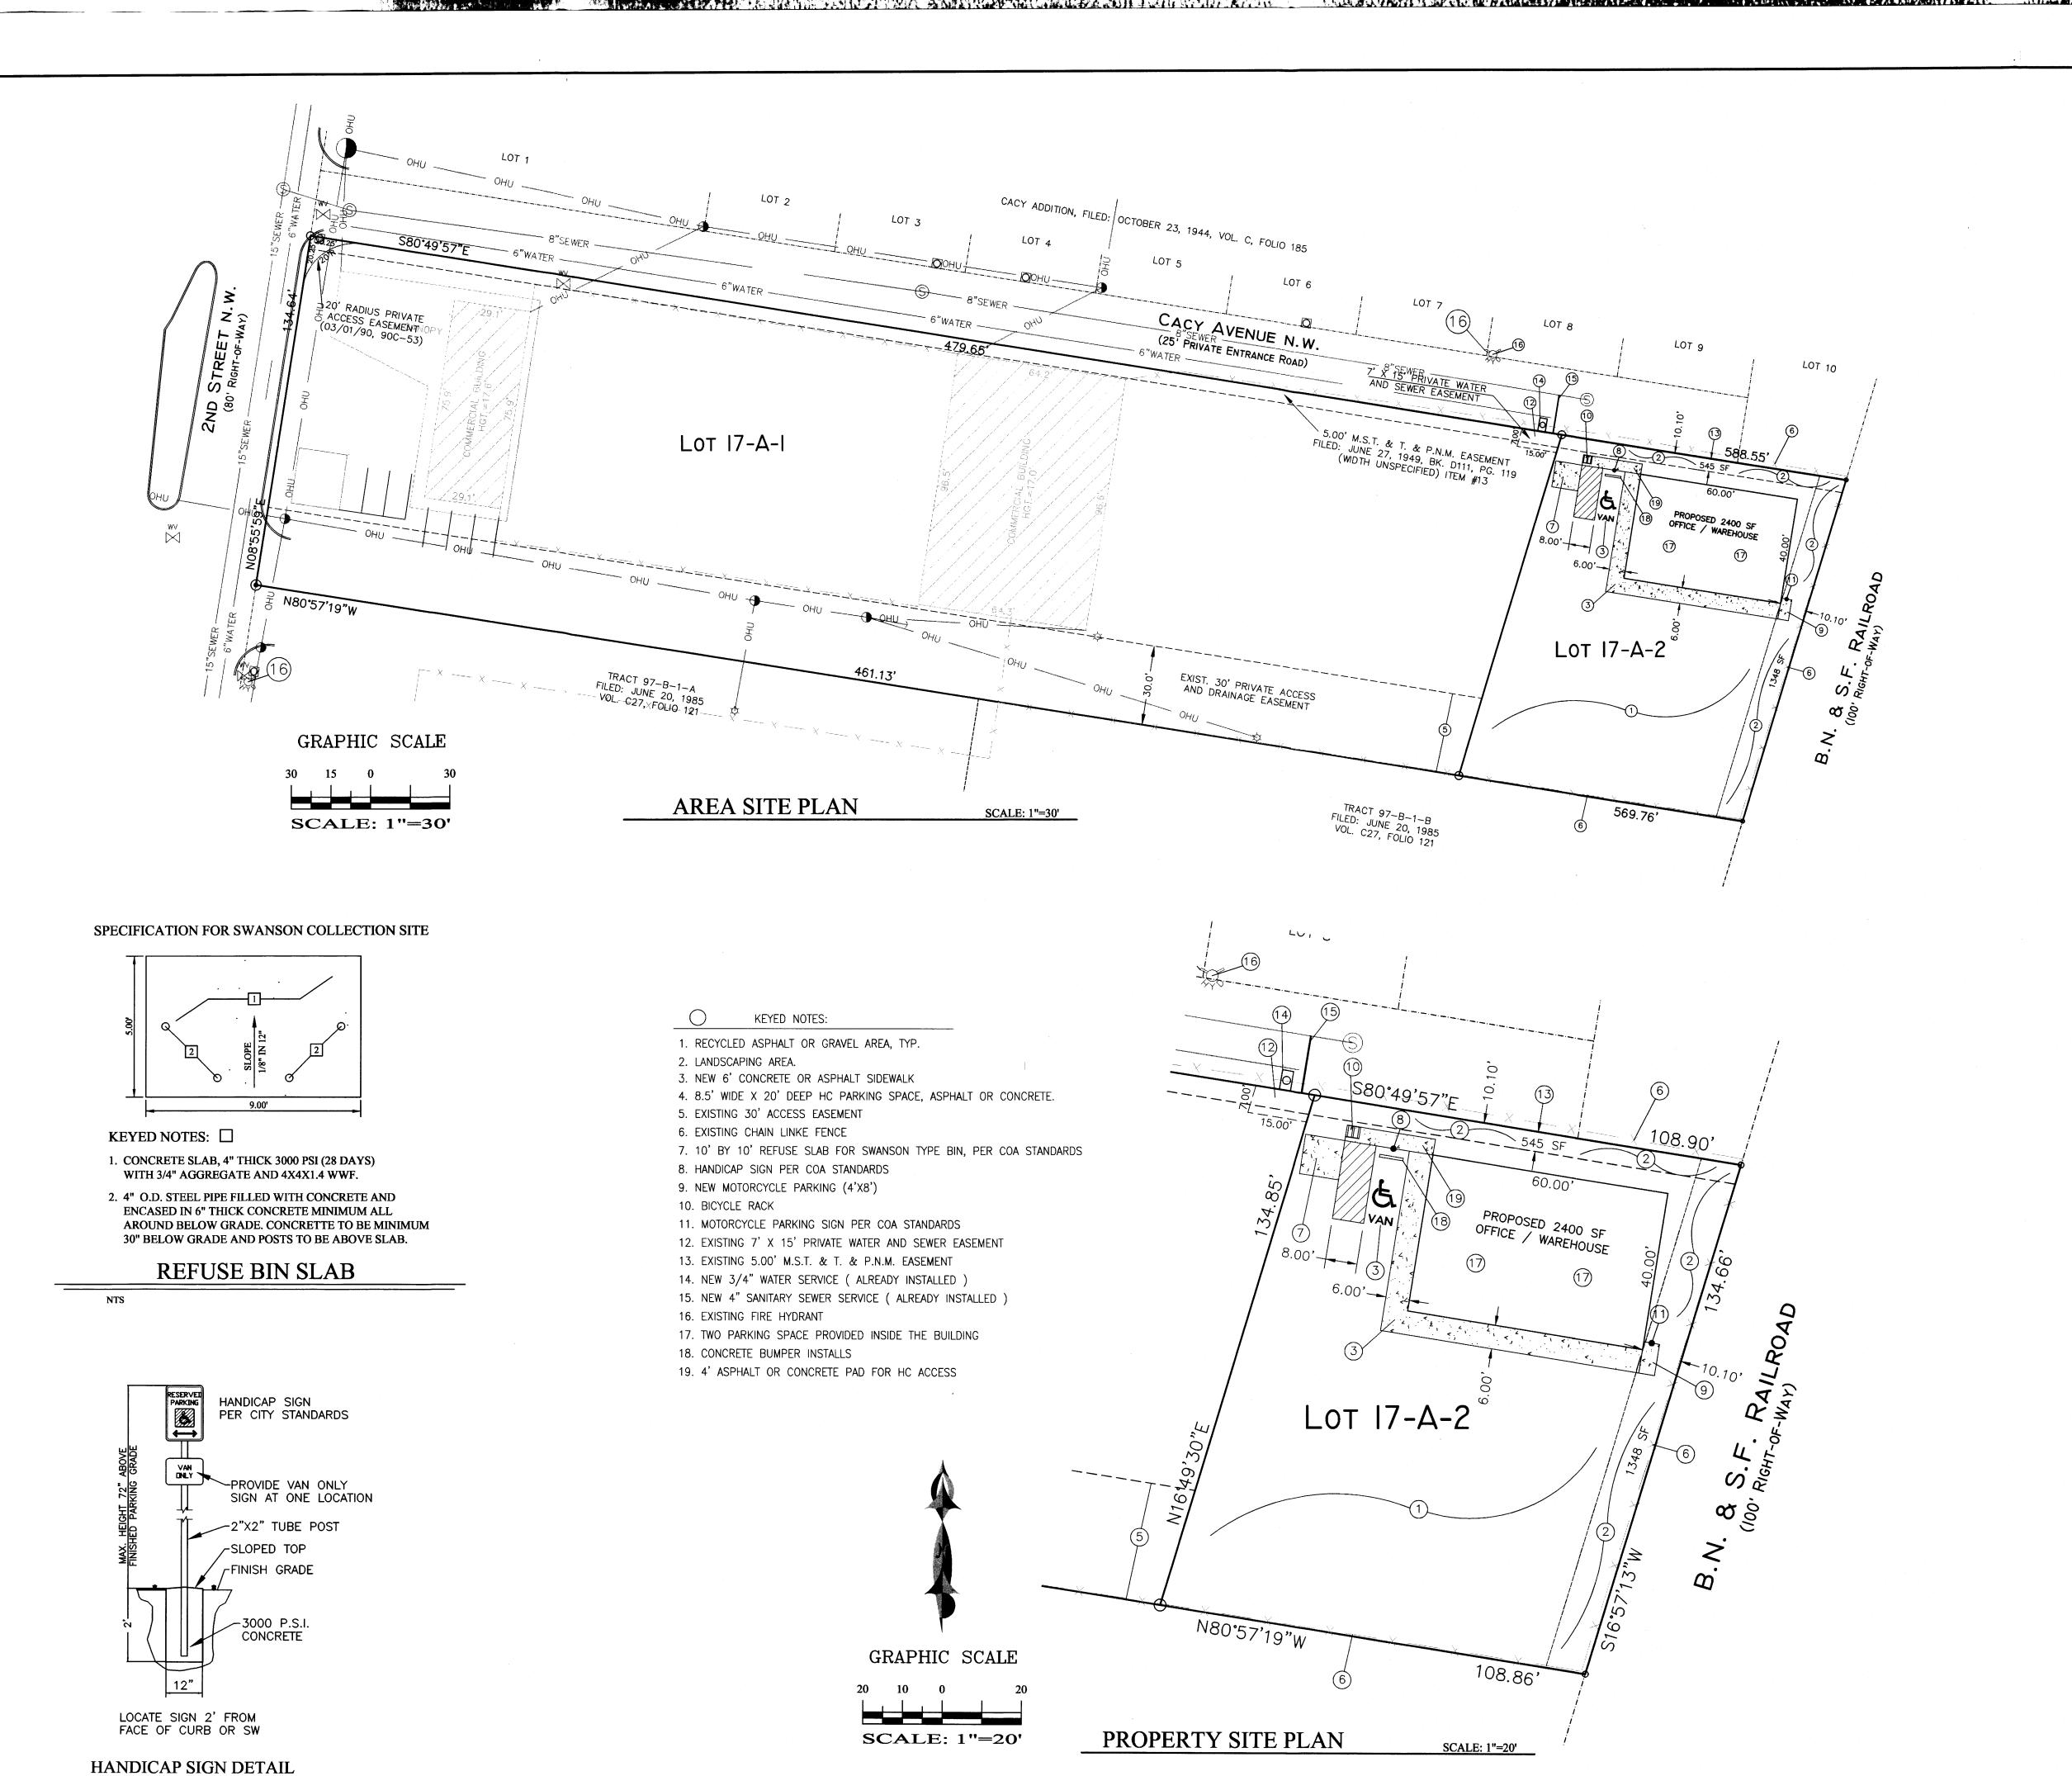

NTS

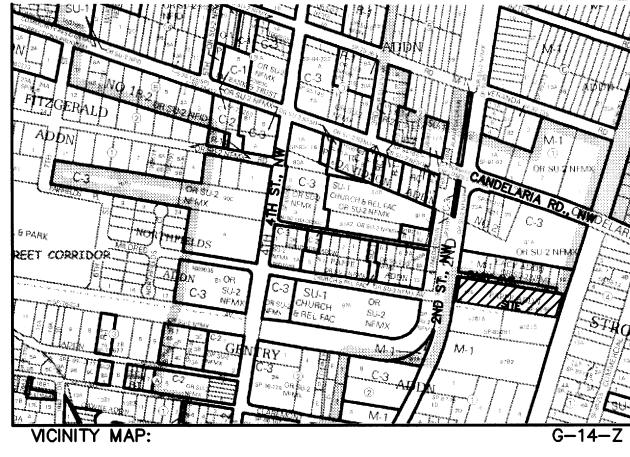

LEGAL DESCRIPTION:

LOT 17-A-2, PAPPE ADDITION CONTAINING 14,521.42 S.F. (0.3334 ACRE) ZONING: M-1

SITE DATA

PROPOSED USAGE:	OFFICE/WAREHOUSE			
LOT AREA:	14,521.42 S.F. (0.3334 ACRE			
OFFICE AREA:	400.00 S.F.			
WAREHOUSE AREA:	2,000.00 S.F.			

TOTAL 2,400.00 S.F.

LANDSCAPE CALCULATIONS:	
NET LOT AREA (14,521-2400)	12,121.00 SF ±
LANDSCAPING REQUIRED:	1,818.15 SF ±
15% OF 18,200.00 SF	
LANDSCAPE PROVIDED	1,893.00 SF ±

TOTAL PARKING PROVIDED: (10UTSIDE AND 2 INSIDE)

PARKING CALCULATIONS: PARKING REQUIRED:

HC PARKING PROVIDED:

OFFICE: WAREHOUSE:	400 SF/200 2000 SF/2000	2 SPACES 1 SPACES
	TOTAL	3 SPACES
TOTAL PARKING REQUIRED:		3 SPACES

3 SPACES HC PARKING REQUIRED: 1 SPACES (1 VAN)

1 SPACES (1 VAN)

MOTORCYCLE SPACES REQUIRED: 1 SPACES MOTORCYCLE SPACES PROVIDED: 1 SPACES

LEGEND

	BOUNDARY LINE
	EASEMENT LINE
Chu-Chu-Chu-Chu-Chu-Chu-Chu-	EXISTING OVERHEAD UTILITY
	EXISTING CURB & GUTTER
X X X X X	EXISTING CHAIN LINK FENCE
	EXISTING SIDEWALK
, ÇÇ	EXISTING FIRE HYDRANT
Ø	EXISTING WATER SERVICE
ET YE CHE DOE	EXISTING DROP INLET
	PROPOSED SIDEWALK



REZA AFAGHPOUR

P.E. #11814

SBS CONSTRUCTION AND ENGINEERING, LLC

10209 SNOWFLAKE CT., NW ALBUQUERQUE, NEW MEXICO 87114 (505)804-5013

	3440 2ND STREET, NW SITE PLAN FOR BUILDING PERMIT						
	DRAWING:	DRAWN BY:	DATE:	SHEET#			
-13	201424-SP.DWG	SH-B	05-29-2013	C101			