CITY OF ALBUQUERQUE



Planning Department Transportation Development Services

November 6, 2014

Shawn Biazar, P.E. SBS Construction and Engineering, LLC 10209 Snowflake Ct., NW Albuquerque, NM 87114

Re: Office Warehouse, 3440 2nd Street NW

Traffic Circulation Layout

Engineer's/Architect's Stamp dated 11-03-14 (G14-D087)

Dear Mr. Biazar:

The TCL submittal received 11-06-14 is approved for Building Permit. A copy of the stamped and signed plan will be needed for each of the building permit plans. Please keep the original to be used for certification of the site for final C.O. for Transportation. Public infrastructure or work done within City Right-of-Way shown on these plans is for information only and is not part of approval. A separate DRC or other appropriate permit is required to construct these items.

Albuquerque

PO Box 1293

When the site construction is completed and a Certificate of Occupancy (C.O.) is requested, use the original City stamped approved TCL for certification. Redline any minor changes and adjustments that were made in the field. A NM registered architect or engineer must stamp, sign, and date the certification TCL along with indicating that the development was built in "substantial compliance" with the TCL. Submit this certification TCL with a completed <u>Drainage and Transportation Information Sheet</u> to front counter personnel for log in and evaluation by Transportation.

www.cabq.gov

New Mexico 87103

Once verification of certification is completed and approved, notification will be made to Building Safety to issue Final C.O. To confirm that a final C.O. has been issued, call Building Safety at 924-3306.

Sincerely,

Jeanne Wolfenbarger, P.E. Senior Engineer, Planning Dept. Development Review Services

C: File



City of Albuquerque

Planning Department


Development & Building Services Division

DRAINAGE AND TRANSPORTATION INFORMATION SHEET (REV 02/2013)


Project Title: 3440 2ND STREET, NW	Building Permit #:	City Drainage #: <u>G14-078</u>	
DRB#: EPC#:		Work Order#:	
Legal Description: LOT 17-A-2, PAPPE ADDIT	ION		
City Address: 3440 2ND STREET, NW			
Engineering Firm: SBS CONSTRUCTION AN	D ENGINEEPING II C	Contact, CHAWAI DIAZAD	
Address: 10209 SNOWFLAKE CT., NW, AL	B NM 87114	Contact: SHAWN BIAZAR	
Phone#: 505-804-5013 Fax#:	., 1441 07114	F-mail: AFCLLC@AOLCOM	
Owner:		Contact:	
Address: Phone#: Fax#:			
Phone#: Fax#:		E-mail:	
Architect:		Contact:	
Address:			
Phone#: Fax#:		E-mail:	
Surveyor:		Contact:	
Address:			
Phone#: Fax#:		E-mail:	
Contractor:			
Address:			
Phone#: Fax#:		E-mail:	
TYPE OF SUBMITTAL:		AL/ACCEPTANCE SOUGHT:	
DRAINAGE REPORT	SIA/FINANCIAL GUARAN'		
DRAINAGE PLAN 1st SUBMITTAL	PRELIMINARY PLAT APPR		
DRAINAGE PLAN RESUBMITTAL	S. DEV. PLAN FOR SUB'D		
CONCEPTUAL G & D PLAN	X S. DEV. FOR BLDG. PERMIT APPROVAL		
GRADING PLAN	SECTOR PLAN APPROVAL		
EROSION & SEDIMENT CONTROL PLAN (ESC) FINAL PLAT APPROVAL			
	ENGINEER'S CERT (HYDROLOGY) CERTIFICATE OF OCCUPANCY (PERM)		
CLOMR/LOMR	CERTIFICATE OF OCCUPANCY (TCL TEMP)		
X TRAFFIC CIRCULATION LAYOUT (TCL)	AFFIC CIRCULATION LAYOUT (TCL) FOUNDATION PERMIT APPROVAL		
ENGINEER'S CERT (TCL)	X BUILDING PERMIT APPRO		
ENGINEER'S CERT (DRB SITE PLAN)	GRADING PERMIT APPRO		
ENGINEER'S CERT (ESC)	PAVING PERMIT APPROVA		
SO-19	WORK ORDER APPROVAL		
OTHER (SPECIFY)	GRADING CERTIFICATION		
WAS A PRE-DESIGN CONFERENCE ATTENDED:	Yes X No Co	,	
DATE SUBMITTED: 11-6-14	By: SHAWN RIATAR	py Provided	

Requests for approvals of Site Development Plans and/or Subdivision Plats shall be accompanied by a drainage submittal. The particular nature, location, and scope to the proposed development defines the degree of drainage detail. One or more of the following levels of submittal may be required based on the followin Conceptual Grading and Drainage Plan: Required for approval of Site Development Plans greater than five (5) acres and Sector Plans

- Drainage Plans: Required for building permits, grading permits, paving permits and site plans less than five (5) acres
- Drainage Report: Required for subdivision containing more than ten (10) lots or constituting five (5) acres or more
- Erosion and Sediment Control Plan: Required for any new development and redevelopment site with 1-acre or more of land disturbing area, including project less than 1-acre than are part of a larger common plan of development

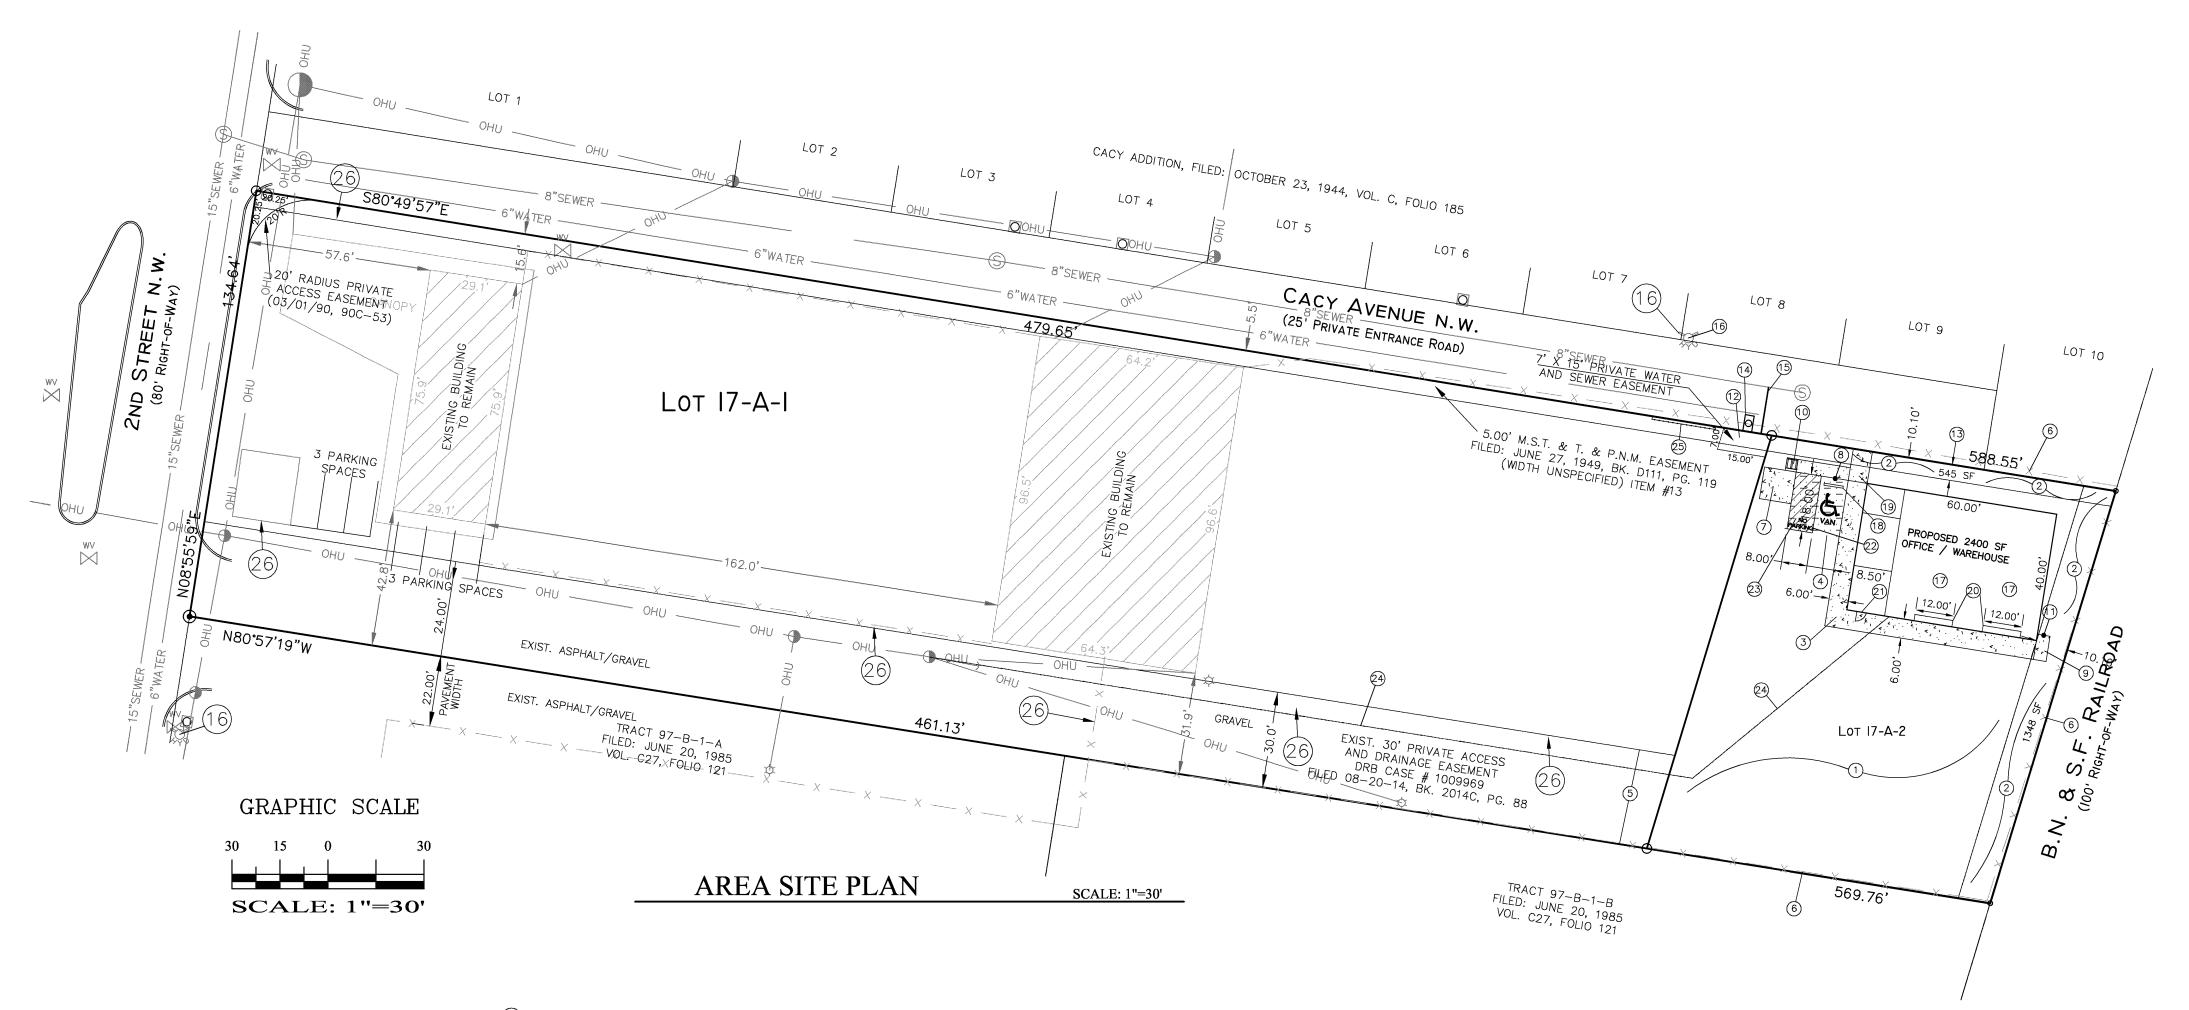


SPECIFICATION FOR SWANSON COLLECTION SITE

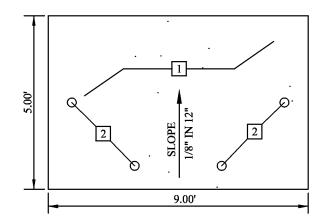

KEYED NOTES:


- 1. CONCRETE SLAB, 4" THICK 3000 PSI (28 DAYS) WITH 3/4" AGGREGATE AND 4X4X1.4 WWF.
- 2. 4" O.D. STEEL PIPE FILLED WITH CONCRETE AND ENCASED IN 6" THICK CONCRETE MINIMUM ALL AROUND BELOW GRADE. CONCRETTE TO BE MINIMUM 30" BELOW GRADE AND POSTS TO BE ABOVE SLAB.

REFUSE BIN SLAB

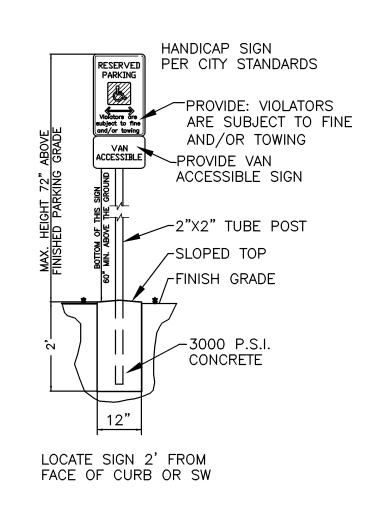


KEYED NOTES:

- 1. RECYCLED ASPHALT OR GRAVEL AREA, TYP.
- 2. LANDSCAPING AREA.
- 3. NEW 6' CONCRETE OR ASPHALT (3" THICK) SIDEWALK
- 4. 8.5' WIDE X 18' DEEP HC PARKING SPACE, 3" THICK ASPHALT.
- 5. EXISTING 30' ACCESS EASEMENT
- 6. EXISTING CHAIN LINK FENCE
- 7. 10' BY 10' REFUSE SLAB FOR SWANSON TYPE BIN, PER COA STANDARDS
- 8. HANDICAP SIGN PER COA STANDARDS, MUST HAVE REQUIRED LANGUAGE PER 66-7-352.4C NMSA 1978, "VIOLATORS ARE SUBJECT TO FINE AND/OR TOWING"
- 9. NEW MOTORCYCLE PARKING (4'X8')
- 10. BICYCLE RACK
- 11. MOTORCYCLE PARKING SIGN PER COA STANDARDS
- 12. EXISTING 7' X 15' PRIVATE WATER AND SEWER EASEMENT
- 13. EXISTING 5.00' M.S.T. & T. & P.N.M. EASEMENT
- 14. NEW 3/4" WATER SERVICE (ALREADY INSTALLED) 15. NEW 4" SANITARY SEWER SERVICE (ALREADY INSTALLED)
- 16. EXISTING FIRE HYDRANT
- 18. CONCRETE BUMPER INSTALLS
- 19. 4' ASPHALT OR CONCRETE PAD FOR HC ACCESS
- 20. 12' WIDE OVERHEAD DOOR
- 21. PROPOSED OFFICE ENTRY DOOR, 3' WIDE
- 22. "NO PARKING" WORDS IN CAPITAL LETTERS, EACH MIN. 1 FOOT HIGH AND MIN. 2" WIDE
- 23. 8' WIDE X 18' DEEP HC ACCESSIBLE SPACE, 3" THICK ASPHALT.
- 24. PROPOSED UNDER GROUND PNM ELECTRIC LINE
- 25. EMERGENCY ACCESS GATE MIN. 20' WIDE FOR FIRE MARSHAL USE ONLY WITH KNOX BOX.
- 26. ACCESS LOCATIONS FOR LOT 17-A-1

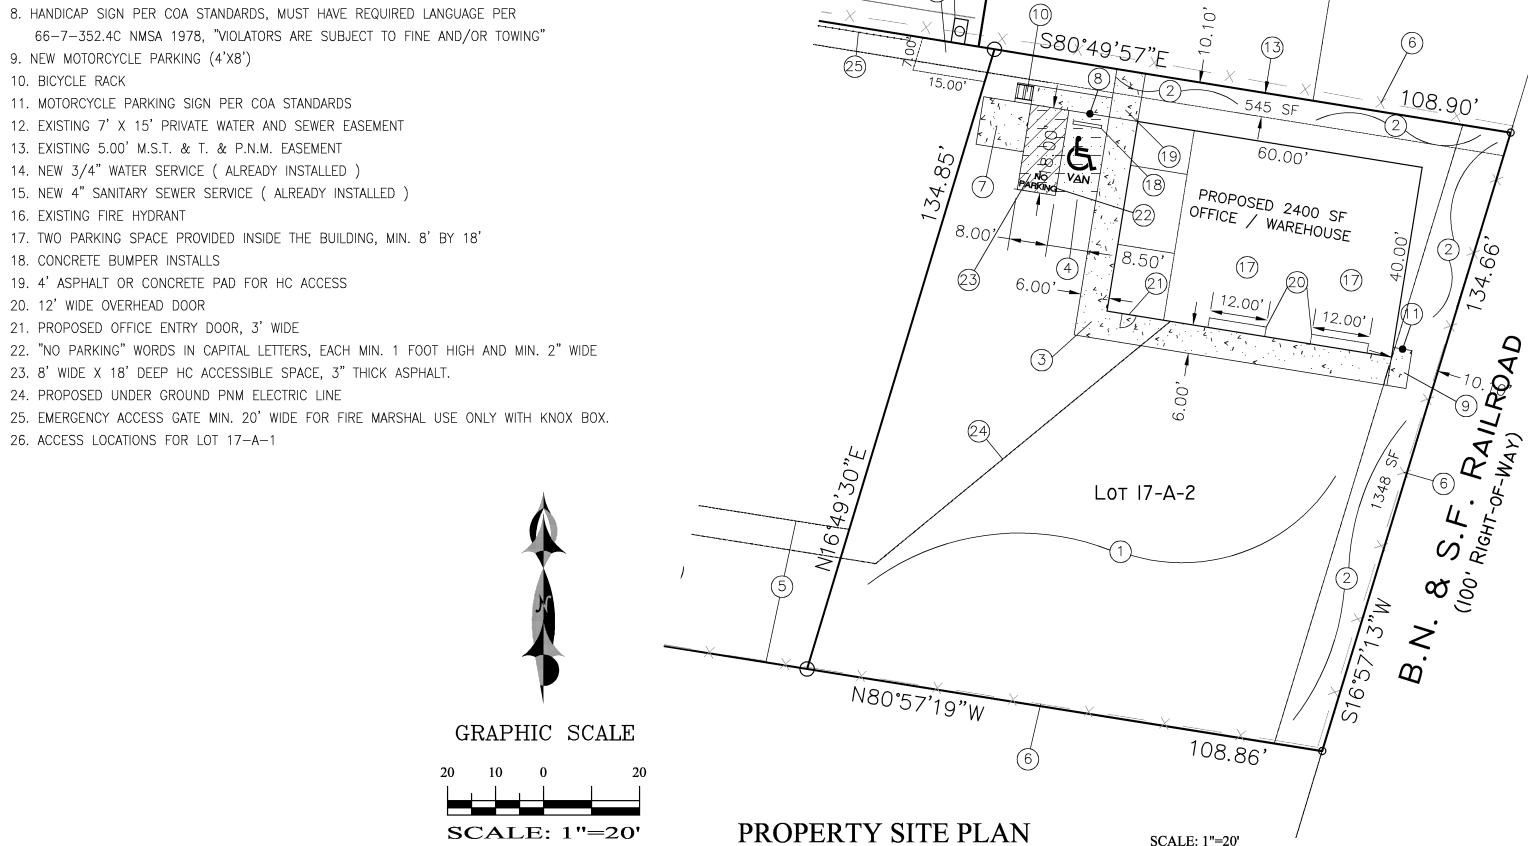

SCALE: 1"=20'

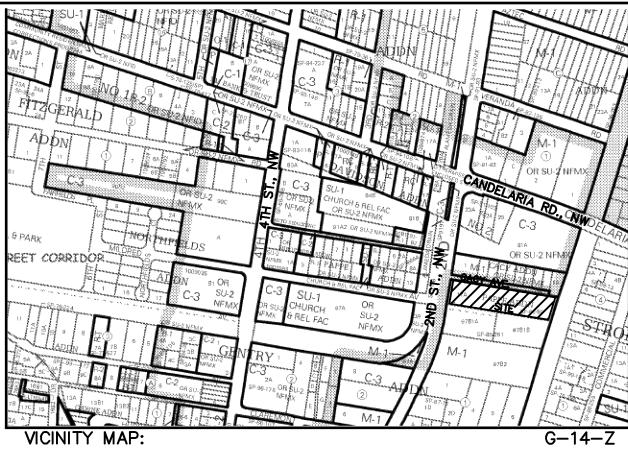

LEGAL DESCRIPTION:

LOT 17-A-2, PAPPE ADDITION CONTAINING 14,521.42 S.F. (0.3334 ACRE) ZONING: M-1

SITE DATA

OFFICE/WAREHOUSE PROPOSED USAGE: LOT AREA: 14,521.42 S.F. (0.3334 ACRE) OFFICE AREA: 400.00 S.F. 2,000.00 S.F. WAREHOUSE AREA:

TOTAL 2,400.00 S.F. LANDSCAPE CALCULATIONS:

NET LOT AREA (14,521-2400) 12,121.00 SF ± LANDSCAPING REQUIRED: 1,818.15 SF ± 15% OF 18,200.00 SF LANDSCAPE PROVIDED 1,893.00 SF ±

PARKING CALCULATIONS

HC PARKING PROVIDED:

PARKING REQUIRED:

OFFICE: 400 SF/200 = 2 SPACES = 1 SPACES WAREHOUSE: 2000 SF/2000 TOTAL 3 SPACES TOTAL PARKING REQUIRED: 3 SPACES TOTAL PARKING PROVIDED: (10UTSIDE AND 2 INSIDE) 3 SPACES HC PARKING REQUIRED: 1 SPACES (1 VAN)

1 SPACES MOTORCYCLE SPACES PROVIDED: 1 SPACES

LEGEND

BOUNDARY LINE EASEMENT LINE EXISTING OVERHEAD UTILITY EXISTING CURB & GUTTER EXISTING CHAIN LINK FENCE ---- x ---- x ---- x ---- x ----EXISTING SIDEWALK EXISTING FIRE HYDRANT EXISTING WATER SERVICE EXISTING DROP INLET PROPOSED SIDEWALK PROPOSED 3" THICK ASPHALT AREA



REZA AFAGHPOUR P.E. #11814

SBS CONSTRUCTION AND ENGINEERING, LLC

1 SPACES (1 VAN)

10209 SNOWFLAKE CT., NW ALBUQUERQUE, NEW MEXICO 87114 (505)804-5013

3440 2ND STREET, NW SITE PLAN FOR BUILDING PERMIT				
RAWING:	DRAWN BY:	DATE:	SHEET#	
201424-SP.DWG	SH-B	10-05-2014	C101	

HANDICAP SIGN DETAIL

NTS