CITY OF ALBUQUERQUE



Planning Department Transportation Development Services

October 28, 2014

Shawn Biazar, P.E. SBS Construction and Engineering, LLC 10209 Snowflake Ct., NW Albuquerque, NM 87114

Re: Office Warehouse, 3440 2nd Street NW
Traffic Circulation Layout
Engineer's/Architect's Stamp dated 10-20-14 (G14-D087)

Dear Mr. Biazar:

Based upon the information provided in your submittal received 10-22-14, the above referenced plan cannot be approved for Building Permit until the following comments are addressed:

PO Box 1293

1. Label each existing building on Lot 17-A-1 as "Existing Building to Remain", and label the existing pavement width and/or gravel roadway width on adjacent roadways. Show existing access to Lot 17-A-1.

Albuquerque

2. Label the DRB case number for the Existing 30-foot Private Access and Drainage Easement.

New Mexico 87103

3. Please identify all the proposed doors for the proposed office and warehouse including handicapped access and the proposed garage doors for the proposed parking inside the warehouse. Show all door widths.

4. Please list the width and length for all parking spaces. The handicap accessible spaces must be a minimum of 8.5 feet in width and 18 feet long.

www.cabq.gov

- 5. The ADA van accessible sign must have the required language per 66-7-352.4C NMSA 1978 "Violators Are Subject to a Fine and/or Towing."
- 6. The ADA access aisle shall have the words "NO PARKING" in capital letters, each of which shall be at least one foot high and at least two inches wide, placed at the rear of the parking space so as to be close to where an adjacent vehicle's rear tire would be placed. (66-1-4.1.B NMSA 1978)
- 7. For Lot 17-A-2, extend the proposed 6-foot sidewalk all of the way to the property line along the south side of Casey Avenue.
- 8. Handicapped access is required to be paved. Both the handicapped parking space and the van accessible space must be paved. The remaining driving area may be recycled asphalt or gravel as called out by Keyed Note 1 on the site plan. Maintain the new 6-foot sidewalk as concrete or asphalt as called out

on the site plan as per Keyed Note 3 as long as a different surface is provided for the pedestrian walkway than the driving area. For the asphalt surface, show the thickness of asphalt proposed.

- 9. The bike rack called out by Keyed Note 10 on the site plan is in the way of the handicapped access from the van accessible sisle and needs to be moved to a location where it does not interfere with wheelchair access.
- "Chain link fence" is misspelled on Keyed Note 6.

Resubmit acceptable package along with fully completed Drainage Transportation Information Sheet to front counter personnel for log in and evaluation by Transportation. Include two copies of the traffic circulation layout at the next submittal. If you have any questions, please contact me at (505) 924-3924.

Sincerely,

1100

Jeanior Engineer, Planning Dept. Development Review Services

CO Clerk

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City of Albuquerque

Planning Department

Development & Building Services Division DRAINAGE AND TRANSPORTATION INFORMATION SHEET


(REV 02/2013)

	(REV 02/2013)	1.1000	
Project Title: LOT 17-A-2, PAPPE ADDITION	Building Permit #:_	City Drainage #: 4140087	
DRB#: EPC#:		Work Order#:	
Legal Description: LOT 17-A-2, PAPPE ADDITION			
City Address: 3440 2ND. STREET, NW, ALBUQUERQUE, NM			
		Contact: SHAWN BIAZAR	
Engineering Firm: SBS CONSTRUCTION AND ENGINEER		- Collabil	
Address: 10209 SNOWFLAKE CT., NW, ALBUQUERQUE, NM Phone#: 505-804-5013 Fax#: 5		E-mail: AECLLC@AOL.COM	
Phone#: 505-804-5013 Fax#: 5			
Owner:		Contact:	
Address:		Pth	
Phone#: Fax#:		E-mail:	
Architect:		Contact:	
Address:		E-mails	
Phone#: Fax#:		E-mail:	
Surveyor:		Contact:	
Address:		r	
Phone#: Fax#:		E-mail:	
Contractor:		Contact:	
Address:			
Phone#: Fax#:		E-mail:	
TYPE OF SUBMITTAL:	CHECK TYPE OF APPRO	VAL/ACCEPTANCE SOUGHT:	
DRAINAGE REPORT	SIA/FINANCIAL GUARA		
DRAINAGE PLAN 1st SUBMITTAL	PRELIMINARY PLAT AP	PROVAL	
DRAINAGE PLAN RESUBMITTAL	S. DEV. PLAN FOR SUB'I		
CONCEPTUAL G & D PLAN	S. DEV. FOR BLDG. PERI	ALL VERSON OF THE STATE OF THE	
GRADING PLAN	SECTOR PLAN APPROVAL FINAL PLAT APPROVAL	HINT OOT I'M MINE HILL	
EROSION & SEDIMENT CONTROL PLAN (ES	CERTIFICATE OF OCCU	111111	
ENGINEER'S CERT (HYDROLOGY)		PANNO DEVELOPMENT SECTION	
CLOMR/LOMR	FOUNDATION PERMIT		
TRAFFIC CIRCULATION LAYOUT (TCL)	BUILDING PERMIT APP		
ENGINEER'S CERT (TCL) ENGINEER'S CERT (DRB SITE PLAN)	GRADING PERMIT APPE		
ENGINEER'S CERT (ESC)	PAVING PERMIT APPRO		
	WORK ORDER APPROV		
OTHER (SPECIFY)	GRADING CERTIFICATI		
OTHER (SPECIFI)			
WAS A PRE-DESIGN CONFERENCE ATTENDED:	Yes No	Copy Provided	
DATE SUBMITTED: 10/20/2014	By: SHAWN BIAZAR		


Requests for approvals of Site Development Plans and/or Subdivision Plats shall be accompanied by a drainage submittal. The particular nature, location, and scope to the proposed development defines the degree of drainage detail. One or more of the following levels of submittal may be required based on the followin

1. Conceptual Grading and Drainage Plan: Required for approval of Site Development Plans greater than five (5) acres and Sector Plans

- 2. Drainage Plans: Required for building permits, grading permits, paving permits and site plans less than five (5) acres
- Drainage Report: Required for subdivision containing more than ten (10) lots or constituting five (5) acres or more
- Erosion and Sediment Control Plan: Required for any new development and redevelopment site with 1-acre or more of land disturbing area, including project less than 1-acre than are part of a larger common plan of development

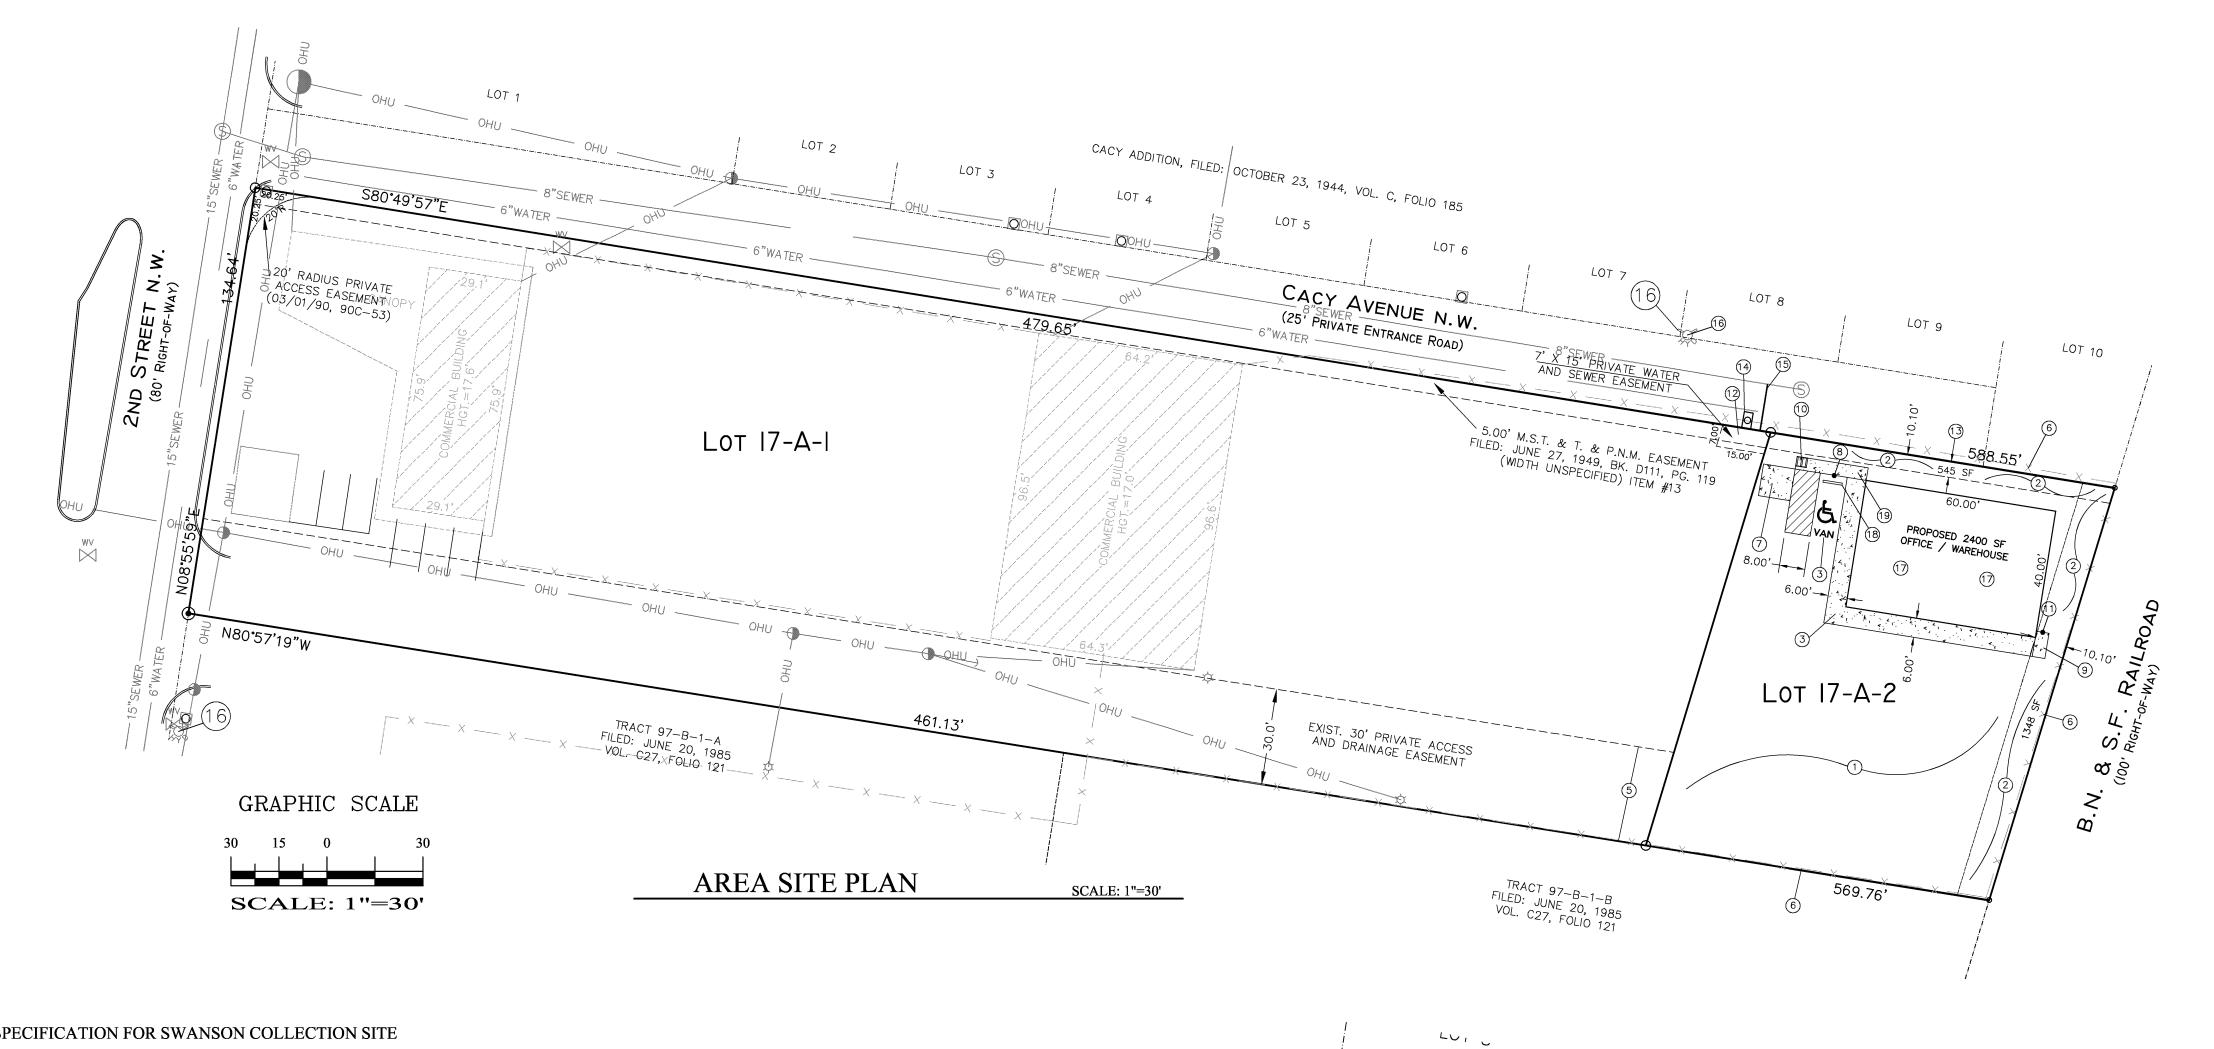


SPECIFICATION FOR SWANSON COLLECTION SITE

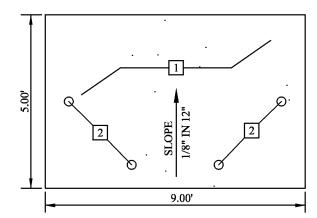


KEYED NOTES: □

- 1. CONCRETE SLAB, 4" THICK 3000 PSI (28 DAYS) WITH 3/4" AGGREGATE AND 4X4X1.4 WWF.
- 2. 4" O.D. STEEL PIPE FILLED WITH CONCRETE AND ENCASED IN 6" THICK CONCRETE MINIMUM ALL AROUND BELOW GRADE. CONCRETTE TO BE MINIMUM 30" BELOW GRADE AND POSTS TO BE ABOVE SLAB.

REFUSE BIN SLAB

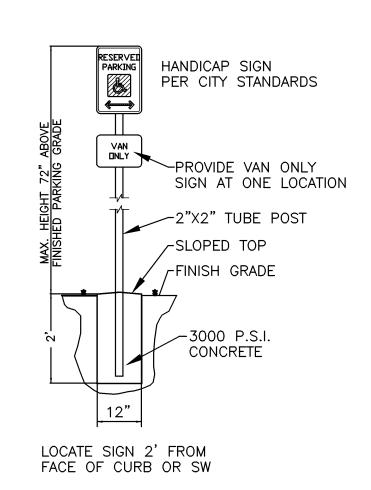


HANDICAP SIGN DETAIL NTS

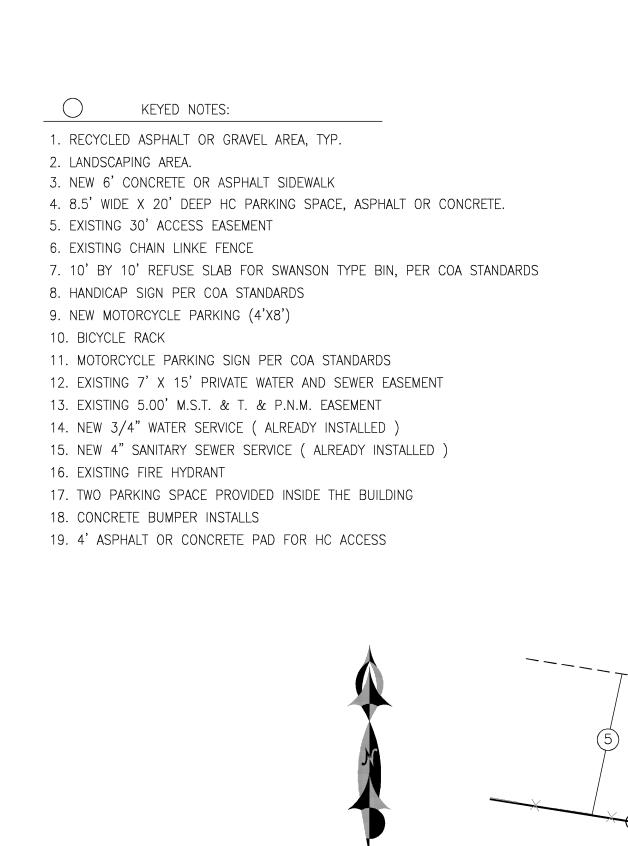


GRAPHIC SCALE

SCALE: 1"=20'

PROPERTY SITE PLAN

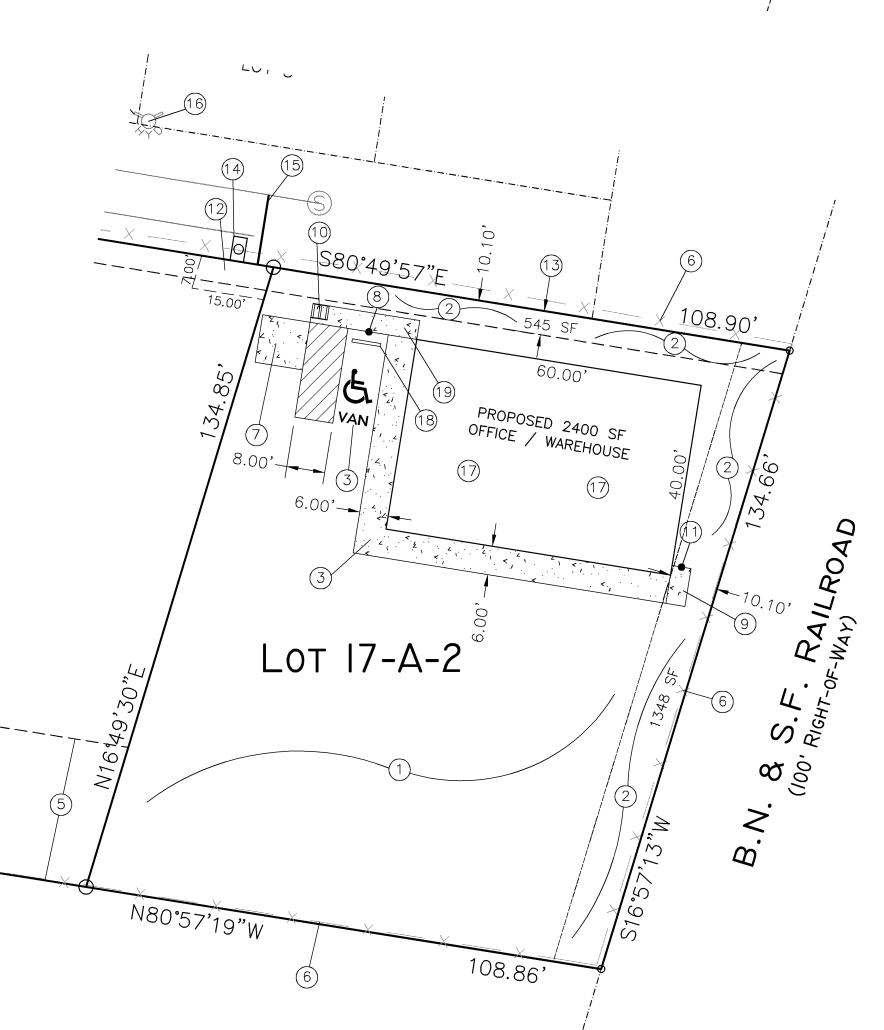

SCALE: 1"=20'

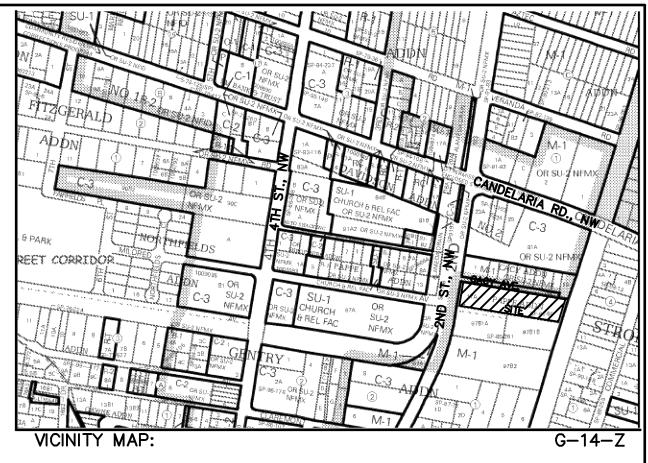

LEGAL DESCRIPTION:

LOT 17-A-2, PAPPE ADDITION CONTAINING 14,521.42 S.F. (0.3334 ACRE) ZONING: M-1

SITE DATA

PROPOSED USAGE: OFFICE/WAREHOUSE LOT AREA: 14,521.42 S.F. (0.3334 ACRE) OFFICE AREA: 400.00 S.F. 2,000.00 S.F. WAREHOUSE AREA: TOTAL 2,400.00 S.F.

LANDSCAPE CALCULATIONS:

NET LOT AREA (14,521-2400) 12,121.00 SF ± LANDSCAPING REQUIRED: 1,818.15 SF ± 15% OF 18,200.00 SF LANDSCAPE PROVIDED 1,893.00 SF ±

PARKING CALCULATIONS:

PARKING REQUIRED:

OFFICE: WAREHOUSE:	400 SF/200 2000 SF/2000	=	2 SPACES 1 SPACES	
	TOTAL		3 SPACES	
TOTAL PARKING REQUIRED:			3 SPACES	
TOTAL PARKING PROVIDED:	(10UTSIDE AND 2 INSIDE)		3 SPACES	
HC PARKING REQUIRED:			1 SPACES (1 VAN)
HC PARKING PROVIDED:			1 SPACES (1 VAN)

1 SPACES MOTORCYCLE SPACES PROVIDED:

LEGEND

	BOUNDARY LINE	
	EASEMENT LINE	
аниани	EXISTING OVERHEAD UTILITY	
	EXISTING CURB & GUTTER	
— x — x — x — x — x —	EXISTING CHAIN LINK FENCE	
	EXISTING SIDEWALK	
X	EXISTING FIRE HYDRANT	
<u>[0]</u>	EXISTING WATER SERVICE	
NEXT (III) 2000 1000	EXISTING DROP INLET	
	PROPOSED SIDEWALK	



REZA AFAGHPOUR P.E. #11814

SBS CONSTRUCTION AND ENGINEERING, LLC

10209 SNOWFLAKE CT., NW ALBUQUERQUE, NEW MEXICO 87114 (505)804-5013

3440 2ND STREET, NW SITE PLAN FOR BUILDING PERMIT						
DRAWING:	DRAWN BY:	DATE:	SHEET#			
201424-SP.DWG	SH-B	05-29-2013	C101			