CITY OF ALBUQUERQUE



March 9, 2018

Shawn Biazar SBS Construction & Engineering, LLC. 10209 Snowflake Ct. NW Albuquerque, NM 87114

RE: 417 Headingly Ave, N.E Grading Plan Engineer's Stamp Date 3/6/18 Hydrology File: G14D090

Dear Mr. Biazar:

Based on the information provided in your submittal received 3/7/18, the Grading Plan cannot be approved until the following are addressed:

PO Box 1293

Albuquerque

NM 87103

Prior to Grading Permit:

- 1. The site must demonstrate adequate downstream capacity per § 14-5-2-12(G) of the Albuquerque Code of Ordinances prior to authorizing any increase in runoff.
 - 2. If downstream capacity cannot be demonstrated, onsite ponding of the increased runoff will be required.
 - 3. It is recommended that the finished floor elevations be elevated at least 1 foot above the overflow to the street.

www.cabq.gov

Prior to Building Permit:

- 4. A Private Facility Drainage Covenant is required for the stormwater ponds. The original notarized form, exhibit A (legible on 8.5x11 paper), and recording fee (\$25, payable to City of Albuquerque) must be turned into DRC (4th, Plaza del Sol) for routing. Please contact Charlotte LaBadie (clabadie@cabq.gov, 924-3996) or Madeline Carruthers (mtafoya@cabq.gov, 924-3997) regarding the routing and recording process for covenants.
- 5. The site will need to be graded and Pad Certifications will be required prior to Hydrology approving the residential Building Permits.

CITY OF ALBUQUERQUE



Prior to Certificate of Occupancy:

- 6. Engineer's Certification, per the DPM Checklist, will be required to ensure the ponds remained intact following home construction.
- 7. The Private Facility Drainage Covenant must be recorded with Bernalillo County and a copy included with the drainage certification.

If you have any questions, please contact me at 924-3695 or dpeterson@cabq.gov.

Sincerely,

Dana Peterson, P.E. Senior Engineer, Planning Dept. Development Review Services

PO Box 1293

Albuquerque

NM 87103

www.cabq.gov



City of Albuquerque

Planning Department Development & Building Services Division DRAINAGE AND TRANSPORTATION INFORMATION SHEET (REV 10/2015)


Project Title: <u>L417 HEADINGLY AVE., NE</u>	GRADING PLAN Building Permit #:	Hydrology File #:		
DRB#:	EPC#:	Work Order#:		
Legal Description: LOT 2-A, BLOCK 10,	MONKBRIDGE ADDITION			
City Address: 417 HEADINGLY AVE., N	IE			
Applicant: SBS CONSTRUCTION AND ENG	Contact: SHAWN BIAZAR			
Address: 10209 SNOWFLAKE CT., NW, A	ALBUQUERQUE, NM 87114			
Phone#: (505)804-5013	Fax <u>#: (505)897-4996</u>	E-mail: <u>AECLLC@AOL.COM</u>		
Other Contact:		Contact:		
Address:				
Phone#:		E-mail:		
Check all that Apply:				
DEPARTMENT:	TYPE OF APPRO	VAL/ACCEPTANCE SOUGHT:		
X HYDROLOGY/DRAINAGE	X BUILDING PE			
TRAFFIC/ TRANSPORTATION MS4/ EROSION & SEDIMENT CONTRO				
<u> </u>				
TYPE OF SUBMITTAL:	PRELIMINAR	Y PLAT APPROVAL		
ENGINEER/ARCHITECT CERTIFICATIO		SITE PLAN FOR SUB'D APPROVAL		
	SITE PLAN F	OR BLDG. PERMIT APPROVAL		
CONCEPTUAL G & D PLAN	FINAL PLAT	APPROVAL		
X GRADING PLAN				
	DRAINAGE MASTER PLANSIA/ RELEAS			
DRAINAGE REPORT	· · · · · · · · · · · · · · · · · · ·	ON PERMIT APPROVAL		
CLOMR/LOMR	· · · · · · · · · · · · · · · · · · ·	ERMIT APPROVAL		
TRAFFIC CIRCLILATION LANOUT (TO	SO-19 APPRO			
TRAFFIC IMPACT STUDY (TIS)	TRAFFIC CIRCULATION LAYOUT (TCL)PAVING PER			
	_TRAFFIC IMPACT STUDY (TIS) GRADING/ F _EROSION & SEDIMENT CONTROL PLAN (ESC) WORK ORDE			
	CLOMR/LOM			
OTHER (SPECIFY)		ĸ		
	PRE-DESIGN	MEETING?		
IS THIS A RESUBMITTAL?: Yes X	NoOTHER (SPE	CIFY)		
DATE SUBMITTED: <u>3-7-2018</u>	By: <u>SHAWN BIAZAR</u>			


COA STAFF: ELECTRONIC SUBMITTAL RECEIVED: ____

Location Lot 2-A, Block 10, Monkbridge Garden Addition, is located at 417 Headingly Ave., NW containing 0.1291 acre. See attached portion of Vicinity Map G-14-Z for exact location	
Purpose The purpose of this drainage report is to present a grading and drainage solution for new buildings and improvement for Lot 2-A, Block 10, Monkbridge Garden Addition.	
Existing Drainage Conditions This lot is very flat and drains south into Headingly Ave., NW and no other offiste flows this site. There is existing block walls to the north and east property lines.	s enters
Proposed Conditions and On-Site Drainage Management Plan There are existing block walls to the north and east. A new block wall is proposed for we property line. Most of the runoff under the developed conditions will drain to the first fl ponds located at the back (north) of property and in the parking area. The site eventually into Headingly Ave., NW. First flush volume requirement for this site is 106.14 cf and t volume provided is 195.14 cf.	lush y drains
<u>GENERAL NOTES:</u>	
1: CONTOUR INTERVAL IS HALF (1.00) FOOT.	
2: ELEVATIONS ARE BASED ON CITY OF ALBUQUERQUE CONTROL S 20_G14, HAVING AN ELEVATION OF <u>4971.007</u> FEET ABOVE SE	
3: UTILITIES SHOWN HEREON ARE IN THEIR APPROXIMATE LOCATION ONLY ON ABOVE GROUND EVIDENCE FOUND IN THE FIELD AND INFORMATION PROVIDED BY THE CLIENT. UTILITIES SHOWN HEREO WHETHER INDICATED AS ABANDONED OR NOT, SHALL BE VERIFIE OTHERS FOR EXACT LOCATION AND/ OR DEPTH PRIOR TO EXCA OR DESIGN CON-SIDERATIONS.	AS—BUILT DN, ED BY
4: THIS IS <u>NOT</u> A BOUNDARY SURVEY, BEARINGS ARE ASSUMED, DISTANCES AND FOUND PROPERTY CORNERS ARE FOR <u>INFORM</u> , <u>PURPOSES ONLY</u> .	
5: SLOPES ARE AT 3:1 MAXIMUM.	Pf
6: ADD 4900 TO ALL PROPOSED SPOT ELEVATIONS.	BL
PONDING VOLUME REQUIREMENTS (90TH PERCENTILE/FIR	<u>ST_FLUSH)</u> IN
VOLUME REQUIRED = 0.34 INCHES x IMPERVIOUS AREA = $(0.34/12 \times 3,746.00) = 160.14$ CF	
PONDING VOLUME CALCULATION	
TOTAL POND AREA PROVIDED = PONDING CALCULATIONS:	
POND A: AREA @ ELEV. 70.45 = 100.11 SF AREA @ ELEV. 69.45 = 36.04 SF POND VOLUME=(100.11+36.56)/2*2=68.08 CF	POND D: BOTTOM AREA=35.59 TOP AREA=77.37 SF DEPTH=0.50'
POND B: AREA @ ELEV. 70.45 = 100.11 SF AREA @ ELEV. 69.45 = 36.04 SF POND VOLUME=(100.11+36.56)/2*2=68.08 CF	POND VOLUME=28.24
POND C: AREA @ ELEV. 70.15 = 84.30 SF AREA @ ELEV. 69.655 = 38.77 SF POND VOLUME=(70.15+38.77)/2*2=30.77 CF	
POND D: AREA @ ELEV. 70.10 = 77.37 SF AREA @ ELEV. 69.60 = 35.59 SF	

POND VOLUME=(77.37+35.59)/2*2=28.24 CF

TOTAL PONDING VOLUME PROVIDED = 68.08 + 68.08 + 30.77 + 28.24 = 195.16 CF

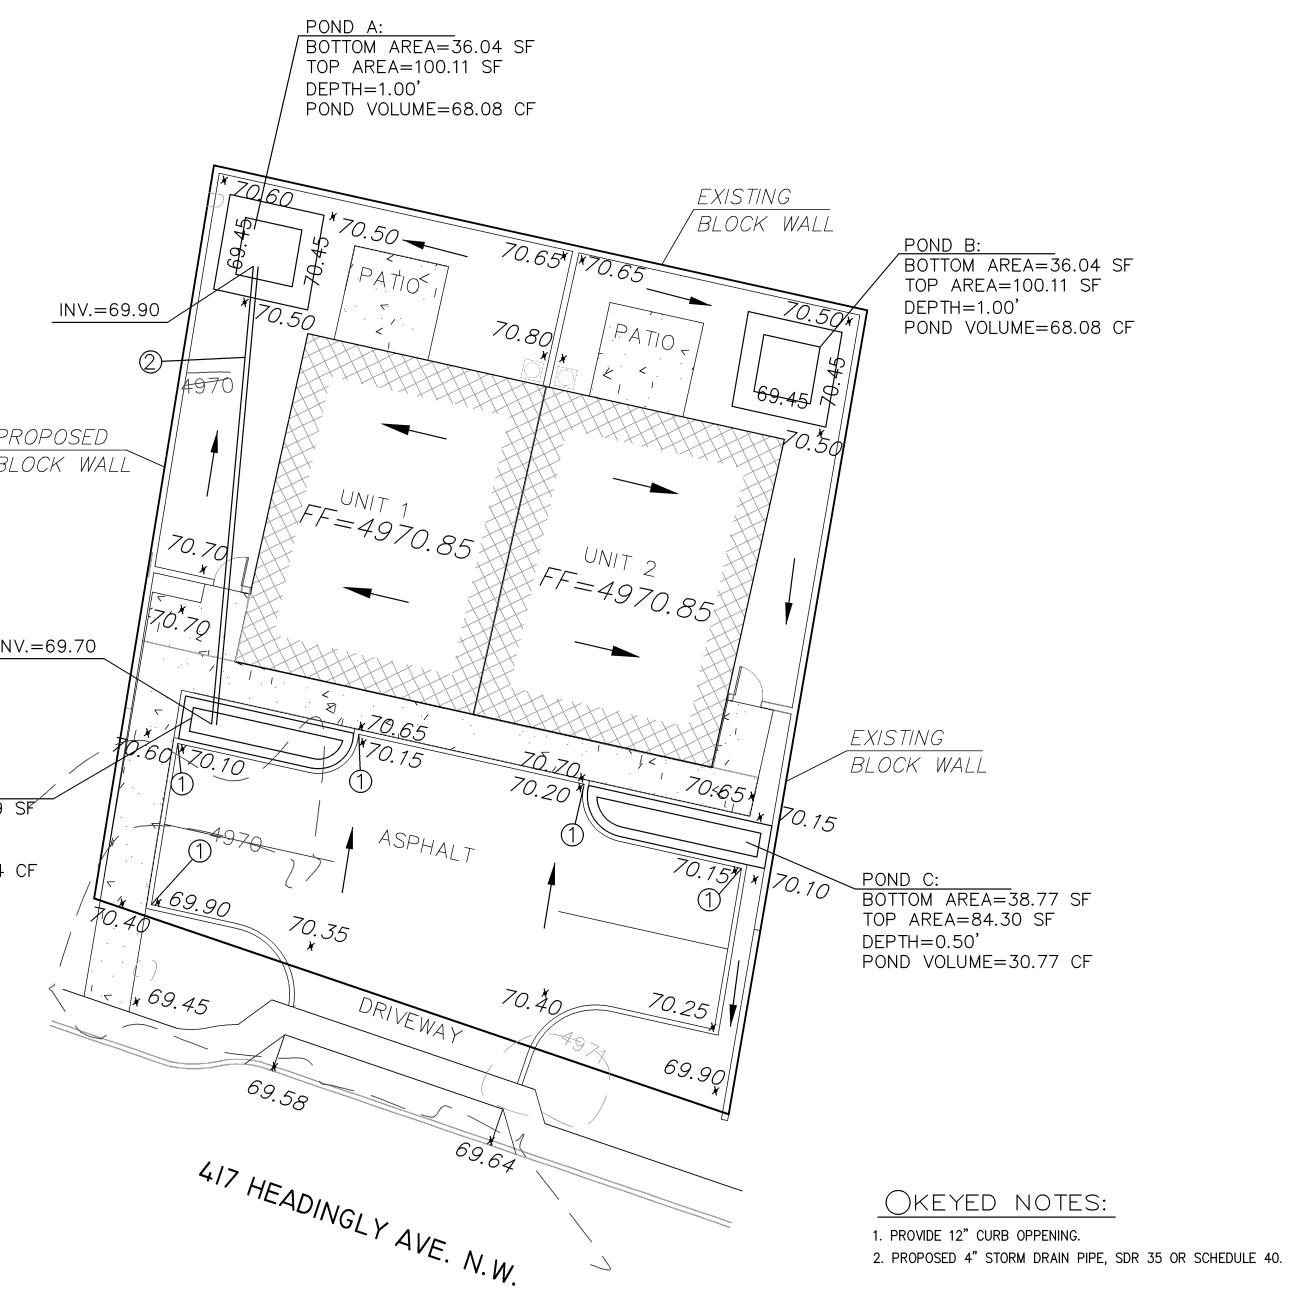

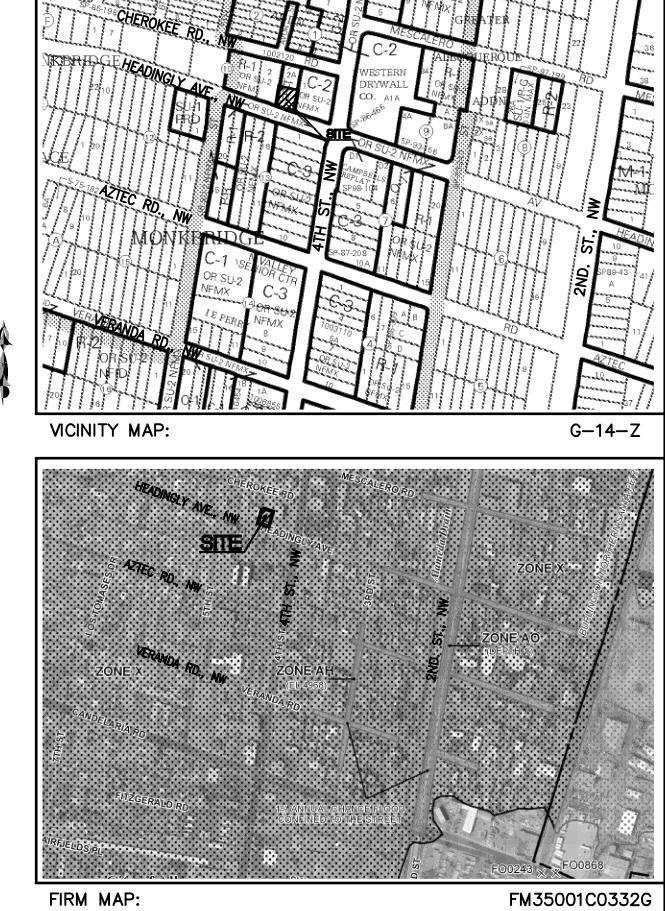

LEGAL DESCRIPTION: LOT 2-B, BLOCK 10, MONKBRIDGE ADDITION ADDRESS: 417 HEADINGLY AVE., NW

LEGEND	

		LEGEND				
			- EXISTING CON	- EXISTING CONTOUR (MAJOR) EXISTING CONTOUR (MINOR) - BOUNDARY LINE		
		¥ <i>42.70</i> ╳ 5029.16		POT ELEVATION		
		× 5075.65 FL	EXISTING FLO	WLINE ELEVATION		
			PROPOSED RE	PROPOSED RETAINING WALL		
		BC=41.30	BOTTOM OF C	CHANEL		
		TF=42.00	TOP OF FOOT	ING		
		TRW=45.12	TOP OF RETA	TOP OF RETAINING WALL		
DULE 40.		HP	HIGH POINT			
		42.40 -<i>42.45</i>	AS-BUILT GR	AS-BUILT GRADES		
		X 5141.50 - <i>FF=5142.30</i> FP=5142.25		OT ELEVATIONS		
Image: Constrained and the second a		SBS CONSTRUCTION AND ENGINEERING, LLC In 10209 SNOWFLAKE CT., NW ALBUQUERQUE, NEW MEXICO 87114 (505)899-5570				
GRAPHIC SCALE	417 HEADINGLY AVE., NW GRADING PLAN					
SCALE: 1"=10'	DRAWING: 201803-GD.DWG	DRAWN BY: SH-B	DATE: 3-6-2018	sheet # 1		
LAST REVISION: 2-2-2018						