**EXISTING 6" WATER LINE** FIRE ACCESS FROM AZTEC RD NW KNOX BOX MOUNTED BETWEEN 4' AND 6' A.F.F PREMISE ID. BUILDING ADDRESS NUMBER SIGNAGE '3821' **Existing Building** 2493 SF **Existing Parking** KNOX BOX MOUNTED AT BUILDING ENTRY BETWEEN 4' AND 6' A.F.F 1/4" / ft DISTANCE FROM FIRE ACCESS TO **FURTHEST POINT OF BUILDING** New Addition 2327 SF KNOX BOX MOUNTED BETWEEN 4' AND 6' A.F.F 8' DITCH EASEMENT 91' - 9"

#20-004680 HYDRANT AND FIRE ACCESS
ALBUQUERQUE FIRE MARSHAL'S OFFICE
PLANS CHECKING DIVISION
SOFT 432 CONSTRUCTION TYPE 15:3
GPM 1500 NUMBER OF HYDRANTS 1
APPROVED ADISAPPROVED
SIGNATURE / MAN NUMBER / DATE ARCHITECT

SAM STERLING ARCHITECTURE, Ilc 924 2nd St NW Suite C, Albuquerque, NM 87102 505.232.2520 samsterlingarchitecture.com

CONSULTANT

KEY PLAN

Shop Cabinet Insight

REV:

PHASE: 90% Construction

DATE: 11.20.2020 DRAWN BY: CHECKED BY: WL

FIRE 1

**ZONING ANALYSIS** 

October 19, 2020 Insight Cabinet Shop 3821 12th Street NW Albuquerque, New Mexico 87107

BUILDING + ZONING Zoning per IDO - MIXED-USE LOW INTENSITY ZONE DISTRICT (MX-L)

Allowable use IDO Table 4-2-1 Land Uses Industrial-Artisan Manufacturing

REQUIRED HYDRANTS

(Table B105.1(2) IFC 2015)

Total Square footage: Type of Construction:

4,820 SF (Existing + Addition) II-B, Fully Sprinklered

Minimum 1,500 GPM


(Table B105.2 IFC 2015) Required Fire Flow:

(Table C102.1 IFC 2015) Required Number of Hydrants: Existing Number of Hydrants:

1 Fire Protection Plan
1" = 10'-0"

**LEGEND** 

= New Fire Hydrant

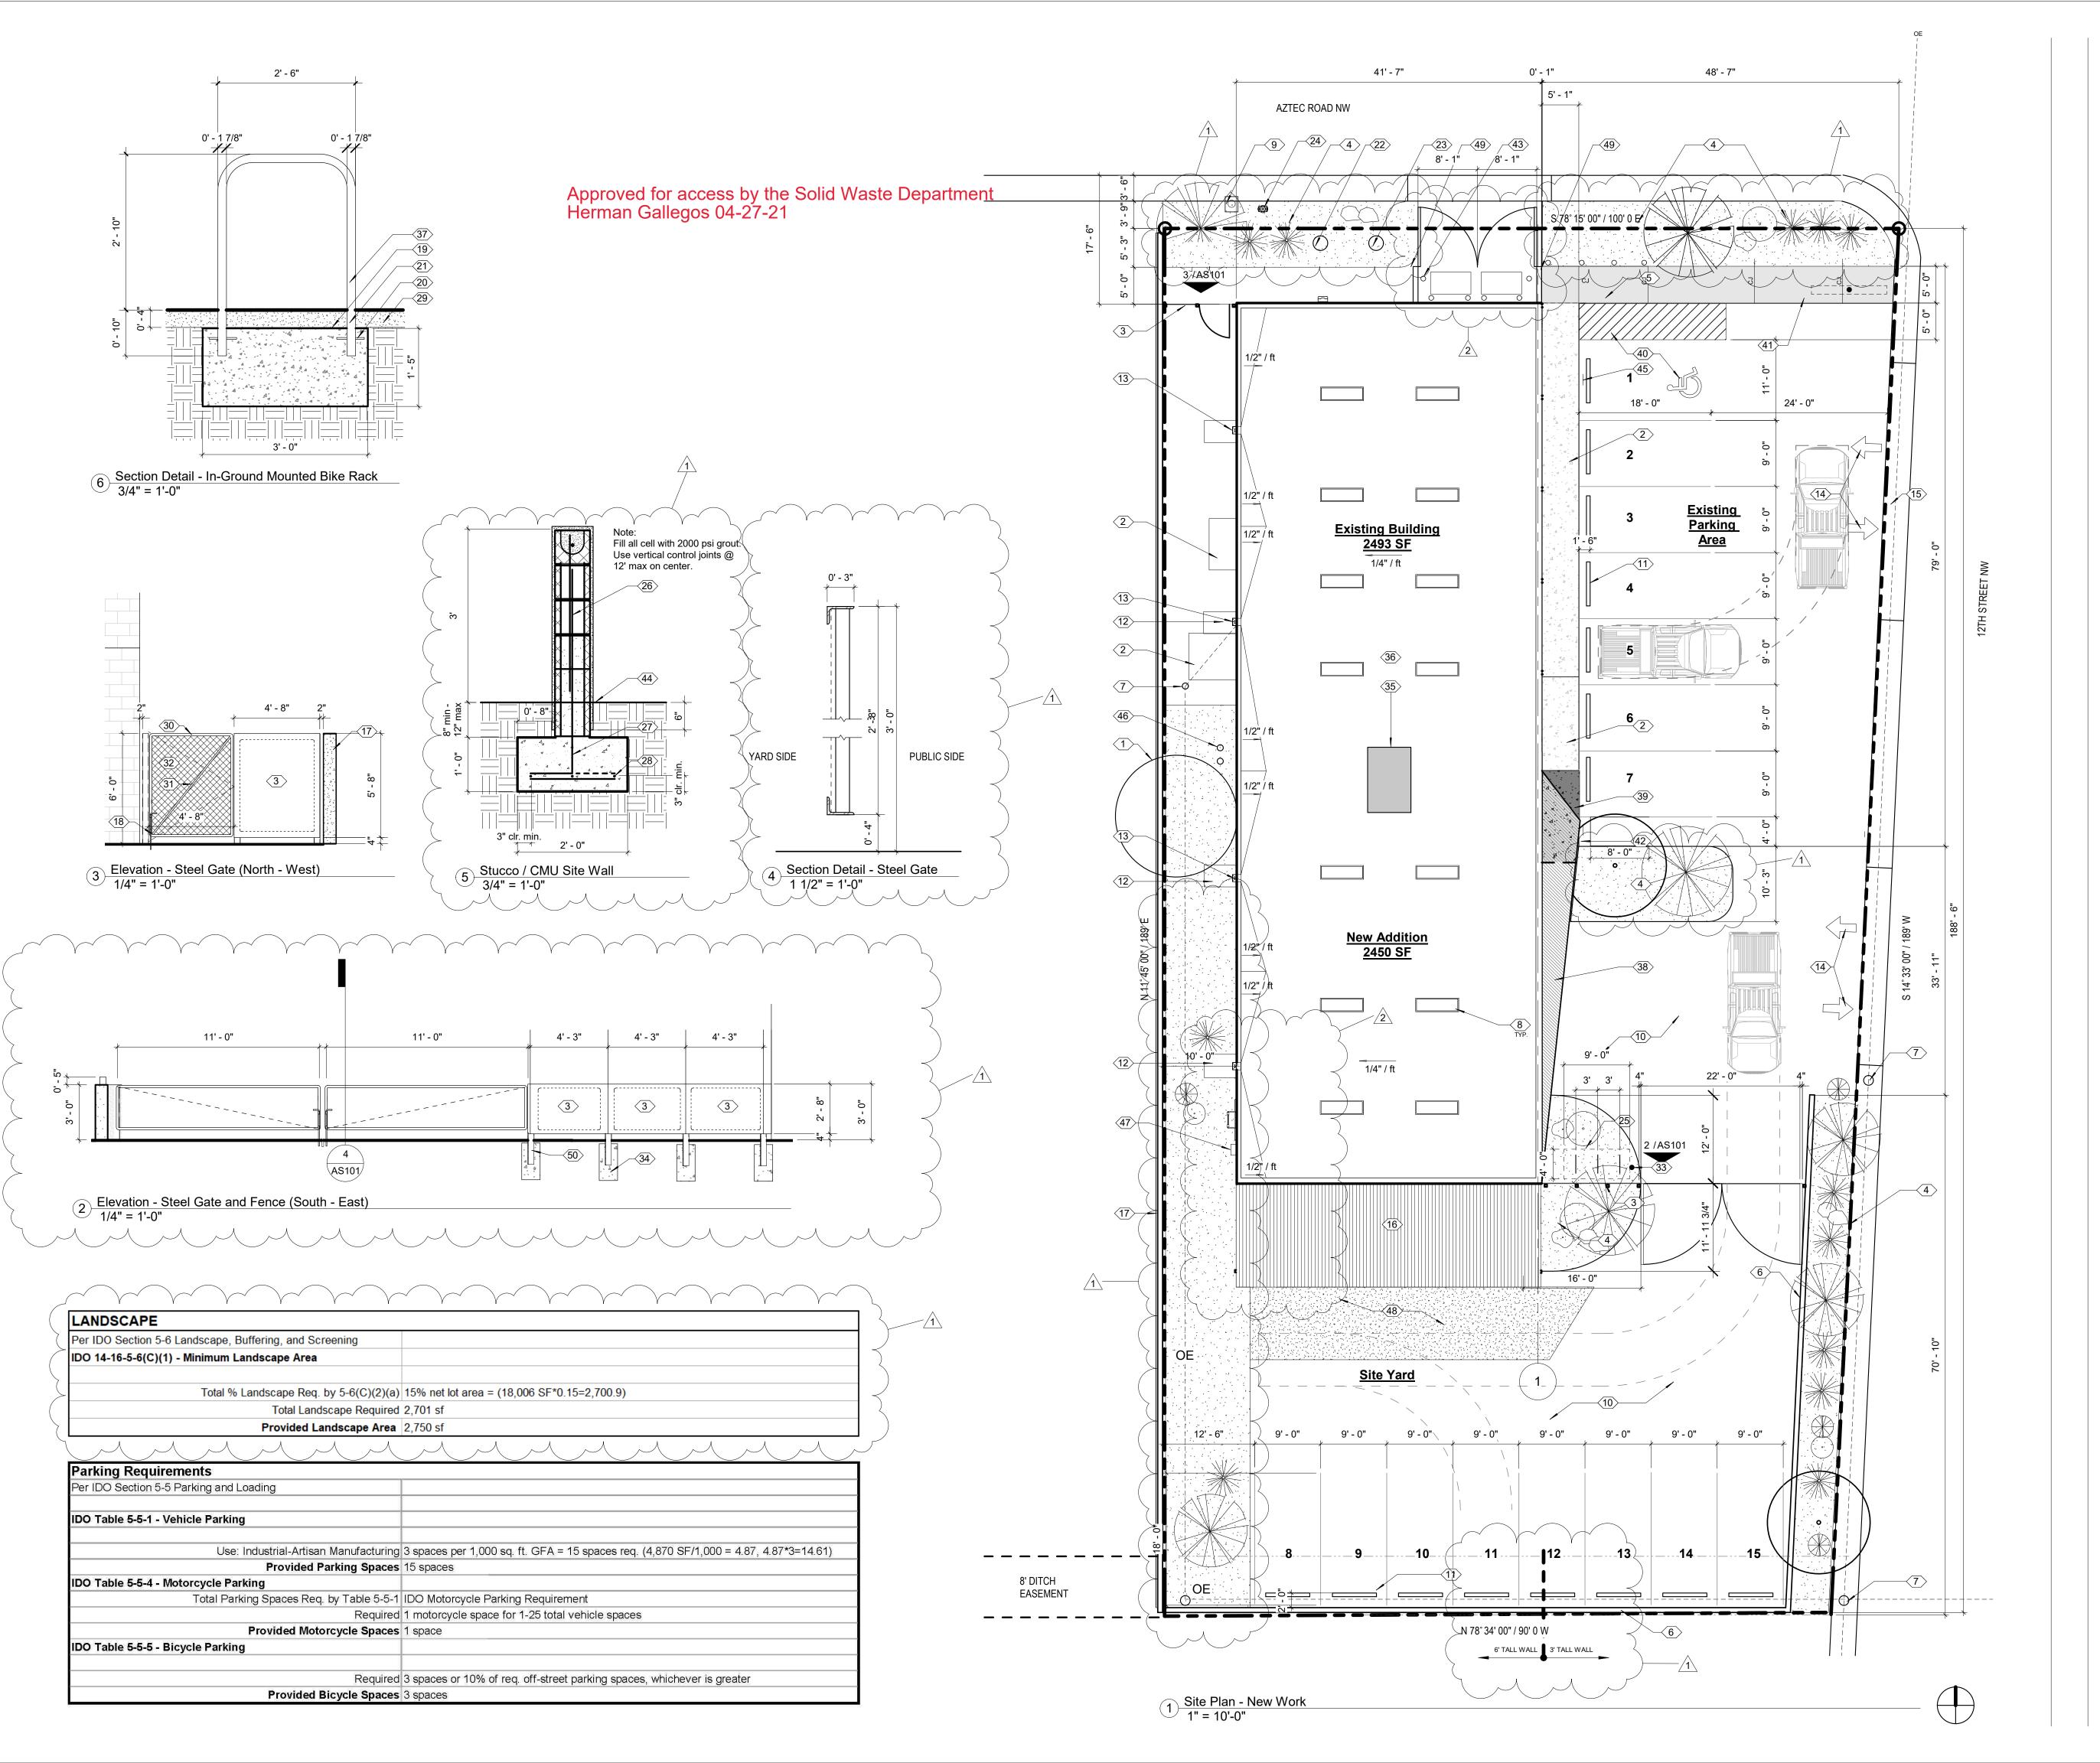

## **GENERAL NOTES**

- A. All dimensions shown are to grid lines or face of structure / curb. Unless noted otherwise
- B. All concrete control joints to be saw-cut U.N.O.
- C. Exterior expansion joints as indicated from homasote

ARCHITECT

CONSULTANT

KEY PLAN

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SAMUEL M.


No. 3077

D. All planting to be irrigated. Coordinate location of irrigation controller with Owner / Architect. Provide

## **KEYNOTE LEGEND**

- 1 Existing tree to remain
- 2 Existing concrete pad to remain 3 New steel fence from 4" x 4" black iron steel tubes and 1/8" steel plate left to rust. No paint. No primer. Cap all exposed ends. See details on this sheet.
- 4 New landscape planter area cut out of existing asphalt. Fill planter area with 3" crusher fines
- (color: Santa Fe Brown)
- 5 New light exposed aggregate concrete sidewalk
- 6 New 6' high 8"x8"x16" stuccoed CMU wall color by Owne/Architect.
- 7 Existing utility pole
- 8 2' x 6' Velux model 2270 fixed skylight, curb mounted. See Skylight Schedule on sheet
- 9 Existing water meter
- 10 Existing asphalt paving 11 Pre-cast concrete parking bumper - typ.
- 12 3' x 5' roof drain spillout- provide cobble and pre-cast splash pad.
- 13 5"x5" downspout painted to match color of painted CMU. Provide 3x5' spillout from 3-5"
- 14 New painted traffic arrows
- 15 Existing driveway entrance and curb cut
- 16 New pavement 17 Existing CMU wall to remain
- 18 5/8" dia. locking cane bolt welded to gate frame
- 19 New concrete 20 Provide 3/8" anchor stud through leg per
- manufacturer's specifications
- 21 Embed in concrete
- 22 FDC see Civil
- 23 PIV see Civil 24 New fire hydrant - see Fire Plan and Civil
- 25 Bike racks (3) racks. See detail on this sheet. 26 30" min. rebar lap
- 27 #4 dowels @ 48" o.c. (alt. bend)
- 28 (3) #4's cont. and #4 transv. @ 48" o.c.
- 29 New crusher fines (Santa Fe Brown)
- 30 2x3x.025 (LLH) steel angle gate frame. Left to
- 31 2"x1/4" steel bar stock diagonal welded to gate
- frame. Tight to mesh 32 1/2"x18 GA. flattened expanded black iron
- metal mesh. Left to rust. Weld to steel angle
- 33 New pole mounted light fixture see Mechanical
- 34 12" o.d. x 2'0" deep concrete footing. Top of pier footing to be 6" below existing grade
- 35 R.T. Mechanical unit. See mechanical drawings 36 80 mil white TPO roof
- 37 1 7/8" galvanized steel tubing
- 38 Warped wall clad in 24 GA. RCM-75 recla metal - see Enlarged Plan A101.1
- 39 New sidewalk see Floor Plan
- 40 New asphalt striping
- 41 Existing sign to remain. Provide new electrical circuit - see Electrical
- 42 Motorcycle Parking sign mounted on 2" diam. black iron steel pipe - see civil
- 43 Painted steel bollards. Filled with concrete see
- 44 Approx. existing grade
- 45 Van ADA parking sign from 2" diam. black iron
- 46 Existing double clean out see Plumbing/Civil 47 Electrical service location - see Electrical
- 48 New pavement see civil
- 49 6 tall wall A:F.A. from CMU dumpster encloure 50 Above grade 4x4x1/4" TS column

## LANDSCAPE LEGEND

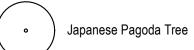





Bird of Paradise



Apache Plume

Large Sandstone Boulder

abinet Insight

Shop

REV: Description Permit Revision Permit Revision 2 4/21/21

PHASE: 100 % Construction

DATE: 2.26.21 DRAWN BY: RA, ST CHECKED BY: AZ, SS

Site Plan & Site Details