
CITY OF ALBUQUERQUE

Planning Department Alan Varela, Director

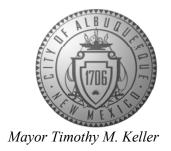

May 10, 2022

Åsa Nilsson-Weber, P.E. Isaacson & Arfman, P.A. 128 Monroe St. N.E Albuquerque, NM 87108

RE: Calle Cuarta Residential 420 Fitzgerald Road NW Grading and Drainage Plans Engineer's Stamp Date: 04/28/22 Hydrology File: G14D097

Dear Ms. Nilsson-Weber:

PO Box 1293 E

Based upon the information provided in your submittal received 04/29/2022, the Grading & Drainage Plans are approved for Grading Permit, Work Order and for action by the DRB on Platting. Please place this stamp approved Grading & Drainage Plans to the Work Order set of construction drawings.

Albuquerque

As a reminder, if the project total area of disturbance (including the staging area and any work within the adjacent Right-of-Way) is 1 acre or more, then an Erosion and Sediment Control (ESC) Plan and Owner's certified Notice of Intent (NOI) is required to be submitted to the Stormwater Quality Engineer (Doug Hughes, PE, jhughes@cabq.gov, 924-3420) 14 days prior to any earth disturbance.

www.cabq.gov

NM 87103

If you have any questions, please contact me at 924-3995 or rbrissette@cabq.gov.

Sincerely,

Renée C. Brissette, P.E. CFM Senior Engineer, Hydrology

Renée C. Brissette

Planning Department




City of Albuquerque


Planning Department Development & Building Services Division


DRAINAGE AND TRANSPORTATION INFORMATION SHEET (REV 11/2018)


Project Title:	Building Permit #:	: Hydrology File #:
DRB#:	EPC#:	Work Order#:
Legal Description:		
City Address:		
		Åsa Nilsson-Weber
Applicant:		Contact:
Address:		
Phone#:	Fax#:	asaw@iacivil.com E-mail:
Owner:		Contact:
Address:		
		E-mail:
TYPE OF SUBMITTAL:PLA		ENCE DRB SITE ADMIN SITE
DEPARTMENT: TRAFFIC/	TRANSPORTATION HY	DROLOGY/ DRAINAGE
Check all that Apply:		21.020 01/ 21.1.1.1.1.02
TYPE OF SUBMITTAL: ENGINEER/ARCHITECT CERPAD CERTIFICATIONCONCEPTUAL G & D PLANGRADING PLANDRAINAGE MASTER PLANDRAINAGE REPORTFLOODPLAIN DEVELOPMENELEVATION CERTIFICATECLOMR/LOMRTRAFFIC CIRCULATION LAYTRAFFIC IMPACT STUDY (TOTHER (SPECIFY)PRE-DESIGN MEETING?	TIFICATION TO PERMIT APPLIC YOUT (TCL) TIS) TO PERMIT APPLIC	EYPE OF APPROVAL/ACCEPTANCE SOUGHT: BUILDING PERMIT APPROVAL CERTIFICATE OF OCCUPANCY PRELIMINARY PLAT APPROVAL SITE PLAN FOR SUB'D APPROVAL SITE PLAN FOR BLDG. PERMIT APPROVAL FINAL PLAT APPROVAL SIA/ RELEASE OF FINANCIAL GUARANTEE FOUNDATION PERMIT APPROVAL GRADING PERMIT APPROVAL SO-19 APPROVAL PAVING PERMIT APPROVAL GRADING/ PAD CERTIFICATION WORK ORDER APPROVAL CLOMR/LOMR FLOODPLAIN DEVELOPMENT PERMIT OTHER (SPECIFY)
	By:	
COA STAFF:	ELECTRONIC SUBMI	ITTAL RECEIVED:

FEE PAID:___

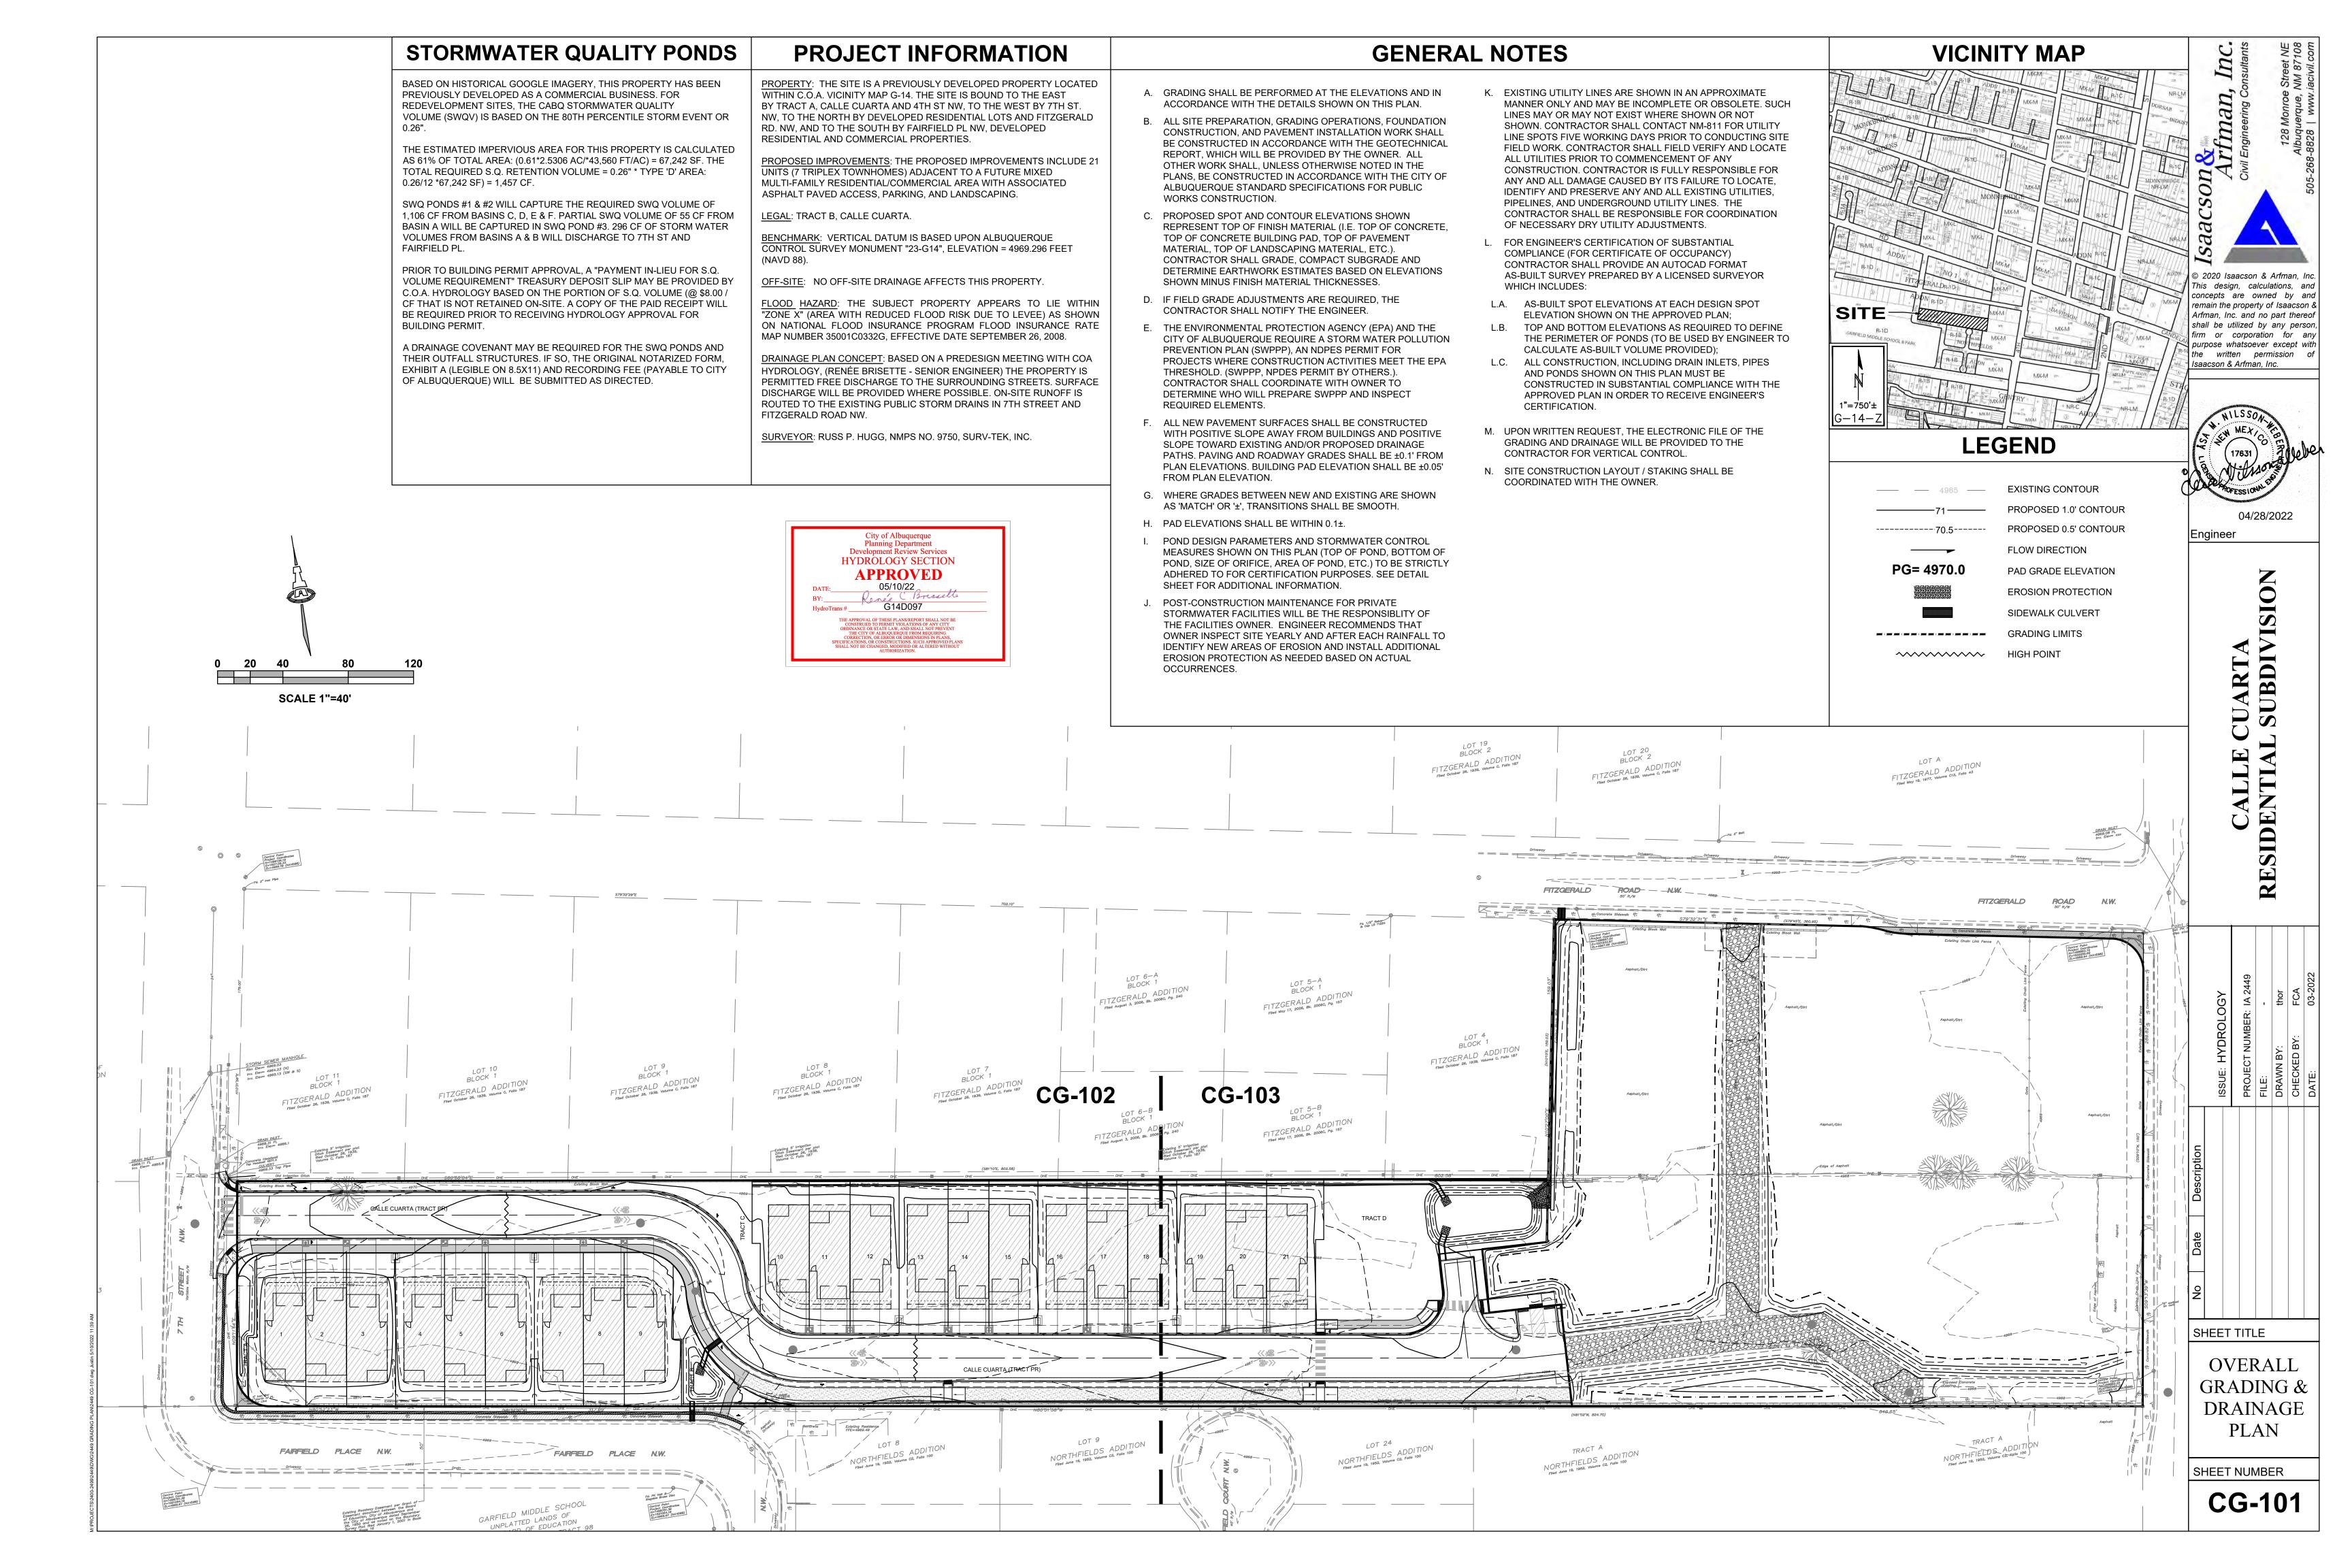

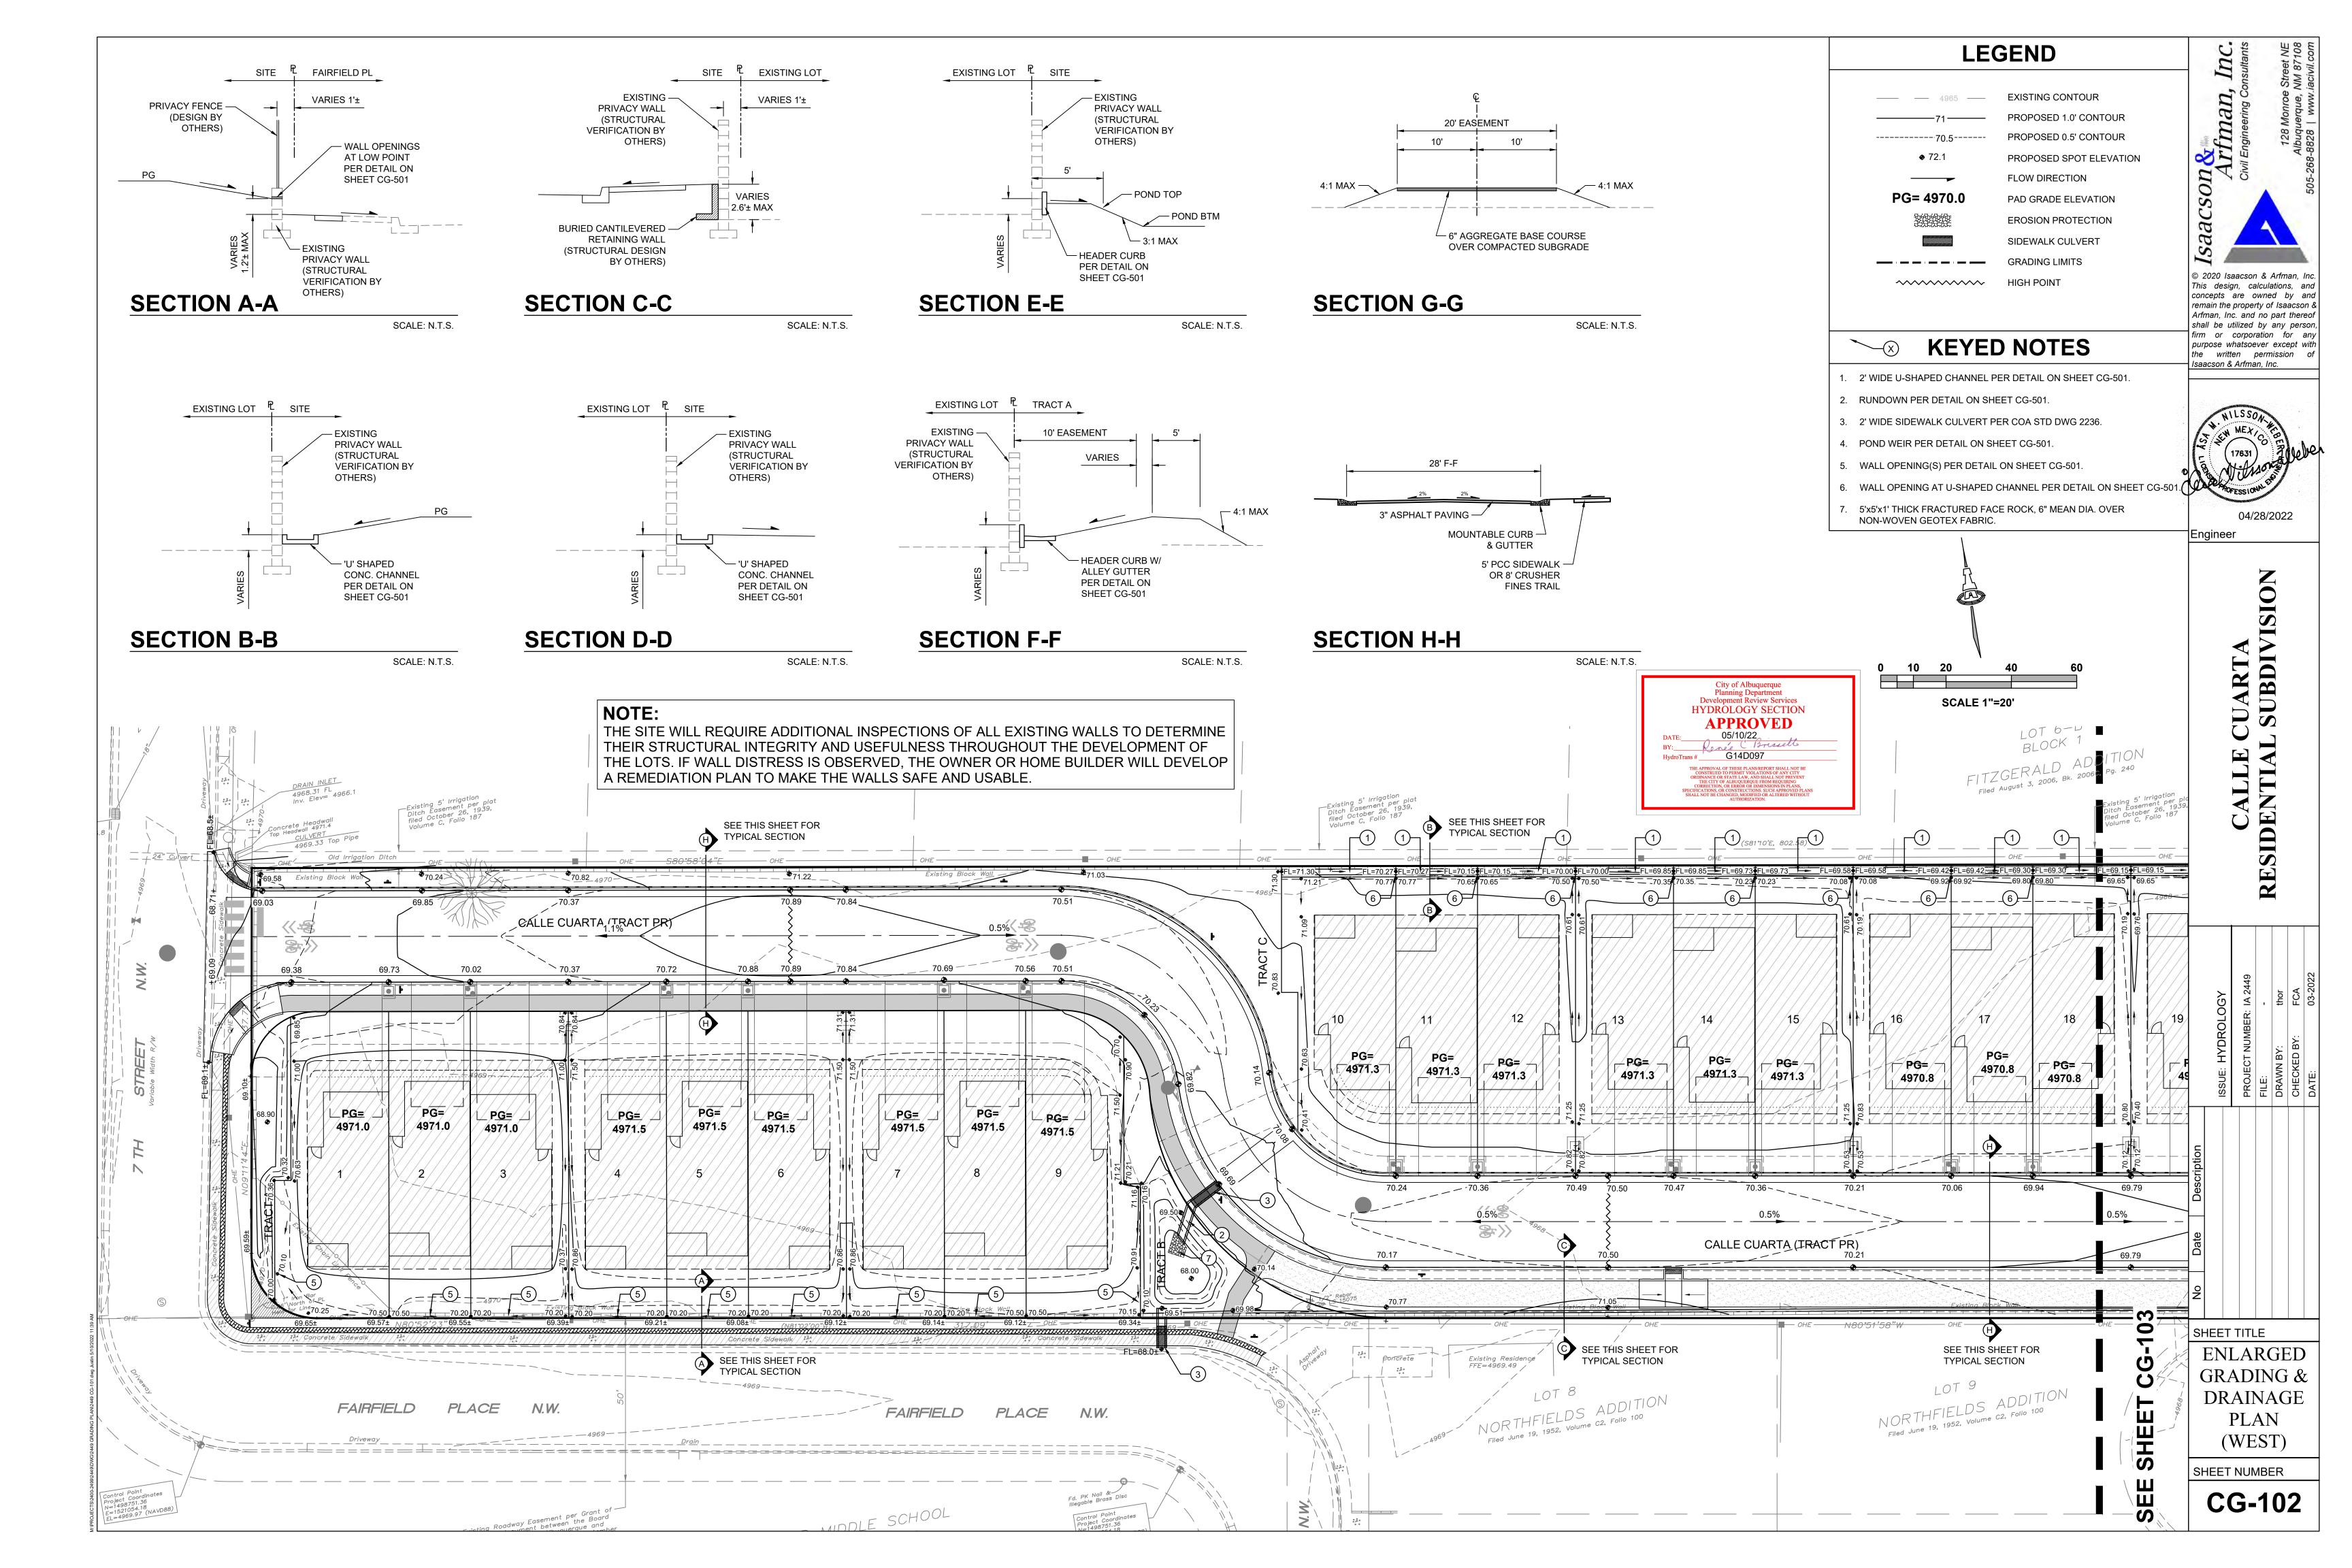


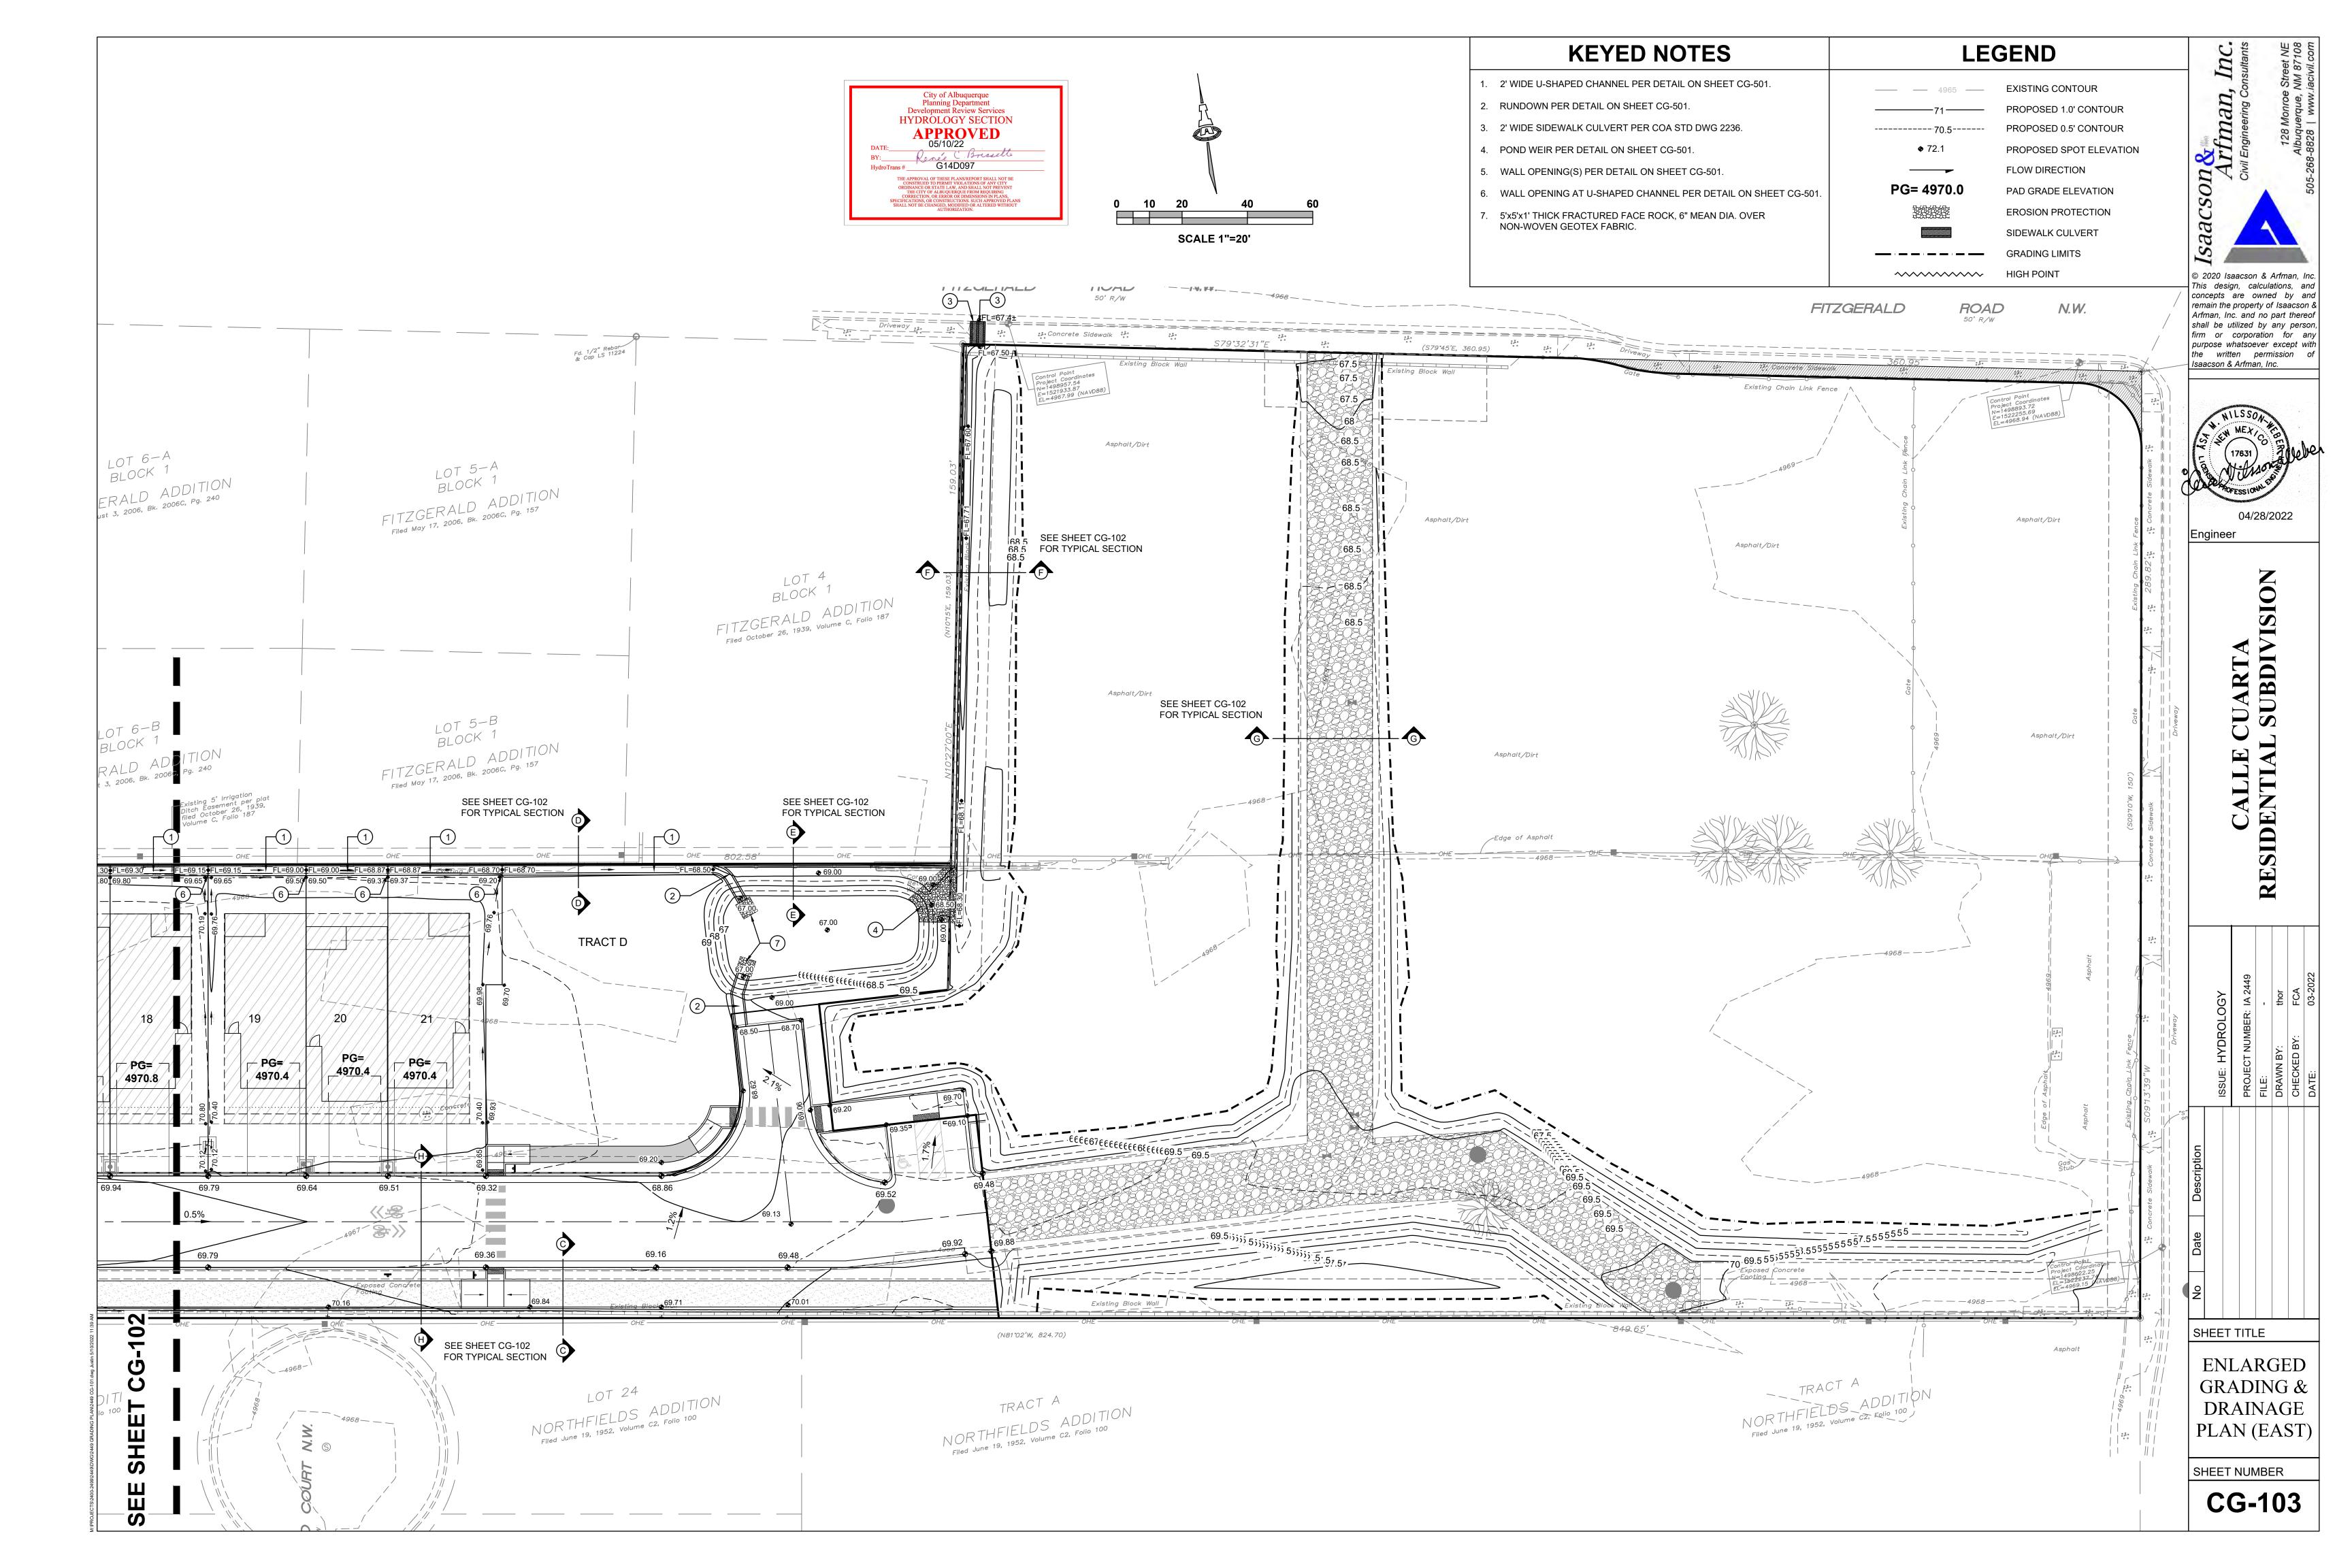


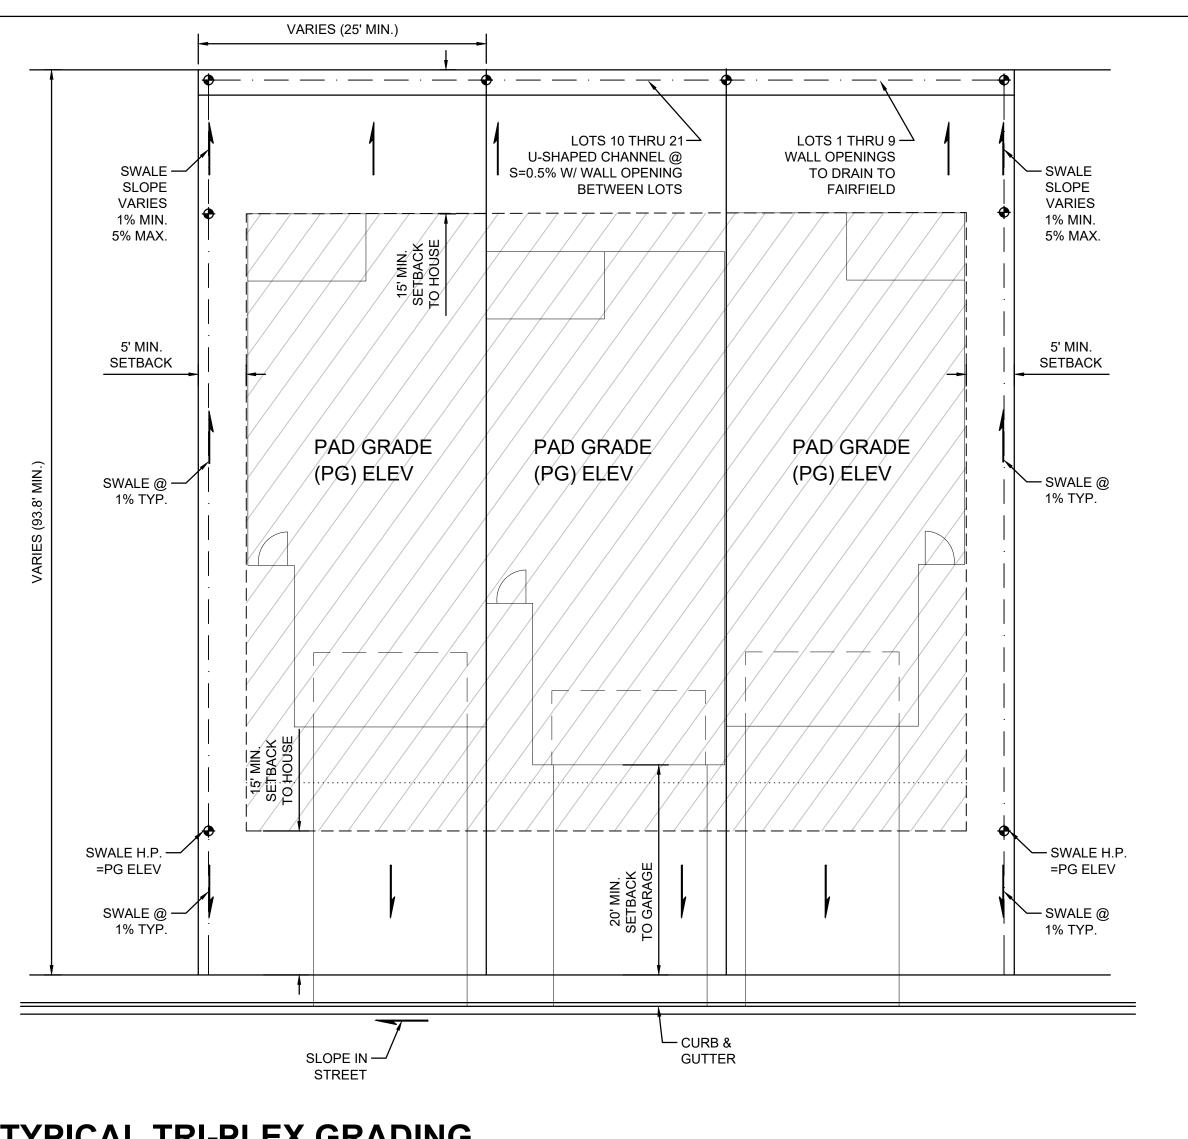

TYPICAL TRI-PLEX GRADING

SCALE: N.T.S.

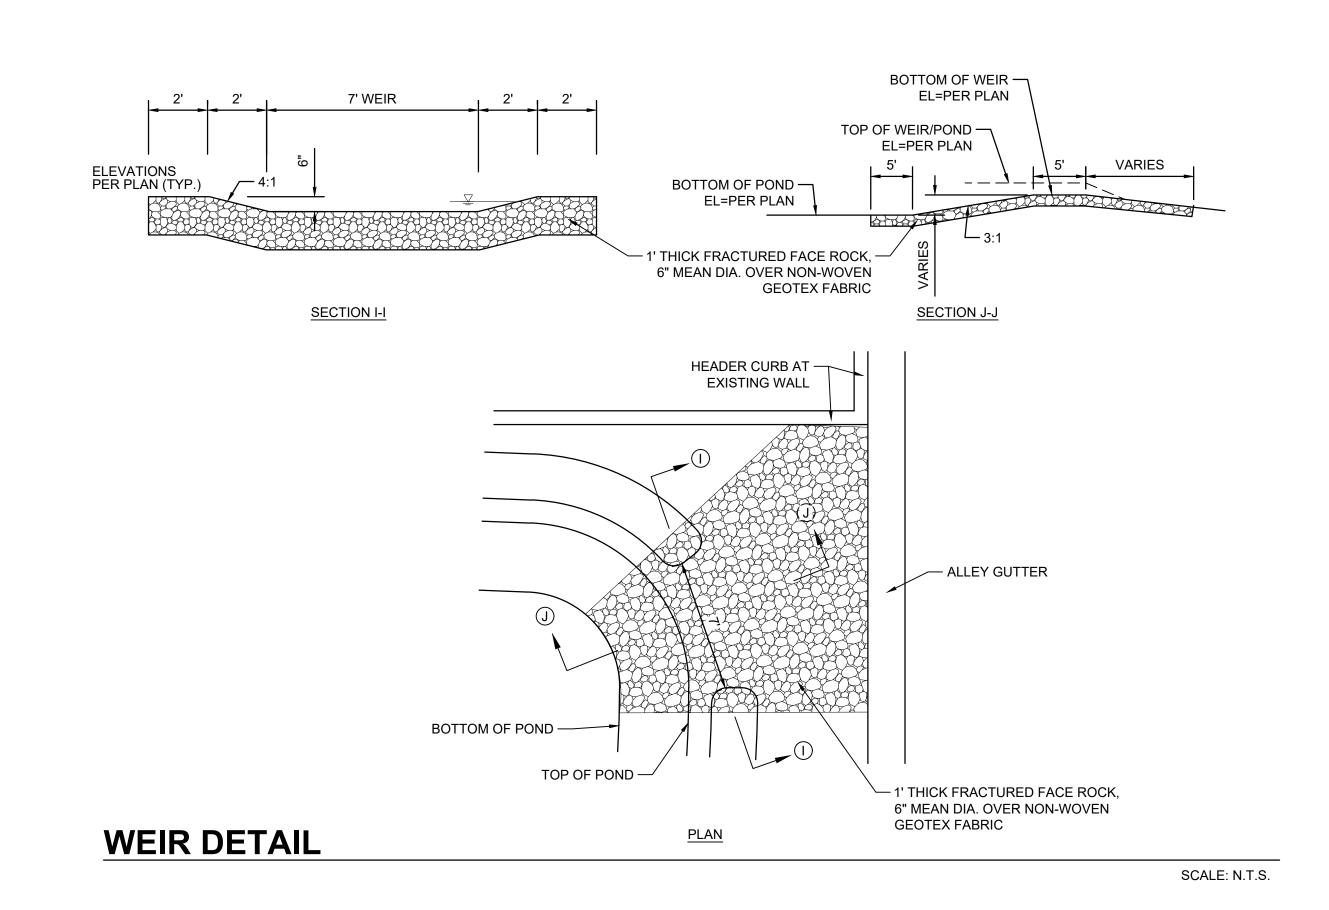

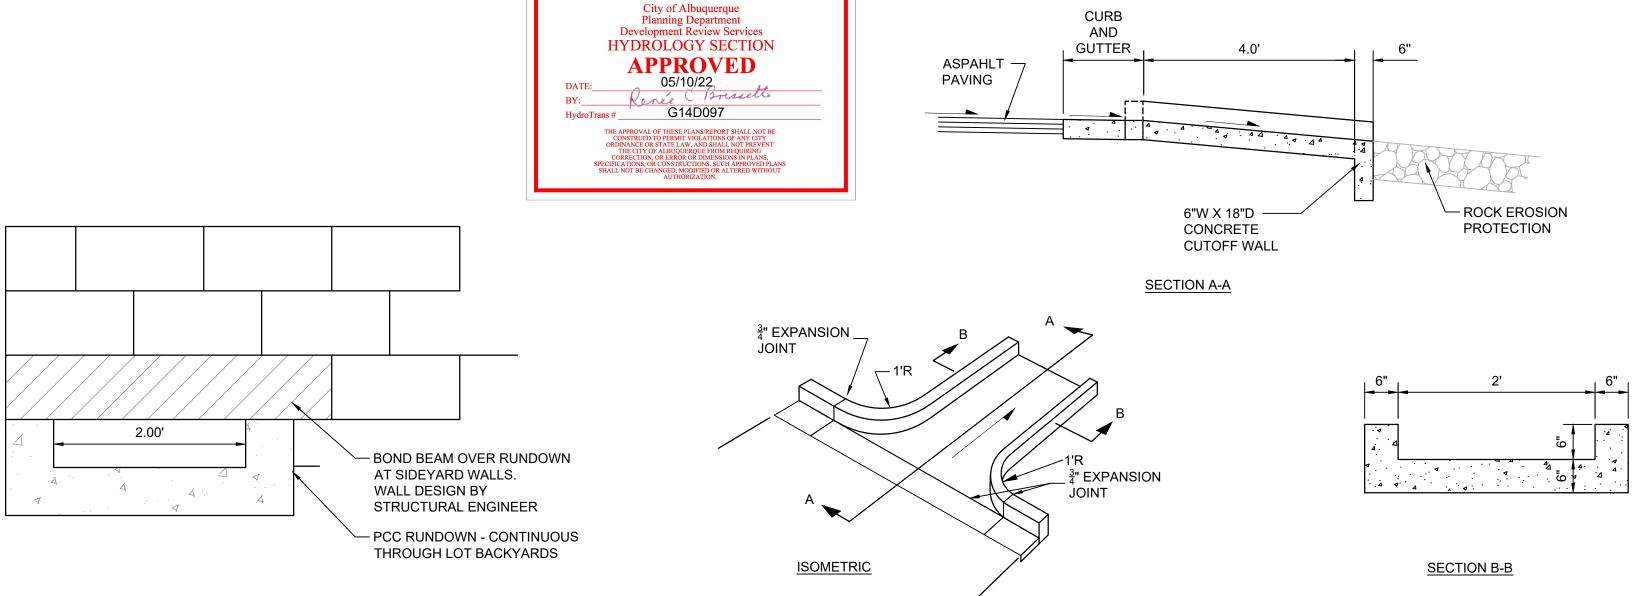


WALL OPENING AT U-SHAPED CHANNEL

SCALE: N.T.S.

CONCRETE RUNDOWN


SCALE: N.T.S.

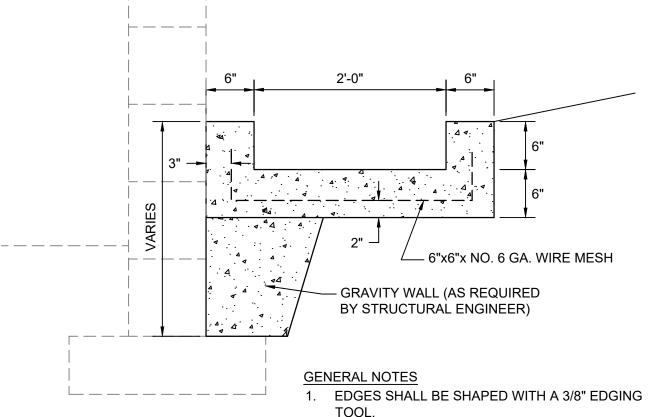

- 2. CONSTRUCTION CONTROL JOINTS AT 6' O.C.
- 3. 1/2" SILICON SEALED EXPANSION JOINTS 24' O.C., ALONG WALL FACE, AND AT SIDEWALK CULVERT.
- 4. 3/8" RADII AT ALL EXPOSED EDGES.

'U' SHAPED CONC. CHANNEL


SCALE: N.T.S.

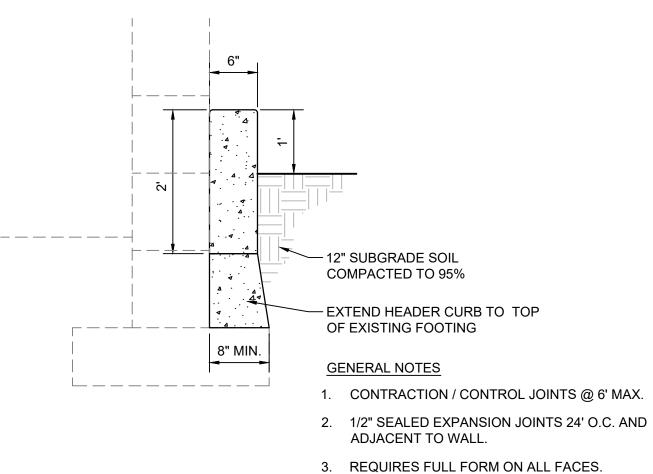

4. 3/8" RADII AT ALL EXPOSED EDGES.

HEADER CURB


SCALE: N.T.S.

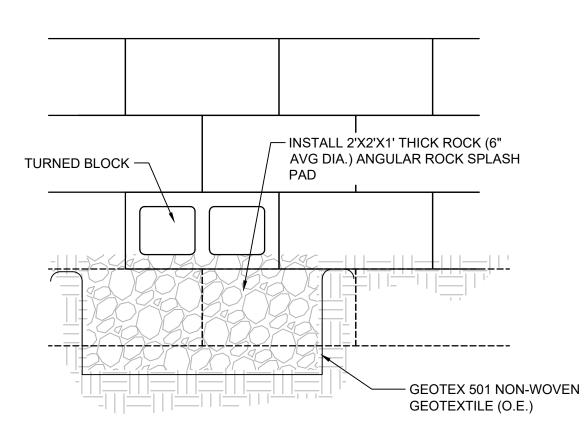

GENERAL NOTES 1. TURN EVERY 5 BLOCKS ALONG BACK YARD WALL TO PROVIDE OPENINGS TO PASS STORM WATER.

CMU WALL OPENING(S)

SCALE: N.T.S.

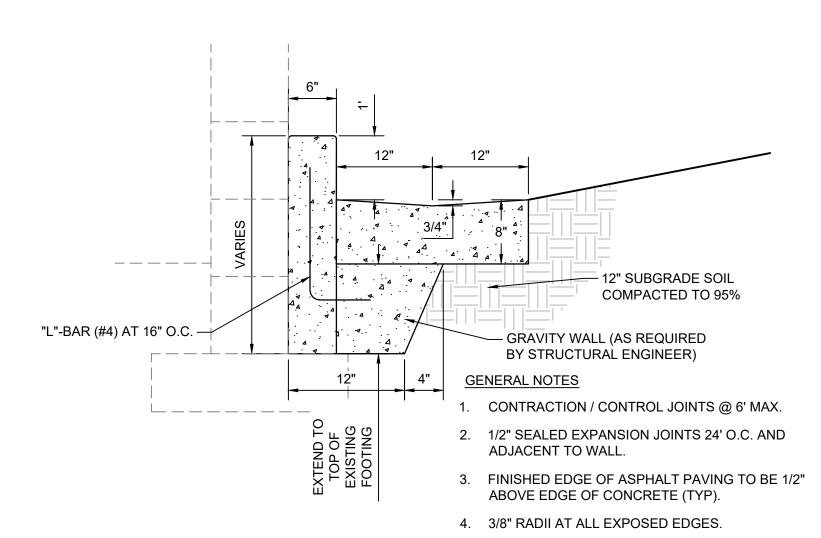

HEADER CURB W/ ALLEY GUTTER

SCALE: N.T.S.

purpose whatsoever except with Isaacson & Arfman, Inc.



Engineer

CUARTA SUBDIVISION

SHEET TITLE

GRADING & DRAINAGE **DETAILS**

SHEET NUMBER

CG-501

