

Offsite flows do not impact the site. The entire site is located within Zone X as shown in the

35001C0138D. The existing site is a portion of the Comanche business park. This subdivision has

an allowable peak discharge of 3.61 CFS per acre as defined in the drainage study for SAD 216 as prepared by Andrews, Asbury and Roberts. Since this site consists of .9462 acre the allowable

Bernalillo County, New Mexico and incorporated areas, flood insurance rate map number


discharge is 3.41 CFS.

NOTICE TO CONTRACTOR

- 1. An excavation/construction permit will be required before beginning any work within City right of way. An approved copy of these plans must be submitted at the time of application for this permit.
- 2. All work detailed on these plans to be performed, except as otherwise stated or provided hereon, shall be constructed in accordance with "City of Albuquerque Standard Specifications for Public Works Construction" (1986 Edition).
- 3. Two working days prior to any excavation, Contractor must contact the Line Locating Service, 765-1234, for location of existing utilities.
- Prior to construction, the Contractor shall excavate and verify the horizontal and vertical locations of all obstructions. Should a conflict exist, the Contractor shall notify the Engineer so that the conflict can
- Backfill compaction shall be according to residential street use.
- Maintenance of these facilities shall be the responsibility of the Owner of the property served.
- Contractor is responsible for obtaining excavation permit for the S.O. 19 and providing proof of acceptance by the City prior to Hydrology sign—off for Certificate of Occupancy.

DRAINAGE FACILITIES WITHIN CITY RIGHT OF WAY

Design Approval HYDROLOGY SECTION DATE Inspection Approval CONSTRUCTION SECTION DATE Acceptance DATE

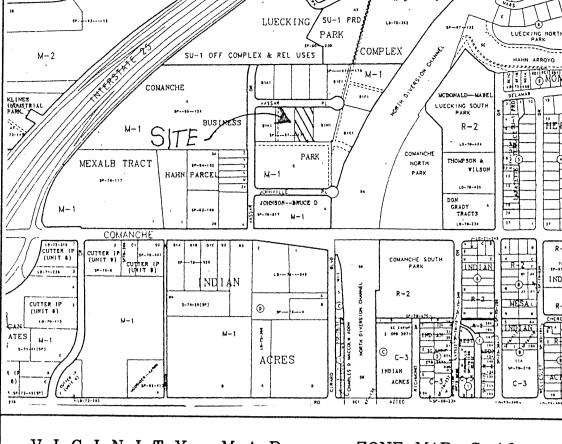

VICINITY MAP ZONE MAP: G-16

T B M (TEMPORARY BENCHMARK)

BUSINESS /

MANHOLE IS LOCATED ON VASSAR PLACE N.E. RIM= 71.42 INV = 63.20 (W)

ACS BENCHMARK

THE STATION IS LOCATED 3.5 MILES NORTH-EAST OF DOWNTOWN ALBUQUERQUE. TO REACH THE STATION FROM THE INTERSECTION OF SECOND STREET (HWY. 85 ALT.) AND MONTANO RD. N.W., GO EAST ON MONTANO RD. 1.45 MILES TO THE PAN AMERICAN WAY (1-25 WEST FRONTAGE RD.) THEN SOUTHWEST ON THE WEST FRONTAGE RD. 0.50 MILES TO THE STATION ON THE RIGHT. THE STATION MARK IS A STANDARD NM SHC BRASS TABLET STAMPED "STA. I-25-20", SET IN TOP OF A CONCRETE POST PROJECTING 0.1 FT. ABOVE GROUND.

X=390403.88 *Y=1502304.95* ELEVATION=5079.46

LEGAL DESCRIPTION

COMANCHE BUSINESS PARK TRACT B-1-1. WITHIN THE CITY OF ALBUQUERQUE, BERNALILLO COUNTY, NEW MEXICO.

LEGEND

STANDARD 8" CURB & GUTTER STANDARD 6" CURB & GUTTER PROPOSED TOP OF CURB ELEVATION PROPOSED BOTTOM OF CURB ELEVATION FLOW ARROW **71.90** PROPOSED ELEVATION FF= 72.00 FINISHED FLOOR ELEVATION

HORIZON VANS


GRADING AND DRAINAGE PLAN

MARK GOODWIN & ASSOCIATES, P.A. CONSULTING ENGINEERS

P.O. BOX 90606 ALBUQUERQUE, NEW MEXICO 87199 (505)828-2200, FAX (505)797-9539


Designed: DPS Drawn: AMB Checked: DMG Sheet **I** of **I** $8122GD20 \setminus 12-17-98 \setminus AMB$ | Scale: 1" = 20' | Date: 11-23-98 | Job: 98122

CONSTRUCTION/SECTION/PERMITS

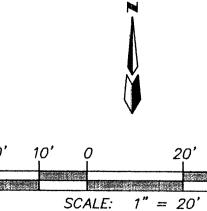





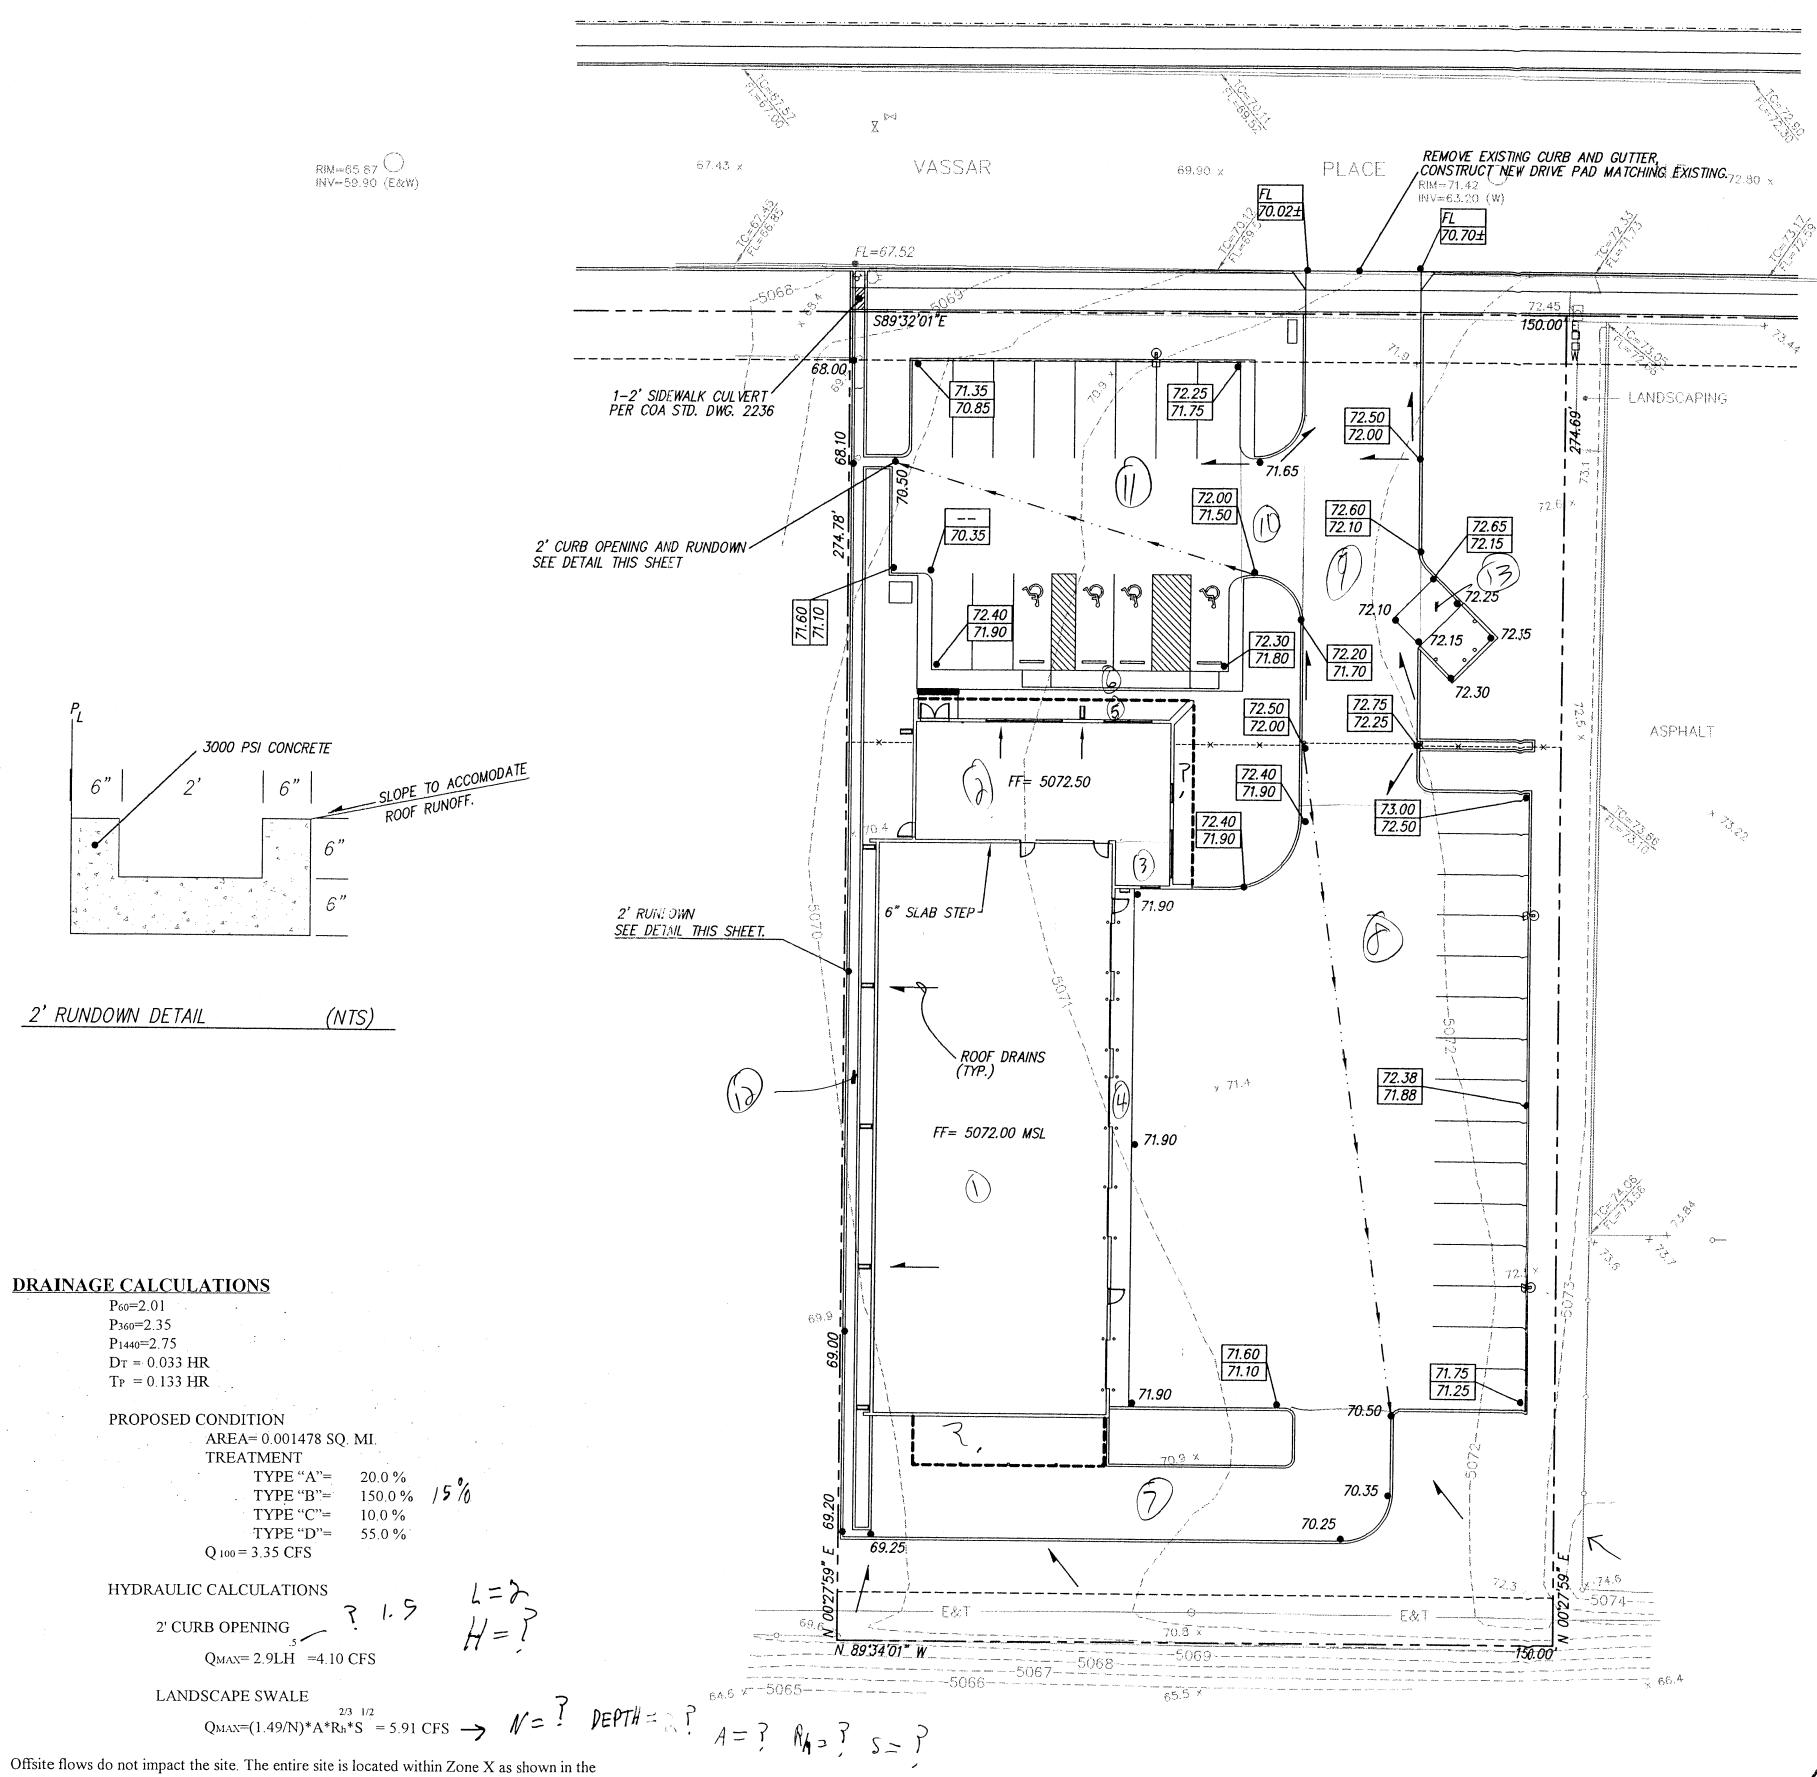

Bernalillo County, New Mexico and incorporated areas, flood insurance rate map number

prepared by Andrews, Asbury and Roberts. Since this site consists of .9462 acre the allowable

discharge is 3.41 CFS.


35001C0138D. The existing site is a portion of the Comanche business park. This subdivision has an allowable peak discharge of 3.61 CFS per acre as defined in the drainage study for SAD 216 as

NOTICE TO CONTRACTOR

- An excavation/construction permit will be required before beginning any work within City right of way. An approved copy of these plans must be submitted at the time of application for this permit.
- All work detailed on these plans to be performed, except as otherwise stated or provided hereon, shall be constructed in accordance with "City of Albuquerque Standard Specifications for Public Works Construction" (1986 Edition).
- 3. Two working days prior to any excavation, Contractor must contact the Line Locating Service, 765—1234, for location of existing utilities.
- Prior to construction, the Contractor shall excavate and verify the horizontal and vertical locations of all obstructions. Should a conflict exist, the Contractor shall notify the Engineer so that the conflict can be resolved with a minimum of delay.
- Backfill compaction shall be according to residential street use.
- Maintenance of these facilities shall be the responsibility of the Owner of the property served.
- Contractor is responsible for obtaining excavation permit for the S.O. 19 and providing proof of acceptance by the City prior to Hydrology sign-off for Certificate of Occupancy.

DRAINAGE FACILITIES WITHIN CITY RIGHT OF WAY

Design Approval HYDROLOGY SECTION DATE Inspection Approval CONSTRUCTION SECTION DATE Acceptance CONSTRUCTION/SECTION/PERMITS DATE

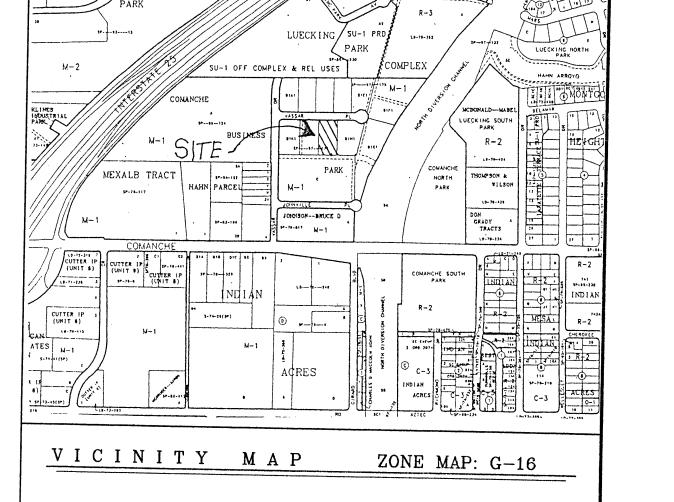

T B M (TEMPORARY BENCHMARK)

MANHOLE IS LOCATED ON VASSAR PLACE N.E. RIM= 71.42 HYDROLOGY INV = 63.20 (W)

ACS BENCHMARK

THE STATION IS LOCATED 3.5 MILES NORTH-EAST OF DOWNTOWN ALBUQUERQUE. TO REACH THE STATION FROM THE INTERSECTION OF SECOND STREET (HWY. 85 ALT.) AND MONTANO RD. N.W., GO EAST ON MONTANO RD. 1.45 MILES TO THE PAN AMERICAN WAY (1-25 WEST FRONTAGE RD.) THEN SOUTHWEST ON THE WEST FRONTAGE RD. 0.50 MILES TO THE STATION ON THE RIGHT. THE STATION MARK IS A STANDARD NM SHC BRASS TABLET STAMPED "STA. I-25-20", SET IN TOP OF A CONCRETE POST PROJECTING 0.1 FT. ABOVE GROUND.

X=390403.88

BUSINESS

ELEVATION=5079.46

LEGAL DESCRIPTION

Y=1502304.95

COMANCHE BUSINESS PARK TRACT B-1-1. WITHIN THE CITY OF ALBUQUERQUE, BERNALILLO COUNTY. NEW MEXICO.

LEGEND

FF= 72.00

STANDARD 8" CURB & GUTTER STANDARD 6" CURB & GUTTER SWALE 72.50 72.00 PROPOSED TOP OF CURB ELEVATION PROPOSED BOTTOM OF CURB ELEVATION FLOW ARROW • 71.90 PROPOSED ELEVATION

FINISHED FLOOR ELEVATION

HORIZON VANS


GRADING AND DRAINAGE PLAN


MARK GOODWIN & ASSOCIATES, P.A. CONSULTING ENGINEERS P.O. BOX 90606 ALBUQUERQUE, NEW MEXICO 87199 (505)828-2200, FAX (505)797-9539


Designed: DPS Drawn: AMB Checked: DMG 8122GD20_12-17-98\AMB | Scale: 1" = 20' | Date: 11-23-98 | Job: 98122

SCALE: 1'' = 20'



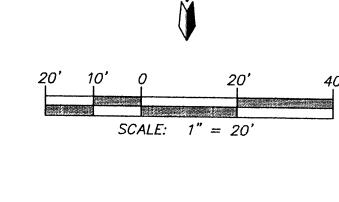

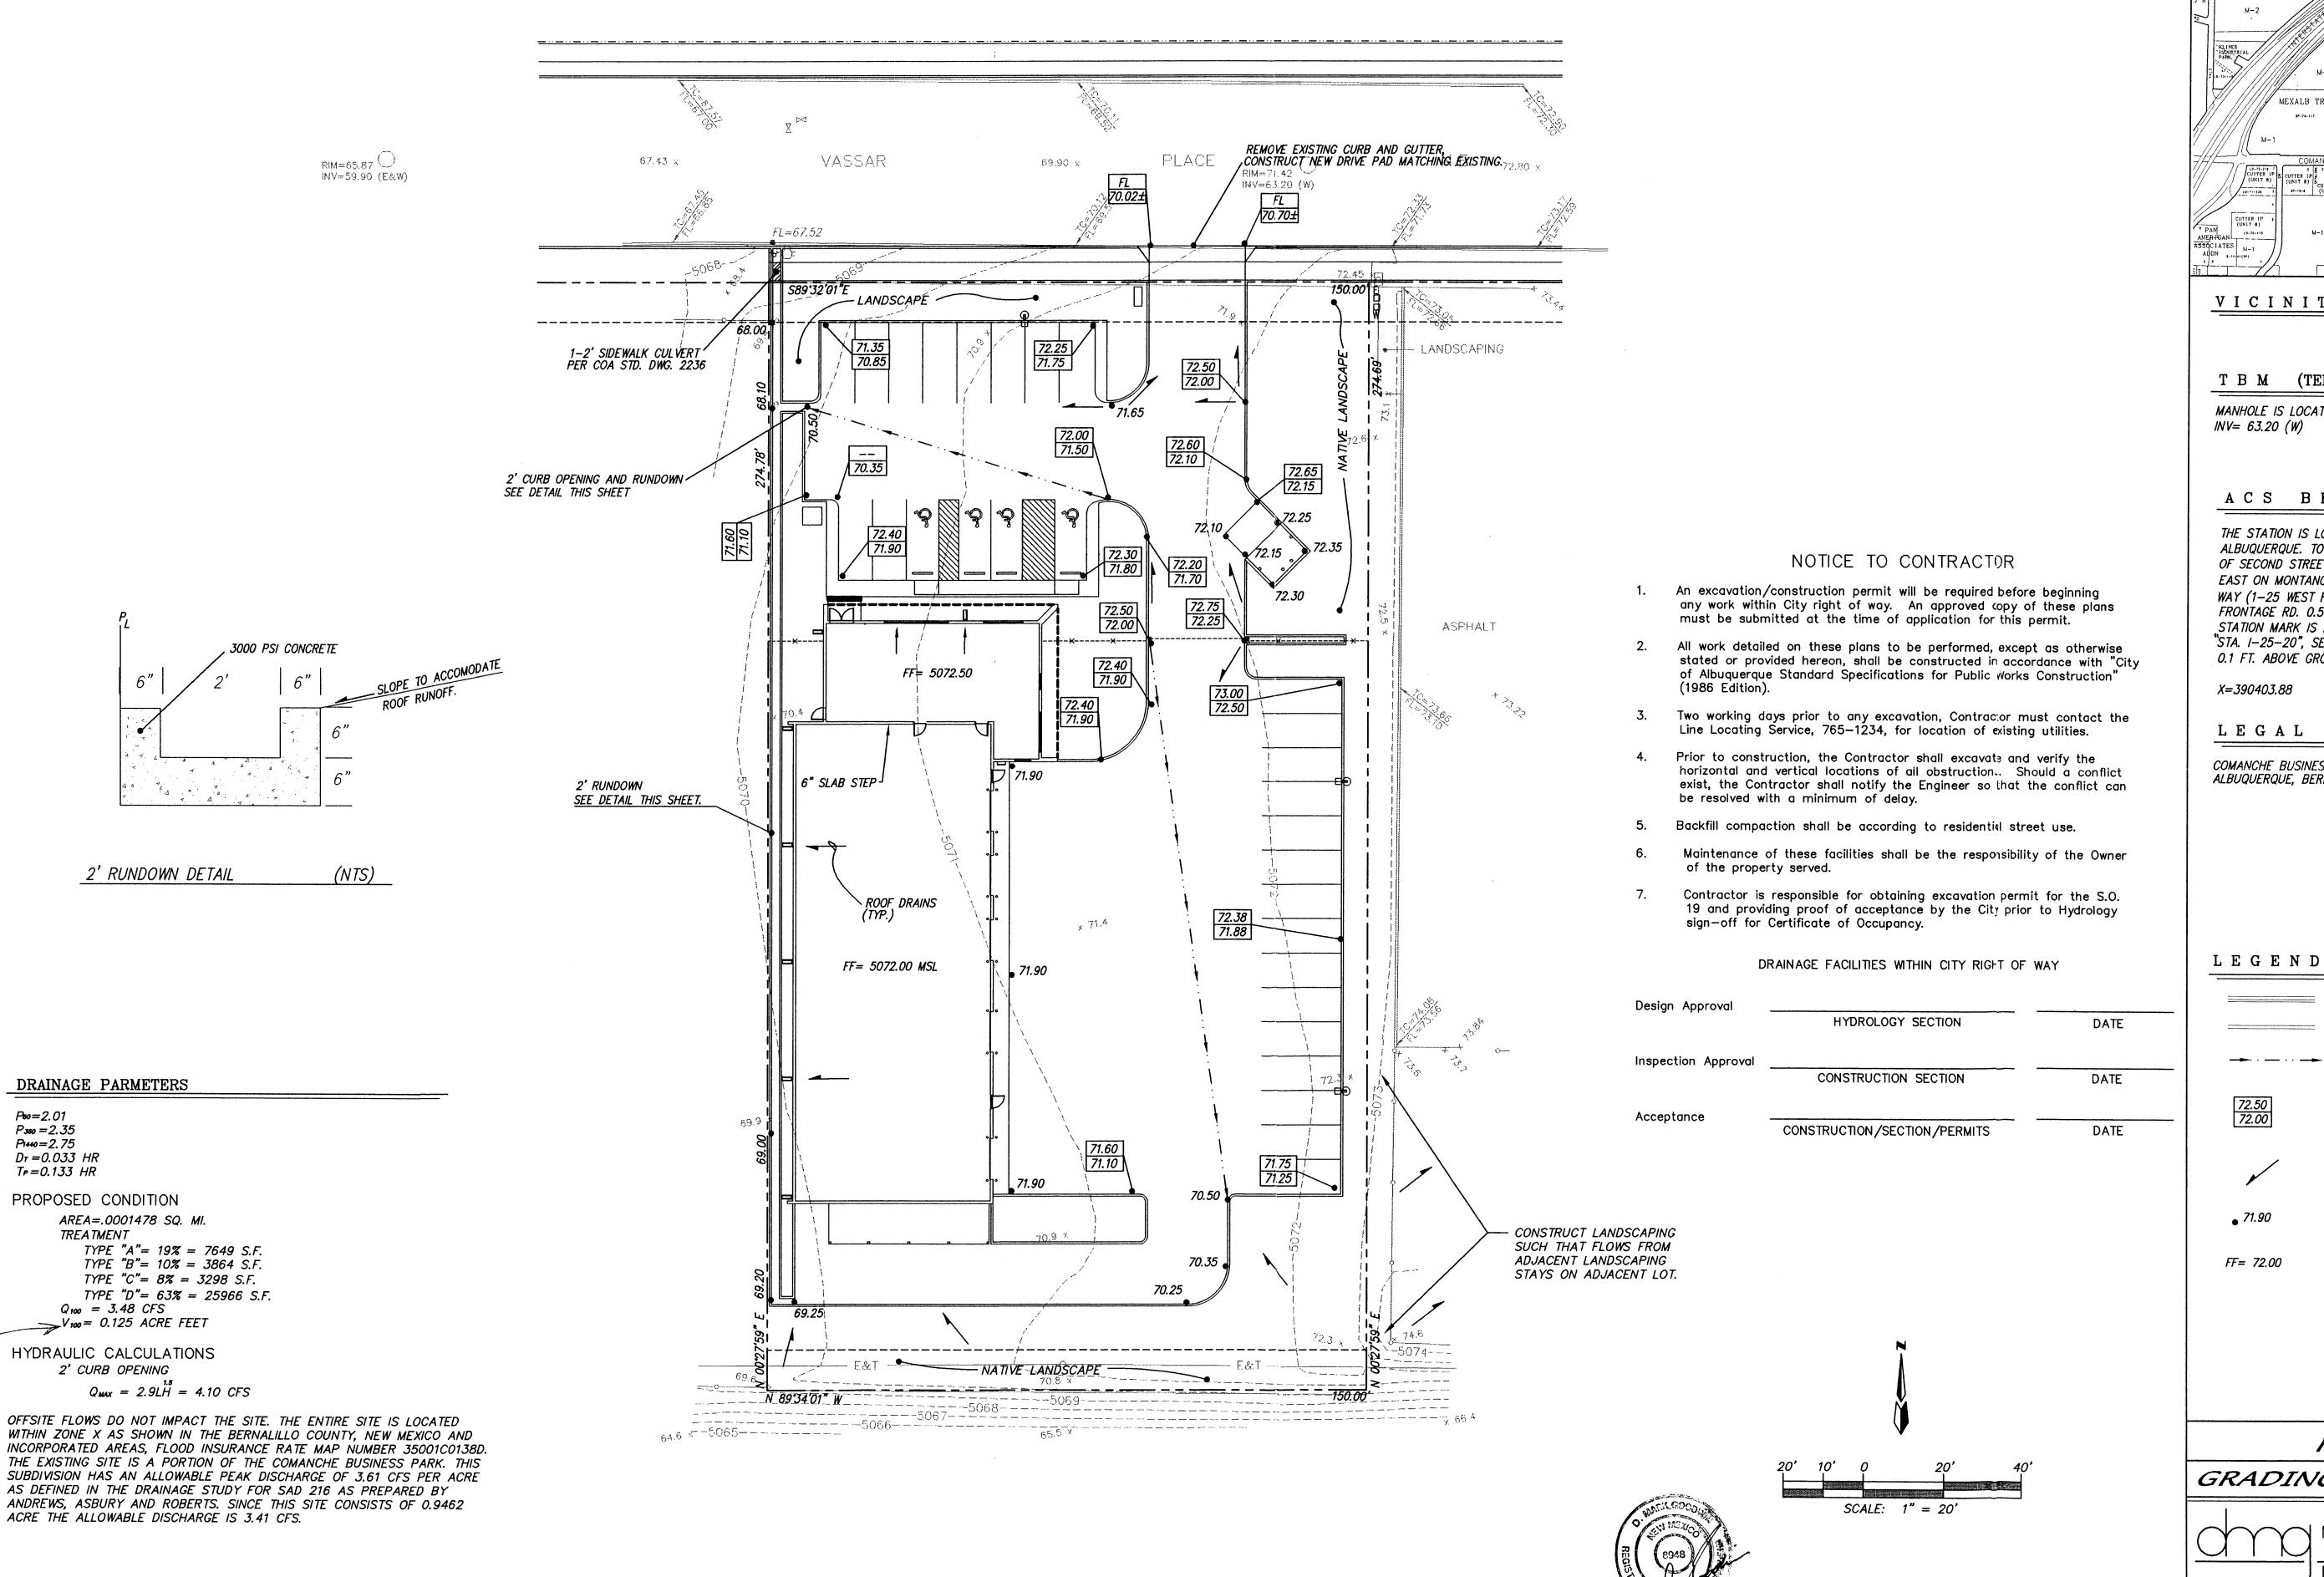

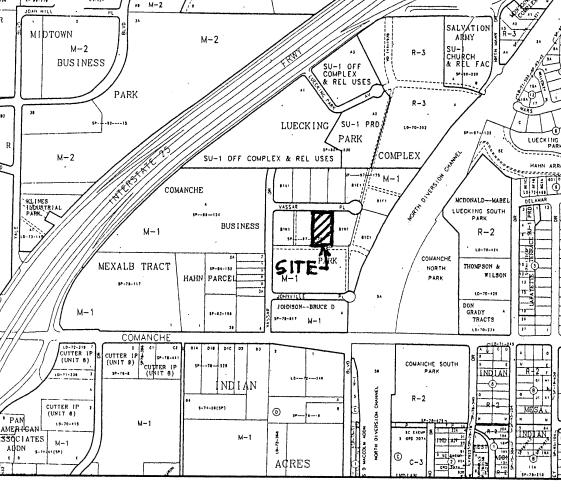

VICINITY MAP ZONE MAP: G-16-Z

T B M (TEMPORARY BENCHMARK)

MANHOLE IS LOCATED ON VASSAR PLACE N.E. RIM= 71.42 INV = 63.20 (W)

ACS BENCHMARK

THE STATION IS LOCATED 3.5 MILES NORTH-EAST OF DOWNTOWN ALBUQUERQUE. TO REACH THE STATION FROM THE INTERSECTION OF SECOND STREET (HWY. 85 ALT.) AND MONTANO RD. N.W., GO EAST ON MONTANO RD. 1.45 MILES TO THE PAN AMERICAN WAY (1-25 WEST FRONTAGE RD.) THEN SOUTHWEST ON THE WEST FRONTAGE RD. 0.50 MILES TO THE STATION ON THE RIGHT. THE STATION MARK IS A STANDARD NM SHC BRASS TABLET STAMPED "STA. I-25-20", SET IN TOP OF A CONCRETE POST PROJECTING 0.1 FT. ABOVE GROUND.

X=390403.88

ELEVATION=5079.46

LEGAL DESCRIPTION

COMANCHE BUSINESS PARK TRACT B-1-1. WITHIN THE CITY OF ALBUQUERQUE, BERNALILLO COUNTY, NEW MEXICO.

LEGEND

STANDARD 8" CURB & GUTTER STANDARD 6" CURB & GUTTER

SWALE

PROPOSED TOP OF CURB ELEVATION

PROPOSED BOTTOM OF CURB ELEVATION

FLOW ARROW

PROPOSED ELEVATION

FF= 72.00 FINISHED FLOOR ELEVATION

HORIZON VANS


GRADING AND DRAINAGE PLAN



MARK GOODWIN & ASSOCIATES, P.A. CONSULTING ENGINEERS

> P.O. BOX 90606 ALBUQUERQUE, NEW MEXICO 87199 (505)828-2200, FAX (505)797-9539

Designed: DPS | Drawn: AMB, WLV | Checked: DMG $8122NEWH \ 8122GD20 \ 02-08-99 \ AMB, WLV \ Scale: 1" = 20' \ Date: 11-98$

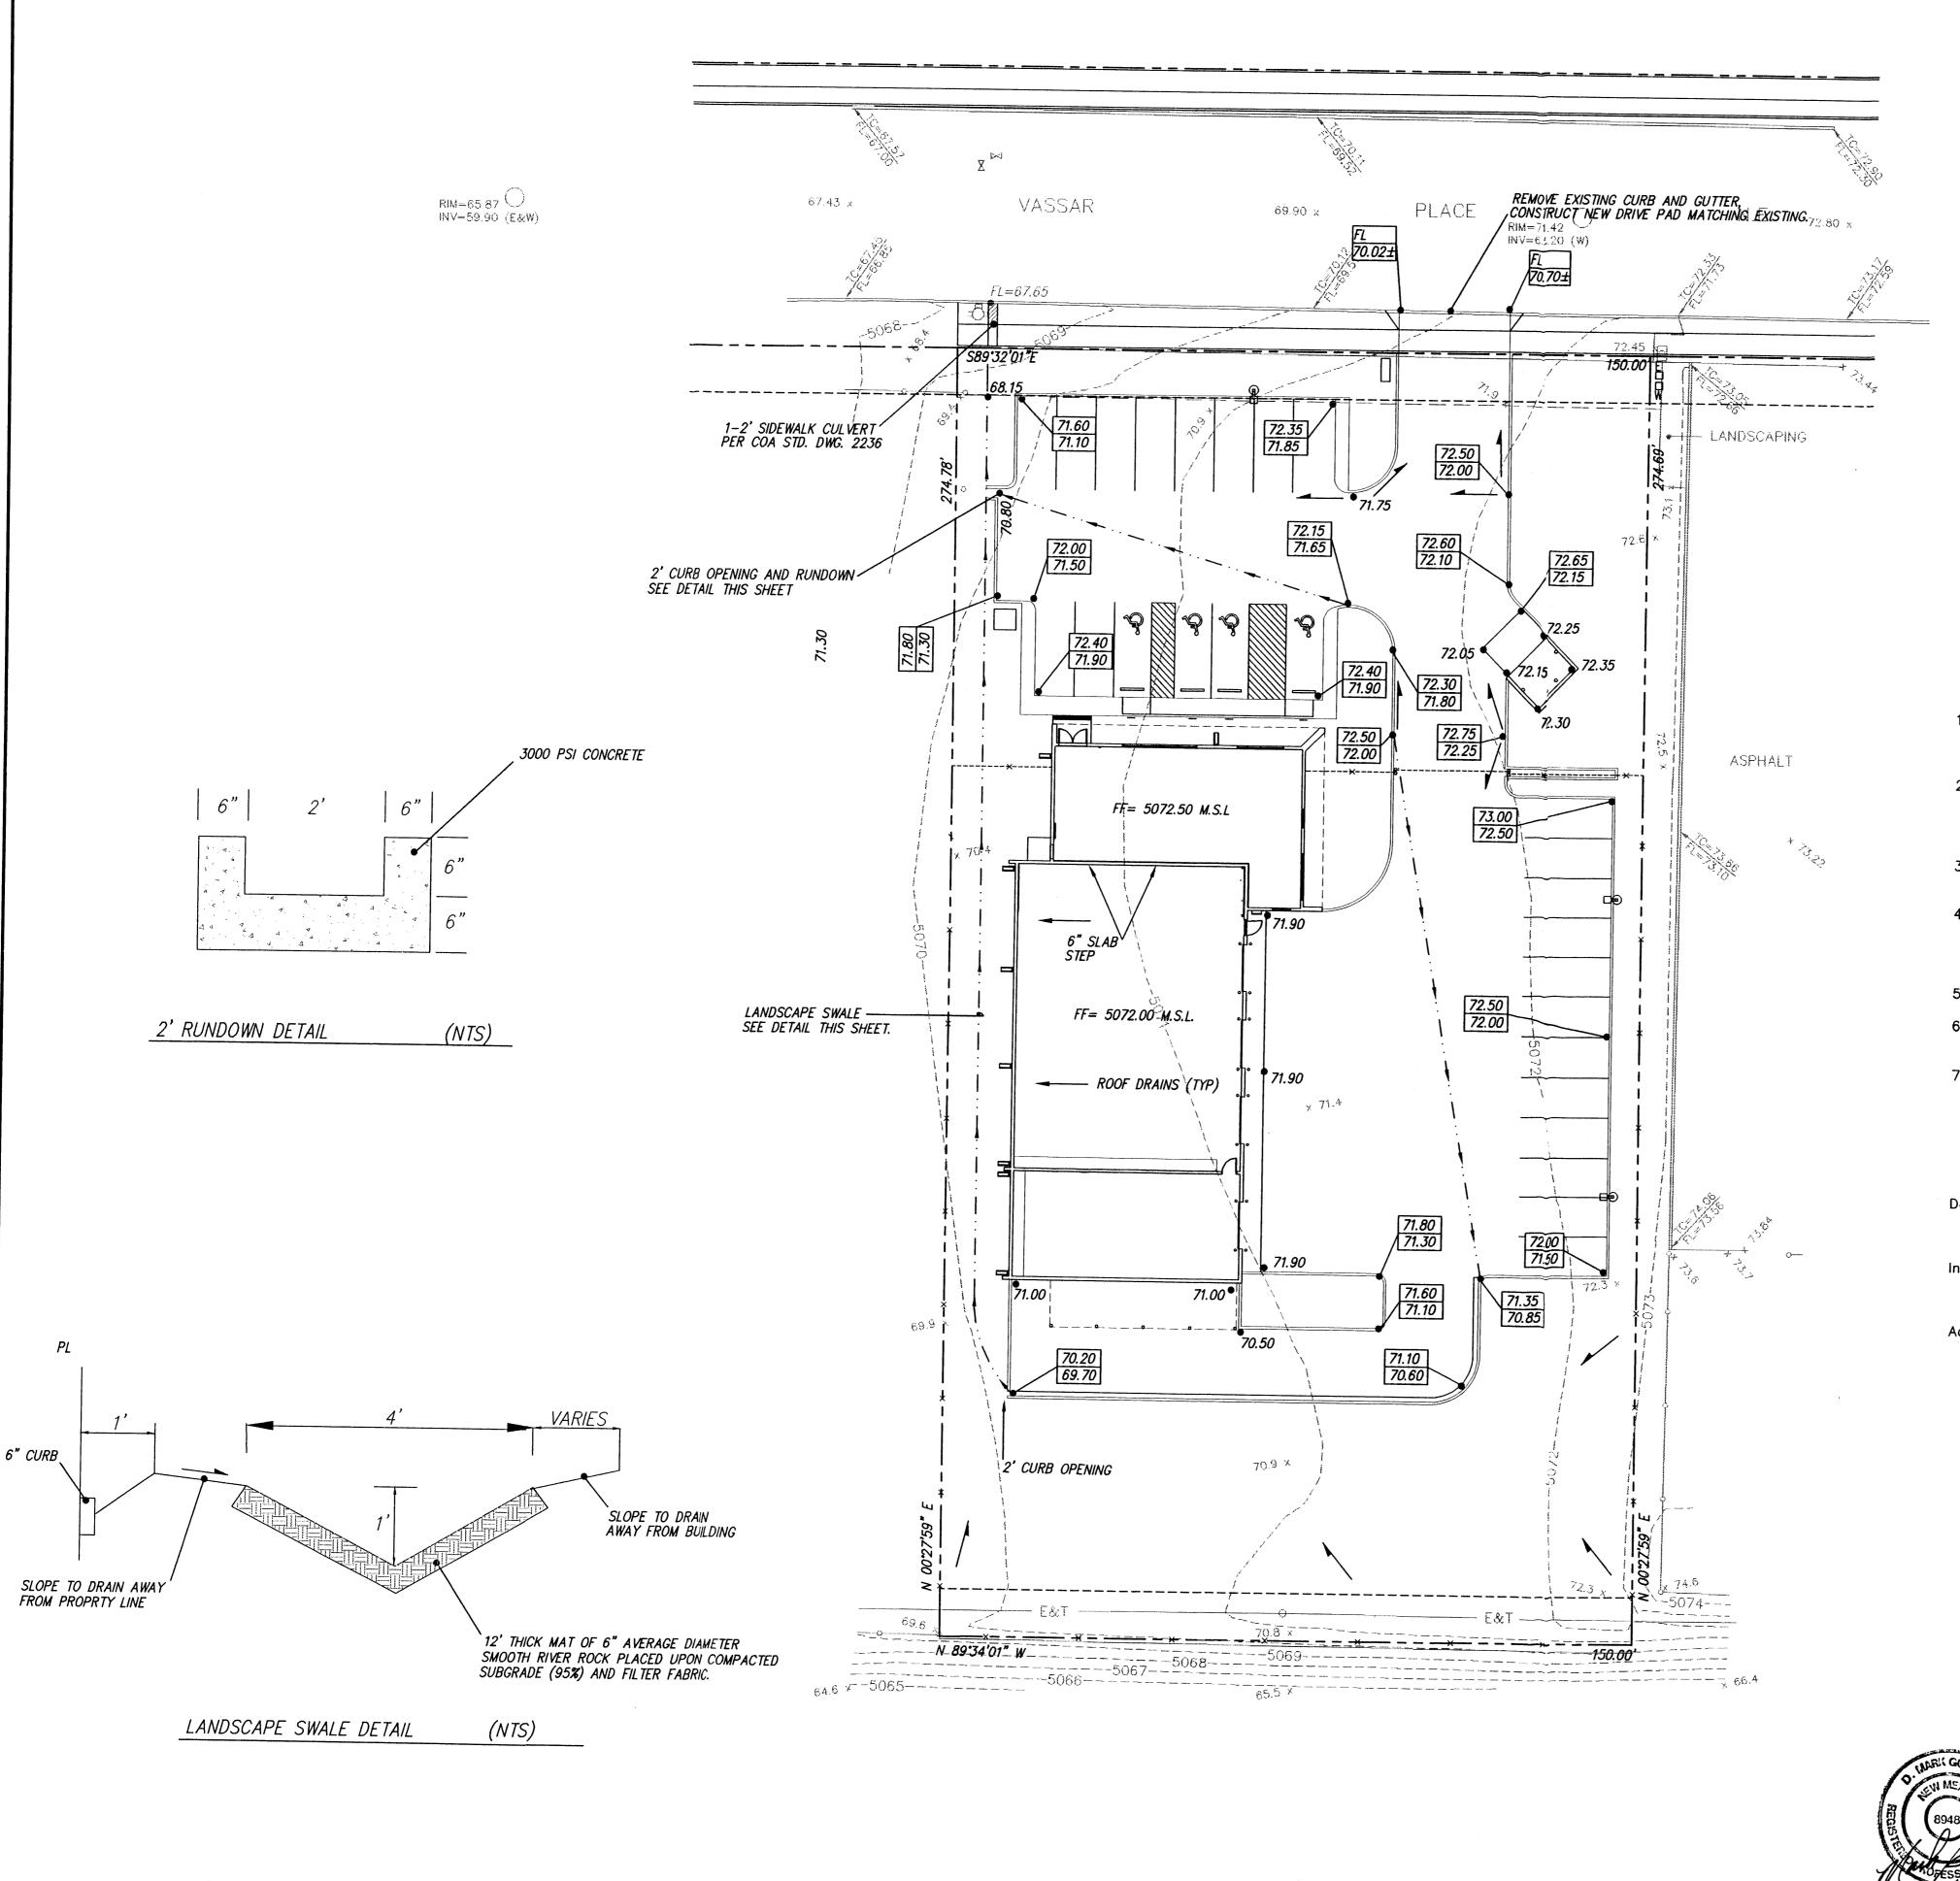



 $P_{60}=2.01$ $P_{360}=2.35$ $P_{1440}=2.75$ $D_T = 0.033 \text{ HR}$ $T_P = 0.133 \, HR$

PROPOSED CONDITION

AREA= 0.001478 SQ. MI. TREATMENT TYPE "A"= 20.0 % TYPE "B"= 150.0 % TYPE "C"= 10.0 % TYPE "D"= 55.0 % $Q_{100} = 3.35 \text{ CFS}$

HYDRAULIC CALCULATIONS

2' CURB OPENING

 Q_{MAX} = 2.9LH = 4.10 CFS

LANDSCAPE SWALE

Offsite flows do not impact the site. The entire site is located within Zone X as shown in the Bernalillo County, New Mexico and incorporated areas, flood insurance rate map number 35001C0138D. The existing site is a portion of the Comanche business park. This subdivision has an allowable peak discharge of 3.61 CFS per acre as defined in the drainage study for SAD 216 as prepared by Andrews, Asbury and Roberts. Since this site consists of .9462 acre the allowable discharge is 3.41 CFS.


 $Q_{MAX}=(1.49/N)*A*R_h*S = 5.91 CFS$

NOTICE TO CONTRACTOR

- 1. An excavation/construction permit will be required before beginning any work within City right of way. An approved copy of these plans must be submitted at the time of application for this permit.
- 2. All work detailed on these plans to be performed, except as otherwise stated or provided hereon, shall be constructed in accordance with "City of Albuquerque Standard Specifications for Public Works Construction" (1986 Edition).
- Two working days prior to any excavation, Contractor must contact the Line Locating Service, 765-1234, for location of existing utilities.
- Prior to construction, the Contractor shall excavate and verify the horizontal and vertical locations of all obstructions. Should a conflict exist, the Contractor shall notify the Engineer so that the conflict can be resolved with a minimum of delay.
- Backfill compaction shall be according to residential street use.
- Maintenance of these facilities shall be the responsibility of the Owner of the property served.
- Contractor is responsible for obtaining excavation permit for the S.O. 19 and providing proof of acceptance by the City prior to Hydrology sign-off for Certificate of Occupancy.

DRAINAGE FACILITIES WITHIN CITY RIGHT OF WAY

Design Approval HYDROLOGY SECTION DATE Inspection Approval CONSTRUCTION SECTION DATE Acceptance CONSTRUCTION/SECTION/PERMITS DATE

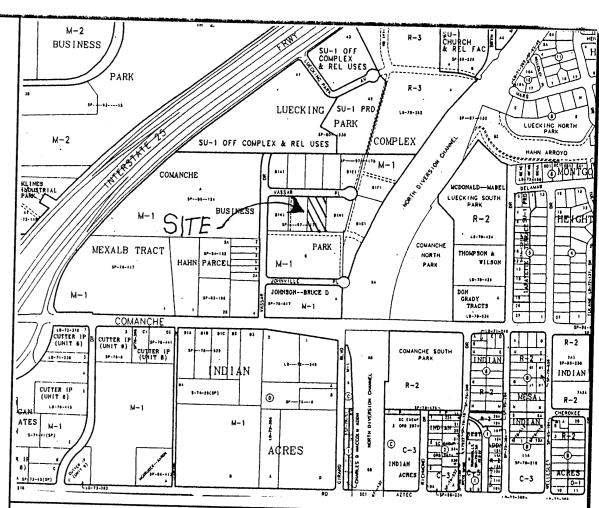

VICINITY MAP ZONE MAP: G-16

T B M (TEMPORARY BENCHMARK)

MANHOLE IS LOCATED ON VASSAR PLACE N.E. RIM= 71.42 INV= 63.20 (W)

ACS BENCHMARK

THE STATION IS LOCATED 3.5 MILES NORTH-EAST OF DOWNTOWN ALBUQUERQUE. TO REACH THE STATION FROM THE INTERSECTION OF SECOND STREET (HWY. 85 ALT.) AND MONTANO RD. N.W., GO EAST ON MONTANO RD. 1.45 MILES TO THE PAN AMERICAN WAY (1-25 WEST FRONTAGE RD.) THEN SOUTHWEST ON THE WEST FRONTAGE RD. 0.50 MILES TO THE STATION ON THE RIGHT. THE STATION MARK IS A STANDARD NM SHC BRASS TABLET STAMPED "STA. I-25-20", SET IN TOP OF A CONCRETE POST PROJECTING 0.1 FT. ABOVE GROUND.

X=390403.88 Y=1502304.95

ELEVATION=5079.46

LEGAL DESCRIPTION

CCMANCHE BUSINESS PARK TRACT B-1-1. WITHIN THE CITY OF ALBUQUERQUE, BERNALILLO COUNTY, NEW MEXICO.

LEGEND

STANDARD 8" CURB & GUTTER STANDARD 6" CURB & GUTTER SWALE

72.50 72.00 PROPOSED TOP OF CURB ELEVATION

FLOW ARROW

• 71.90

PROPOSED ELEVATION

FF= 72.00

FINISHED FLOOR ELEVATION

PROPOSED BOTTOM OF CURB ELEVATION


HORIZON VANS


GRADING AND DRAINAGE PLAN

MARK GOODWIN & ASSOCIATES, P.A. CONSULTING ENGINEERS

P.O. BOX 90606 ALBUQUERQUE, NEW MEXICO 87199 (505)828-2200, FAX (505)797-9539

Designed: DPS Drawn: AMB Checked: DMG 8122GD\11-23-98\AMB | Scale: 1'' = 20' | Date: 11-23-98 | Job: 98122

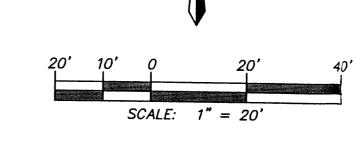

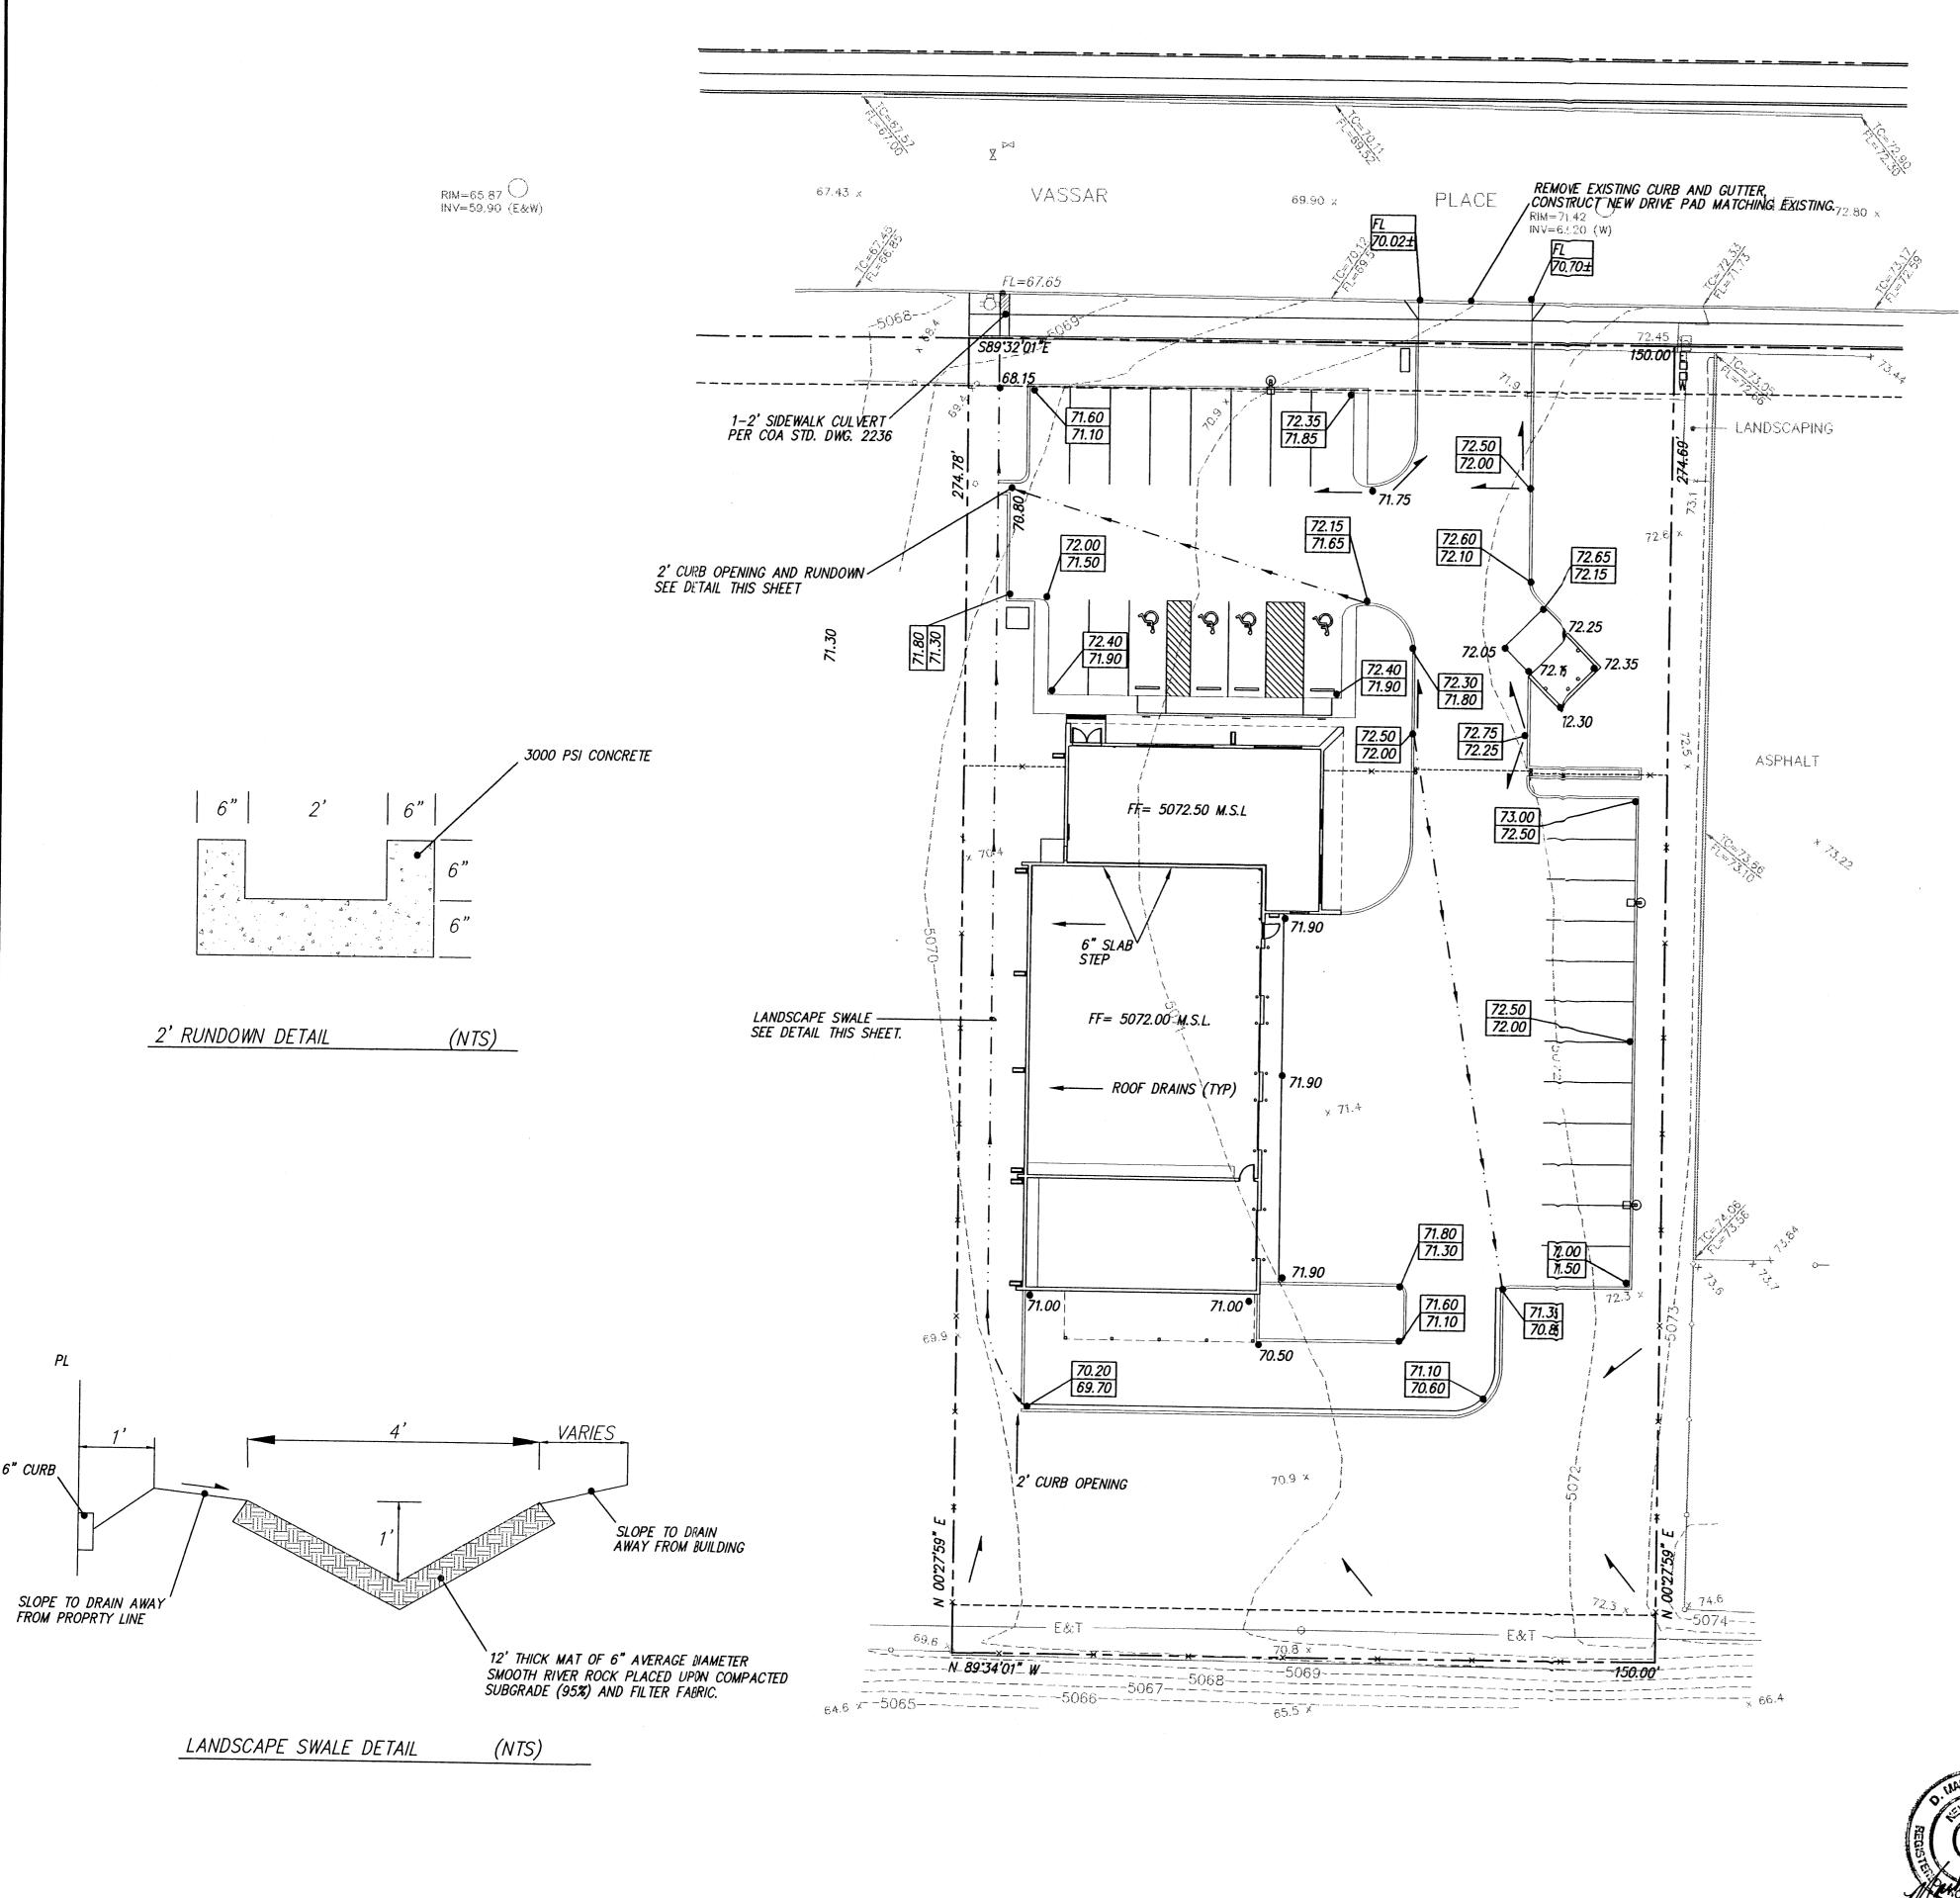



 $P_{60}=2.01$ $P_{360}=2.35$ $P_{1440}=2.75$ $D_T = 0.033 \text{ HR}$

 $T_P = 0.133 \, HR$

PROPOSED CONDITION

AREA= 0.001478 SO. MI TREATMENT TYPE "A"= 20.0 %

TYPE "B"= 150.0 % TYPE "C"= 10.0 % TYPE "D"= 55.0 % $Q_{100} = 3.35 \text{ CFS}$

HYDRAULIC CALCULATIONS

2' CURB OPENING

 Q_{MAX} = 2.9LH =4.10 CFS

LANDSCAPE SWALE

 $Q_{MAX}=(1.49/N)*A*R_h*S = 5.91 CFS$


Offsite flows do not impact the site. The entire site is located within lone X as shown in the Bernalillo County, New Mexico and incorporated areas, flood insurace rate map number 35001C0138D. The existing site is a portion of the Comanche business park. This subdivision has an allowable peak discharge of 3.61 CFS per acre as defined in the dainage study for SAD 216 as prepared by Andrews, Asbury and Roberts. Since this site consists of 9462 acre the allowable discharge is 3.41 CFS.


NOTICE TO CONTRACTOR

- 1. An excavation/construction permit will be required bfore beginning any work within City right of way. An approved coy of these plans must be submitted at the time of application for tis permit.
- 2. All work detailed on these plans to be performed, ecept as otherwise stated or provided hereon, shall be constructed in scordance with "City of Albuquerque Standard Specifications for Public Wks Construction" (1986 Edition).
- Two working days prior to any excavation, Contract must contact the Line Locating Service, 765-1234, for location of exting utilities.
- Prior to construction, the Contractor shall excavate and verify the horizontal and vertical locations of all obstructions. Should a conflict exist, the Contractor shall notify the Engineer so the the conflict can be resolved with a minimum of delay.
- Backfill compaction shall be according to residential treet use.
- Maintenance of these facilities shall be the responsility of the Owner of the property served.
- Contractor is responsible for obtaining excavation rmit for the S.O. 19 and providing proof of acceptance by the Cityrior to Hydrology sign-off for Certificate of Occupancy.

DRAINAGE FACILITIES WITHIN CITY RIGHOF WAY

Design Approval HYDROLOGY SECTION DATE Inspection Approval CONSTRUCTION SECTION DATE Acceptance CONSTRUCTION/SECTION/PERMITS DATE

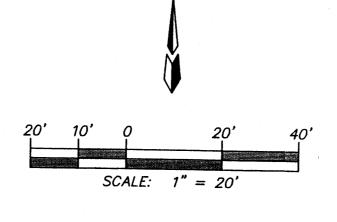

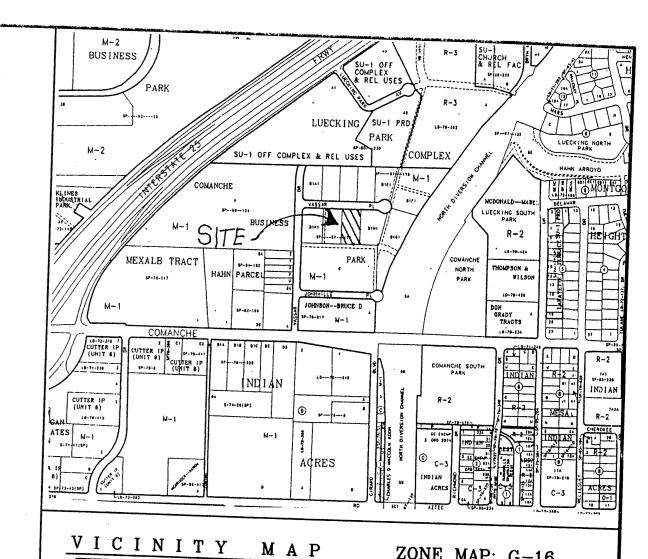

ZONE MAP: G-16

T B M (TEMPORARY BENCHMARK)

MANHOLE IS LOCATED ON VASSAR PLACE N.E. RIM= 71.42 INV= 63.20 (W)

ACS BENCHMARK

THE STATION IS LOCATED 3.5 MILES NORTH-EAST OF DOWNTOWN ALBUQUERQUE. TO REACH THE STATION FROM THE INTERSECTION OF SECOND STREET (HWY. 85 ALT.) AND MONTANO RD. N.W., GO EAST ON MONTANO RD. 1.45 MILES TO THE PAN AMERICAN WAY (1-25 WEST FRONTAGE RD.) THEN SOUTHWEST ON THE WEST FRONTAGE RD. 0.50 MILES TO THE STATION ON THE RIGHT. THE STATION MARK IS A STANDARD NM SHC BRASS TABLET STAMPED "STA. I-25-20", SET IN TOP OF A CONCRETE POST PROJECTING O.1 FT. ABOVE GROUND.

ELEVATION=5079.46

X=390403.88 Y=1502304.95

LEGAL DESCRIPTION

COMANCHE BUSINESS PARK TRACT B-1-1. WITHIN THE CITY OF ALBUQUERQUE, BERNALILLO COUNTY, NEW MEXICO.

LEGEND


STANDARD 8" CURB & GUTTER STANDARD 6" CURB & GUTTER SWALE ---

PROPOSED TOP OF CURB ELEVATION PROPOSED BOTTOM OF CURB ELEVATION

FLOW ARROW

• 71.90 PROPOSED ELEVATION

FF= 72.00 FINISHED FLOOR ELEVATION

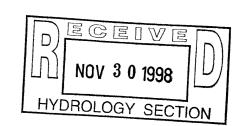


HORIZON VANS

GRADING AND DRAINAGE PLAN

MARK GOODWIN & ASSOCIATES, P.A. CONSULTING ENGINEERS P.O. BOX 90606 ALBUQUERQUE, NEW MEXICO 87199 (505)828-2200, FAX (505)797-9539


Designed: DPS Drawn: AMB Checked: DMG 8122GD\11-23-98\AMB | Scale: 1" = 20' | Date: 11-23-98 | Job: 98122



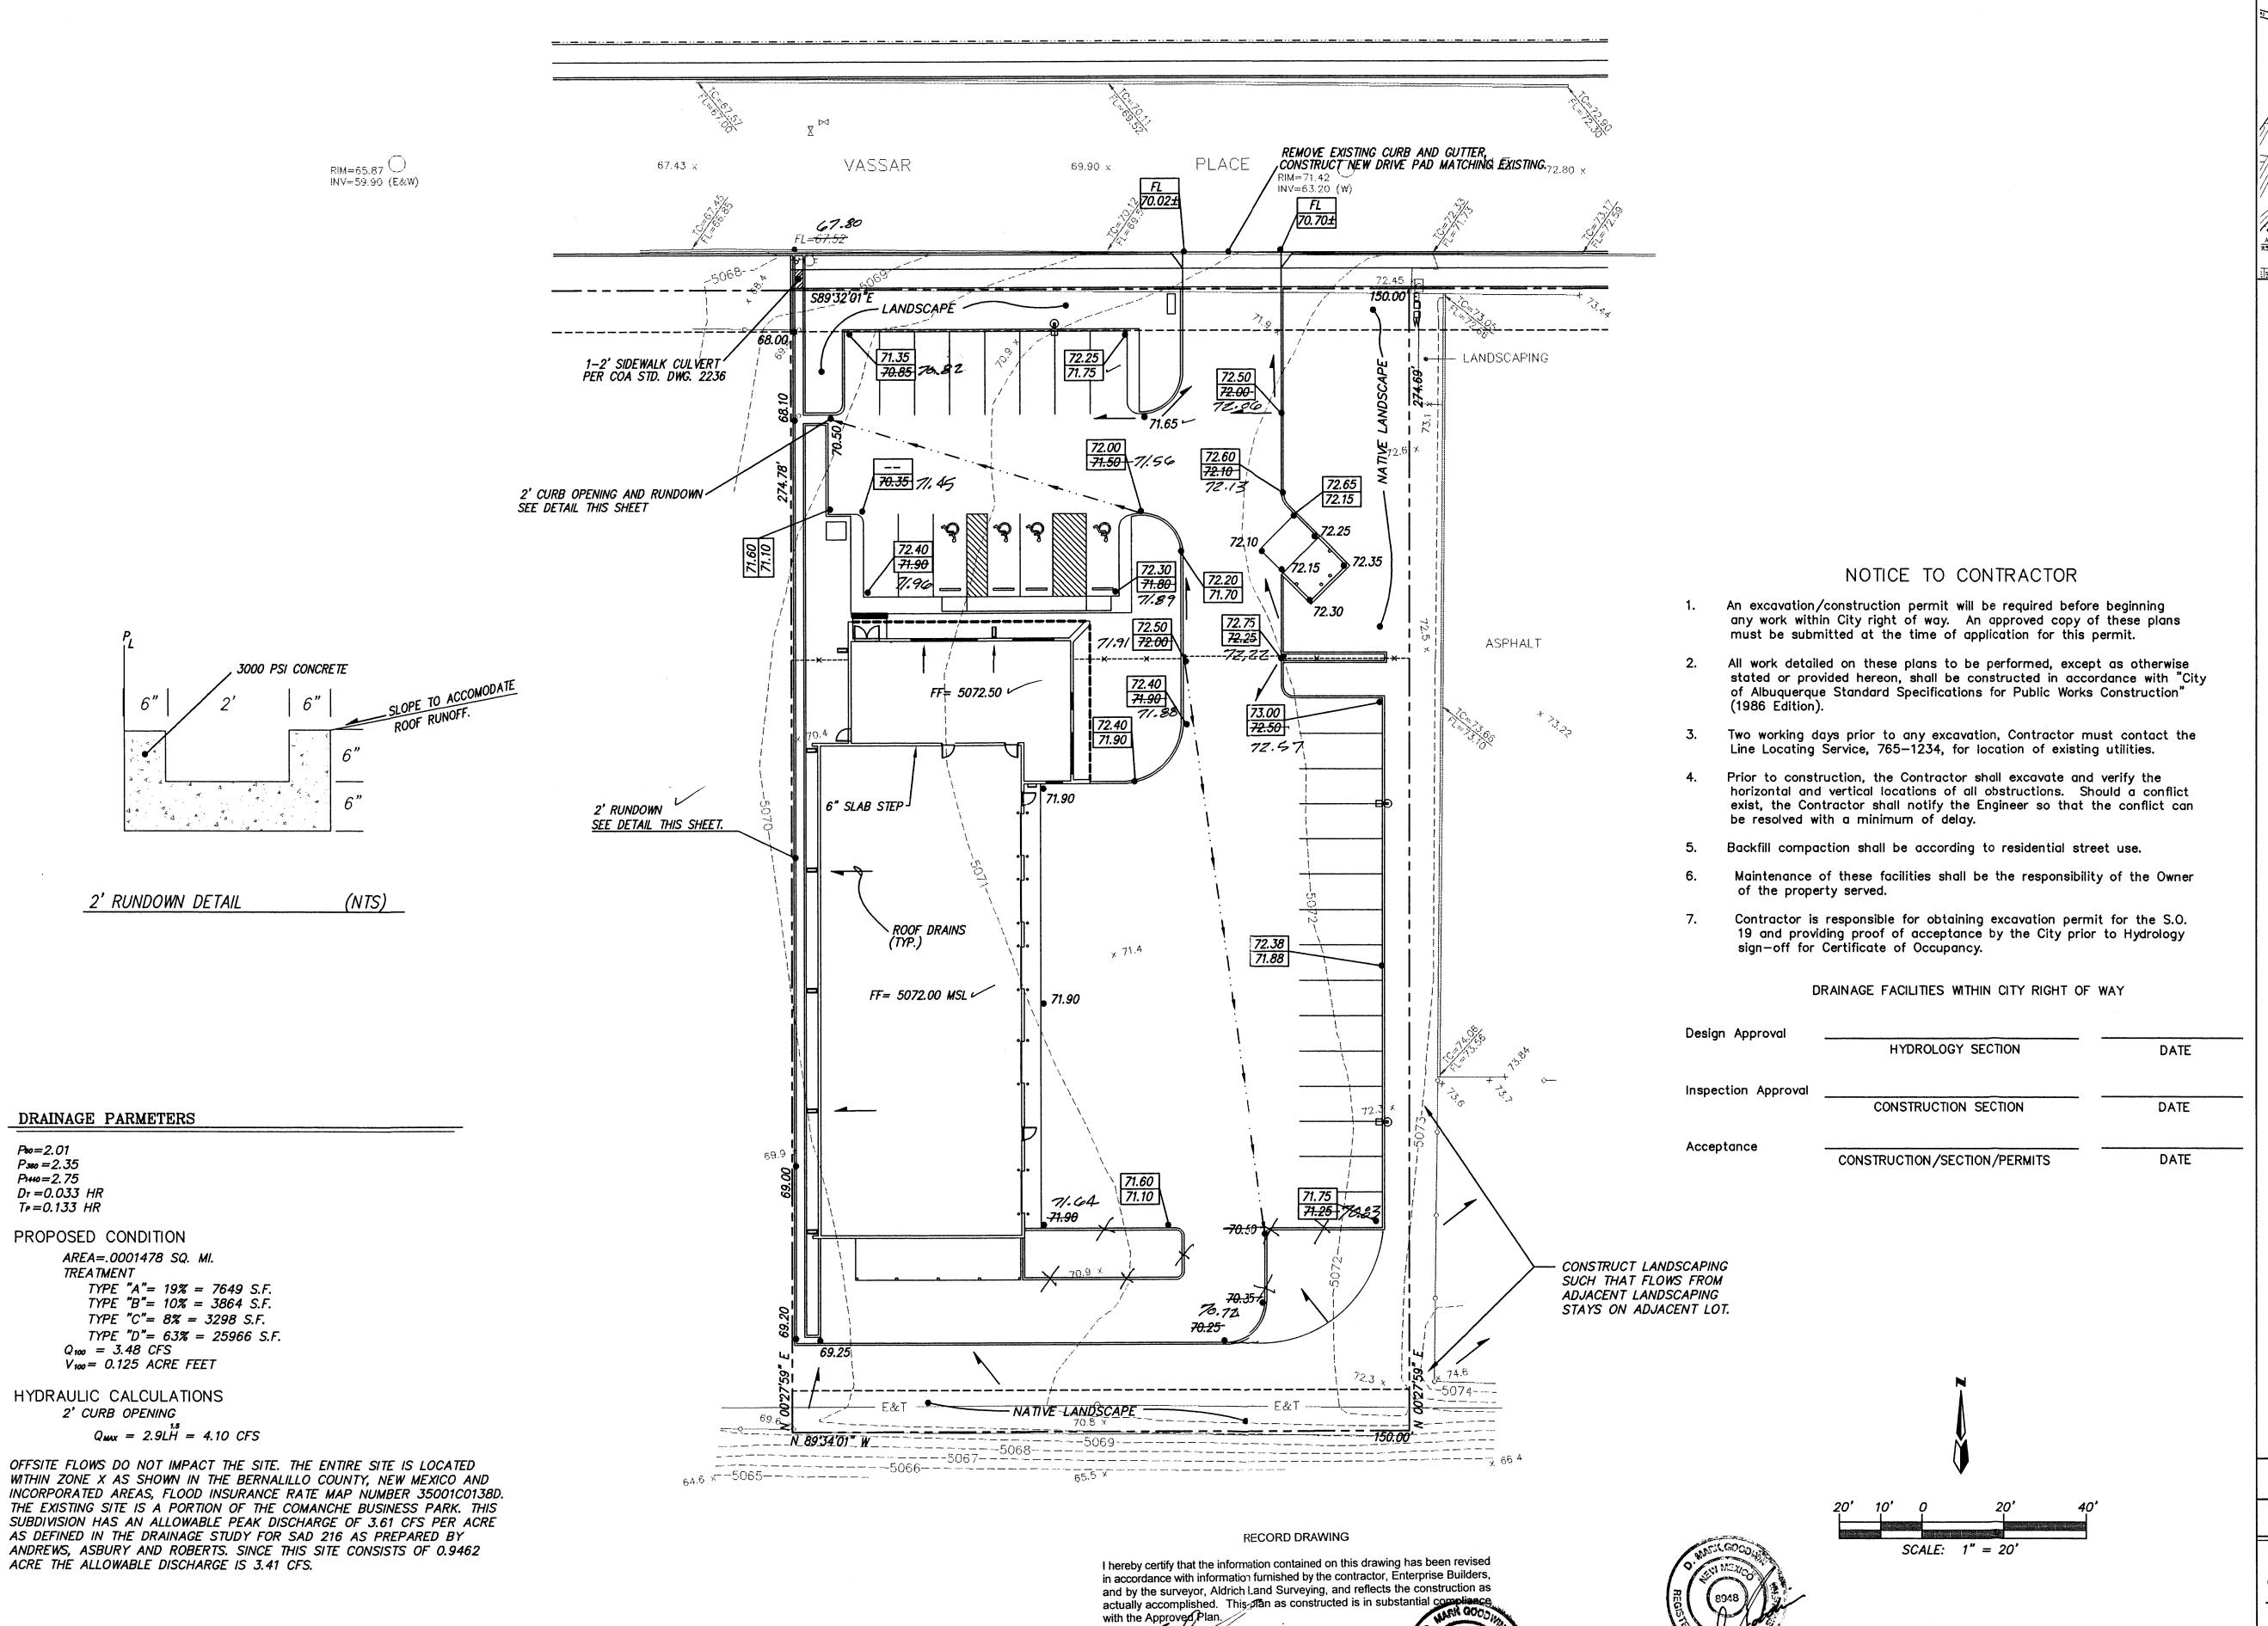

NMPE 8948

Mark Goodwin /

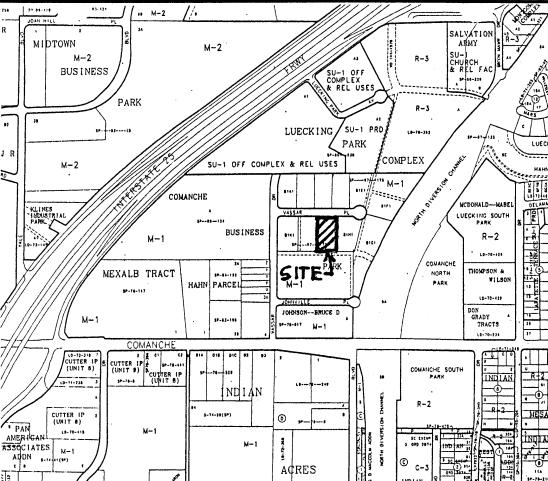

VICINITY MAP ZONE MAP: G-16-Z

T B M (TEMPORARY BENCHMARK)

MANHOLE IS LOCATED ON VASSAR PLACE N.E. RIM= 71.42 INV= 63.20 (W)

ACS BENCHMARK

THE STATION IS LOCATED 3.5 MILES NORTH-EAST OF DOWNTOWN ALBUQUERQUE. TO REACH THE STATION FROM THE INTERSECTION OF SECOND STREET (HWY. 85 ALT.) AND MONTANO RD. N.W., GO EAST ON MONTANO RD. 1.45 MILES TO THE PAN AMERICAN WAY (1-25 WEST FRONTAGE RD.) THEN SOUTHWEST ON THE WEST FRONTAGE RD. 0.50 MILES TO THE STATION ON THE RIGHT. THE STATION MARK IS A STANDARD NM SHC BRASS TABLET STAMPED "STA. I-25-20", SET IN TOP OF A CONCRETE POST PROJECTING O.1 FT. ABOVE GROUND.


ELEVATION=5079.46 X=390403.88 Y=1502304.95

LEGAL DESCRIPTION

COMANCHE BUSINESS PARK TRACT B-1-1. WITHIN THE CITY OF ALBUQUERQUE, BERNALILLO COUNTY, NEW MEXICO.

LEGEND

STANDARD 8" CURB & GUTTER STANDARD 6" CURB & GUTTER SWALE _____ AS-Built 72.50 12.40 72.00 71.91 PROPOSED TOP OF CURB ELEVATION PROPOSED BOTTOM OF CURB ELEVATION AS-Built FLOW ARROW • 71.90 PROPOSED ELEVATION FF= 72.00 FINISHED FLOOR ELEVATION

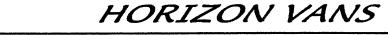

GRADING AND DRAINAGE PLAI

MARK GOODWIN & ASSOCIATES, P.A. CONSULTING ENGINEERS P.O. BOX 90606

ALBUQUERQUE, NEW MEXICO 87199 (505)828-2200, FAX (505)797-9539 Designed: DPS Drawn: AMB, WLV Checked: DMG

 $8122NEWH \ 8122GD20 \ 02-08-99 \ AMB, WLV \ Scale: 1" = 20' \ Date: 11-98$