




- 1. NEW ENTRANCE PER COA STANDARD DRAWING #2426.
- 2. EXISTING CURB AND GUTTER.
- REMOVE EXISTING CURB.
- 4. NEW ASPHALT PAVING AREA.
- 5. NEW MOUNTABLE CURB AND GUTTER PER COA STANDARD DRAWING 2415A.
- 6. NEW 4' SIDEWALK.
- 7. INSTALL HANDICAP SIGN (SEE DETAIL THIS SHEET).
- 8. TRASH ENCLOSURE (SEE DETAIL THIS SHEET).

CURVE TABLE												
NIDVE	LENGTH	RADIUS	DELTA	TANGENT	CHORD	CHORD DIRECTION						
				84.75	144.10	N32°36'42"W						
		136.81			147.10	S02*21'27"W						
C2	147.16	1510.95	05'34'49"	73.64	147.10	302 21 27 W						

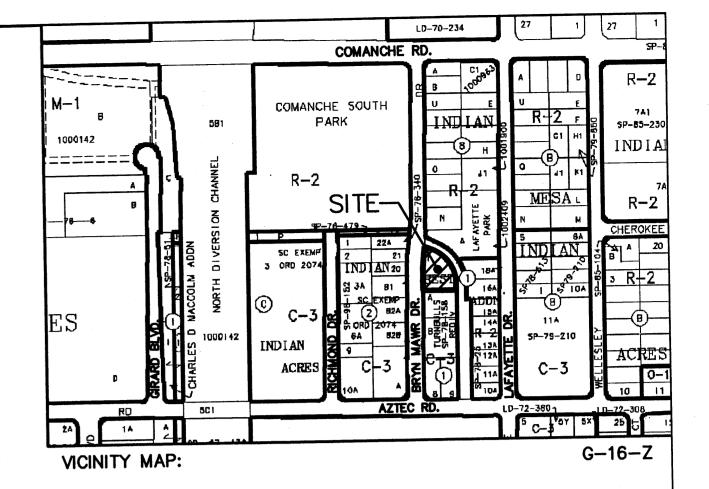

LEGAL DESCRIPTION:

LOTS 1 AND 2, BLOCK 1, INDIAN REST, CONTAINING 14,271.00 SF. (0.3276 AC.) ZONING: C-3

SITE DATA

LOT 1:

PROPOSED USAGE: LOT AREA:

WAREHOUSE 8,039.60 SF. (0.1846 AC.)

2,400.00 S.F. GROSS BUILDING AREA:

IIN (PRE-ENGINEERED STEEL BUILDING, W/ NON-COMBUSTABLE INTERIOR FRAMING

CONSTRUCTION TYPE: LANDSCAPE CALCULATIONS:

5,639.60 SF ±

845.00 SF ±

NET LOT AREA

LANDSCAPING REQUIRED: 15% OF 5,639 SF

PARKING CALCULATIONS

PARKING REQUIRED:

2,400 GSF / 2000 GSF 1 SPACES WAREHOUSE:

3 SPACES TOTAL PARKING PROVIDED:

1 SPACES (1 VAN) HC PARKING REQUIRED:

1 SPACES (1 VAN) HC PARKING PROVIDED:

LOT 2:

WAREHOUSE PROPOSED USAGE: LOT AREA:

6,231.40 SF. (0.1431 AC.) 2,400.00 S.F.

GROSS BUILDING AREA: IIN (PRE-ENGINEERED STEEL BUILDING, CONSTRUCTION TYPE: W/ NON-COMBUSTABLE INTERIOR FRAMING

LANDSCAPE CALCULATIONS:

NET LOT AREA LANDSCAPING REQUIRED: 15% OF 3,831 SF

3,831.40 SF ± 575.00 SF ±

PARKING CALCULATIONS


PARKING REQUIRED:

WAREHOUSE:

TOTAL PARKING PROVIDED:


1 SPACES (1 VAN) HC PARKING REQUIRED: 1 SPACES (1 VAN)

HC PARKING PROVIDED:

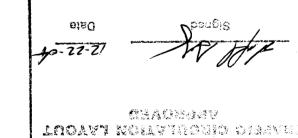



3 SPACES

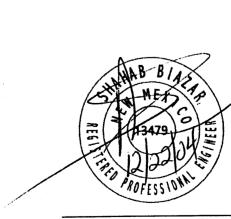




SHAHAB BIAZAR P.E. #13479

and CONSULTING, LLC


4416 ANAHEIM AVE., NE ALBUQUERQUE, NEW MEXICO 87113 (505)899-5570

LOTS 1 & 2, BLOCK 1, INDIAN REST

SITE PLAN SHEET# DRAWN BY: DRAWING: 1 OF 1 10-28-2004 SHH 200447-ST.DWG

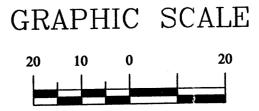

SCALE: 1"=20'

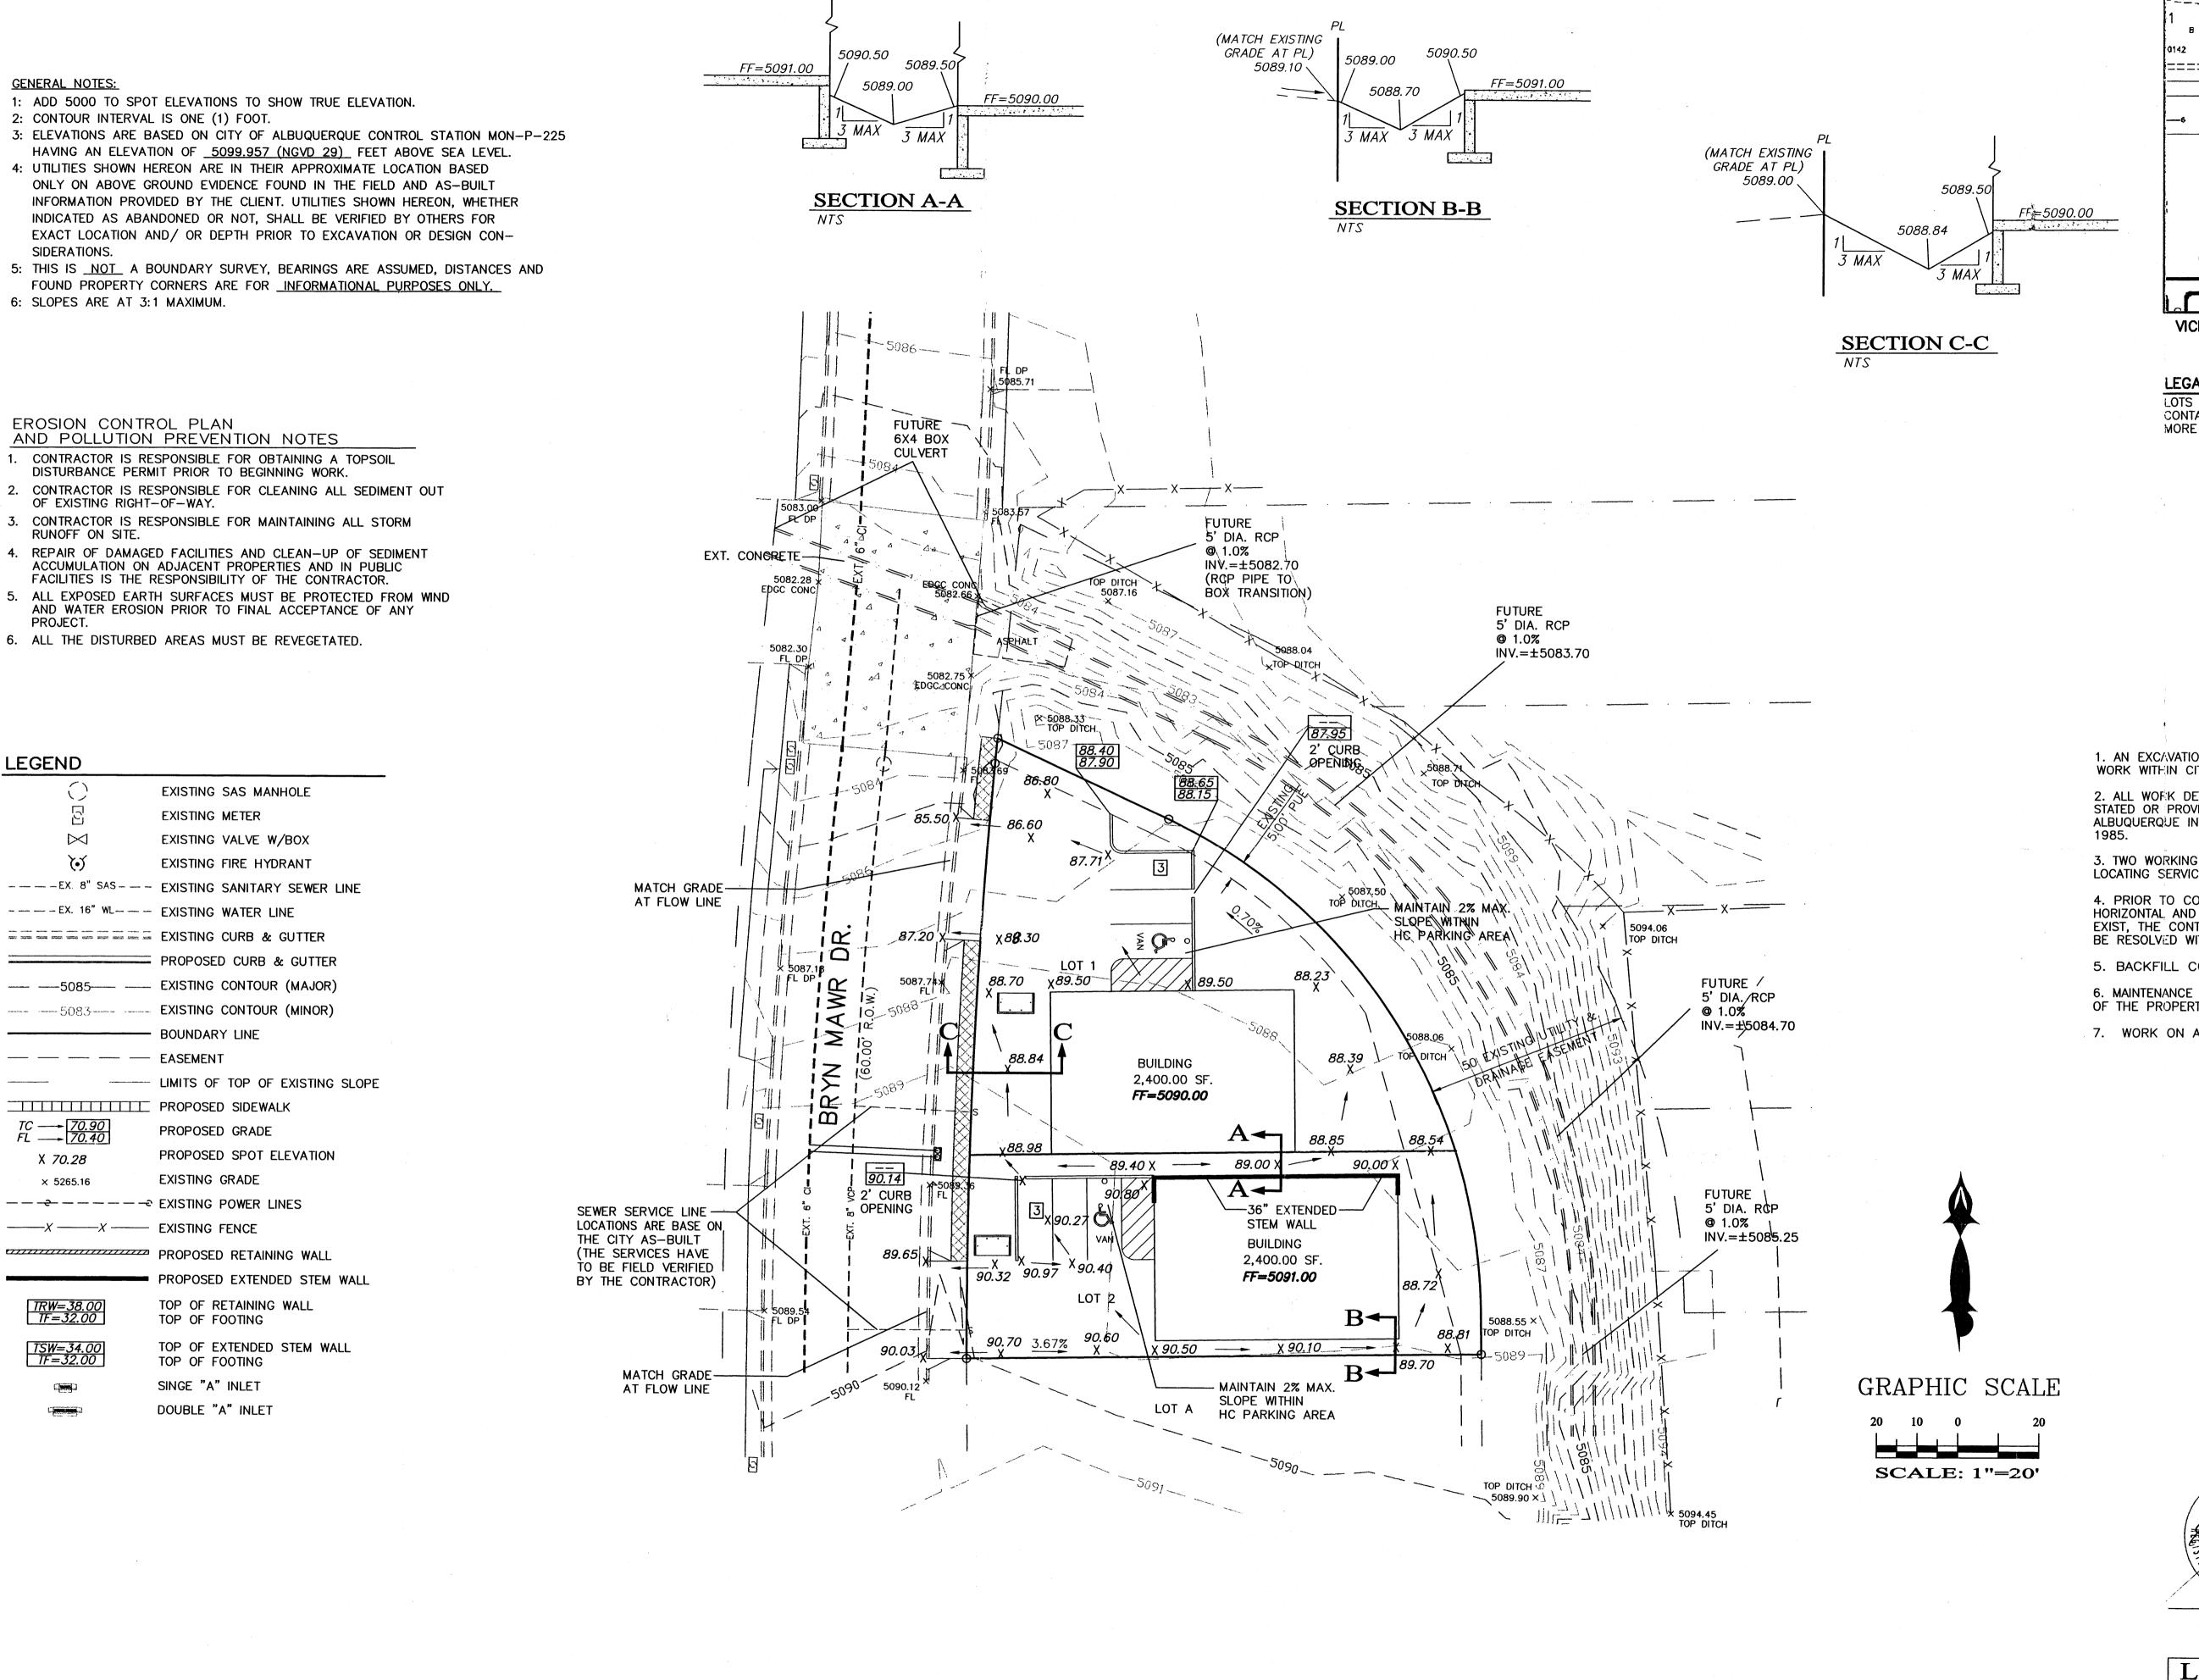

ROUGH GRADING APPROVAL

DATE

GENERAL NOTES:


RUNOFF ON SITE.

LEGEND

 \bowtie

X *70.28*

× 5265.16

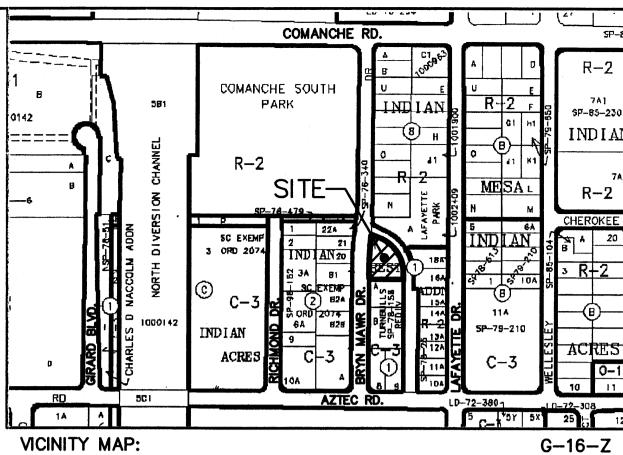

LEGAL DESCRIPTION:

LOTS 1 AND 2, BLOCK 1, INDIAN REST CONTAINING 14,271.00 SQUARE FEET (0.3276 ACRES) MORE OR LESS.

NOTICE TO CONTRACTORS

1. AN EXCAVATION/CONSTRUCTION PERMIT WILL BE REQUIRED BEFORE BEGINNING ANY WORK WITHIN CITY RIGHT-OF-WAY.

2. ALL WORK DETAILED ON THESE PLANS TO BE PERFORMED, EXCEPT AS OTHERWISE STATED OR PROVIDED HEREON, SHALL BE CONSTRUCTED IN ACCORDANCE WITH CITY OF ALBUQUERQUE INTERIM STANDARD SPECIFICATIONS FOR PUBLIC WORKS CONSTRUCTION.

3. TWO WORKING DAYS PRIOR TO ANY EXCAVATION, CONTRACTOR MUST CONTACT LINE LOCATING SERVICE, 765-1234, FOR LOCATION OF EXISTING UTILITIES.

- 4. PRIOR TO CONSTRUCTION, THE CONTRACTOR SHALL EXCAVATE AND VERIFY THE HORIZONTAL AND VERTICAL LOCATIONS OF ALL CONSTRUCTIONS. SHOULD A CONFLICT EXIST, THE CONTRACTOR SHALL NOTIFY THE ENGINEER SO THAT THE CONFLICT CAN BE RESOLVED WITH A MINIMUM AMOUNT OF DELAY.
- 5. BACKFILL COMPACTION SHALL BE ACCORDING TO TRAFFIC/STREET USE. 6. MAINTENANCE OF THESE FACILITIES SHALL BE THE RESPONSIBILITY OF THE OWNER OF THE PROPERTY SERVED.
- 7. WORK ON ARTERIAL STREETS SHALL BE PERFORMED ON A 24-HOUR BASIS.






SHAHAB BIAZAR P.E. #13479


LAST REVISION: 11-22-200

4416 ANAHEIM AVE., NE ALBUQUERQUE, NEW MEXICO 87113 (505)899-5570

LOTS 1 & 2, BLOCK 1, INDIAN REST GRADING AND DRAINAGE PLAN DRAWING: DRAWN BY: DATE:

200447-GR.DWG SHH 11-02-2004 1 OF 1

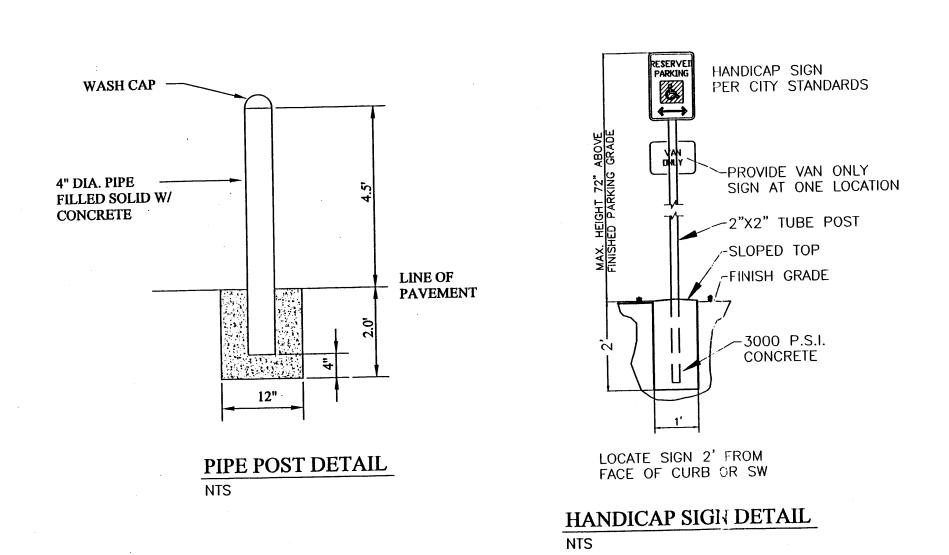

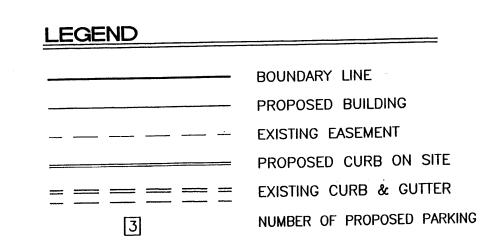



5.00'


RULE UP DUMPSTER ENCLOSURE DETAIL

CMU WALL

NTS

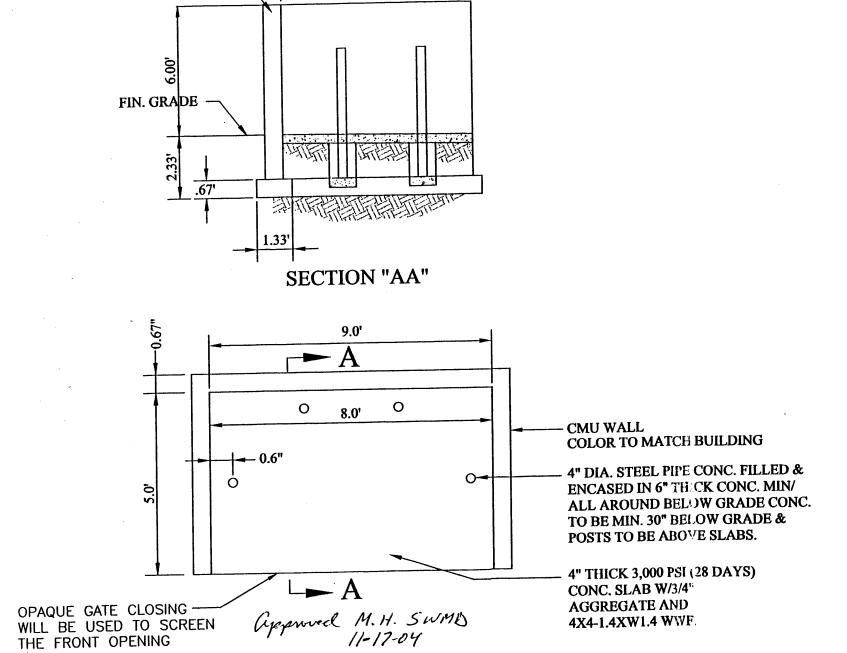


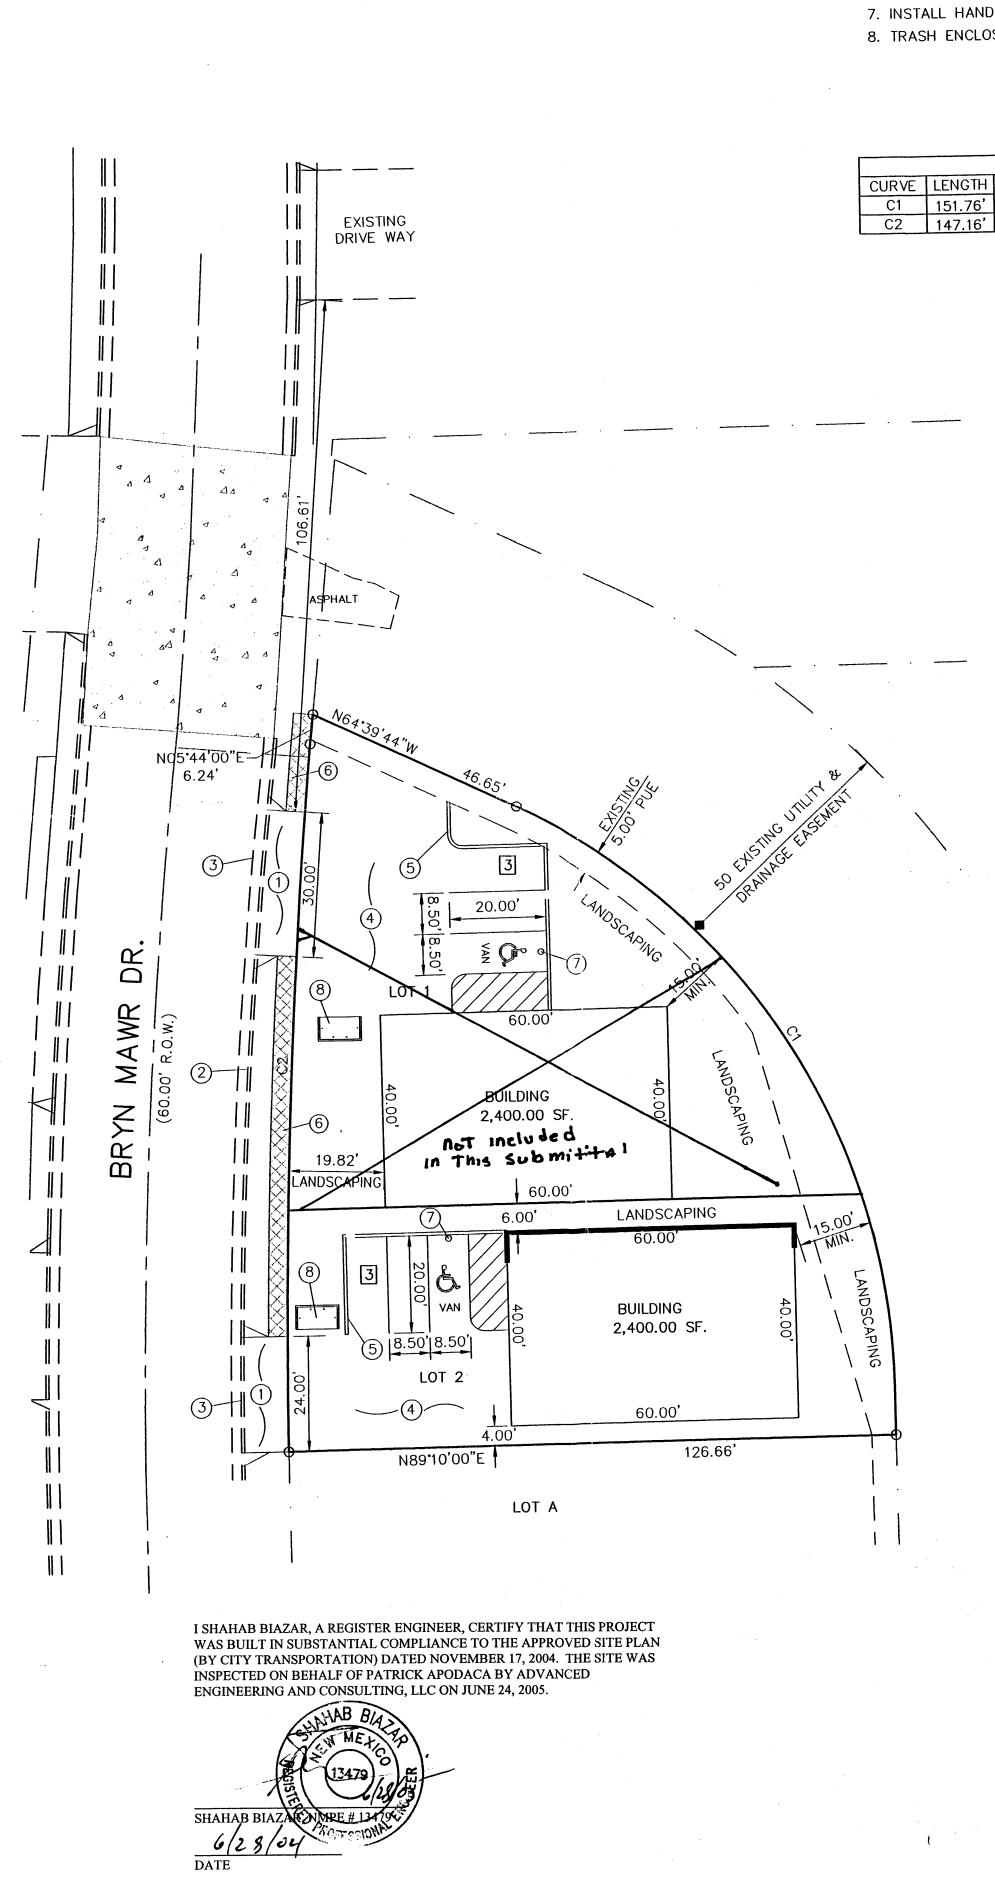

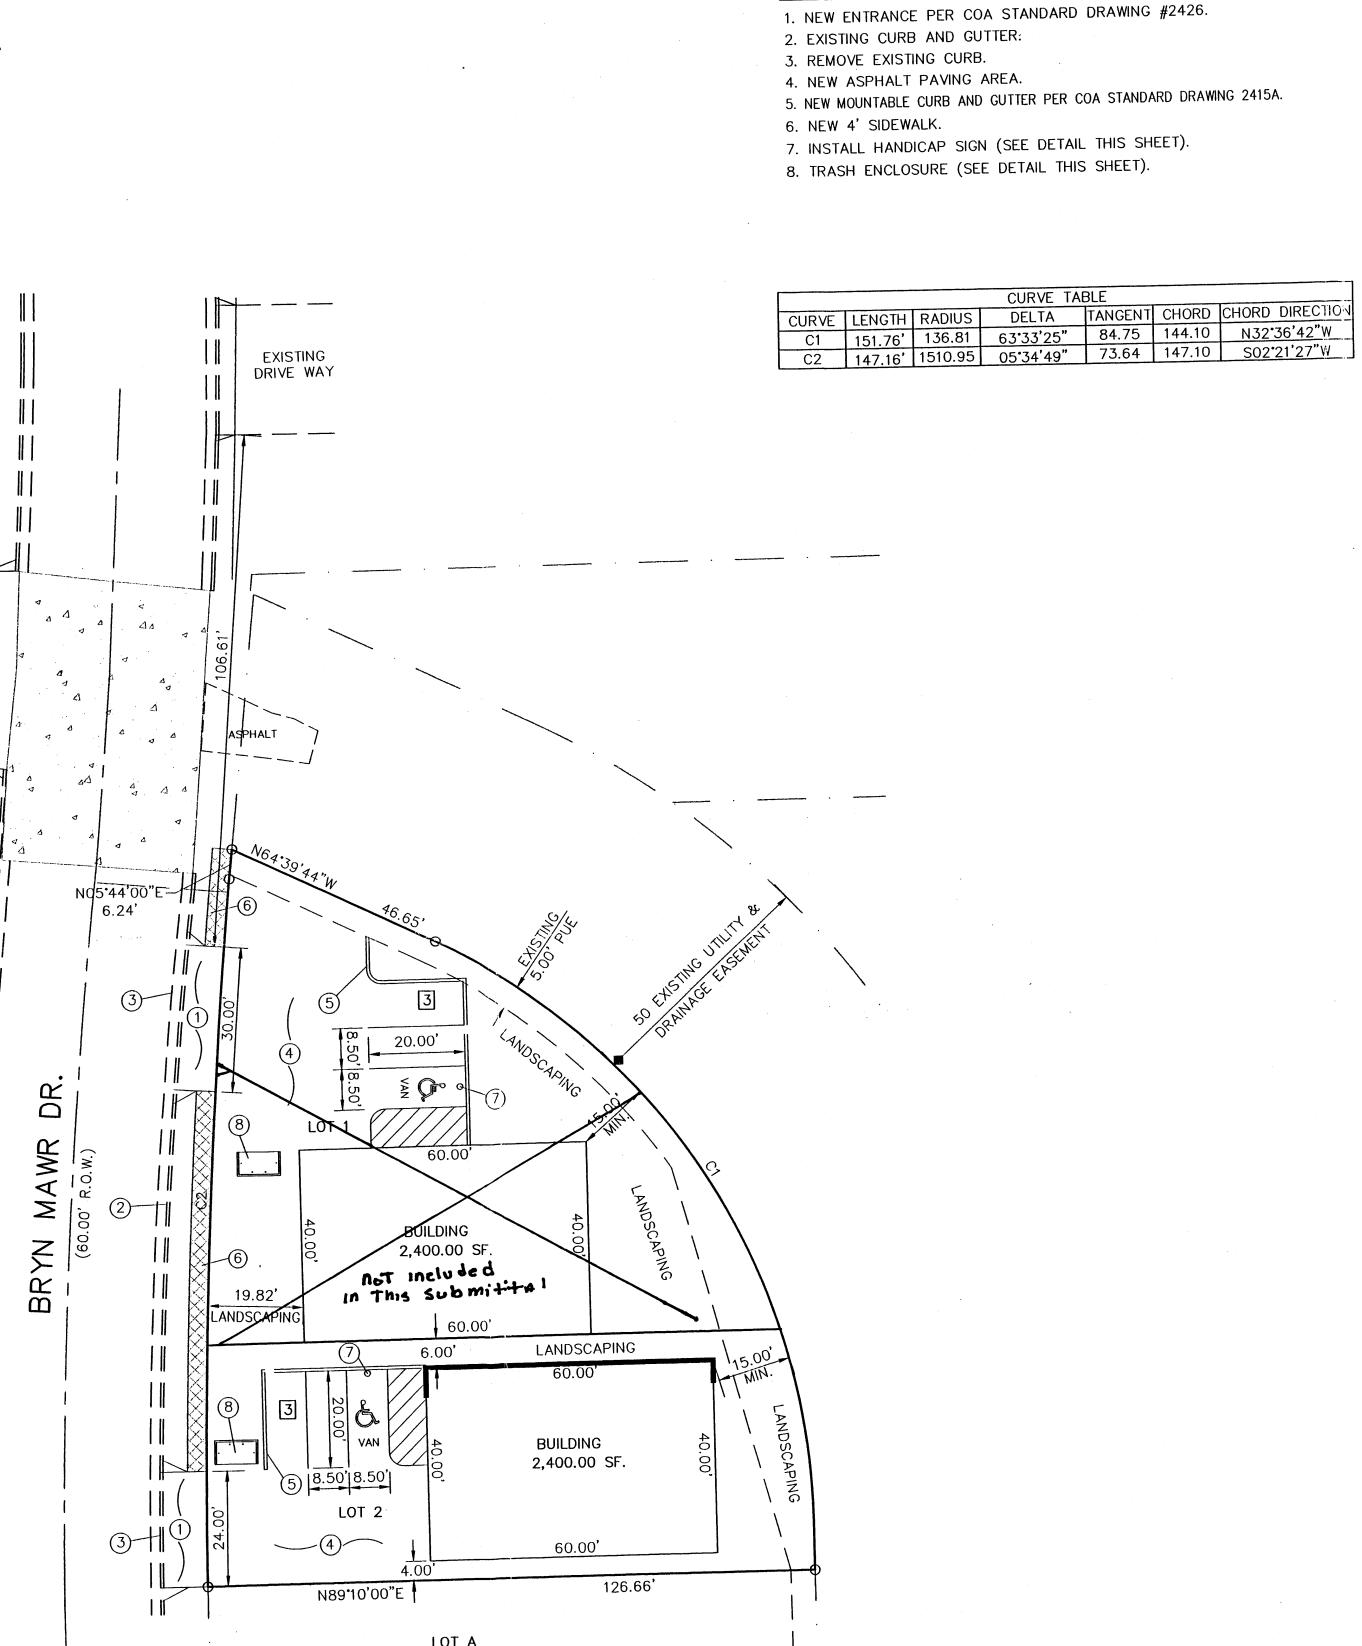


The Albert of the Line of the Albert Maria State of the Control of

O NOTES:

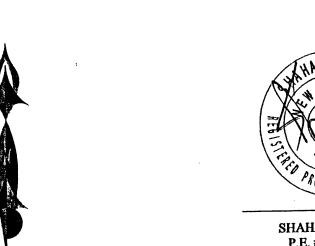

LAST REVISION: 11-16-200



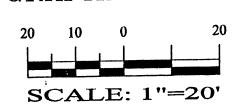



SHAHAB BIAZAR P.E. #13479

200447-ST.DWG

ENGINEERING and CONSULTING, LLC

4416 ANAHEIM AVE., NE ALBUQUERQUE, NEW MEXICO 87113 (505)899-5570

LOTS 1 & 2, BLOCK 1, INDIAN REST

10-28-2004

SITE PLAN DATE: DRAWN BY: DRAWING:

SHH

COMANCHE SOUTH

LOTS 1 AND 2, BLOCK 1, INDIAN REST, CONTAINING 14,271.00 SF. (0.3276 AC.)

WAREHOUSE

2,400.00 S.F.

5,639.60 SF ±

845.00 SF ±

WAREHOUSE

2,400.00 S.F.

3,831.40 SF ±

575.00 SF ±

8,039.60 SF. (0.1846 AC.)

2,400 GSF / 2000 GSF 1 SPACES

6,231.40 SF. (0.1431 AC.)

2,400 GSF / 2000 GSF 1 SPACES

IIN (PRE-ENGINEERED STEEL BUILDING,

W/ NON-COMBUSTABLE INTERIOR FRAMING

IIN (PRE-ENGINEERED STEEL BUILDING,

W/ NON-COMBUSTABLE INTERIOR FRAMING

3 SPACES

3 SPACES

1 SPACES (1 VAN)

1 SPACES (1 VAN)

1 SPACES (1 VAN)

1 SPACES (1 VAN)

VICINITY MAP:

ZONING: C-3

SITE DATA

PROPOSED USAGE:

GROSS BUILDING AREA:

LANDSCAPE CALCULATIONS:

LANDSCAPING REQUIRED: 15% OF 5,639 SF

PARKING CALCULATIONS

TOTAL PARKING PROVIDED:

HC PARKING REQUIRED:

HC PARKING PROVIDED:

GROSS BUILDING AREA:

LANDSCAPE CALCULATIONS

LANDSCAPING REQUIRED:

PARKING CALCULATIONS:

TOTAL PARKING PROVIDED:

HC PARKING REQUIRED:

HC PARKING PROVIDED:

PARKING REQUIRED:

WAREHOUSE:

CONSTRUCTION TYPE:

PROPOSED USAGE:

NET LOT AREA

15% OF 3,831 SF

PARKING REQUIRED:

WAREHOUSE:

LOT 2:

LOT AREA:

CONSTRUCTION TYPE:

NET LOT AREA

LOT 1:


LOT AREA:


LEGAL DESCRIPTION:

COMANCHE RD.

G-16-Z

1 OF

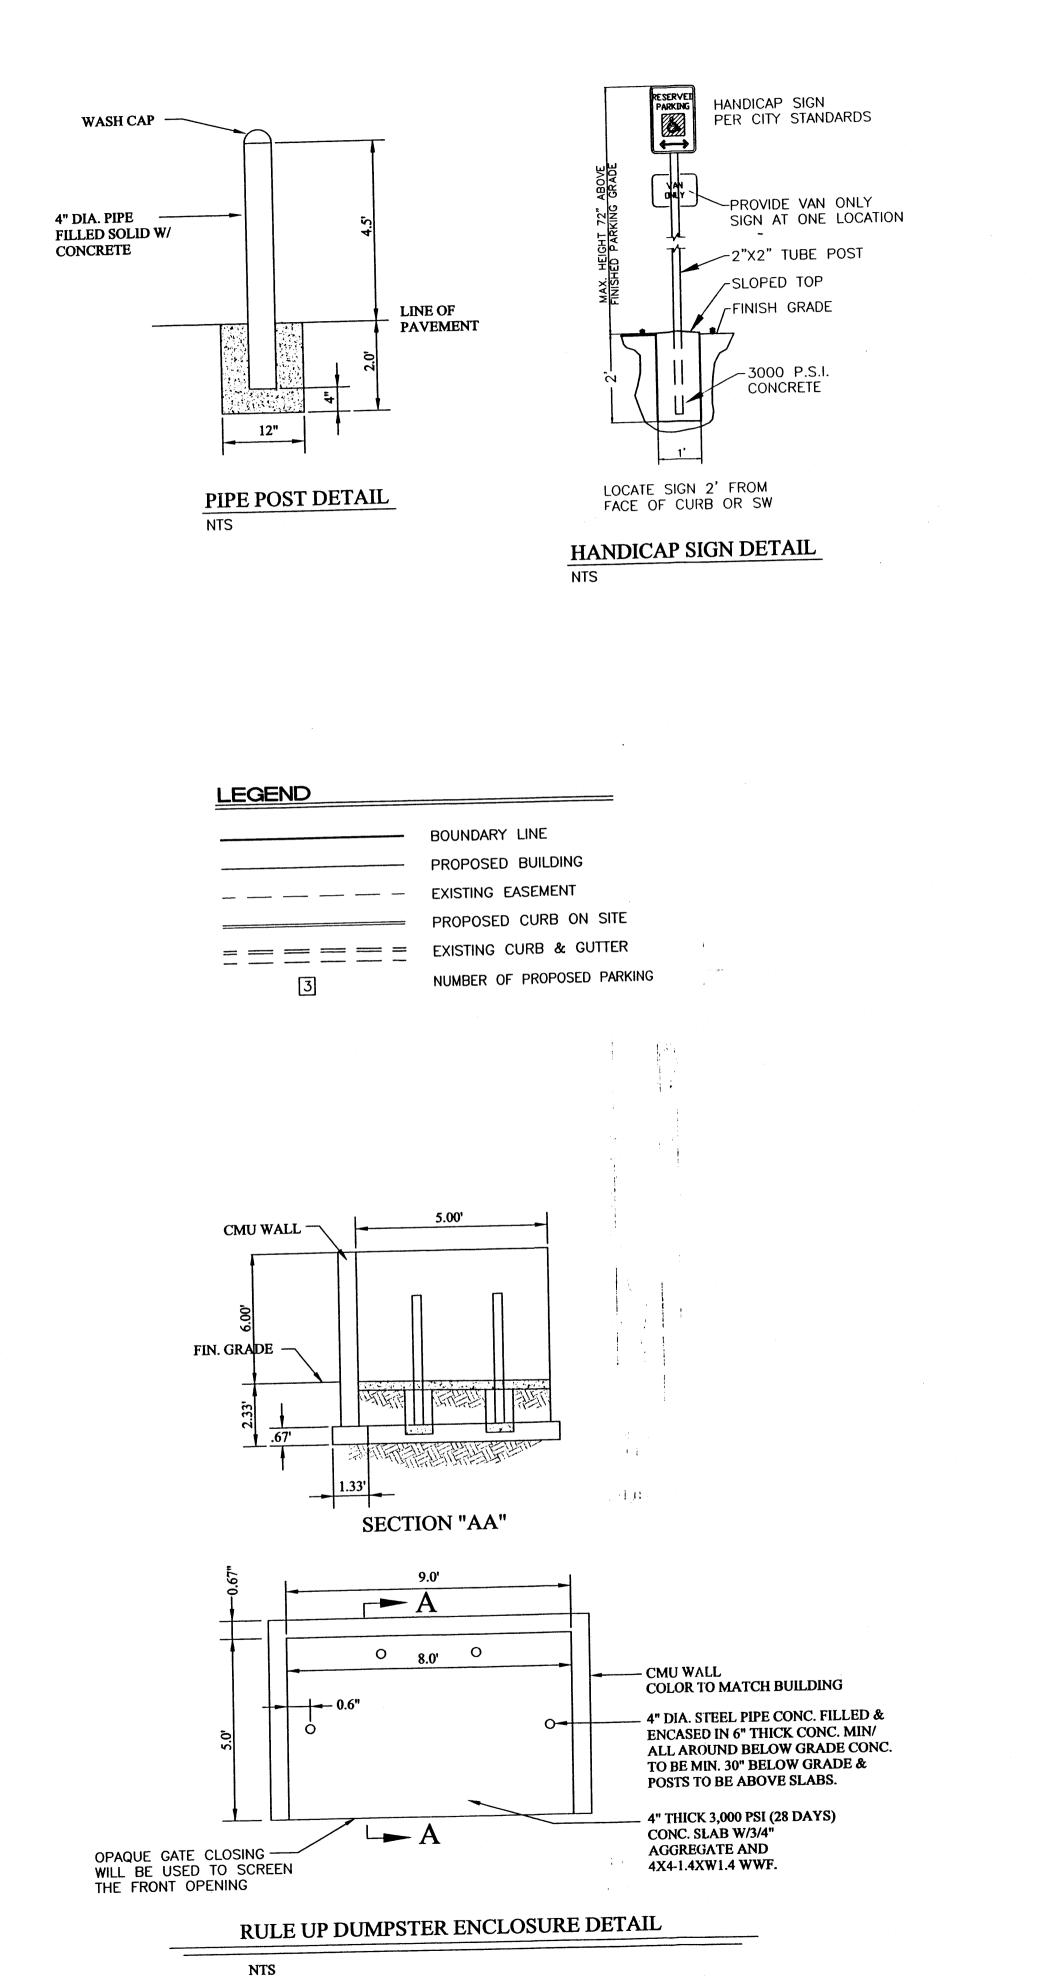

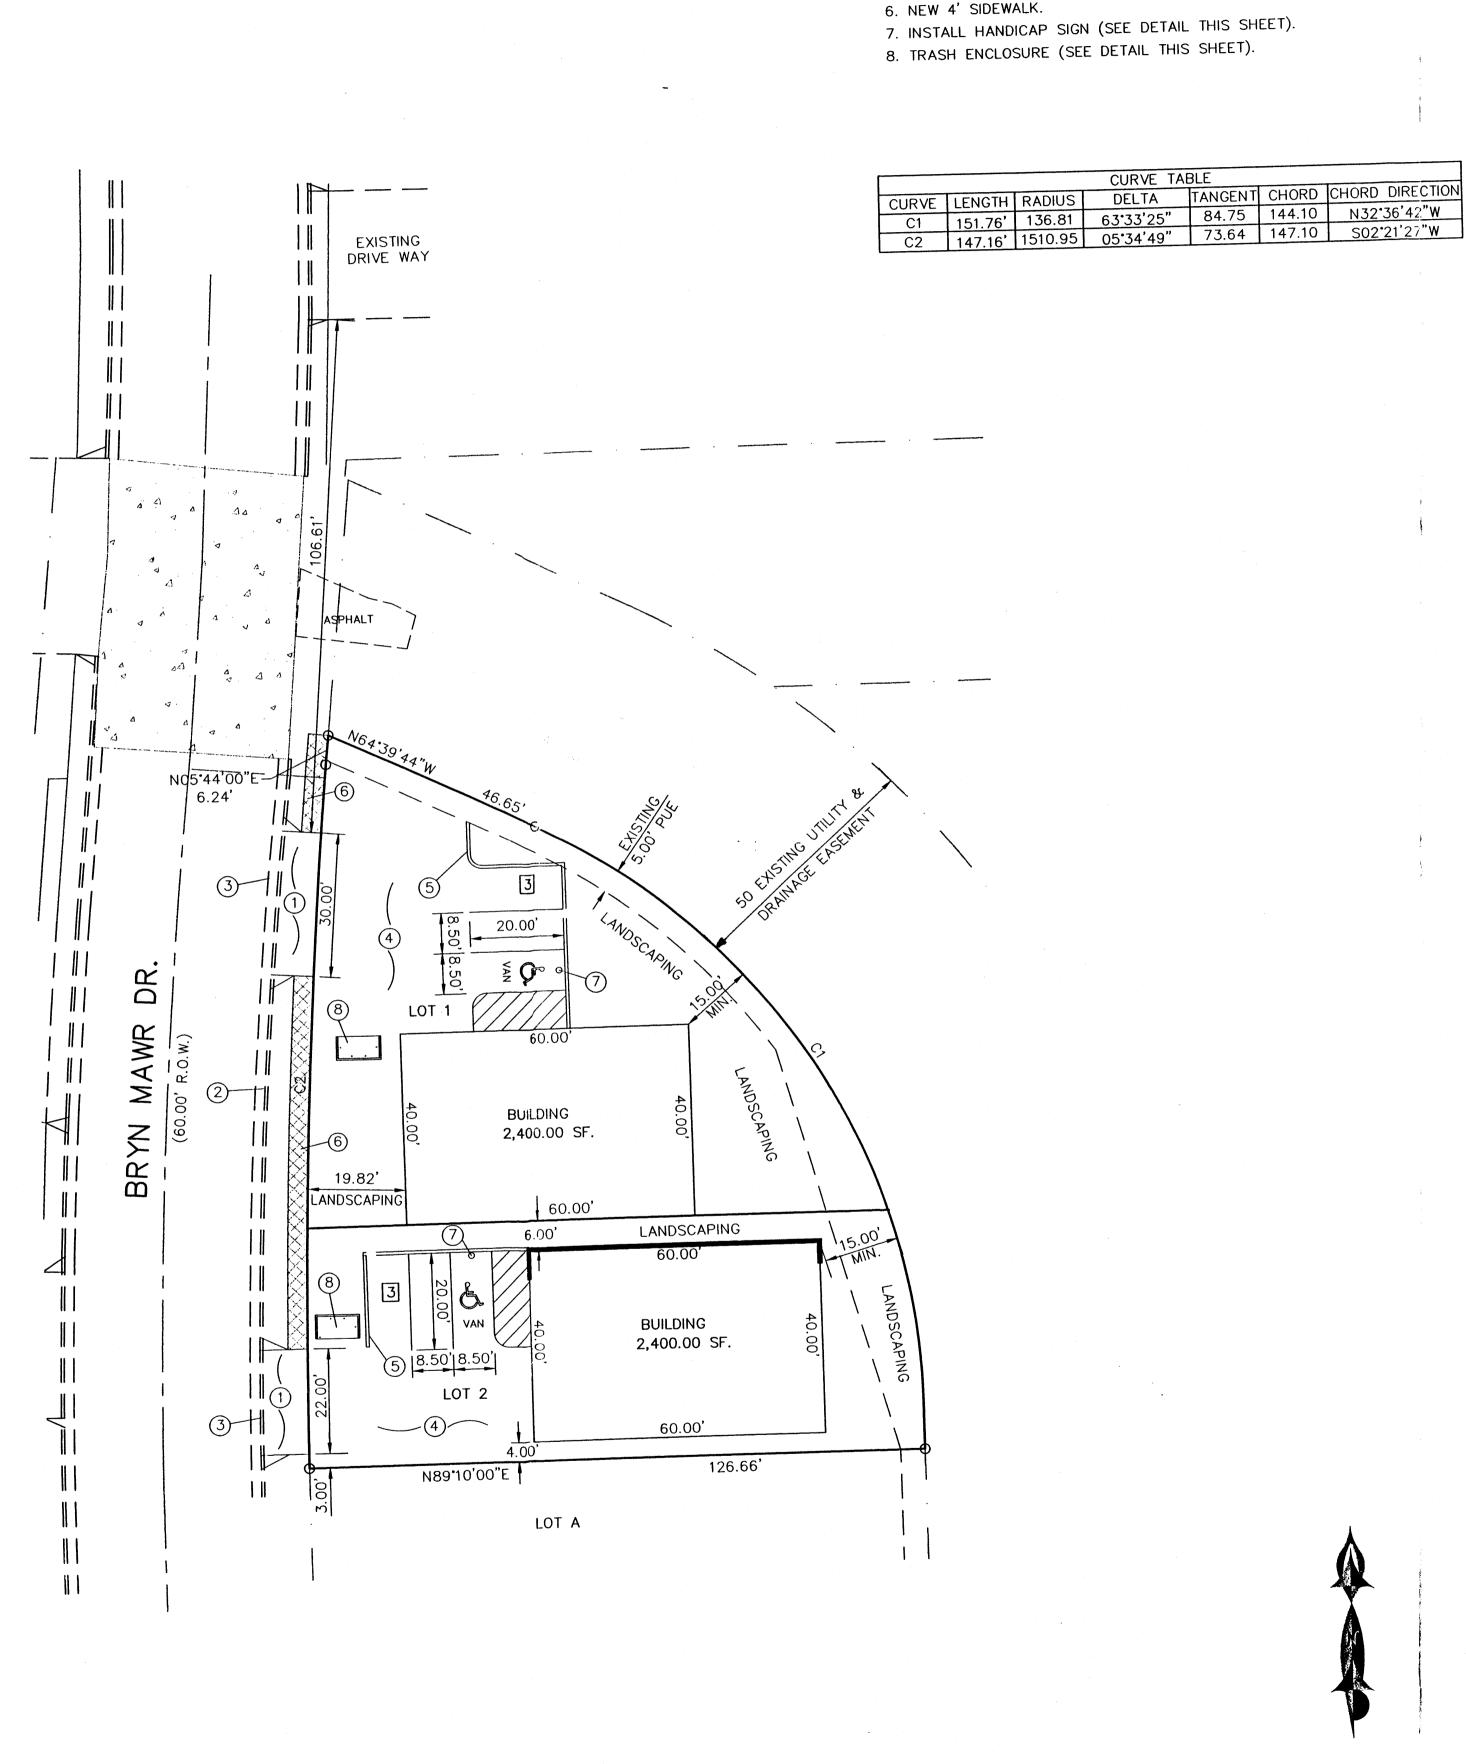

O NOTES:

2. EXISTING CURB AND GUTTER. 3. REMOVE EXISTING CURB.


4. NEW ASPHALT PAVING AREA.

1. NEW ENTRANCE PER COA STANDARD DRAWING #2426.

5. NEW MOUNTABLE CURB AND GUTTER PER COA STANDARD DRAWING 2415A.

CURVE TABLE

DELTA TANGENT CHORD CHORD DIRECTION

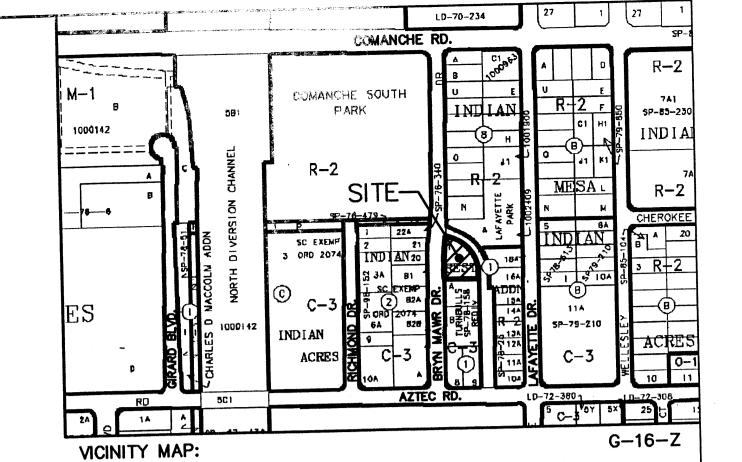

LEGAL DESCRIPTION:

LOTS 1 AND 2, BLOCK 1, INDIAN REST, CONTAINING 14,271.00 SF. (0.3276 AC.) ZONING: C-3

SITE DATA

PROPOSED USAGE: LOT AREA:

GROSS BUILDING AREA:

WAREHOUSE 8,039.60 SF. (0.1846 AC.)

2,400.00 S.F. IIN (PRE-ENGINEERED STEEL BUILDING, W/ NON-COMBUSTABLE INTERIOR FRAMING CONSTRUCTION TYPE:

LANDSCAPE CALCULATIONS: NET LOT AREA LANDSCAPING REQUIRED:

5,639.60 SF ± 845.00 SF ±

PARKING CALCULATIONS:

15% OF 5,639 SF

PARKING REQUIRED: WAREHOUSE:

2,400 GSF / 2000 GSF 1 SPACES

TOTAL PARKING PROVIDED:

1 SPACES (1 VAN) HC PARKING REQUIRED: 1 SPACES (1 VAN) HC PARKING PROVIDED:

PROPOSED USAGE:

LOT AREA:

WAREHOUSE 6,231.40 SF. (0.1431 AC.)

2,400.00 S.F.

GROSS BUILDING AREA: IIN (PRE-ENGINEERED STEEL BUILDING, CONSTRUCTION TYPE: W/ NON-COMBUSTABLE INTERIOR FRAMING

LANDSCAPE CALCULATIONS

3,831.40 SF ± 575.00 SF ±

NET LOT AREA

LANDSCAPING REQUIRED: 15% OF 3,831 SF

PARKING CALCULATIONS

PARKING REQUIRED:

WAREHOUSE:

2,400 GSF / 2000 GSF 3 SPACES

TOTAL PARKING PROVIDED: HC PARKING REQUIRED:


1 SPACES (1 VAN)


1 SPACES

3 SPACES

HC PARKING PROVIDED:

1 SPACES (1 VAN)

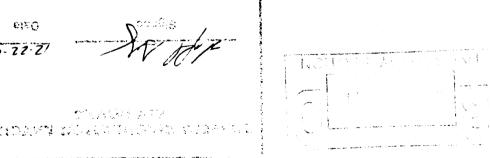

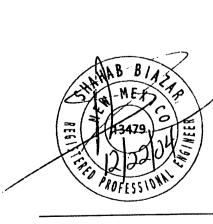

ADVANCED ENGINEERING and CONSULTING, LLC

SHAHAB BIAZAR P.E. #13479

4416 ANAHEIM AVE., NE ALBUQUERQUE, NEW MEXICO 87113 (505)899-5570

LOTS 1 & 2, BLOCK 1, INDIAN REST SITE PLAN

SHEET# DATE: DRAWN BY: DRAWING: 1 OF 1 10-28-2004 200447-ST.DWG SHH

GRAPHIC SCALE SCALE: 1"=20'

GENERAL NOTES: 1: ADD 5000 TO SPOT ELEVATIONS TO SHOW TRUE ELEVATION. 2: CONTOUR INTERVAL IS ONE (1) FOOT. 3: ELEVATIONS ARE BASED ON CITY OF ALBUQUERQUE CONTROL STATION MON-P-225 HAVING AN ELEVATION OF 5099.957 (NGVD 29) FEET ABOVE SEA LEVEL. 4: UTILITIES SHOWN HEREON ARE IN THEIR APPROXIMATE LOCATION BASED ONLY ON ABOVE GROUND EVIDENCE FOUND IN THE FIELD AND AS-BUILT INFORMATION PROVIDED BY THE CLIENT. UTILITIES SHOWN HEREON, WHETHER INDICATED AS ABANDONED OR NOT, SHALL BE VERIFIED BY OTHERS FOR EXACT LOCATION AND/ OR DEPTH PRIOR TO EXCAVATION OR DESIGN CON-5: THIS IS NOT A BOUNDARY SURVEY, BEARINGS ARE ASSUMED, DISTANCES AND FOUND PROPERTY CORNERS ARE FOR INFORMATIONAL PURPOSES ONLY. 6: SLOPES ARE AT 3:1 MAXIMUM. EROSION CONTROL PLAN AND POLLUTION PREVENTION NOTES 1. CONTRACTOR IS RESPONSIBLE FOR OBTAINING A TOPSOIL DISTURBANCE PERMIT PRIOR TO BEGINNING WORK. 2. CONTRACTOR IS RESPONSIBLE FOR CLEANING ALL SEDIMENT OUT OF EXISTING RIGHT-OF-WAY. 3. CONTRACTOR IS RESPONSIBLE FOR MAINTAINING ALL STORM RUNOFF ON SITE. 4. REPAIR OF DAMAGED FACILITIES AND CLEAN-UP OF SEDIMENT ACCUMULATION ON ADJACENT PROPERTIES AND IN PUBLIC FACILITIES IS THE RESPONSIBILITY OF THE CONTRACTOR. 5. ALL EXPOSED EARTH SURFACES MUST BE PROTECTED FROM WIND AND WATER EROSION PRIOR TO FINAL ACCEPTANCE OF ANY 6. ALL THE DISTURBED AREAS MUST BE REVEGETATED. LEGEND EXISTING SAS MANHOLE EXISTING METER EXISTING VALVE W/BOX EXISTING FIRE HYDRANT ____EX. 8" SAS _ _ _ EXISTING SANITARY SEWER LINE ----EX. 16" WL--- EXISTING WATER LINE THE ARTS STORE STO PROPOSED CURB & GUTTER ____ 5085___ EXISTING CONTOUR (MAJOR) EXISTING CONTOUR (MINOR) BOUNDARY LINE ___ EASEMENT LIMITS OF TOP OF EXISTING SLOPE PROPOSED SIDEWALK

PROPOSED GRADE PROPOSED SPOT ELEVATION X 70.28 EXISTING GRADE × 5265.16 ____ EXISTING POWER LINES _____X ____X ____ EXISTING FENCE PROPOSED RETAINING WALL

PROPOSED EXTENDED STEM WALL

TOP OF RETAINING WALL TOP OF FOOTING


TOP OF EXTENDED STEM WALL TOP OF FOOTING


SINGE "A" INLET DOUBLE "A" INLET


I SHAHAB BIAZAR, NMPE, OF THE ADVANCED ENGINEERING, LLC HEREBY CERTIFY THAT PROJECT HAS BEEN GRADED AND WILL DRAIN IN SUBSTANTIAL COMPLIANCE WITH AND IN ACCORDANCE WITH THE DESIGN INTENT OF THE APPROVED PLAN DATED 11-22-04. THE RECORD INFORMATION EDITED ONTO THE ORIGINAL DESIGN DOCUMENT HAS BEEN OBTAINED BY ME OR UNDER MY DIRECT SUPERVISION AND IS TRUE AND CORRECT TO THE BEST OF MY KNOWLEDGE AND BELIEF.


SHAHAB BIAZAR, NMPE # 13479 DATE 6/28/05




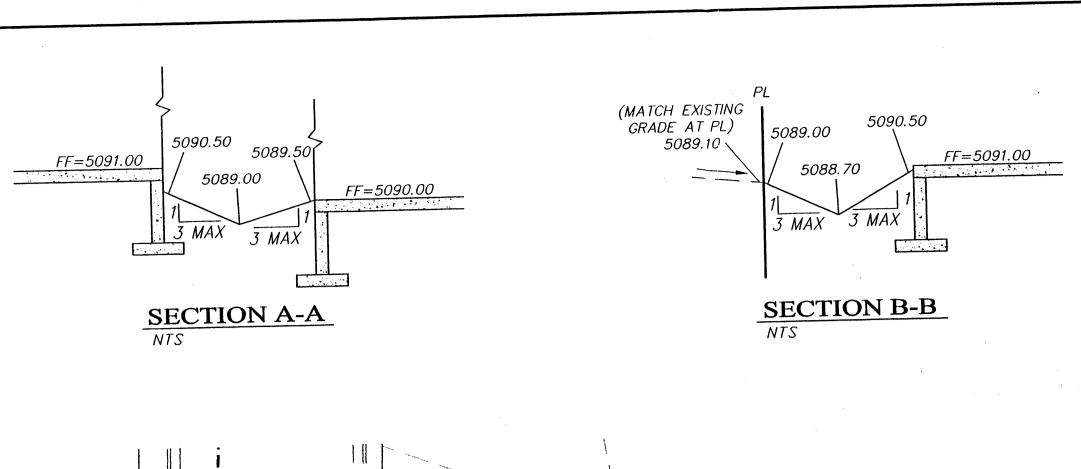


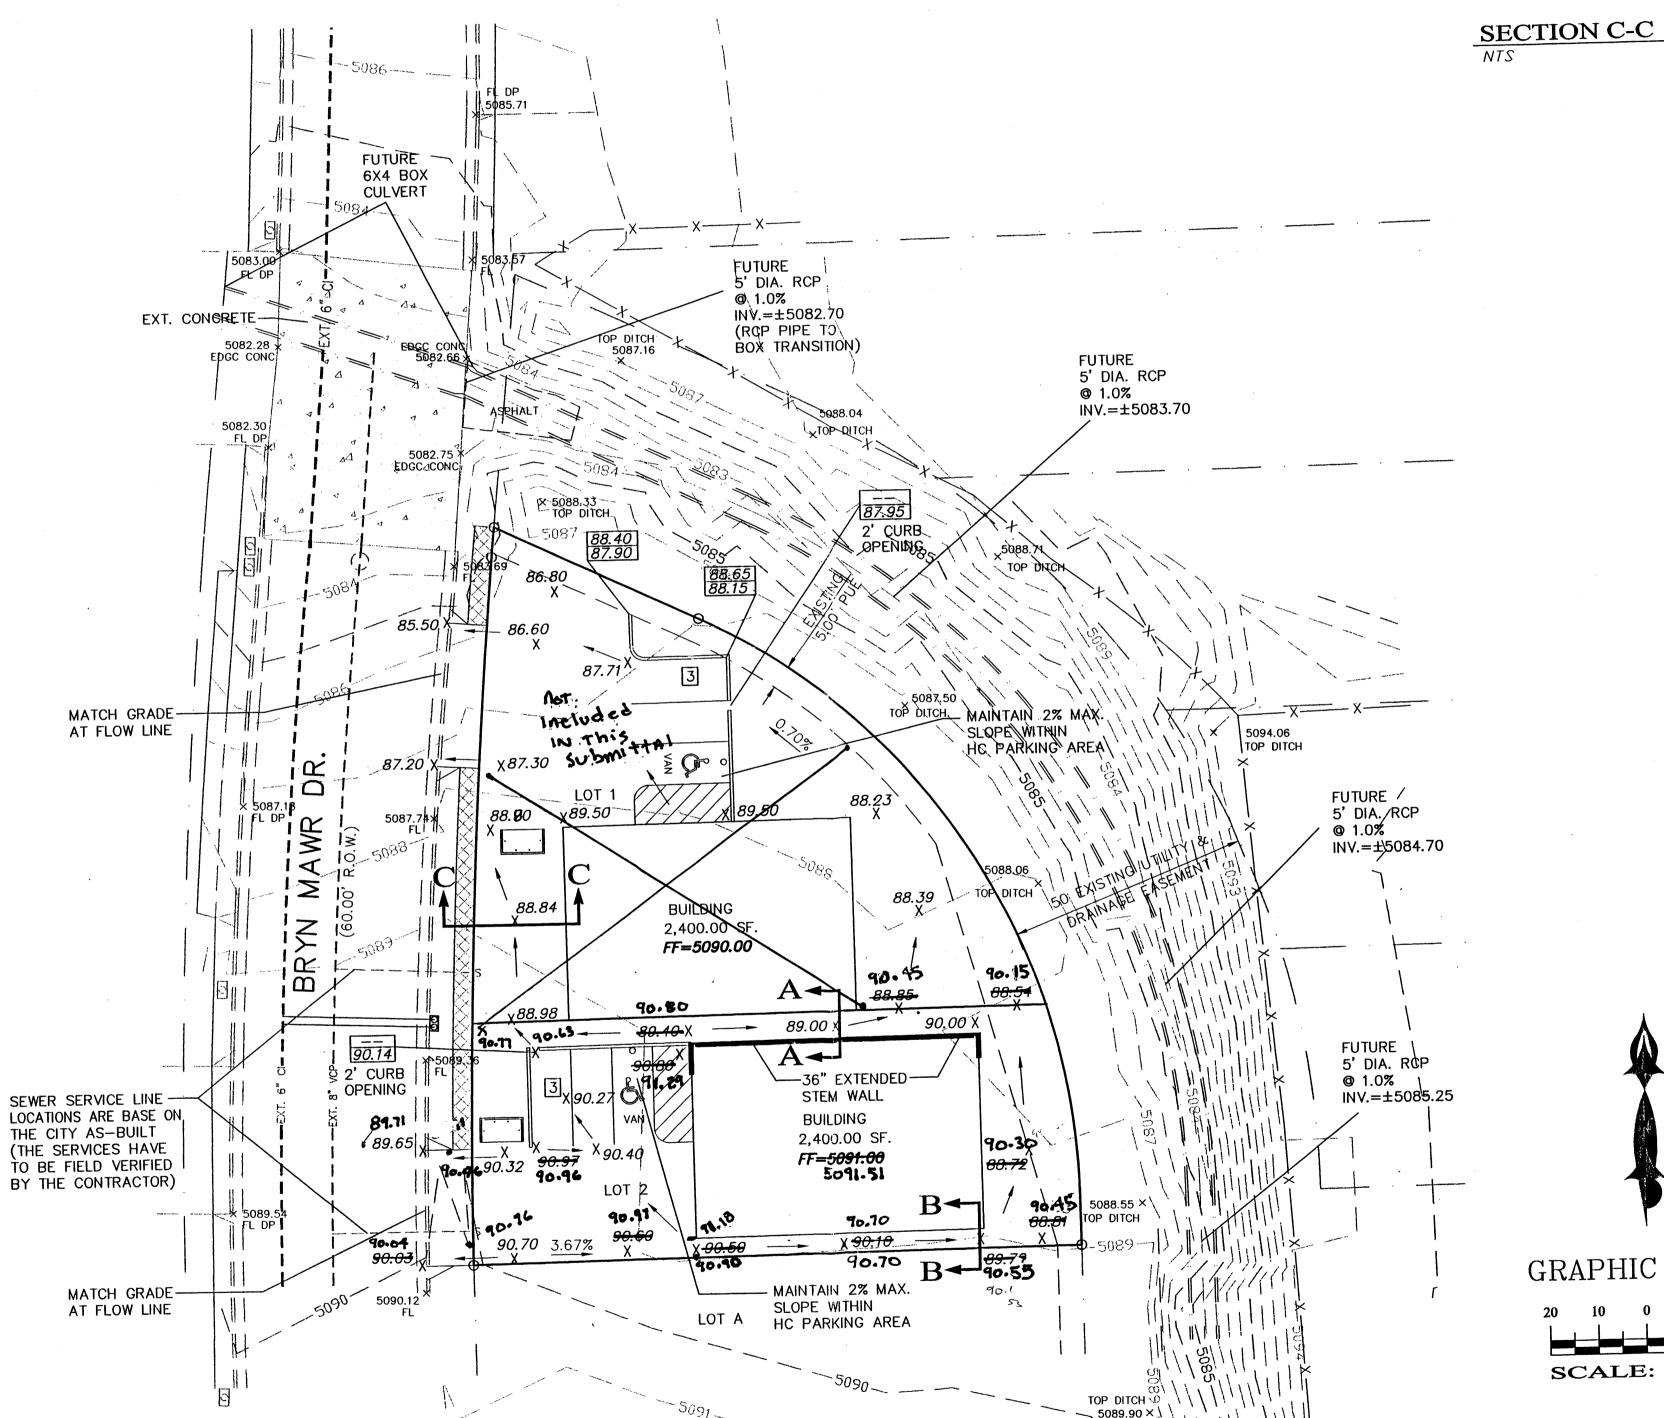

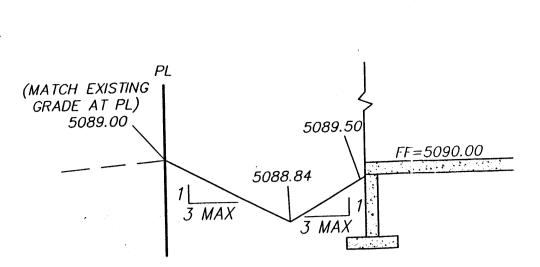

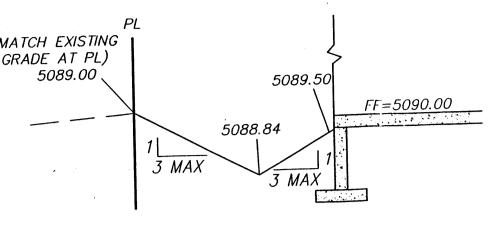

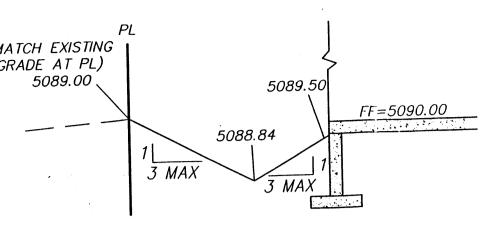

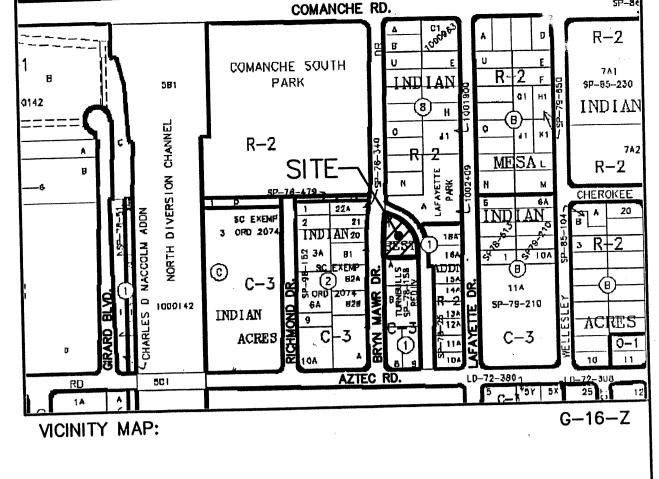

LEGAL DESCRIPTION:

LOTS 1 AND 2, BLOCK 1, INDIAN REST CONTAINING 14,271.00 SQUARE FEET (0.3276 ACRES) MORE OR LESS.

NOTICE TO CONTRACTORS

1. AN EXCAVATION/CONSTRUCTION PERMIT WILL BE REQUIRED BEFORE BEGINNING ANY WORK WITHIN CITY RIGHT-OF-WAY.

2. ALL WORK DETAILED ON THESE PLANS TO BE PERFORMED, EXCEPT AS OTHERWISE STATED OR PROVIDED HEREON, SHALL BE CONSTRUCTED IN ACCORDANCE WITH CITY OF ALBUQUERQUE INTERIM STANDARD SPECIFICATIONS FOR PUBLIC WORKS CONSTRUCTION,

3. TWO WORKING DAYS PRIOR TO ANY EXCAVATION, CONTRACTOR MUST CONTACT LINE LOCATING SERVICE, 765-1234, FOR LOCATION OF EXISTING UTILITIES.

4. PRIOR TO CONSTRUCTION, THE CONTRACTOR SHALL EXCAVATE AND VERIFY THE HORIZONTAL AND VERTICAL LOCATIONS OF ALL CONSTRUCTIONS. SHOULD A CONFLICT EXIST, THE CONTRACTOR SHALL NOTIFY THE ENGINEER SO THAT THE CONFLICT CAN BE RESOLVED WITH A MINIMUM AMOUNT OF DELAY.

5. BACKFILL COMPACTION SHALL BE ACCORDING TO TRAFFIC/STREET USE. 6. MAINTENANCE OF THESE FACILITIES SHALL BE THE RESPONSIBILITY OF THE OWNER

OF THE PROPERTY SERVED. 7. WORK ON ARTERIAL STREETS SHALL BE PERFORMED ON A 24-HOUR BASIS.



GRAPHIC SCALE SCALE: 1"==20'





SHAHAB BIAZAR P.E. #13479

4416 ANAHEIM AVE., NE ALBUQUERQUE, NEW MEXICO 87113

LOTS 1 & 2, BLOCK 1, INDIAN REST GRADING AND DRAINAGE PLAN DRAWN BY: DRAWING:


11-02-2004 SHH 200447-GR.DWG


JUL 0 7 2005


1 OF 1

ROUGH GRADING APPROVAL


DATE

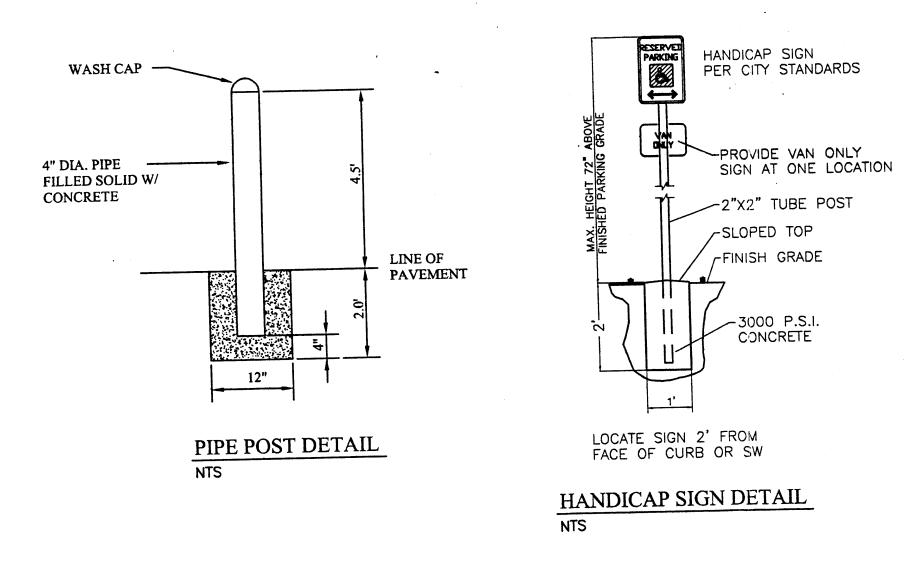


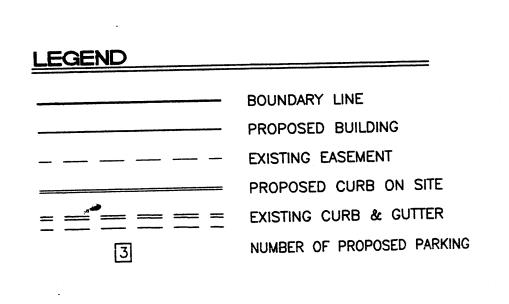

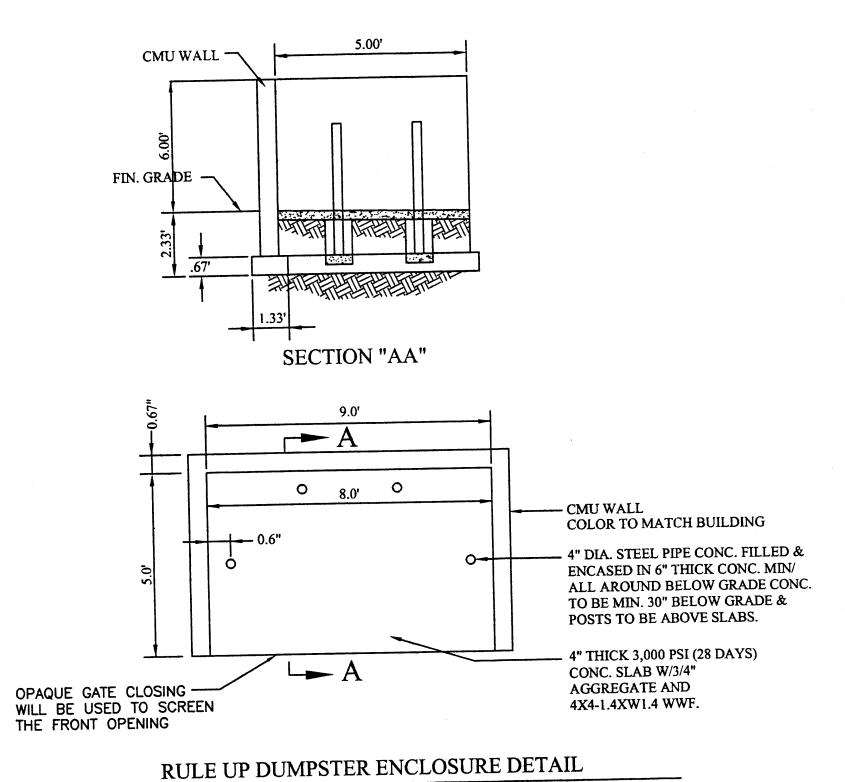

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O NOTES:

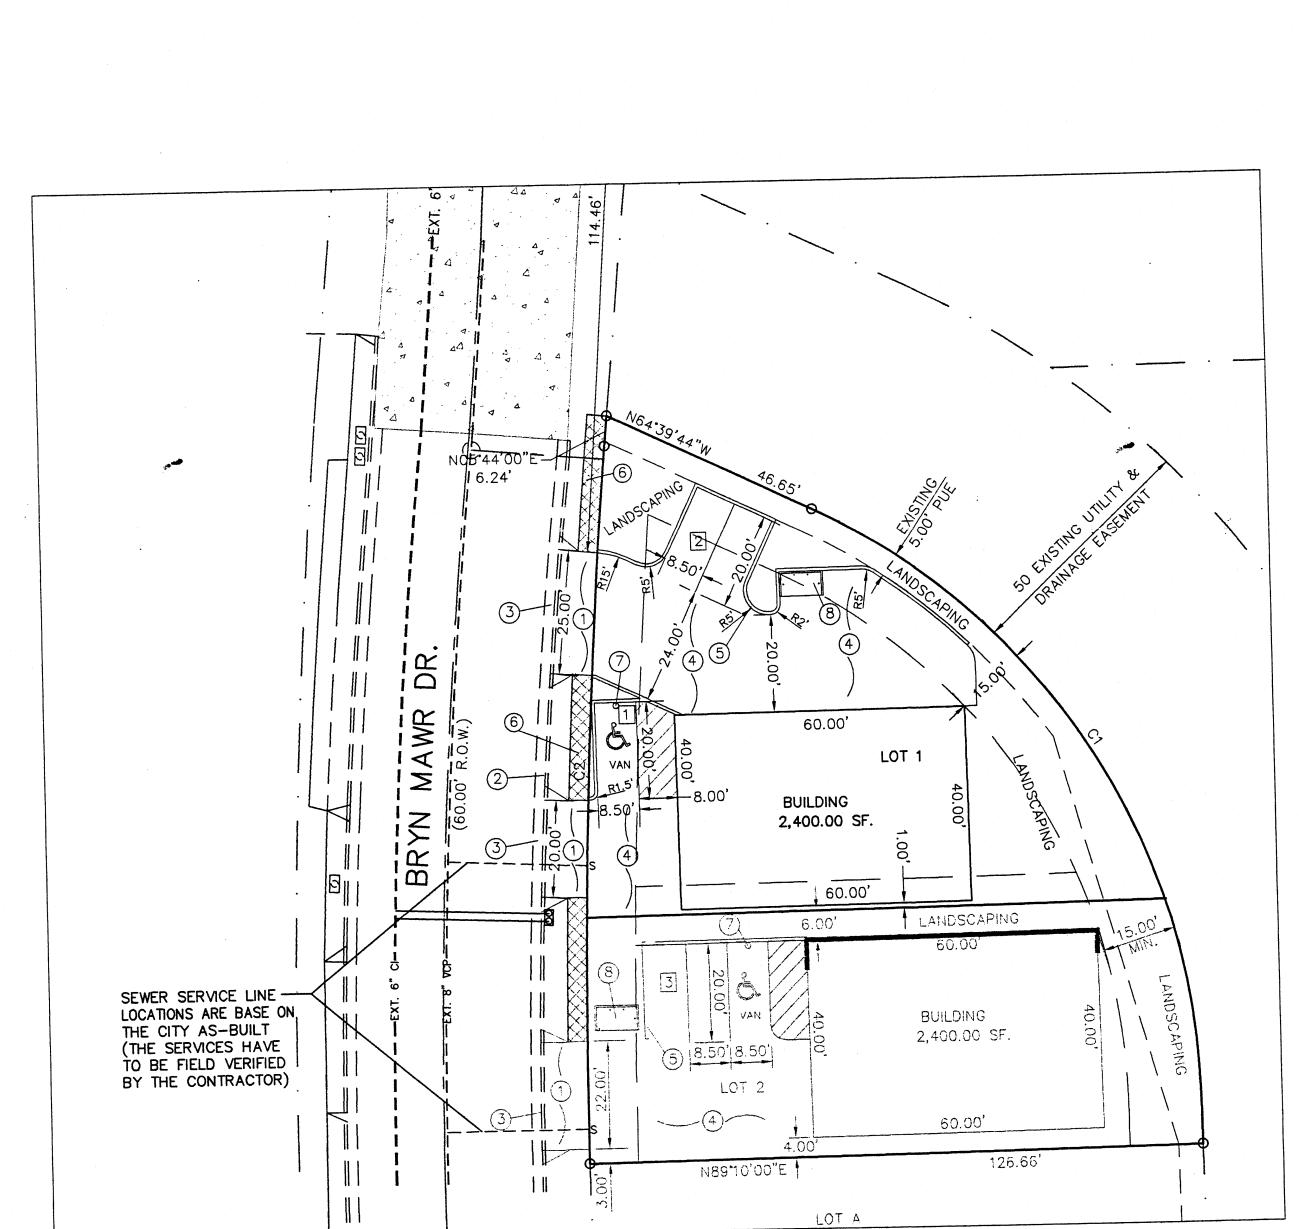2. EXISTING CURB AND GUTTER.

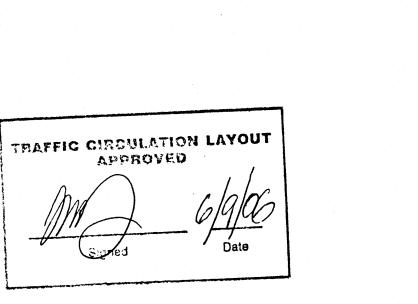4. NEW ASPHALT PAVING AREA.

3. REMOVE EXISTING CURB.

6. NEW 4' SIDEWALK.

1. NEW ENTRANCE PER COA STANDARD DRAWING #2426.

7. INSTALL HANDICAP SIGN (SEE DETAIL THIS SHEET).

8. TRASH ENCLOSURE (SEE DETAIL THIS SHEET).


5. NEW MOUNTABLE CURB AND GUTTER PER COA STANDARD DRAWING 2415A.


CURVE TABLE


 CURVE
 LENGTH
 RADIUS
 DELTA
 TANGENT
 CHORD
 CHORD DIRECTION

 C1
 151.76'
 136.81
 63'33'25"
 84.75
 144.10
 N32'36'42"W

 C2
 147.16'
 1510.95
 05'34'49"
 73.64
 147.10
 S02'21'27"W

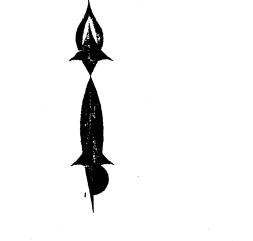

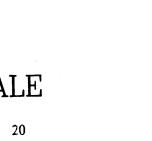

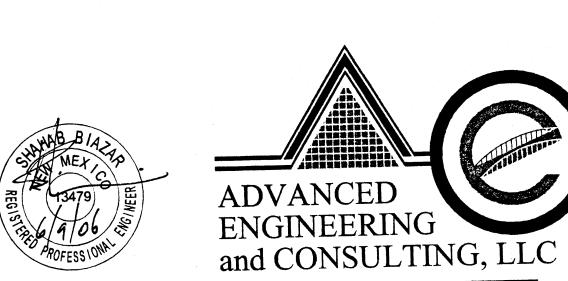

COMANCHE RD.

G-16-Z

COMANCHE SOUTH

LEGAL DESCRIPTION:

LOTS 1, BLOCK 1, INDIAN REST, CONTAINING 14,271.00 SF. (0.3276 AC.)

WAREHOUSE

2,400.00 S.F.

5,639.60 SF ±

2527.00 SF ±

845.00 SF ±

8,039.60 SF. (0.1846 AC.)

2,400 GSF / 2000 GSF 1 SPACES

IIN (PRE-ENGINEERED STEEL BUILDING, W/ NON-COMBUSTABLE INTERIOR FRAMING

3 SPACES

1 SPACES (1 VAN)

1 SPACES (1 VAN)

DATE

VICINITY MAP:

ZONING: C-3

SITE DATA

PROPOSED USAGE:

NET LOT AREA

GROSS BUILDING AREA:

LANDSCAPE CALCULATIONS:

LANDSCAPING REQUIRED: 15% OF 5,639 SF

LANDSCAPING REQUIRED:

PARKING CALCULATIONS

TOTAL PARKING PROVIDED:

HC PARKING REQUIRED:

HC PARKING PROVIDED:

TRAFFIC ENGINEERING, TRANSPORTATION DIVISION

SHAHAB BIAZAR P.E. #13479

PARKING REQUIRED:

WAREHOUSE:

SOLID WASTE MANAGEMENT

CONSTRUCTION TYPE:

LOT 1:

LOT AREA:

4416 ANAHEIM AVE., NE ALBUQUERQUE, NEW MEXICO 87113 (505)899-5570

LOT 1, BLOCK 1, INDIAN REST

SITE PLAN SHEET# DATE: DRAWN BY: DRAWING: 1 OF 1 06-07-2006 200641-ST.DWG

GRAPHIC SCALE

SCALE: 1"=20'



- 1: ADD 5000 TO SPOT ELEVATIONS TO SHOW TRUE ELEVATION.
- 2: CONTOUR INTERVAL IS ONE (1) FOOT.
- 3: ELEVATIONS ARE BASED ON CITY OF ALBUQUERQUE CONTROL STATION MON-P-225 HAVING AN ELEVATION OF _5099.957 (NGVD 29) FEET ABOVE SEA LEVEL.
- 4: UTILITIES SHOWN HEREON ARE IN THEIR APPROXIMATE LOCATION BASED ONLY ON ABOVE GROUND EVIDENCE FOUND IN THE FIELD AND AS-BUILT INFORMATION PROVIDED BY THE CLIENT. UTILITIES SHOWN HEREON, WHETHER INDICATED AS ABANDONED OR NOT, SHALL BE VERIFIED BY OTHERS FOR EXACT LOCATION AND/ OR DEPTH PRIOR TO EXCAVATION OR DESIGN CON-SIDERATIONS.
- 5: THIS IS NOT A BOUNDARY SURVEY, BEARINGS ARE ASSUMED, DISTANCES AND FOUND PROPERTY CORNERS ARE FOR INFORMATIONAL PURPOSES ONLY.
- 6: SLOPES ARE AT 3:1 MAXIMUM.


FF=5091.51 **SECTION A-A**


EROSION CONTROL PLAN AND POLLUTION PREVENTION NOTES


- 1. CONTRACTOR IS RESPONSIBLE FOR OBTAINING A TOPSOIL DISTURBANCE PERMIT PRIOR TO BEGINNING WORK.
- 2. CONTRACTOR IS RESPONSIBLE FOR CLEANING ALL SEDIMENT OUT
- OF EXISTING RIGHT-OF-WAY.
- 3. CONTRACTOR IS RESPONSIBLE FOR MAINTAINING ALL STORM RUNOFF ON SITE.
- 4. REPAIR OF DAMAGED FACILITIES AND CLEAN-UP OF SEDIMENT ACCUMULATION ON ADJACENT PROPERTIES AND IN PUBLIC FACILITIES IS THE RESPONSIBILITY OF THE CONTRACTOR.
- 5. ALL EXPOSED EARTH SURFACES MUST BE PROTECTED FROM WIND AND WATER EROSION PRIOR TO FINAL ACCEPTANCE OF ANY
- 6. ALL THE DISTURBED AREAS MUST BE REVEGETATED.

LEGEND	
	EXISTING SAS MANHOLE
	EXISTING METER
\bowtie	EXISTING VALVE W/BOX
(•)	EXISTING FIRE HYDRANT
EX. 8" SAS	EXISTING SANITARY SEWER LINE
- — — – EX. 16" WL— — —	EXISTING WATER LINE
	EXISTING CURB & GUTTER
	PROPOSED CURB & GUTTER
	EXISTING CONTOUR (MAJOR)
	EXISTING CONTOUR (MINOR)
	BOUNDARY LINE
	EASEMENT
	LIMITS OF TOP OF EXISTING SLOPE
	PROPOSED SIDEWALK
TC 70.90 FL 70.40	PROPOSED GRADE
X 70.28	PROPOSED SPOT ELEVATION
× 5265.16	EXISTING GRADE
=======================================	EXISTING POWER LINES
——————————————————————————————————————	EXISTING FENCE
	PROPOSED RETAINING WALL
	PROPOSED EXTENDED STEM WALL
$\begin{array}{c} TRW = 38.00 \\ TF = 32.00 \end{array}$	TOP OF RETAINING WALL TOP OF FOOTING
TSW=34.00 TF=32.00	TOP OF EXTENDED STEM WALL TOP OF FOOTING
	SINGE "A" INLET

DOUBLE "A" INLET

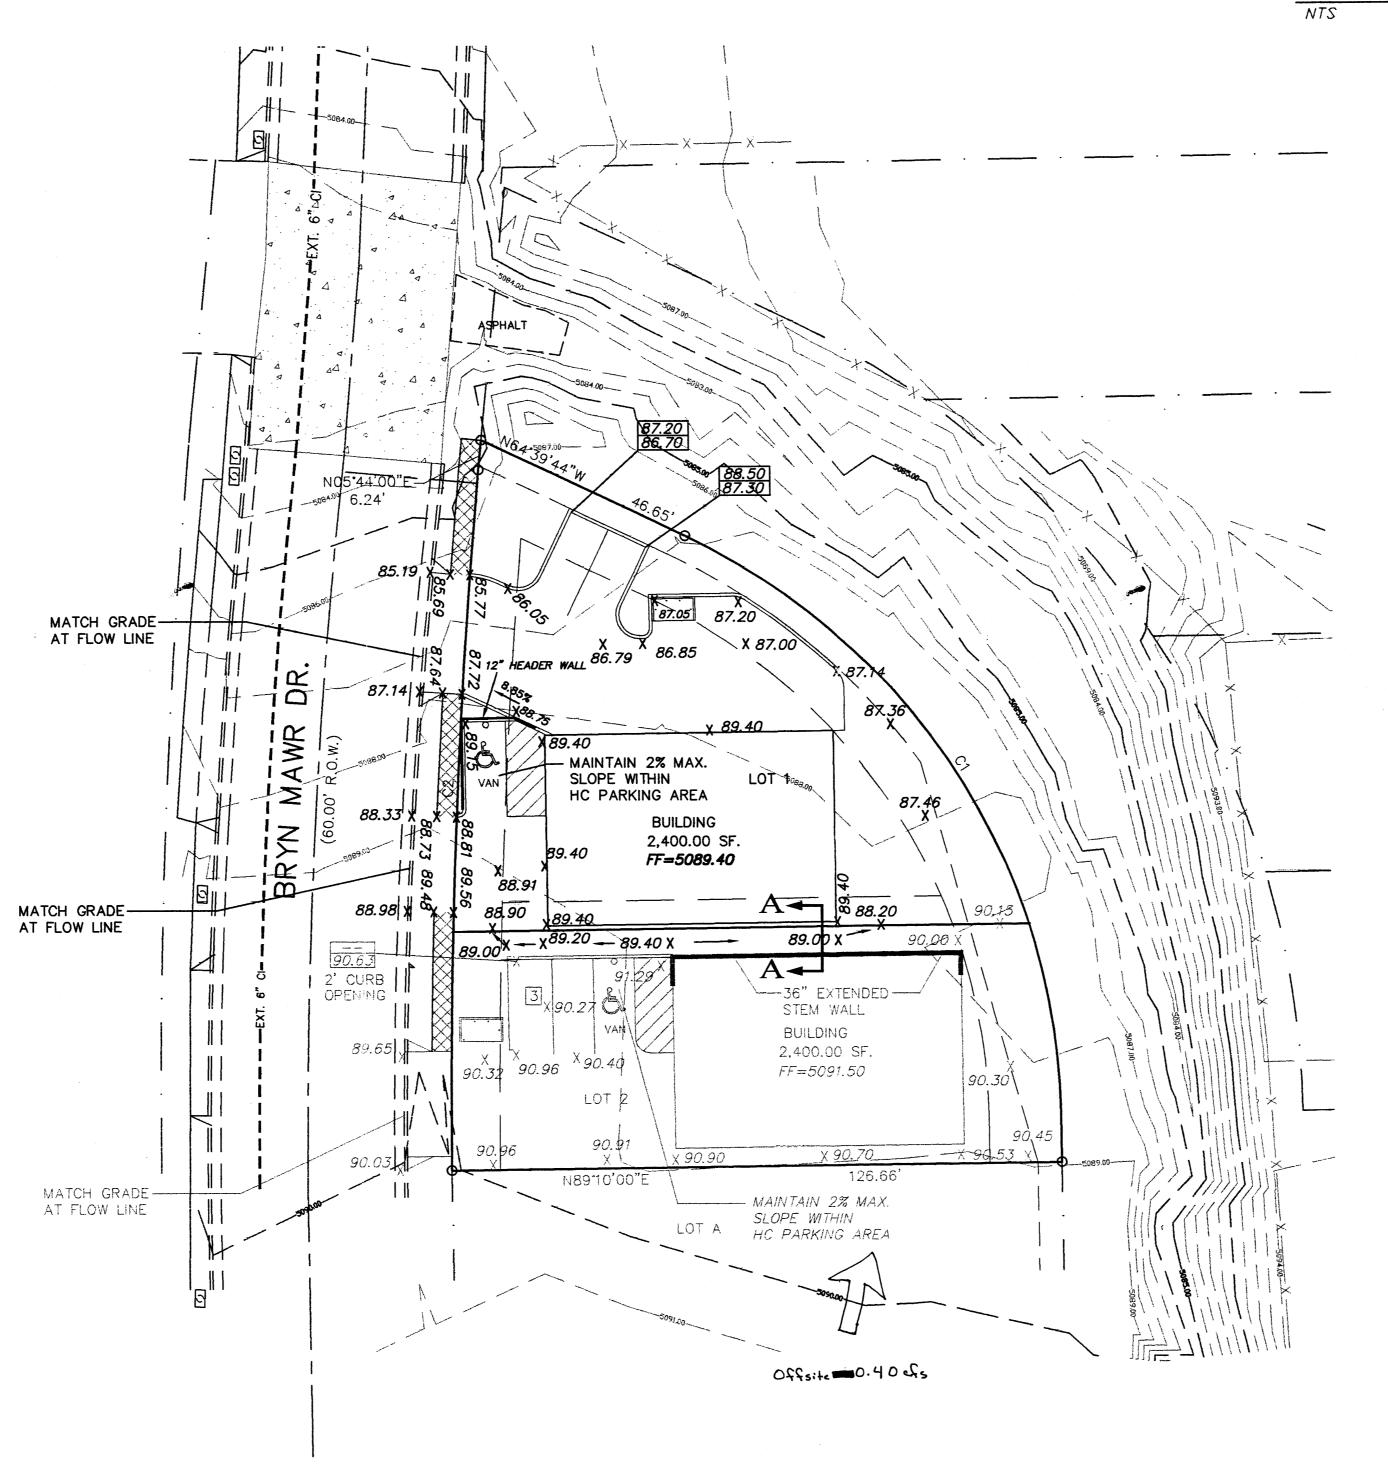

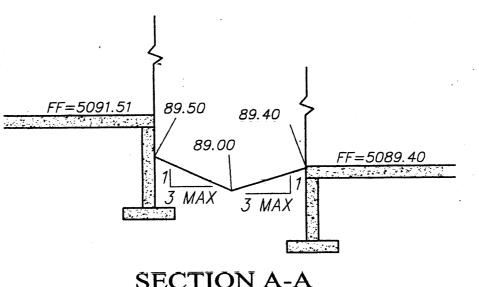

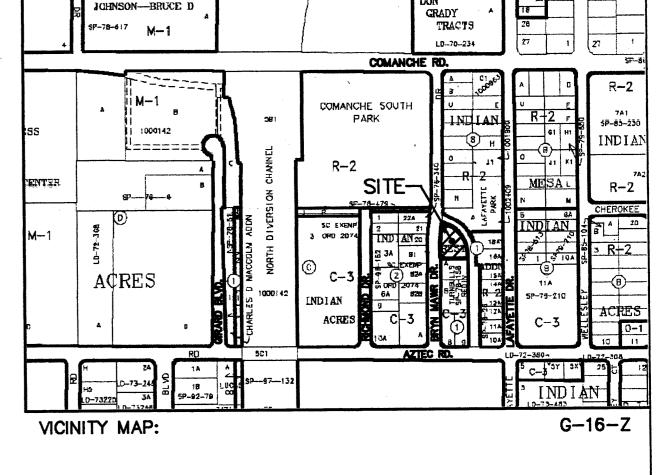

LEGAL DESCRIPTION: LOT 1, BLOCK 1, INDIAN REST CONTAINING 14,271.00 SQUARE FEET (0.3276 ACRES) MORE OR LESS.

ADDRESS: 3512 BRYN MAWR DR.

NOTICE TO CONTRACTORS

1. AN EXCAVATION/CONSTRUCTION PERMIT WILL BE REQUIRED BEFORE BEGINNING ANY WORK WITHIN CITY RIGHT-OF-WAY.


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- OF THE PROPERTY SERVED. 7. WORK ON ARTERIAL STREETS SHALL BE PERFORMED ON A 24-HOUR BASIS.



GRAPHIC SCALE



ADDRESS: 3512 Bryn Mawr Dr

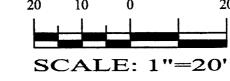

LAST REVISION: 06-09-2007

ADVANCED ENGINEERING and CONSULTING, LLC

SHAHAB BIAZAR P.E. #13479

4416 ANAHEIM AVE., NE ALBUQUERQUE, NEW MEXICO 87113 (505)899-5570

LOT 1, BLOCK 1, INDIAN REST GRADING AND DRAINAGE PLAN DRAWN BY: DRAWING:

JUN 0 9 2006


200641-GR.DWG

G-16 D138

1 OF

ROUGH GRADING APPROVAL

DATE

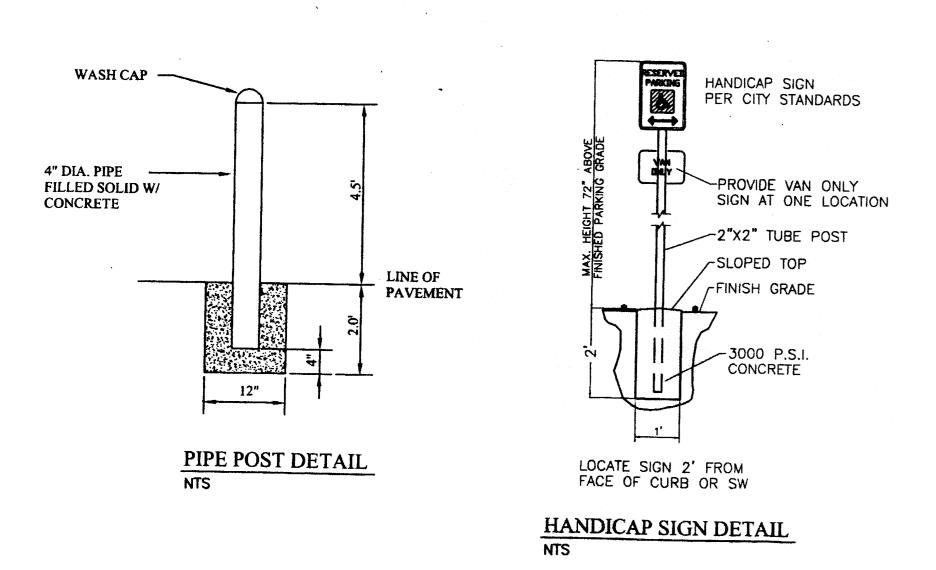

BOUNDARY LINE


PROPOSED BUILDING


EXISTING EASEMENT

PROPOSED CURB ON SITE

EXISTING CURB & GUTTER


NUMBER OF PROPOSED PARKING

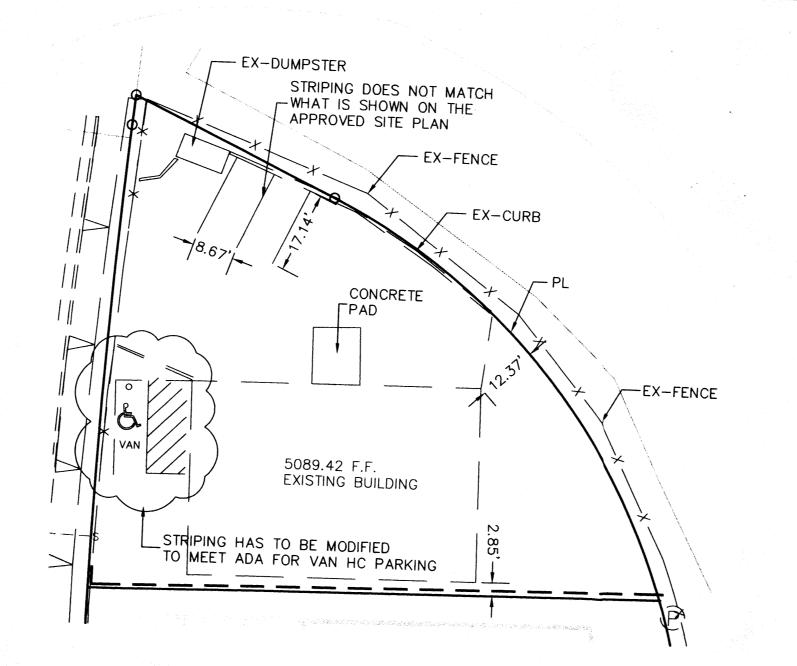

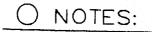


- 1. NEW ENTRANCE PER COA STANDARD DRAWING #2426.
- 2. EXISTING CURB AND GUTTER.
- 3. REMOVE EXISTING CURB.
- 4. NEW ASPHALT PAVING AREA.
- 5. NEW MOUNTABLE CURB AND GUTTER PER COA STANDARD DRAWING 2415A.
- 6. NEW 4' SIDEWALK.
- 7. INSTALL HANDICAP SIGN (SEE DETAIL THIS SHEET).
- 8. TRASH ENCLOSURE (SEE DETAIL THIS SHEET).

	·		CURVE TA	BLE	***************************************	
CURVE	LENGTH	RADIUS	DELTA	TANGENT	CHORD	CHORD DIRECTION
C1	-	136.81	63'33'25"	84.75	144.10	N32'36'42"W
C2	147.16	1510.95	05'34'49"	73.64	147.10	S02*21'27"W

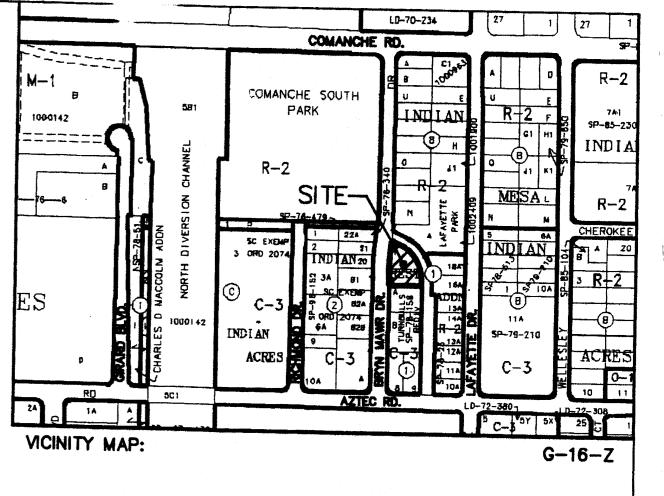


LEGAL DESCRIPTION:


LOTS 1, BLOCK 1, INDIAN REST, CONTAINING 14,271.00 SF. (0.3276 AC.) ZONING: C-3

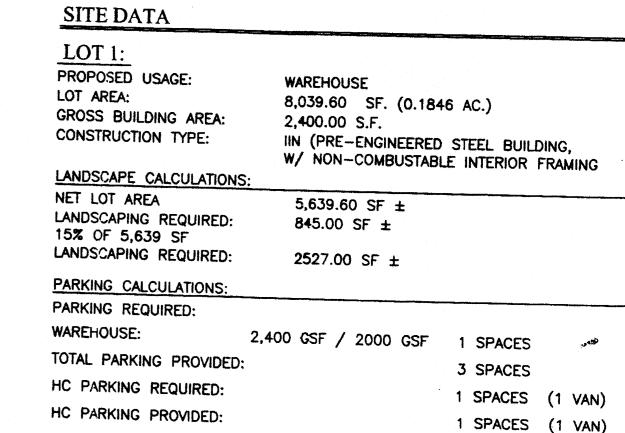



TRAFFIC ENGINEERING, TRANSPORTATION DIVISION

SOLID WASTE MANAGEMENT DATE

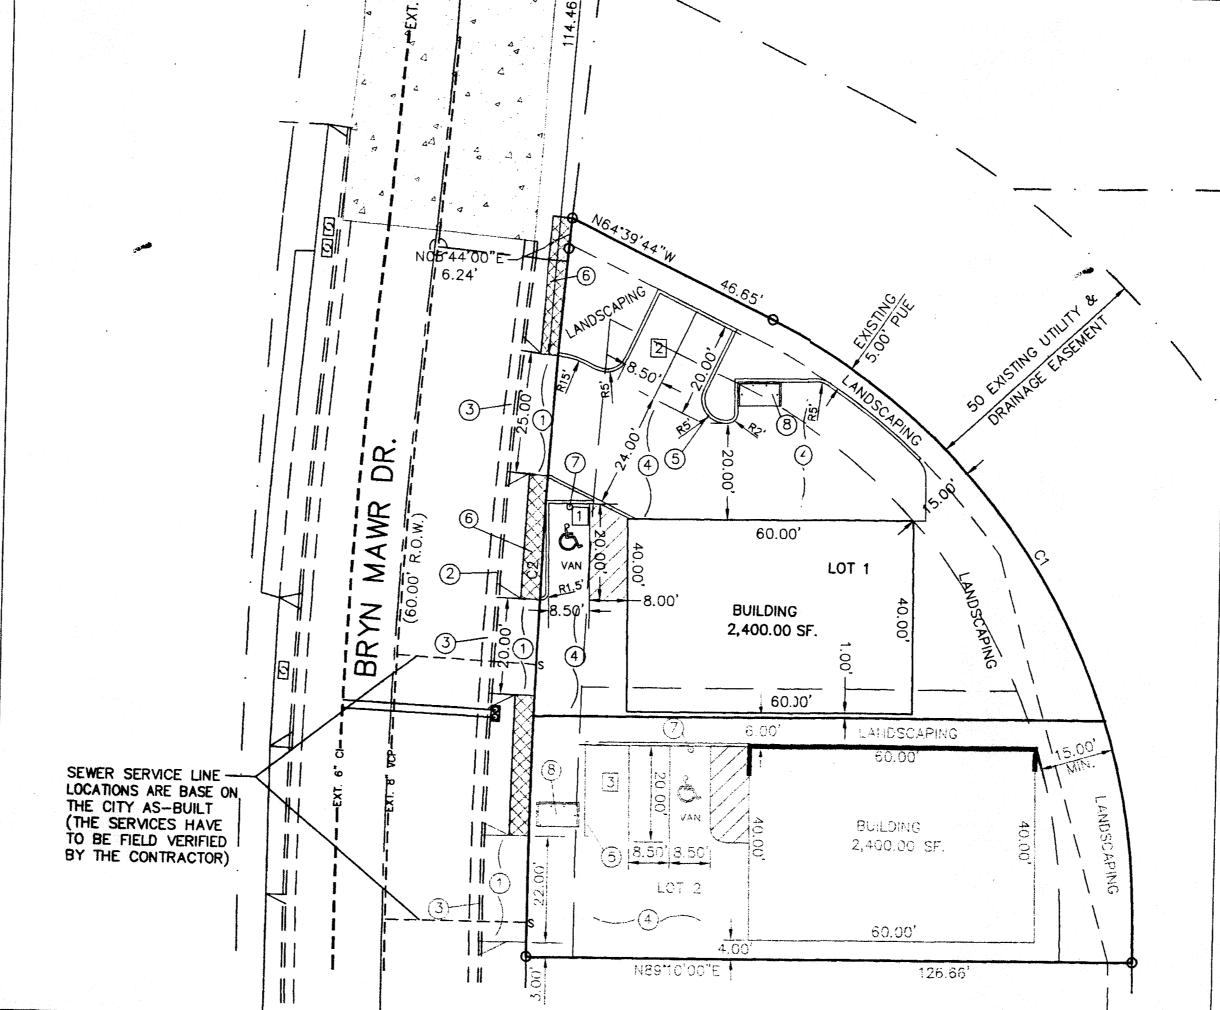

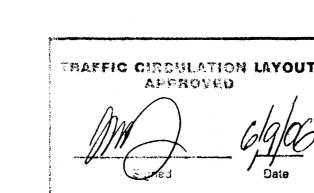


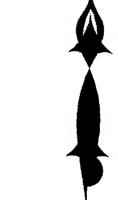

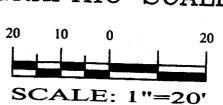



SHAHAB BIAZAR P.E. #13479

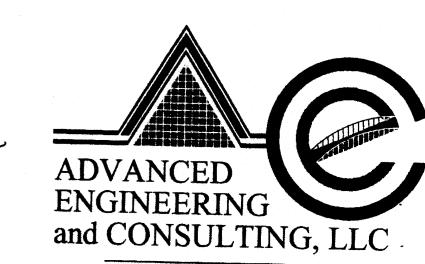


DATE

4416 ANAHEIM AVE., NE ALBUQUERQUE, NEW MEXICO 87113 (505)899-5570

LOT 1, BLOCK 1, INDIAN REST SITE PLAN DRAWN BY:

DRAWING: DATE: SHEET# 200641-ST.DWG SB 06-07-2006 1 OF 1

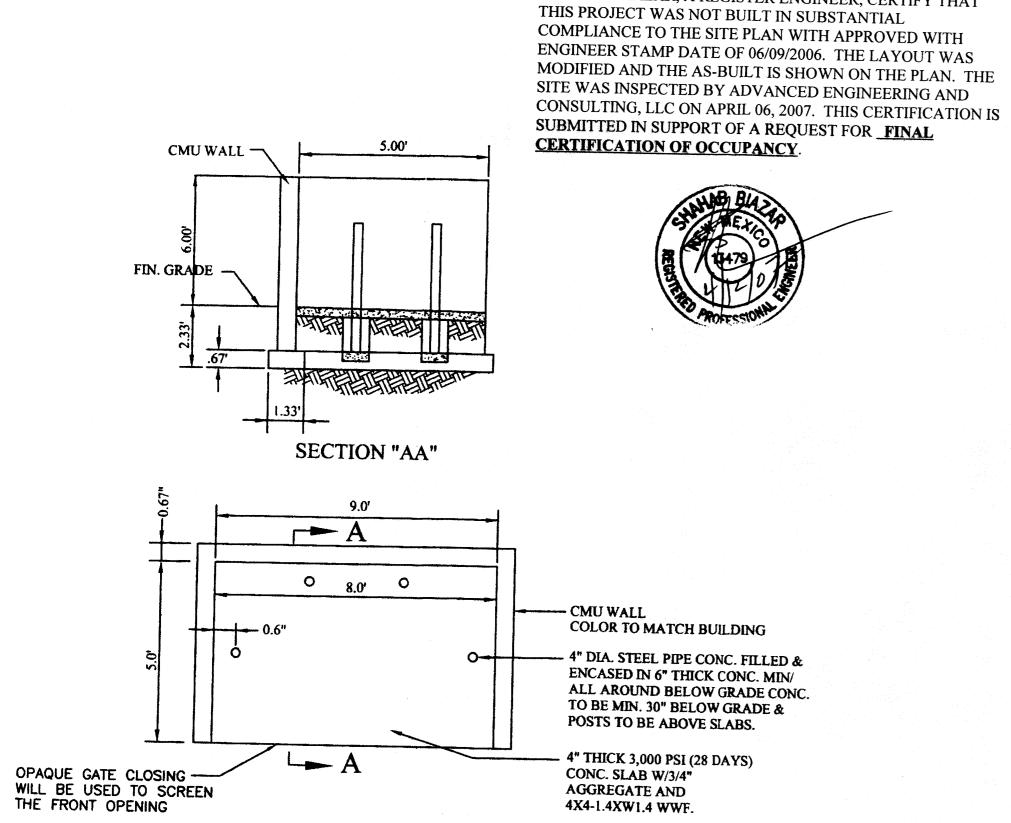

RULE UP DUMPSTER ENCLOSURE DETAIL


LEGEND

I SHAHAB BIAZAR, A REGISTER ENGINEER, CERTIFY THAT

LOTA

GRAPHIC SCALE

LAST REVISION: 06-09-200,

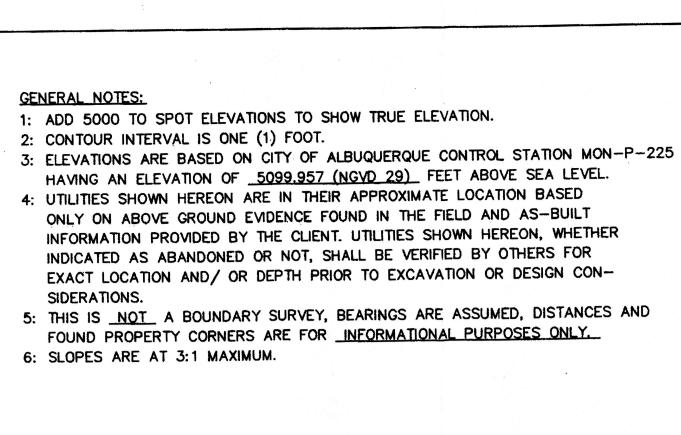

EROSION CONTROL PLAN

OF EXISTING RIGHT-OF-WAY.

RUNOFF ON SITE.

LEGEND

AND POLLUTION PREVENTION NOTES

DISTURBANCE PERMIT PRIOR TO BEGINNING WORK.

6. ALL THE DISTURBED AREAS MUST BE REVEGETATED.

CONTRACTOR IS RESPONSIBLE FOR OBTAINING A TOPSOIL

3. CONTRACTOR IS RESPONSIBLE FOR MAINTAINING ALL STORM

4. REPAIR OF DAMAGED FACILITIES AND CLEAN-UP OF SEDIMENT ACCUMULATION ON ADJACENT PROPERTIES AND IN PUBLIC FACILITIES IS THE RESPONSIBILITY OF THE CONTRACTOR.

ALL EXPOSED EARTH SURFACES MUST BE PROTECTED FROM WIND AND WATER EROSION PRIOR TO FINAL ACCEPTANCE OF ANY

EXISTING SAS MANHOLE

EXISTING VALVE W/BOX

EXISTING FIRE HYDRANT

PROPOSED CURB & GUTTER

LIMITS OF TOP OF EXISTING SLOPE

PROPOSED SPOT ELEVATION

- PROPOSED EXTENDED STEM WALL

TOP OF EXTENDED STEM WALL

TOP OF RETAINING WALL

BOUNDARY LINE

PROPOSED GRADE

EXISTING GRADE

TOP OF FOOTING

TOP OF FOOTING

SINGE "A" INLET

DOUBLE "A" INLET

EXISTING METER

----EX. 8" SAS --- EXISTING SANITARY SEWER LINE

- - - EX. 16" WL- - EXISTING WATER LINE

====== EXISTING CURB & GUTTER

____ 5085___ EXISTING CONTOUR (MAJOR)

___ ___ EXISTING CONTOUR (MINOR)

--- EASEMENT

PROPOSED SIDEWALK

EXISTING POWER LINES

PROPOSED RETAINING WALL


X *70.28*


× 5265.16


TRW=38.00TF=32.00

TSW=34.00 TF=32.00

2. CONTRACTOR IS RESPONSIBLE FOR CLEANING ALL SEDIMENT OUT

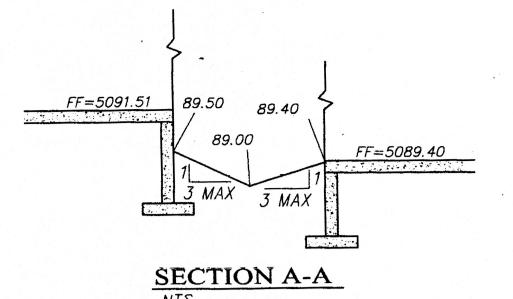

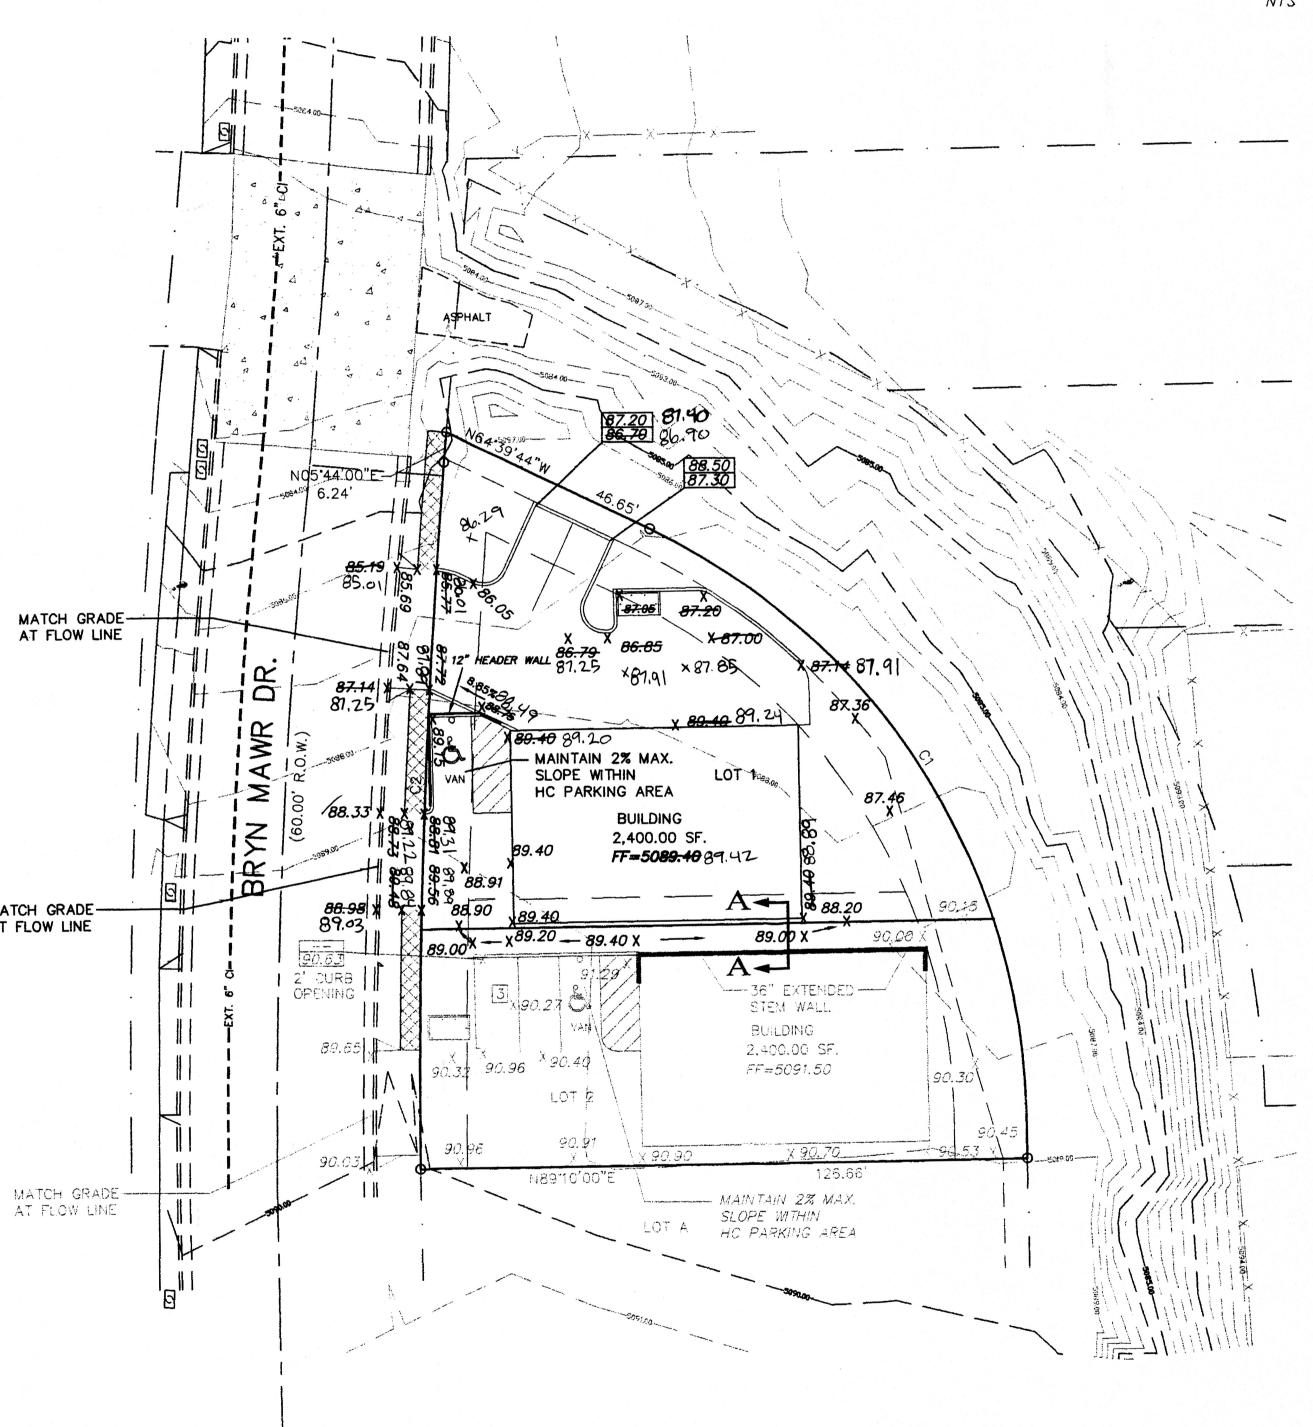

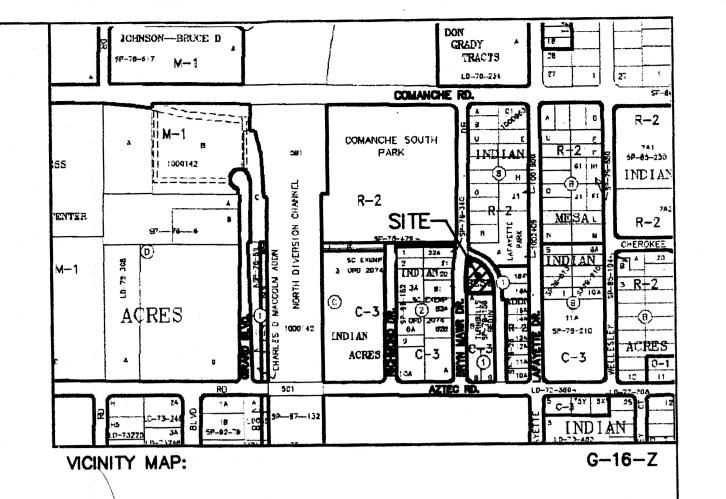

LEGAL DESCRIPTION:

LOT 1, BLOCK 1, INDIAN REST CONTAINING 14,271.00 SQUARE FEET (0.3276 ACRES)

3512 BRYN MAWR DR.

NOTICE TO CONTRACTORS

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- 5. BACKFILL COMPACTION SHALL BE ACCORDING TO TRAFFIC/STREET USE. 6. MAINTENANCE OF THESE FACILITIES SHALL BE THE RESPONSIBILITY OF THE OWNER
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DRAINAGE CERTIFICATION

OF THE PROPERTY SERVED.

I, SHAHAB BIAZAR, NMPE 13479, OF THE FIRM ADVANCED ENGINEERING AND CONSULTING, LLC HEREBY CERTIFY THAT THIS PROJECT HAS BEEN GRADED AND WILL DRAIN IN SUBSTANTIAL OMPLIANCE WITH AND IN ACCORDANCE WITH THE DESIGN INTENT OF THE APPROVED PLAN THE RECORD INFORMATION EDITED ONTO THE ORIGINAL DESIGN DOCUMENT S BEEN OBTAINED BY ME OR UNDER MY DIRECT SUPERVISION AND IS TRUE AND CORRECT TO THE BEST OF MY KNOWLEDGE AND BELIEF. THIS CERTIFICATION IS SUBMITTED IN SUPPORT OF A REQUEST FOR GRADING CERTIFICATION.

THE RECORD INFORMATION REPRESENTED HEREON IS NOT NECESSARILY COMPLETE AND INTENDED ONLY TO VERIFY SUBSTANTIAL COMPLIANCE OF THE GRADING AND DRAINAGE ASPECTS OF THIS PROJECT. THOSE RELYING ON THIS RECORD DOCUMENT ARE ADVISED TO OBTAIN INDEPENDENT VERIFICATION OF ITS ACCURACY BEFORE USING IT FOR ANY OTHER

SHAHAB BIAZAR, NMPE 13479

04/12/2007

LAST REVISION: 06-09-2007





ENGINEERING and CONSULTING, LLC

SHAHAB BIAZAR P.E. #13479

200641-GR.DWG

4416 ANAHEIM AVE., NE ALBUQUERQUE, NEW MEXICO 87113 (505)899-5570

06-07-2006

LOT 1, BLOCK 1, INDIAN REST GRADING AND DRAINAGE PLAN SHEET# DATE: DRAWING: DRAWN BY:

SHH

MAY 0 1 2007 HYDROLOGY SECTION

1 OF 1


MATCH GRADE -AT FLOW LINE

GRAPHIC SCALE

SCALE: 1"=20'

DATE

ROUGH GRADING APPROVAL

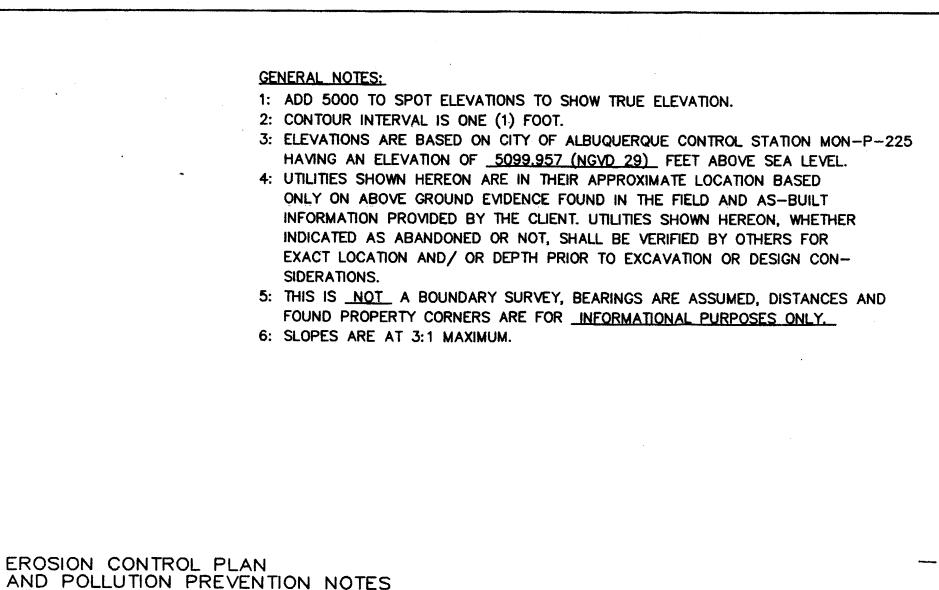

CONTRACTOR IS RESPONSIBLE FOR OBTAINING A TOPSOIL

CONTRACTOR IS RESPONSIBLE FOR MAINTAINING ALL STORM

FACILITIES IS THE RESPONSIBILITY OF THE CONTRACTOR.

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EXISTING VALVE W/BOX

EXISTING FIRE HYDRANT

PROPOSED CURB & GUTTER

LIMITS OF TOP OF EXISTING SLOPE

PROPOSED SPOT ELEVATION

PROPOSED EXTENDED STEM WALL

TOP OF EXTENDED STEM WALL

TOP OF RETAINING WALL

TOP OF FOOTING

TOP OF FOOTING

SINGE "A" INLET

DOUBLE "A" INLET

EXISTING METER

---- EX. 8" SAS--- EXISTING SANITARY SEWER LINE

--- EXISTING WATER LINE

--- EASEMENT

X 70.28

× 5265.16

TSW=34.00 TF=32.00

======= EXISTING CURB & GUTTER

--- 5083--- EXISTING CONTOUR (MINOR)

PROPOSED SIDEWALK

EXISTING POWER LINES

PROPOSED RETAINING WALL

- BOUNDARY LINE

PROPOSED GRADE

EXISTING GRADE

CONTRACTOR IS RESPONSIBLE FOR CLEANING ALL SEDIMENT OUT


DISTURBANCE PERMIT PRIOR TO BEGINNING WORK.

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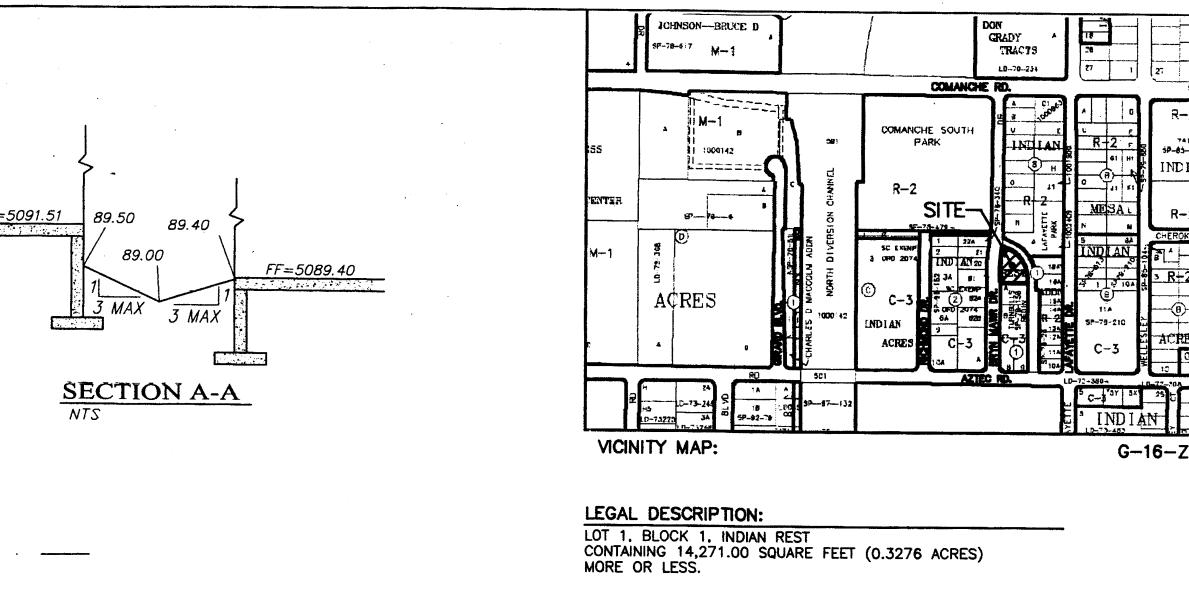
OF EXISTING RIGHT-OF-WAY.

RUNOFF ON SITE.

LEGEND

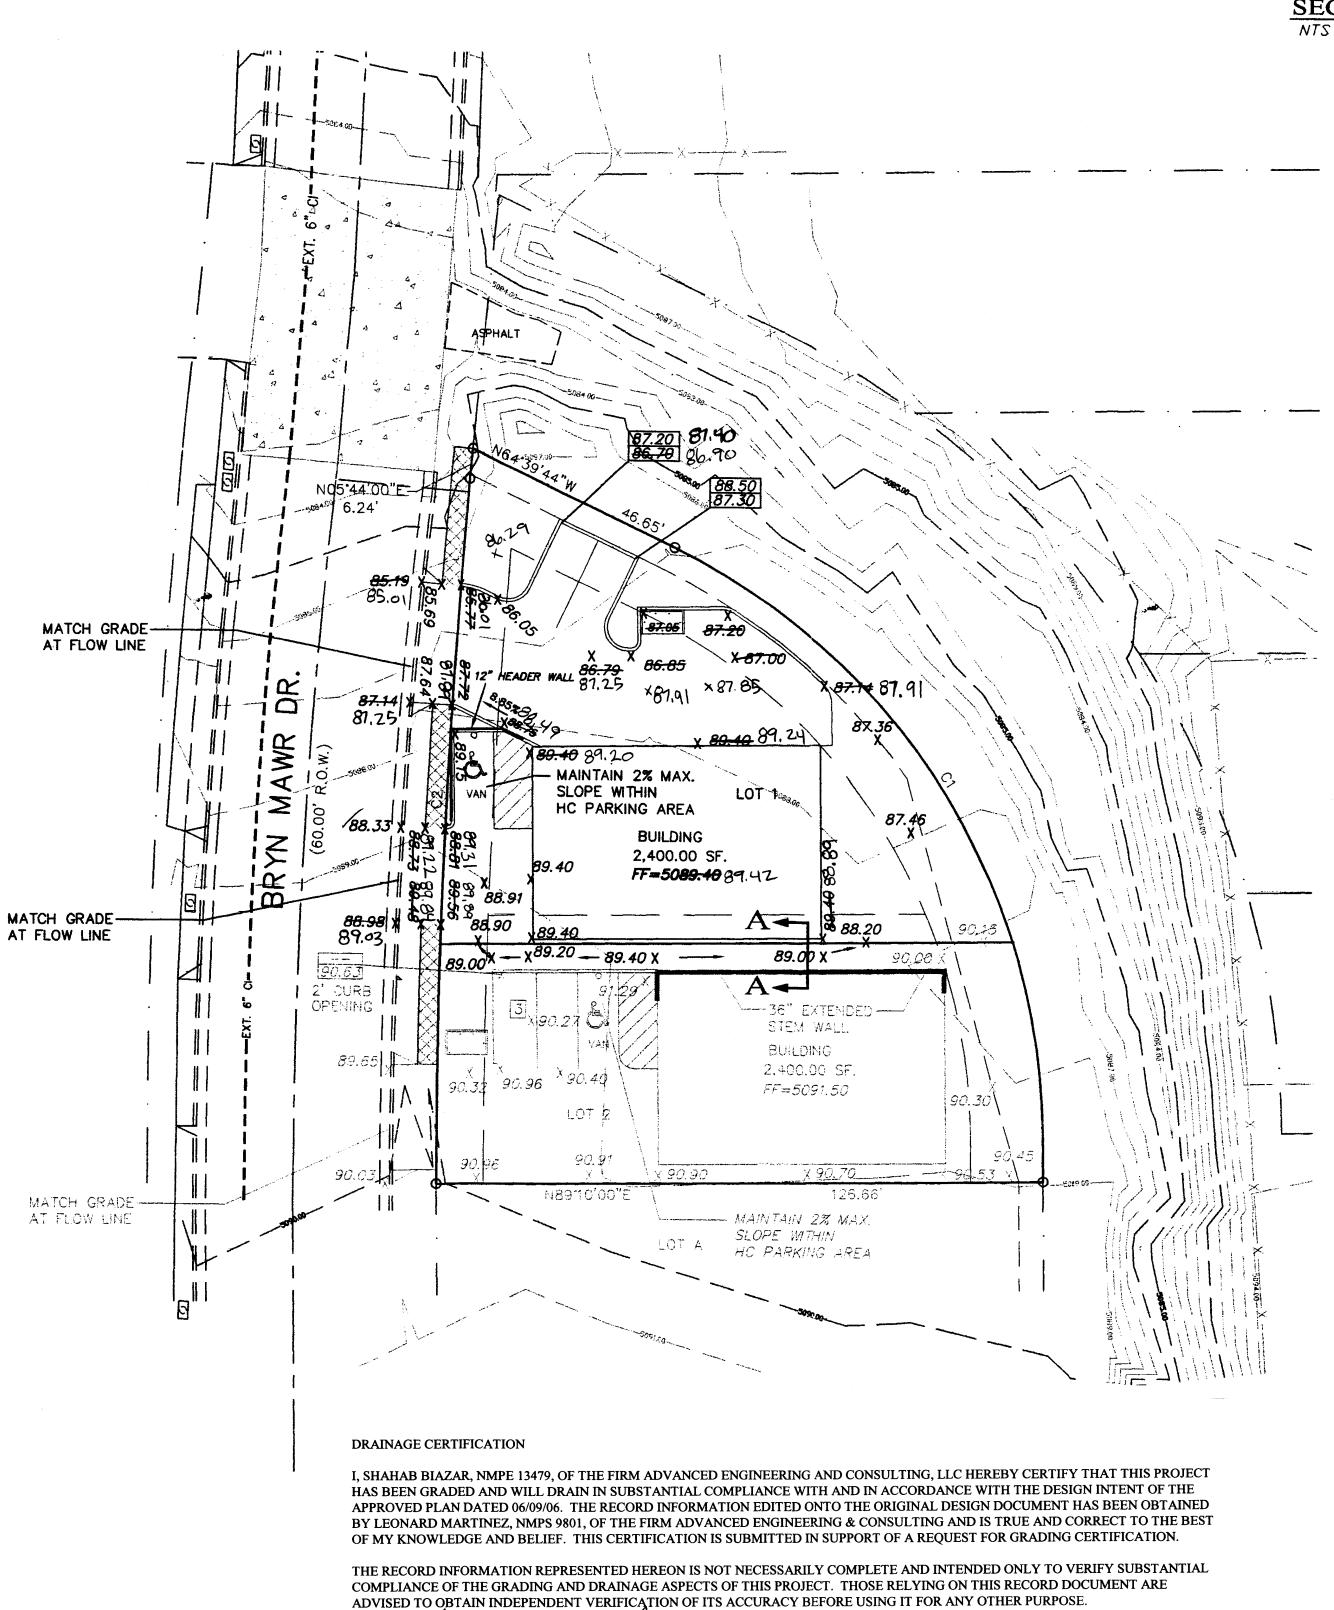

SHAHAB BIAZAR, NMPE 13479



ADDRESS:

3512 BRYN MAWR DR.

NOTICE TO CONTRACTORS

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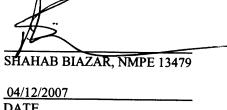
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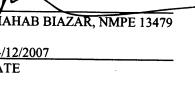
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ADVANCED ENGINEERING

and CONSULTING, LLC 4416 ANAHEIM AVE., NE ALBUQUERQUE, NEW MEXICO 87113

LOT 1, BLOCK 1, INDIAN REST GRADING AND DRAINAGE PLAN DRAWING: DRAWN BY: DATE: SHEET# 200641-GR.DWG SHH 06-07-2006 1 OF 1



人员以后, 以至产品, 不是不是任何, 在是不完成了了。
 人员以后, 以是产品, 不是不是任何, 在是一个人。

GRAPHIC SCALE

SCALE: 1"=20'

DATE

ROUGH GRADING APPROVAL

1 JUN 1 4 2007 HYDROLOGY SECTION

LAST REVISION: 06-09-2007

SHAHAB BIAZAR P.E. #13479