CITY OF ALBUQUERQUE



November 4, 2015

Jay Newell, P.E. Sterling Design Associates, LLC 2009 W. Littleton Blvd. Suite 300 Littleton, CO 80120

RE: Starbucks 4301 San Mateo Blvd. NE Request Permanent C.O. – Accepted Engineers Stamp Date 2/9/15 (G17D006C) Certification Dated 10/23/15

Dear Mr. Newell,

Based on the Certification received 10/26/2015 and the letter received 11-4-15, the above referenced site is acceptable for release of Certificate of Occupancy by Hydrology.

PO Box 1293

If you have any questions, please contact me at 924-3695 or Totten Elliott at 924-3982.

Albuquerque

Sincerely, Bite H

Senior Engineer, Hydrology

Rita Harmon, P.E.

Planning Department

NM 87103

www.cabq.gov

TE/RH C: File



November 3, 2015

Ms. Rita Harmon, P.E. Senior Engineer, Hydrology Planning Department City of Albuquerque PO Box 1293 Albuquerque, NM 87103

RE: Starbucks 4301 San Mateo Blvd. NE Request Permanent C.O. – Not Accepted Engineer's Stamp Date 2/9/15 (G17D006C) Certification Dated 10/23/15

Ms. Harmon:

I have reviewed your letter dated October 29, 2015, outlining several items concerning the improvements constructed on the subject site and have included a review of their impact on project.

- The concrete sidewalk culvert is not within a paved pedestrian access, but is rather within a landscape area. Therefore pedestrian access across the top of the culvert by use of a steel plate is unnecessary.
- Based on the as-built field shots it appears there is adequate fall from the outlet of the sidewalk culvert across the adjacent downstream parking area. Therefore the 2' wide pan is unnecessary.
- As clarified in separate correspondence, the city's concern is in regard to the 6" curb opening on the "east" end of the building. Inclusion of a 6" curb opening may have provided additional drainage benefits to the adjacent landscape area; however, the lack of such an opening serving a relatively small tributary area should not significantly alter the overall design intent of the grading and drainage aspects of the project as described on the approved plan(s).

As the compliance language on the As-Built Sheet C301, stamped 10/23/15 indicates; these deviations from the grading and drainage design described on the approved plan(s) represent discrepancies which are minor in nature and/or should impact maintenance of the property rather than the overall drainage design intent.

Respectfully submitted, Sterling Design Associates, Ilc



Jay M. Newell 11 3/15 On behalf of Sterling Design Associates, LLC

Jay M. Newell, PE Wayne T. Sterling, RLA, LEED AP

> 2009 W. Littleton Blvd., #300 Littleton, CO 80120

303.794.4727 www.SterlingDesignAssociates.com

GENERAL NOTES

- 1. REFER TO SHEET C100 FOR ADDITIONAL PROJECT GENERAL NOTES
- 2. IF, DURING THE OVERLOT GRADING PROCESS, CONDITIONS ARE ENCOUNTERED BY THE CONTRACTOR, HIS SUBCONTRACTORS, OR OTHER AFFECTED PARTIES, WHICH COULD INDICATE A SITUATION THAT IS NOT IDENTIFIED IN THE PLANS OR SPECIFICATIONS, THE CONTRACTOR SHALL CONTACT THE GEOTECHNICAL ENGINEER IMMEDIATELY FOR RECOMMENDATIONS.
- 3. ALL EARTHWORK, GRADING, OVERLOT GRADING, BACKFILLING, FILLING, EXCAVATION, COMPACTION, PAVEMENT, AND FLATWORK CONSTRUCTION WILL BE IN ACCORDANCE WITH THE RECOMMENDATIONS FROM THE GEOTECHNICAL INVESTIGATION PREPARED SPECIFICALLY FOR THIS SITE
- 4. ALL CONCRETE PAVEMENT, CONCRETE FLATWORK, CONCRETE STRUCTURES AND CONCRETE UTILITIES SHALL BE IN ACCORDANCE WITH THE MATERIAL RECOMMENDATIONS FROM THE GEOTECHNICAL INVESTIGATION PREPARED SPECIFICALLY FOR THIS SITE AND THE CITY OF ALBUQUERQUE STANDARD SPECIFICATIONS FOR PUBLIC WORKS CONSTRUCTION.
- 5. THE EARTHWORK FOR ALL BUILDING FOUNDATIONS AND SLABS SHALL BE IN ACCORDANCE WITH ARCHITECTURAL PLANS AND SPECIFICATIONS AND THE RECOMMENDATIONS OF THE GEOTECHNICAL INVESTIGATION PREPARED SPECIFICALLY FOR THIS SITE.
- 6. SPOT ELEVATIONS SHALL TAKE PRECEDENCE OVER CONTOURS AND SLOPES SHOWN. THE CONTRACTOR SHALL NOTICY THE ENGINEER OF SPOT ELEVATIONS WHICH DO NOT APPEAR TO BE CONSISTENT WITH THE CONTOURS AND SLOPES. SPOT ELEVATIONS AND SPECIFIC PROFILE DESIGN SHALL BE USED FOR SETTING ELEVATIONS OF CURB AND GUTTER AND UTILITIES
- 7. SPOT ELEVATIONS REPRESENT FLOWLINE (BOTTOM FACE OF CURB OR PAN CENTER) WHERE SHOWN AT CURB AND **GUTTER & PAN LOCATIONS UNLESS OTHERWISE NOTED.**
- 8. CONTOURS SHOWN ARE FOR FINISHED PAVING, SIDEWALK, SLAB, OR GROUND. ADJUSTMENT TO SUBGRADE IS THE CONTRACTOR'S RESPONSIBILITY.
- 9. THE CONTRACTOR IS RESPONSIBLE FOR PROVIDING HIS OWN ESTIMATE OF EARTHWORK QUANTITIES.
- 10. REFER TO SITE PLAN FOR EXTENT OF PAVEMENT AND PAVEMENT SECTIONS.
- 11. GRADES WITHIN ASPHALT PAVING AREAS SHALL BE CONSTRUCTED TO WITHIN 0.10 FEET OF THE DESIGN GRADE HOWEVER, THE CONTRACTOR SHALL MAINTAIN POSITIVE DRAINAGE IN ALL PAVEMENT AREAS AND ALONG CURBS. ALL CURBS SHALL BE BUILT IN ACCORDANCE WITH THE PLAN. CURBS OR PAVEMENT AREAS WHICH DO NOT PROVIDE PROPER DRAINAGE MUST BE REMOVED AND REPLACED AT THE CONTRACTOR'S EXPENSE.
- 12. THE CONTRACTOR SHALL HAVE FORMS CHECKED BY A SURVEYOR FOR CURB AND GUTTER ADJACENT TO EXISTING ASPHALT OR CONCRETE. THE CROSS SLOPE SHALL NOT BE LESS THAN 2% OR GREATER THAN 4% FROM THE EXISTING SAWCUT LINE TO THE PROPOSED LIP OF GUTTER. DO NOT PLACE CONCRETE IN FORMS THAT HAVE BEEN CHECKED TO BE OR APPEAR IN ANY WAY INCORRECT. CONTACT THE ENGINEER IMMEDIATELY IF A PROBLEM SHOULD ARISE.
- 13. THE CONTRACTOR SHALL ADJUST AND/OR CUT EXISTING PAVEMENT AS NECESSARY TO ASSURE A SMOOTH FIT AND CONTINUOUS GRADE.
- 14. THE CONTRACTOR SHALL ASSURE POSITIVE DRAINAGE AWAY FROM BUILDINGS FOR ALL LANDSCAPED AND PAVED AREA
- 15. ALL DISTURBED AREAS THAT ARE NOT DESIGNATED TO BE PAVED SHALL BE LANDSCAPED OR SEEDED, ACCORDING TO THE LANDSCAPE PLAN.
- 16. EXISTING DRAINAGE STRUCTURES SHALL BE INSPECTED AND REPAIRED AS NEEDED, AND EXISTING PIPES CLEANED OUT TO REMOVE ALL SILT AND DEBRIS.
- 17. IF ANY EXISTING STRUCTURES, SIDEWALK, AND/OR CURB AND GUTTER MODIFIED OR TO REMAIN ARE DAMAGED DURING CONSTRUCTION, IT SHALL BE THE CONTRACTOR'S RESPONSIBILITY TO REPAIR AND/OR REPLACE THE EXISTING STRUCTURE AS NECESSARY TO RETURN IT TO EXISTING CONDITIONS OR BETTER PRIOR TO PROJECT CLOSEOUT.
- 18. ALL GRATES, MANHOLE RIMS, VALVE BOXES, VALVE COVERS, CLEANOUTS, AND VAULT OR BOX COVERS SHALL BE ADJUSTED TO "AS CONSTRUCTED" FINISHED GRADE PRIOR TO THE FINAL LIFT OF ASPHALT.
- 19. NO PROPOSED SLOPE IN LANDSCAPED AREAS OR OPEN SPACE SHALL EXCEED THREE (3) HORIZONTAL FEET TO ONE (1) VERTICAL FOOT, OR AS OTHERWISE SPECIFIED BY LOCAL CRITERIA.
- 20. THE CONTRACTOR SHALL PROTECT THE PROJECT BENCHMARK THROUGHOUT CONSTRUCTION AND SET ADDITIONAL PROJECT BENCHMARKS AS NECESSARY TO MAINTAIN VERTICAL CONTROL THROUGHOUT THE DURATION OF THE PROJECT.
- 21. THE CONTRACTOR SHALL FILL AND COMPACT BASEMENTS, CESSPOOLS, AND OTHER LARGE EXCAVATED AREAS WITH CLEAN FILL SUITABLE TO THE OWNER, AND IN ACCORDANCE WITH RECOMMENDATIONS OBTAINED FROM THE GEOTECHNICAL REPORT OR GEOTECHNICAL ENGINEER AND GRADE TO MATCH EXISTING OR PROPOSED FINISH GRADE: OR CONFIRM SUCH WORK HAS BEEN PERFORMED PRIOR TO CONSTRUCTION.

GRADING NARRATIVE

EXISTING SITE TOPOGRAPHY GENERALLY SLOPES AT APPROXIMATELY 2.5% FROM THE EAST TO THE WEST ACROSS THE EXISTING PAVED PARKING LOT. EXISTING PERIMETER LANDSCAPE AREAS ARE LESS STEEP.


PROPOSED GRADING IMPROVEMENTS INCLUDE PROVIDING A RELATIVELY FLAT PAD FOR THE PROPOSED BUILDING, PEDESTRIAN, AND ASSOCIATED ADA ACCESS AREAS. PROPOSED PERIMETER DRIVE AND PARKING AREAS INCLUDE SLOPES OF 0.5% TO 6%. PERIMETER LANDSCAPED AREAS RANGE FROM 2% TO A MAXIMUM SLOPE OF 3H:1V. SLOPES THAT ARE 3H:1V INCLUDE THE FIRST FLUSH DETENTION AREAS AND PORTIONS OF GRADING ASSOCIATED WITH THE SOUTHERN PROPERTY LINE. LANDSCAPED AREAS NOT ASSOCIATED WITH THE SOUTHERN PROPERTY LINE AND FIRST FLUSH DETENTION AREAS RNAGE FROM 2% TO 20%. A PROPOSED RETAINING WALL (MAXIMUM HEIGHT EQUALS APPROXIMATELY 0.6-FOOT) IS REQUIRED TO ACCOMMODATE THE PROPOSED GRADES ON THE WEST SIDE OF THE BUILDING ADJACENT TO THE PROPOSED PARKING. CUT AND FILL DEPTHS ARE BOTH PROPOSED TO BE APPROXIMATELY 3.5-FEET MAXIMUM.


THE SITE WILL GENERALLY CONVEY STORMWATER RUNOFF IN CONFORMANCE WITH THE HISTORICAL DRAINAGE SYSTEM. RUNOFF WILL BY CONVEYED AS SHEET FLOW ACROSS THE PAVED AREAS TO LOW POINTS LOCATED IN LANDSCAPED AREAS. THREE CURB OPENINGS WILL DIRECT RUNOFF TO FIRST FLUSH TREATMENT AREAS.


THE REQUIRED FIRST FLUSH VOLUME WILL BE PROVIDED IN TWO ON-SITE PONDS AND ONE DEPRESSED LANDSCAPED AREA. THE PONDING AREAS WILL BE LOCATED DOWNSTREAM OF CURB OPENINGS. ONCE EACH POND HAS REACHED THE FIRST FLUSH VOLUME, THE PONDS WILL RELEASE WATER AT INFLOW RATES.

ULTIMATELY, SITE STORMWATER IS CONVEYED TO THE NORTHWEST PORTION OF THE SITE WHERE THE HISTORICAL STORMWATER HAS BEEN RELEASED. OFF-SITE STORMWATER FLOWS TO THE NORTHWEST ACROSS THE ABLERTSON'S PARKING LOT AND IS ULTIMATELY CONVEYED TO THE PUBLIC STREET STORM SEWER SYSTEM IN MONTGOMERY BLVD NE.

REFER TO THE DRAINAGE SUMMARY ON THIS SHEET, AND THE PEAK DISCHARGE AND OUTLET CALCULATIONS ON SHEET C390 FOR ADDITIONAL INFORMATION

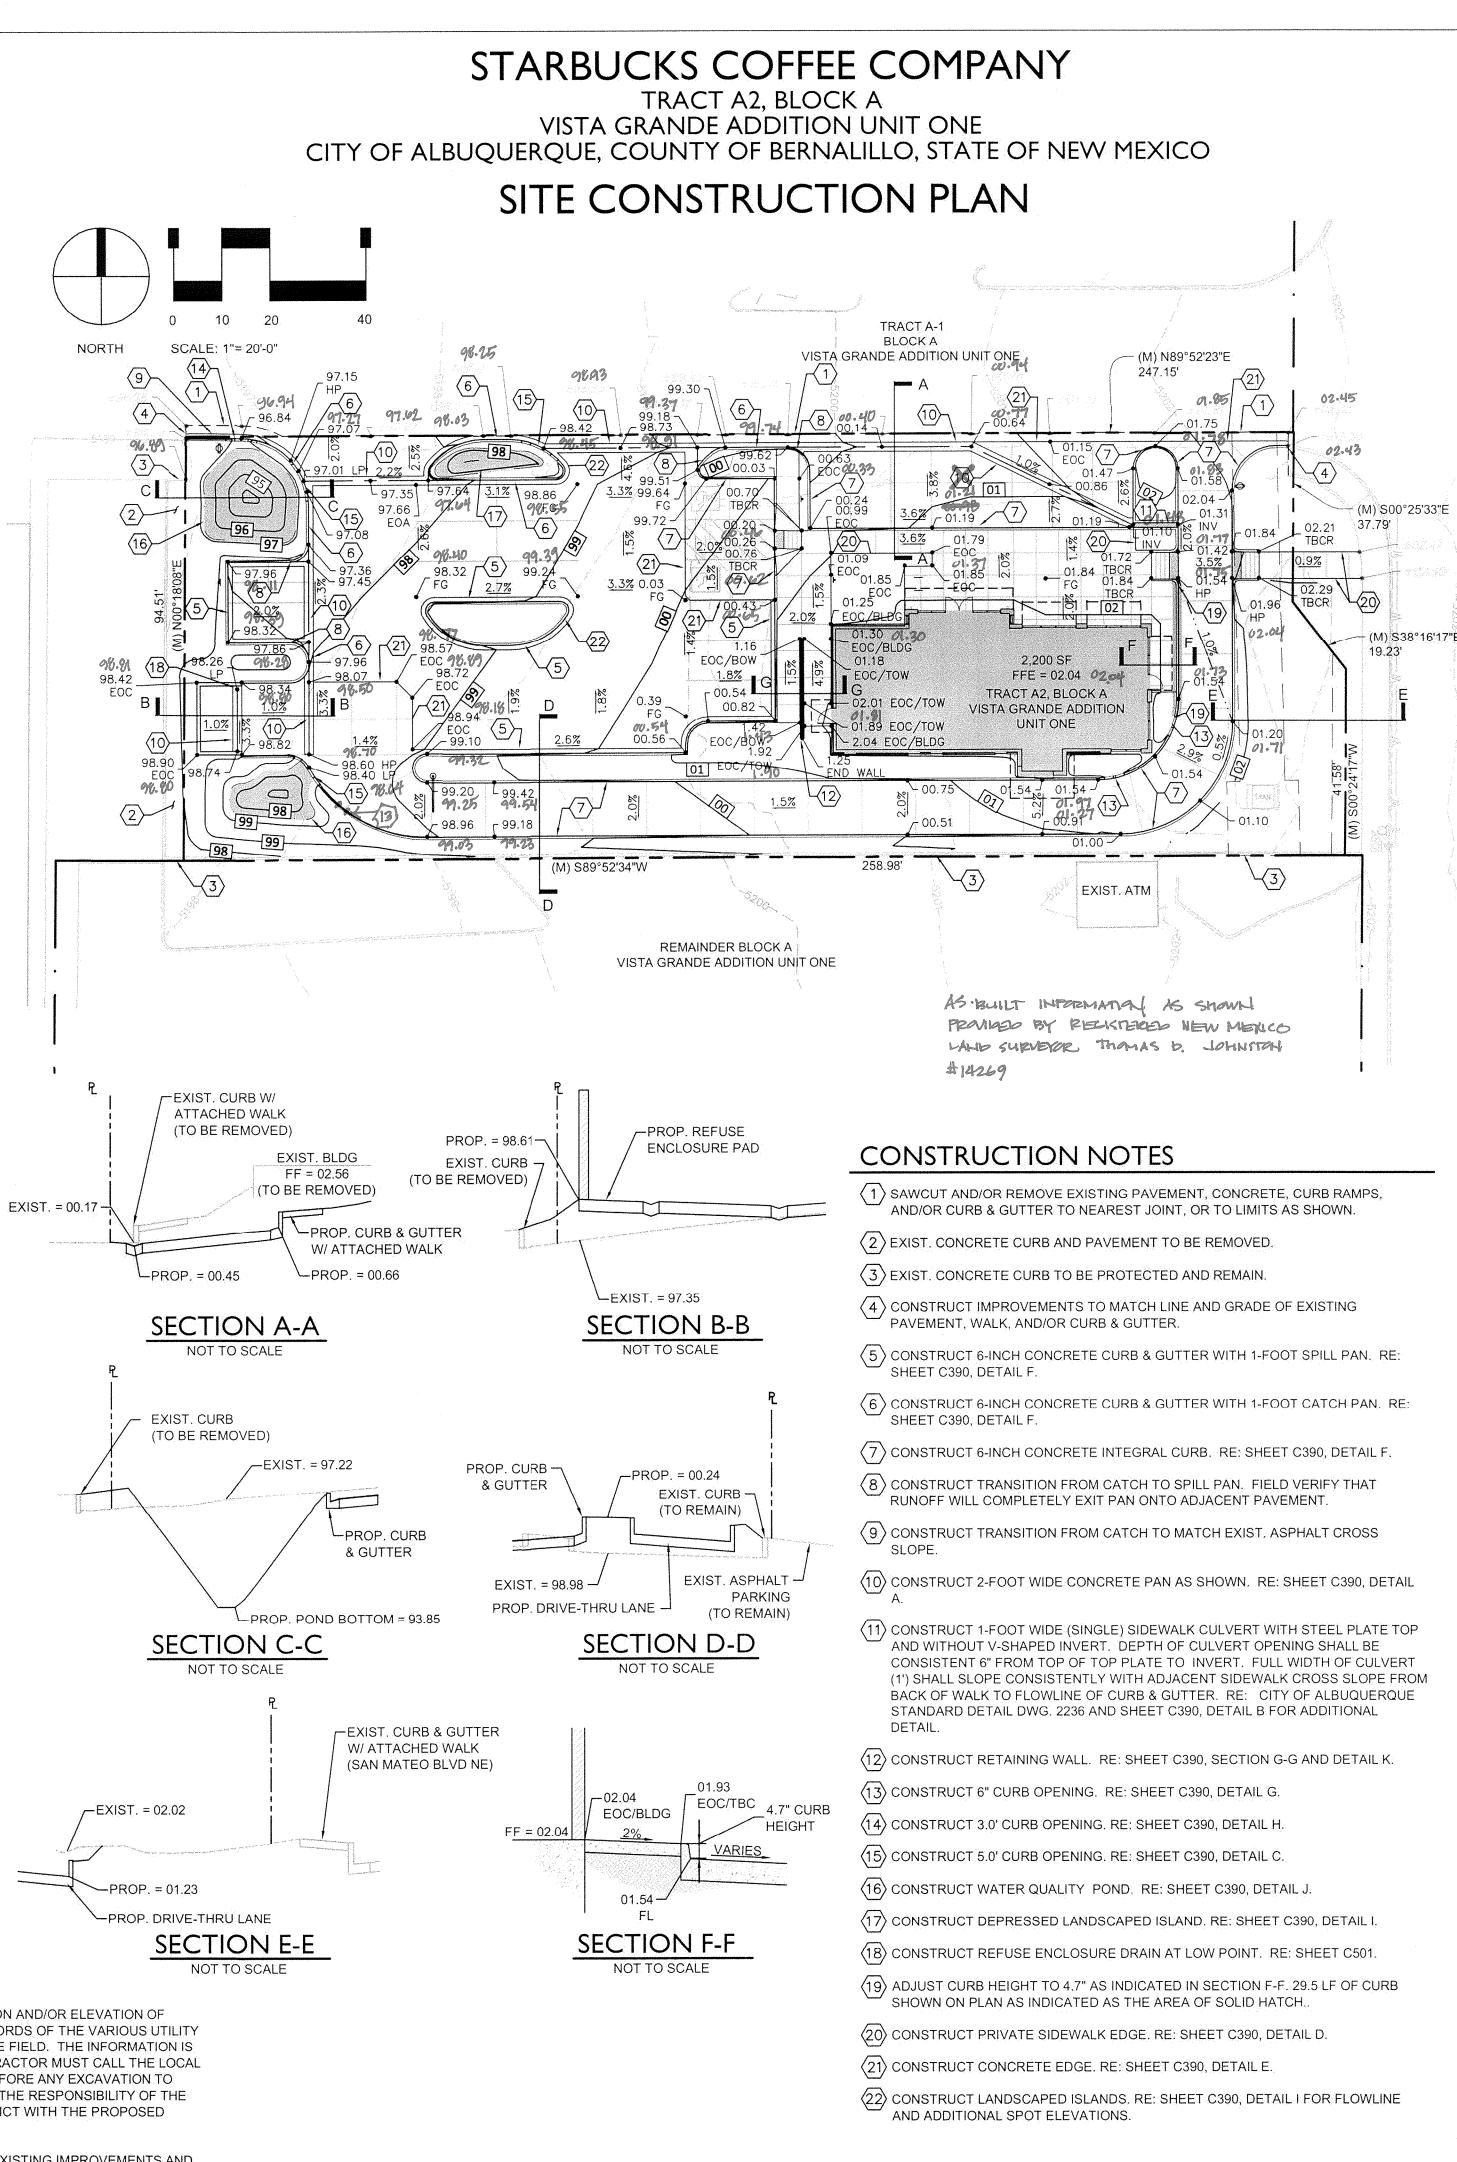

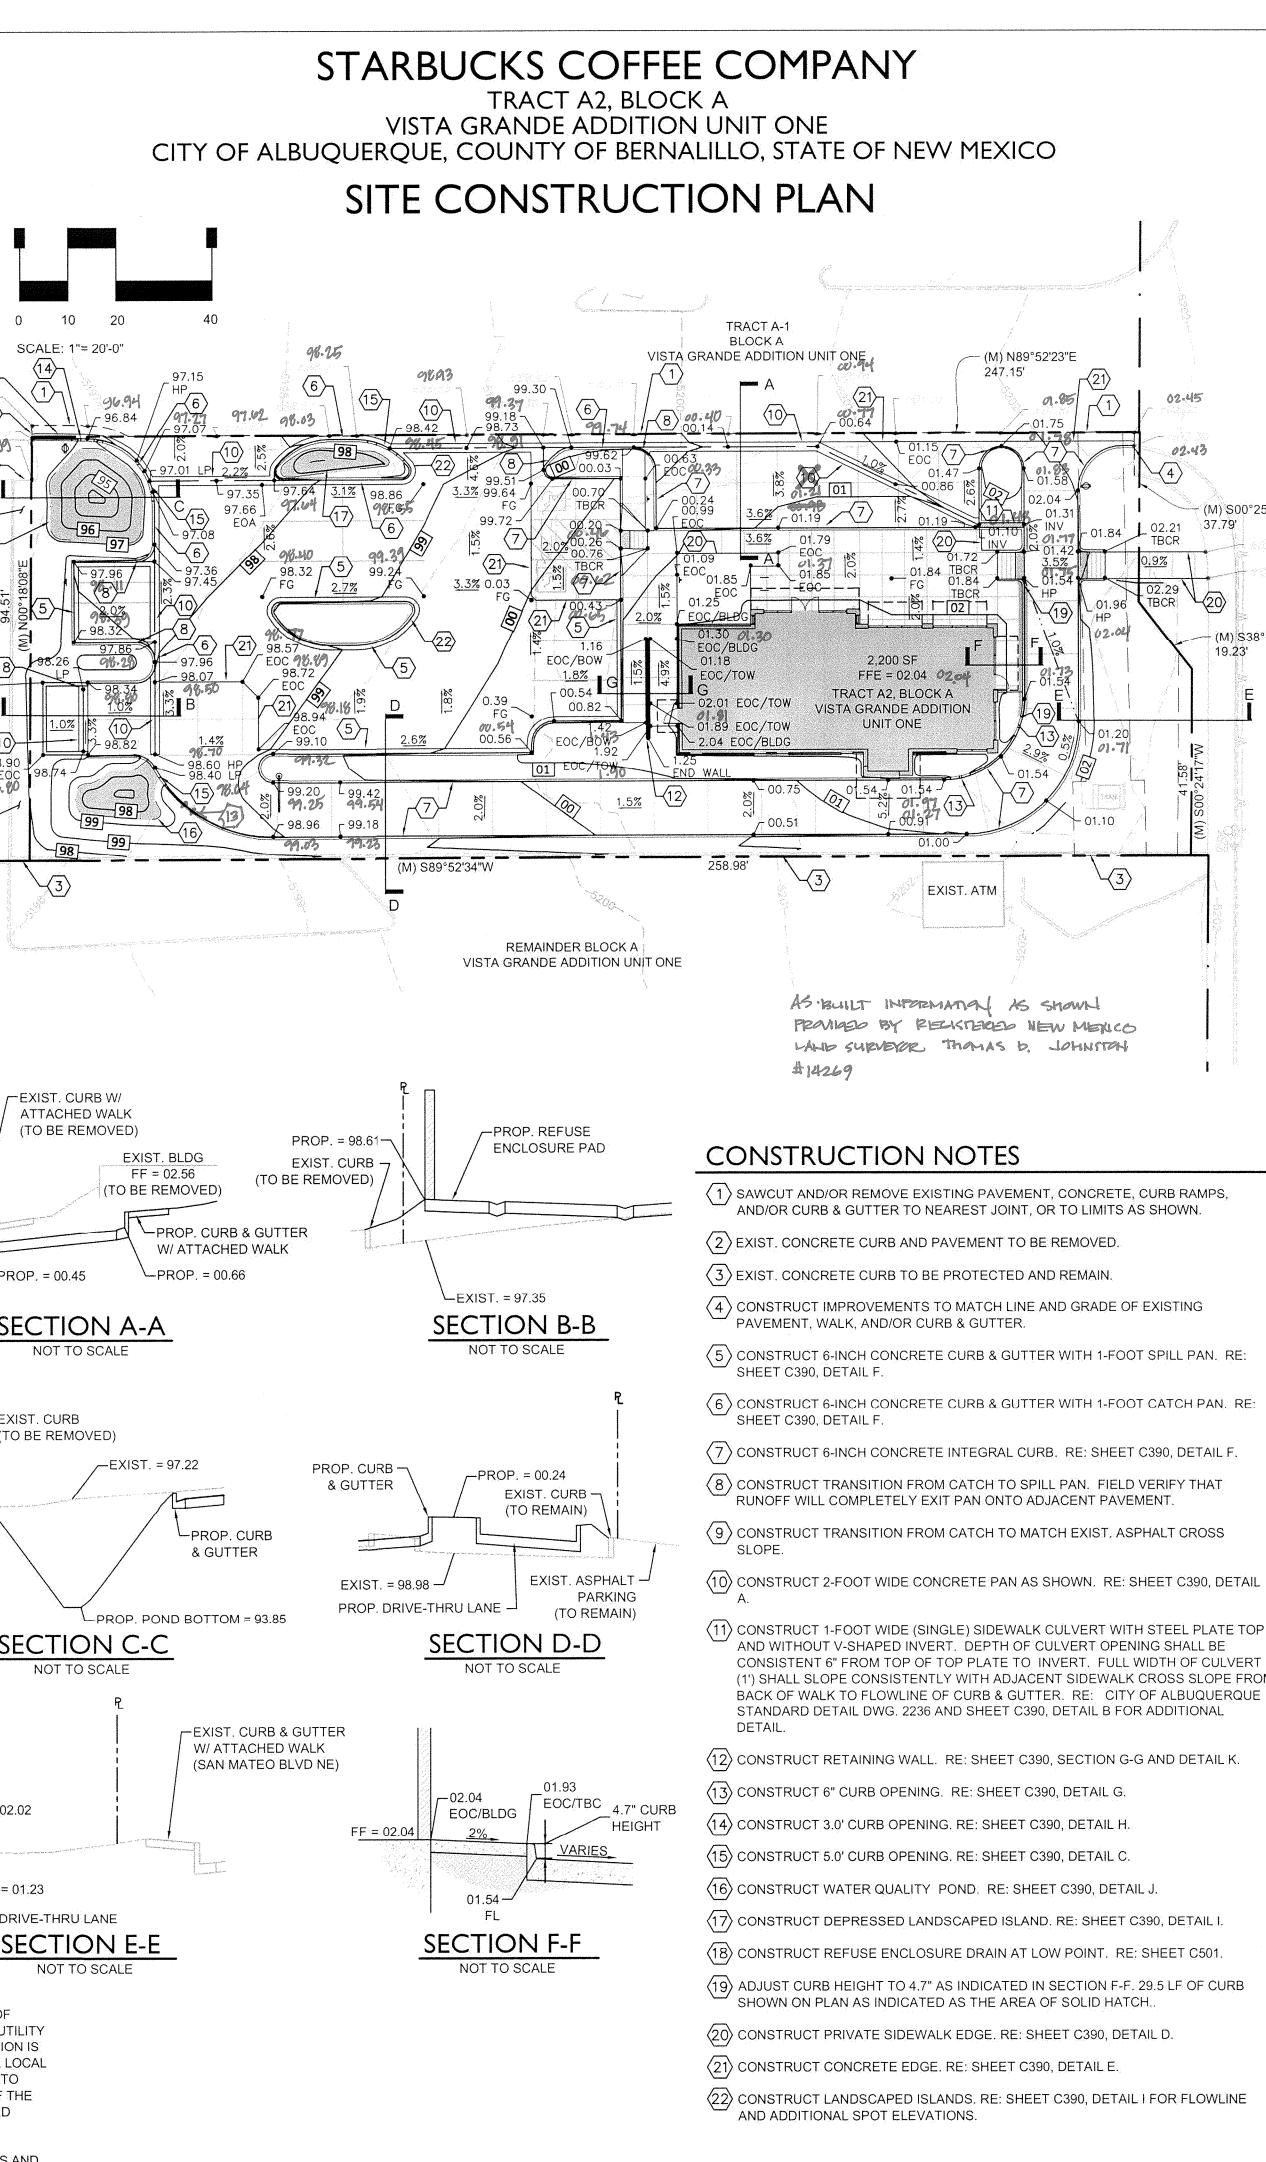


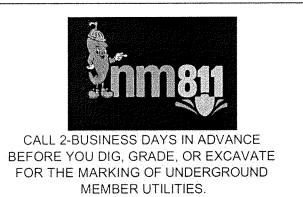



CAUTION - NOTICE TO CONTRACTOR


THE CONTRACTOR IS SPECIFICALLY CAUTIONED THAT THE LOCATION AND/OR ELEVATION OF EXISTING UTILITIES AS SHOWN ON THESE PLANS IS BASED ON RECORDS OF THE VARIOUS UTILITY COMPANIES AND, WHERE POSSIBLE, MEASUREMENTS TAKEN IN THE FIELD. THE INFORMATION IS NOT TO BE RELIED ON AS BEING EXACT OR COMPLETE. THE CONTRACTOR MUST CALL THE LOCAL UTILITY LOCATION CENTER (1-800-245-4545) AT LEAST 48 HOURS BEFORE ANY EXCAVATION TO REQUEST EXACT FIELD LOCATIONS OF THE UTILITIES. IT SHALL BE THE RESPONSIBILITY OF THE CONTRACTOR TO RELOCATE ALL EXISTING UTILITIES WHICH CONFLICT WITH THE PROPOSED IMPROVEMENTS SHOWN ON THE PLANS.


THE CONTRACTOR SHALL BE RESPONSIBLE FOR ANY DAMAGE TO EXISTING IMPROVEMENTS AND UTILITIES AND SHALL REPAIR ANY DAMAGE AT HIS EXPENSE.

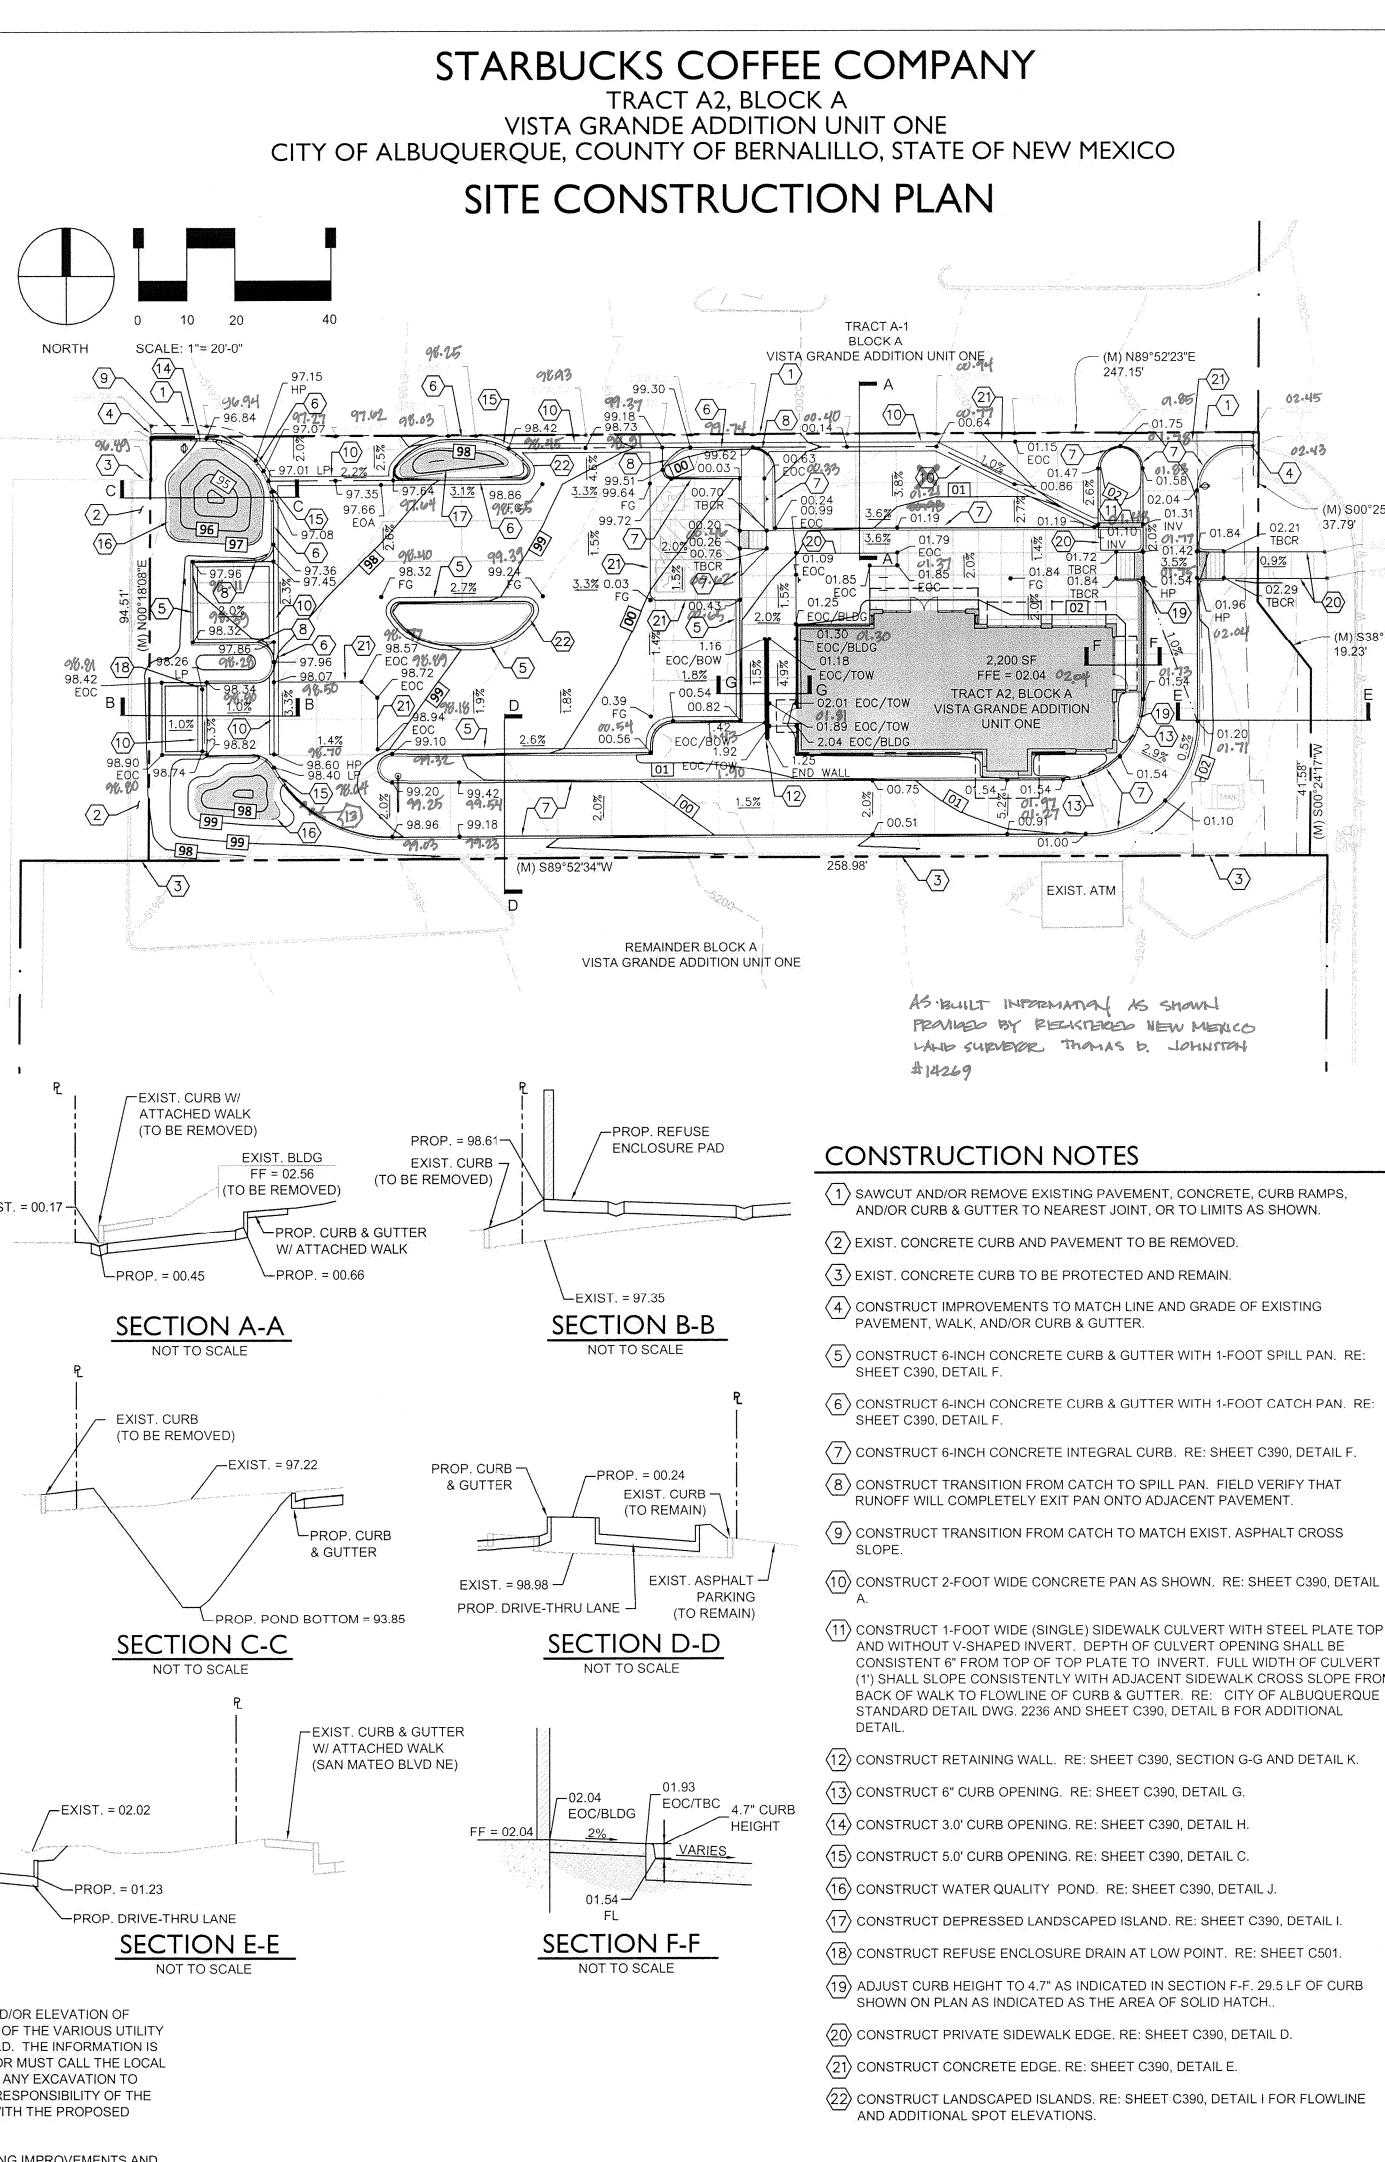

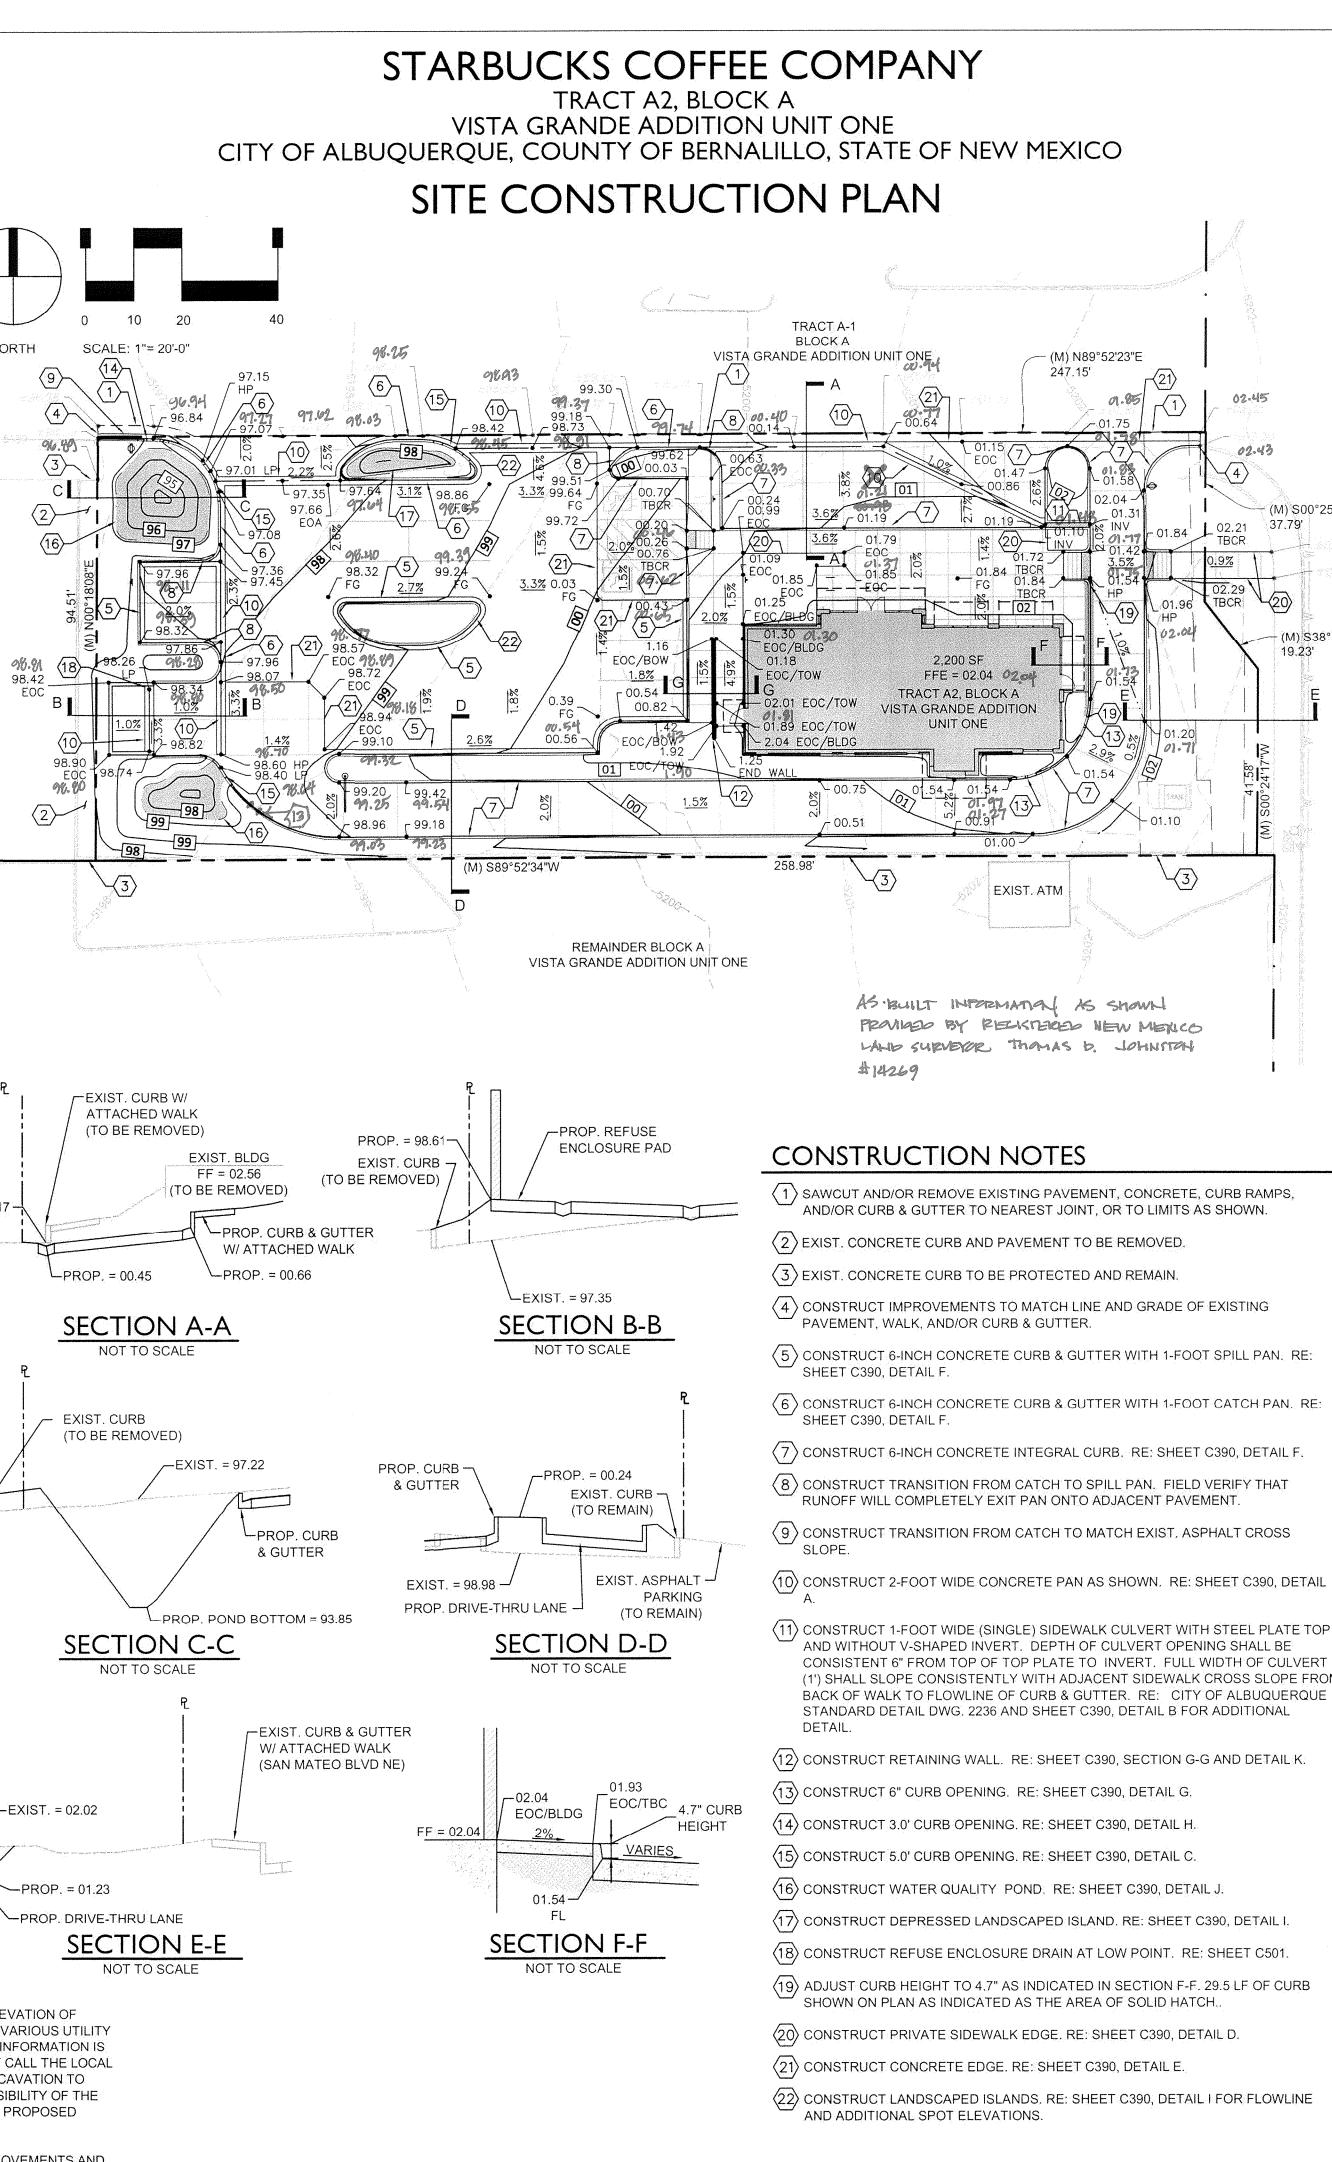

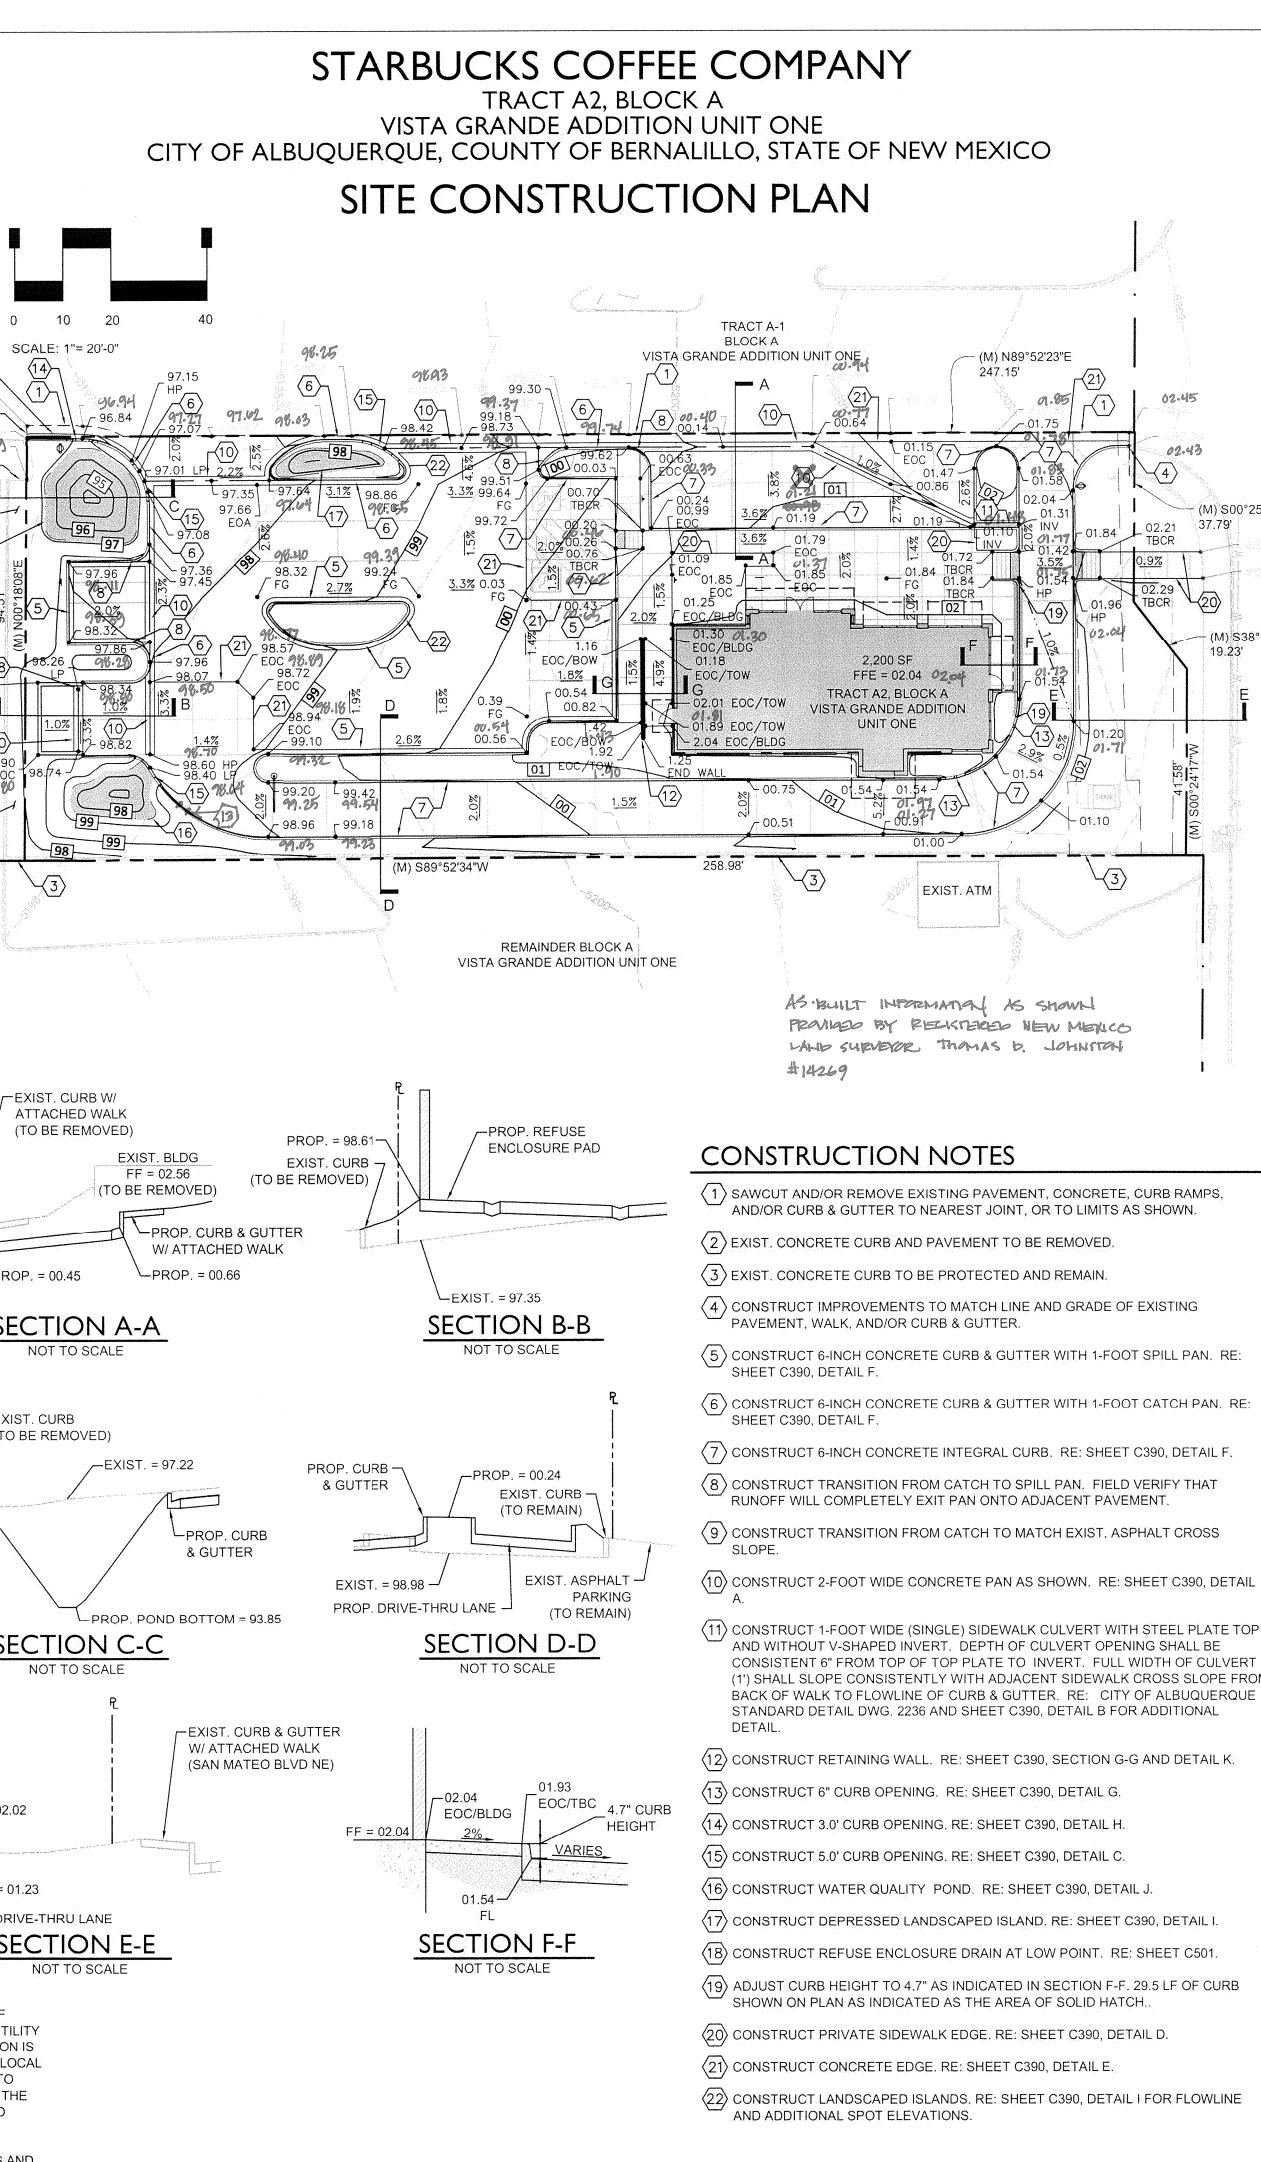

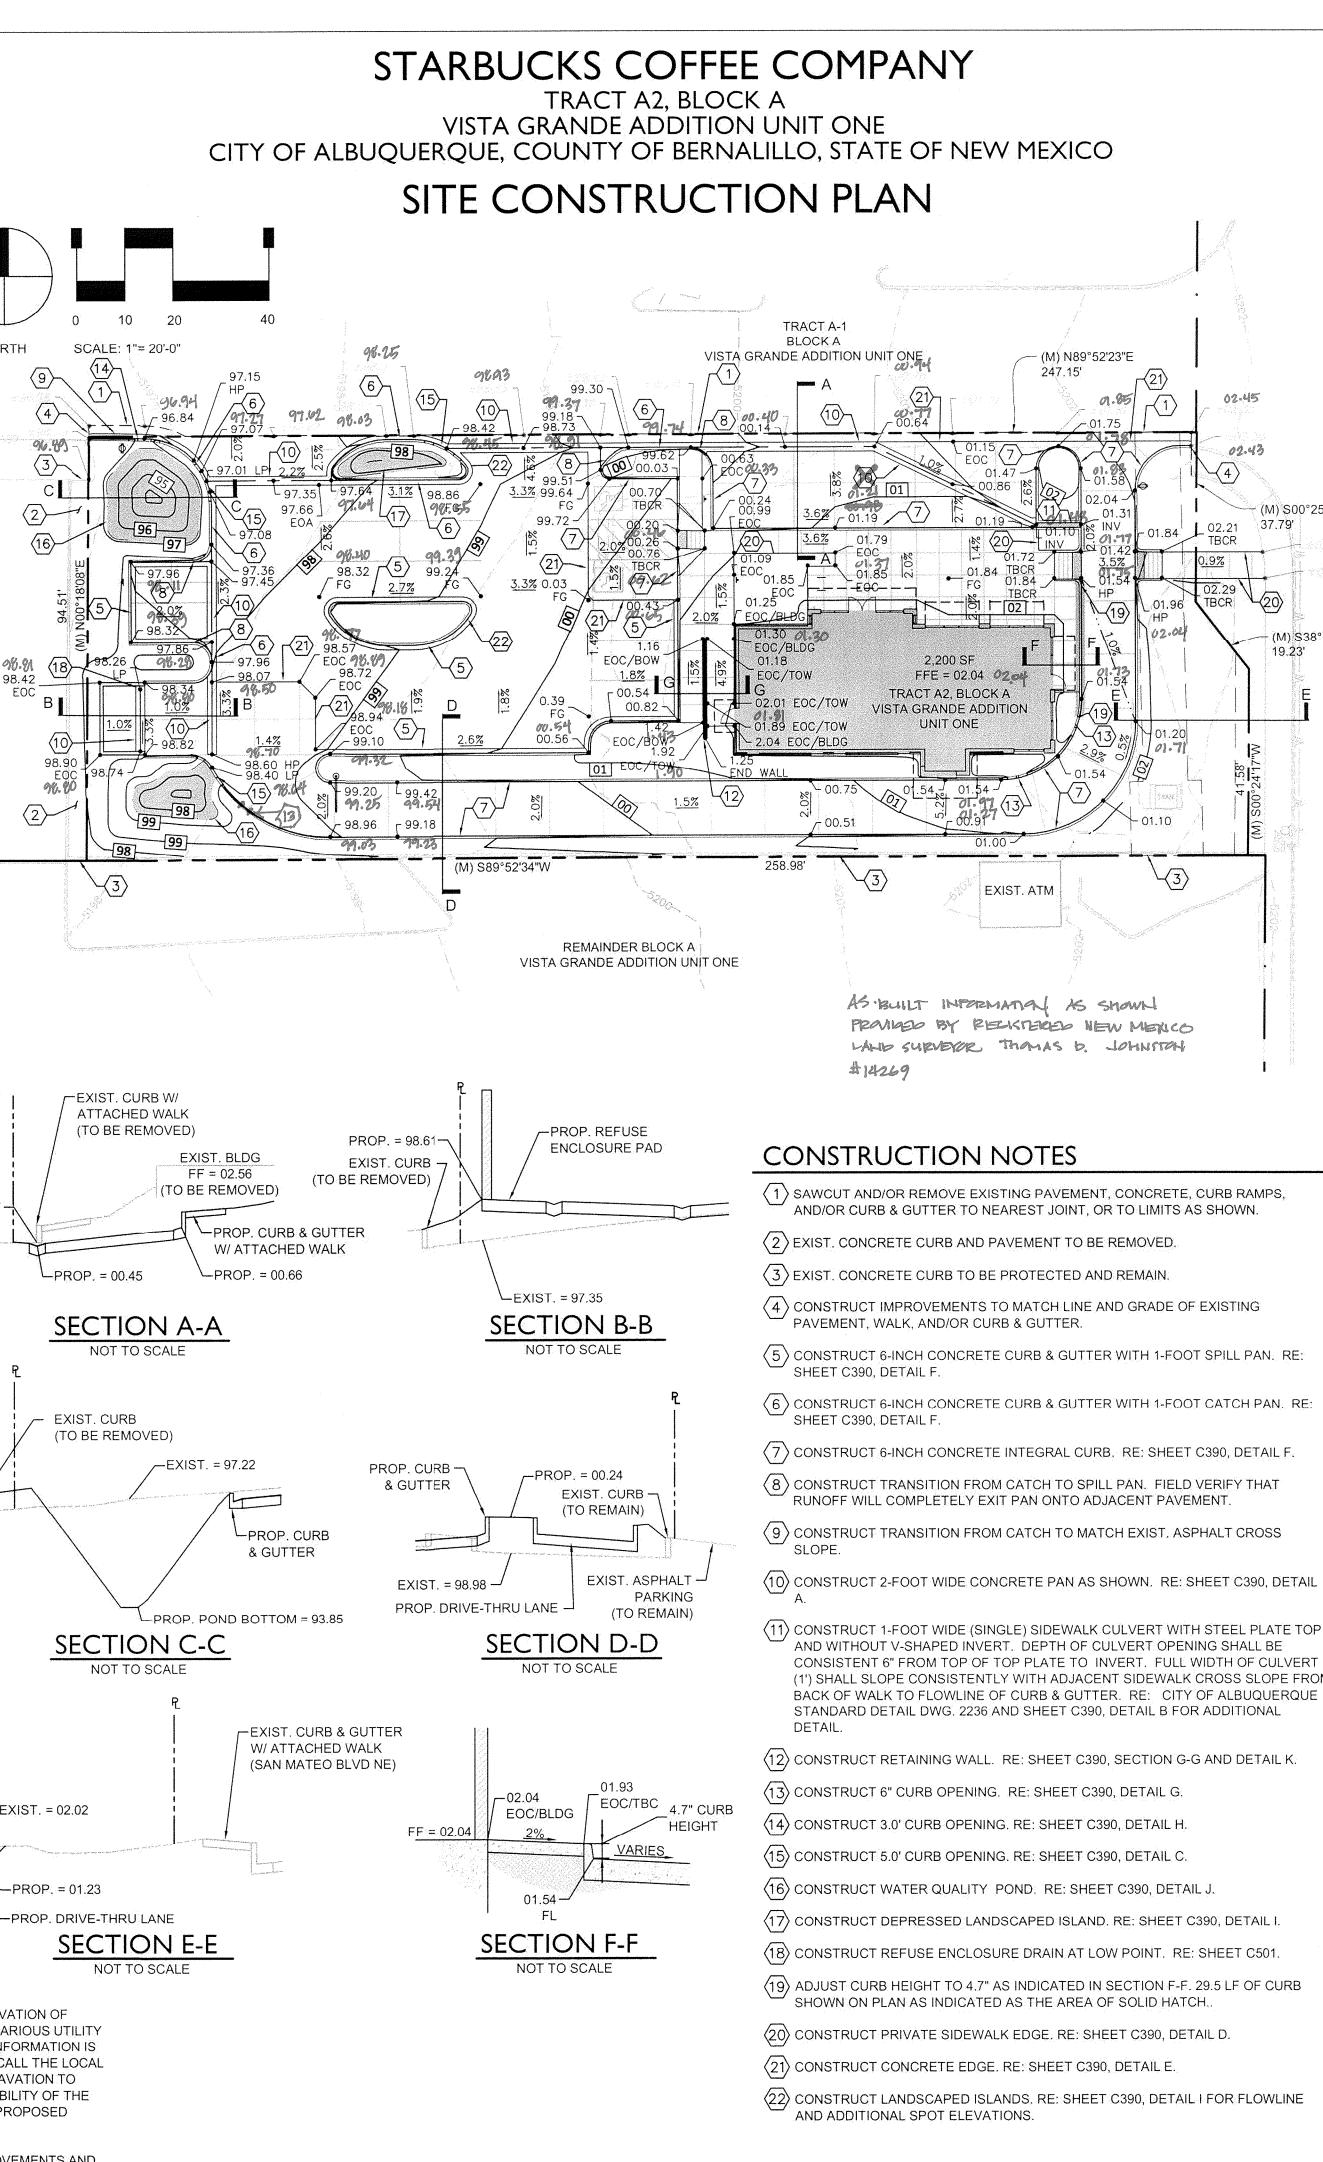

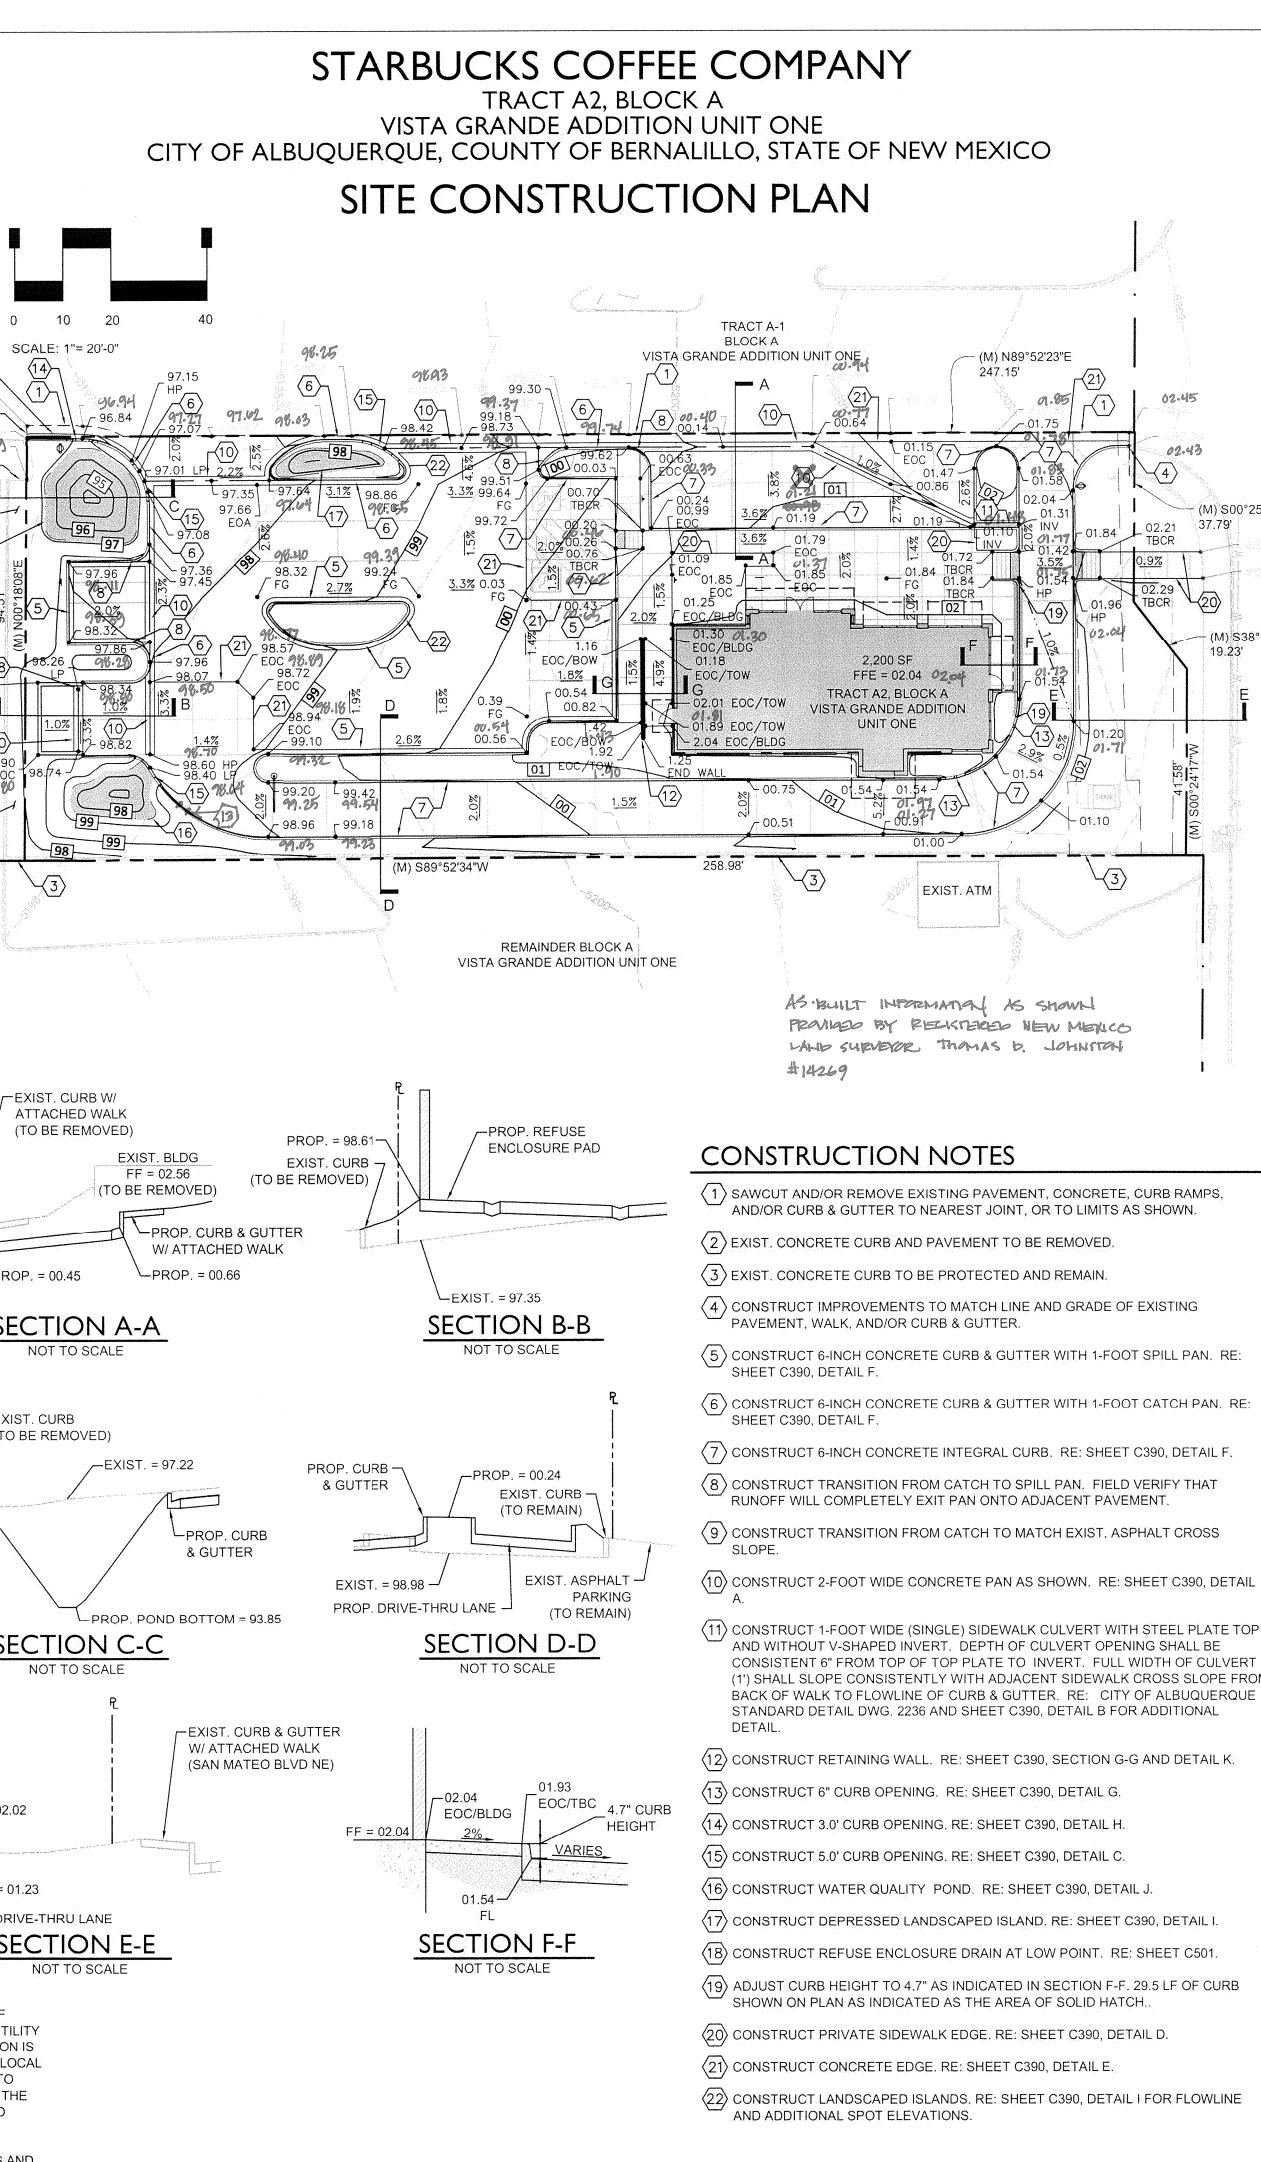

LEGEND



EASEMENT LINE EXIST. CURB & GUTTER PROP. CURB & GUTTER EXIST. SIDEWALK PROP. SIDEWALK EXIST, LIGHT POLE PROP. LIGHT POLE EXIST. SIGN PROP. SIGN PROP. BOLLARD LANSCAPE AREA

PROP. HANDICAP PARKING SYMBOL

EXIST. OVERHEAD POWER EXIST. WATER VALVE EXIST. POWER POLE EXIST. FIRE HYDRANT EXIST. ELECTRIC METER EXIST. TRAFFIC SIGNAL BOX EXIST. ELECTRIC VAULT EXIST. TRAFFIC SIGNAL POLE EXIST. MANHOLE EXIST. INLET EXIST. TRANSFORMER

PROP. CONTOUR EXIST. CONTOUR PROP. SAWCUT LINE PROP. SPOT ELEVATION EXIST. SPOT ELEVATION

ABBREVIATION KEY

INV. EOC TBCR BLDG TOW BOW FG HP IP TBC BTM POND

EOA

INVERT EDGE OF CONCRETE TOP BACK OF CURB RAMP GRADE AT BUILDING TOP OF WALL BOTTOM OF WALL **FINISHED GRADE** HIGH POINT LOW POINT TOP BACK OF CURB BOTTOM POND EDGE OF ASPHALT

DRAINAGE SUMMARY (RE: SHEET C390 FOR ADDTL INFO.)


LOT AREA	= 0.55 A		
LOT IMPE	= 17,248		
FIRST FLU (0.34" X I№	= 489 CF		
FIRST FLU	JSH VOLUMI	E PROVIDED	= 537.5 (
POND #1			POND #
ELEV (FT)	AREA (SF)	VOLUME (CF)	ELEV (FT)
93.85 94.0 95.0 96.0 96.85	3.3 7.7 73.3 206.6 368.4	0.8 35.7 170.0 411.1	96.80 97.0 98.0 98.40
DEP. LAN	DSCAPED IS	LAND #1	
	AREA	VOLUME	

= 0.55 AC	RE		
= 17,248 SF (0.40 ACRE)			
= 489 CF			
= 537.5 CI	=.		
POND #2			
ELEV (FT)	AREA (SF)	VOLUME (CF)	
96.80 97.0	0.0 6.8	0.5 41.8	

DEP. LAN	IDSCAPED IS	SLAND #1
ELEV (FT)	AREA (SF)	VOLUME (CF)
97.25 98.0 98.18	0.4 68.6 104.8	18.6 34.0

92.2 92.4 164.4

VICINITY MAP

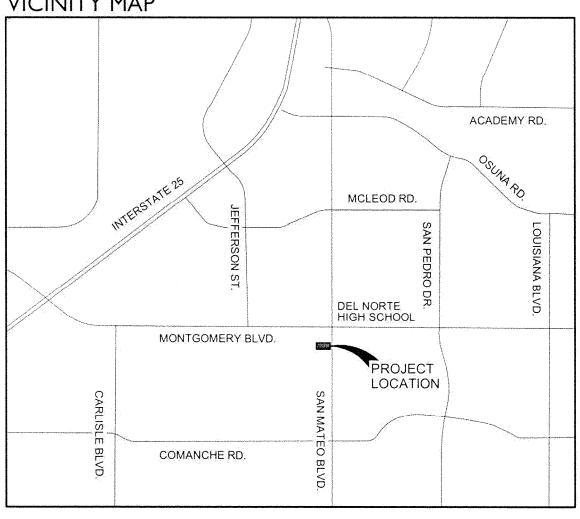

I have reviewed copies of the Grading As-Built, dated October 6, 2015, and the Grading As-Built, dated October 21, 2015, both prepared and stamped by Thomas D. Johnston, New Mexico Registered Land Surveyor No. 14269.

The review is intended only to determine if the improvements as described solely by the as-built plans are in substantial compliance with the overall design intent of the grading and drainage aspects of the project as described on the approved plan(s) and in support of a request for a Certificate of Occupancy.


Upon review it has been found that the ponds and depressed landscape island are complete. Concrete pan(s) are noted on the as-built as not constructed. Other deviations from the grading and drainage design described on the approved plan(s) represent discrepancies which are minor in nature and/or should impact maintenance of the property rather than the overall drainage design intent.

Based on the review described herein, of the information listed herein, and of this information only; it appears the completed improvements as described herein, associated with the grading and drainage aspects of the project have been graded and will drain in substantial compliance with the overall design intent of the approved plan(s).



2009 W. Littleton Blvd. #300 Littleton, CO 80120 303.794.4727 ph www.SterlingDesignAssociates.com

PREPARED UNDER THE DIRECT SUPERVISION OF JAY M. NEWELL, P.E. NEW MEXICO REGISTRATION NO. 21372 FOR & ON BEHALF OF STERLING DESIGN ASSOCIATES, LLC

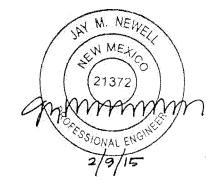

STERLING DESIGN ASSOCIATES, LLC

NO.: 1	DATE: -10/23/15	BY: - MA
DESCRIP	DATE: - 10/23/15 TION: - AS-1941LT	
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DATE: 02/09/15	SCALE: 1" = 20'-0"	
PROJECT MANAGER:	PROJECT NO.:	
JLO	-	
DRAWN BY:	DRAWING FILE:	
OKK	-	

PROJECT:

04518-042

STARBUCKS DRIVE-THRU 4301 SAN MATEO BLVD. NE ALBUQUERQUE, NM 87110

DEVELOPER:

STARBUCKS COFFEE COMPANY 2401 UTAH AVENUE SOUTH SEATTLE, WA 98134

(206) 318-1575


SHEET TITLE:

GRADING & DRAINAGE PLAN

AS·BUILT

SHEET NUMBER:

C301

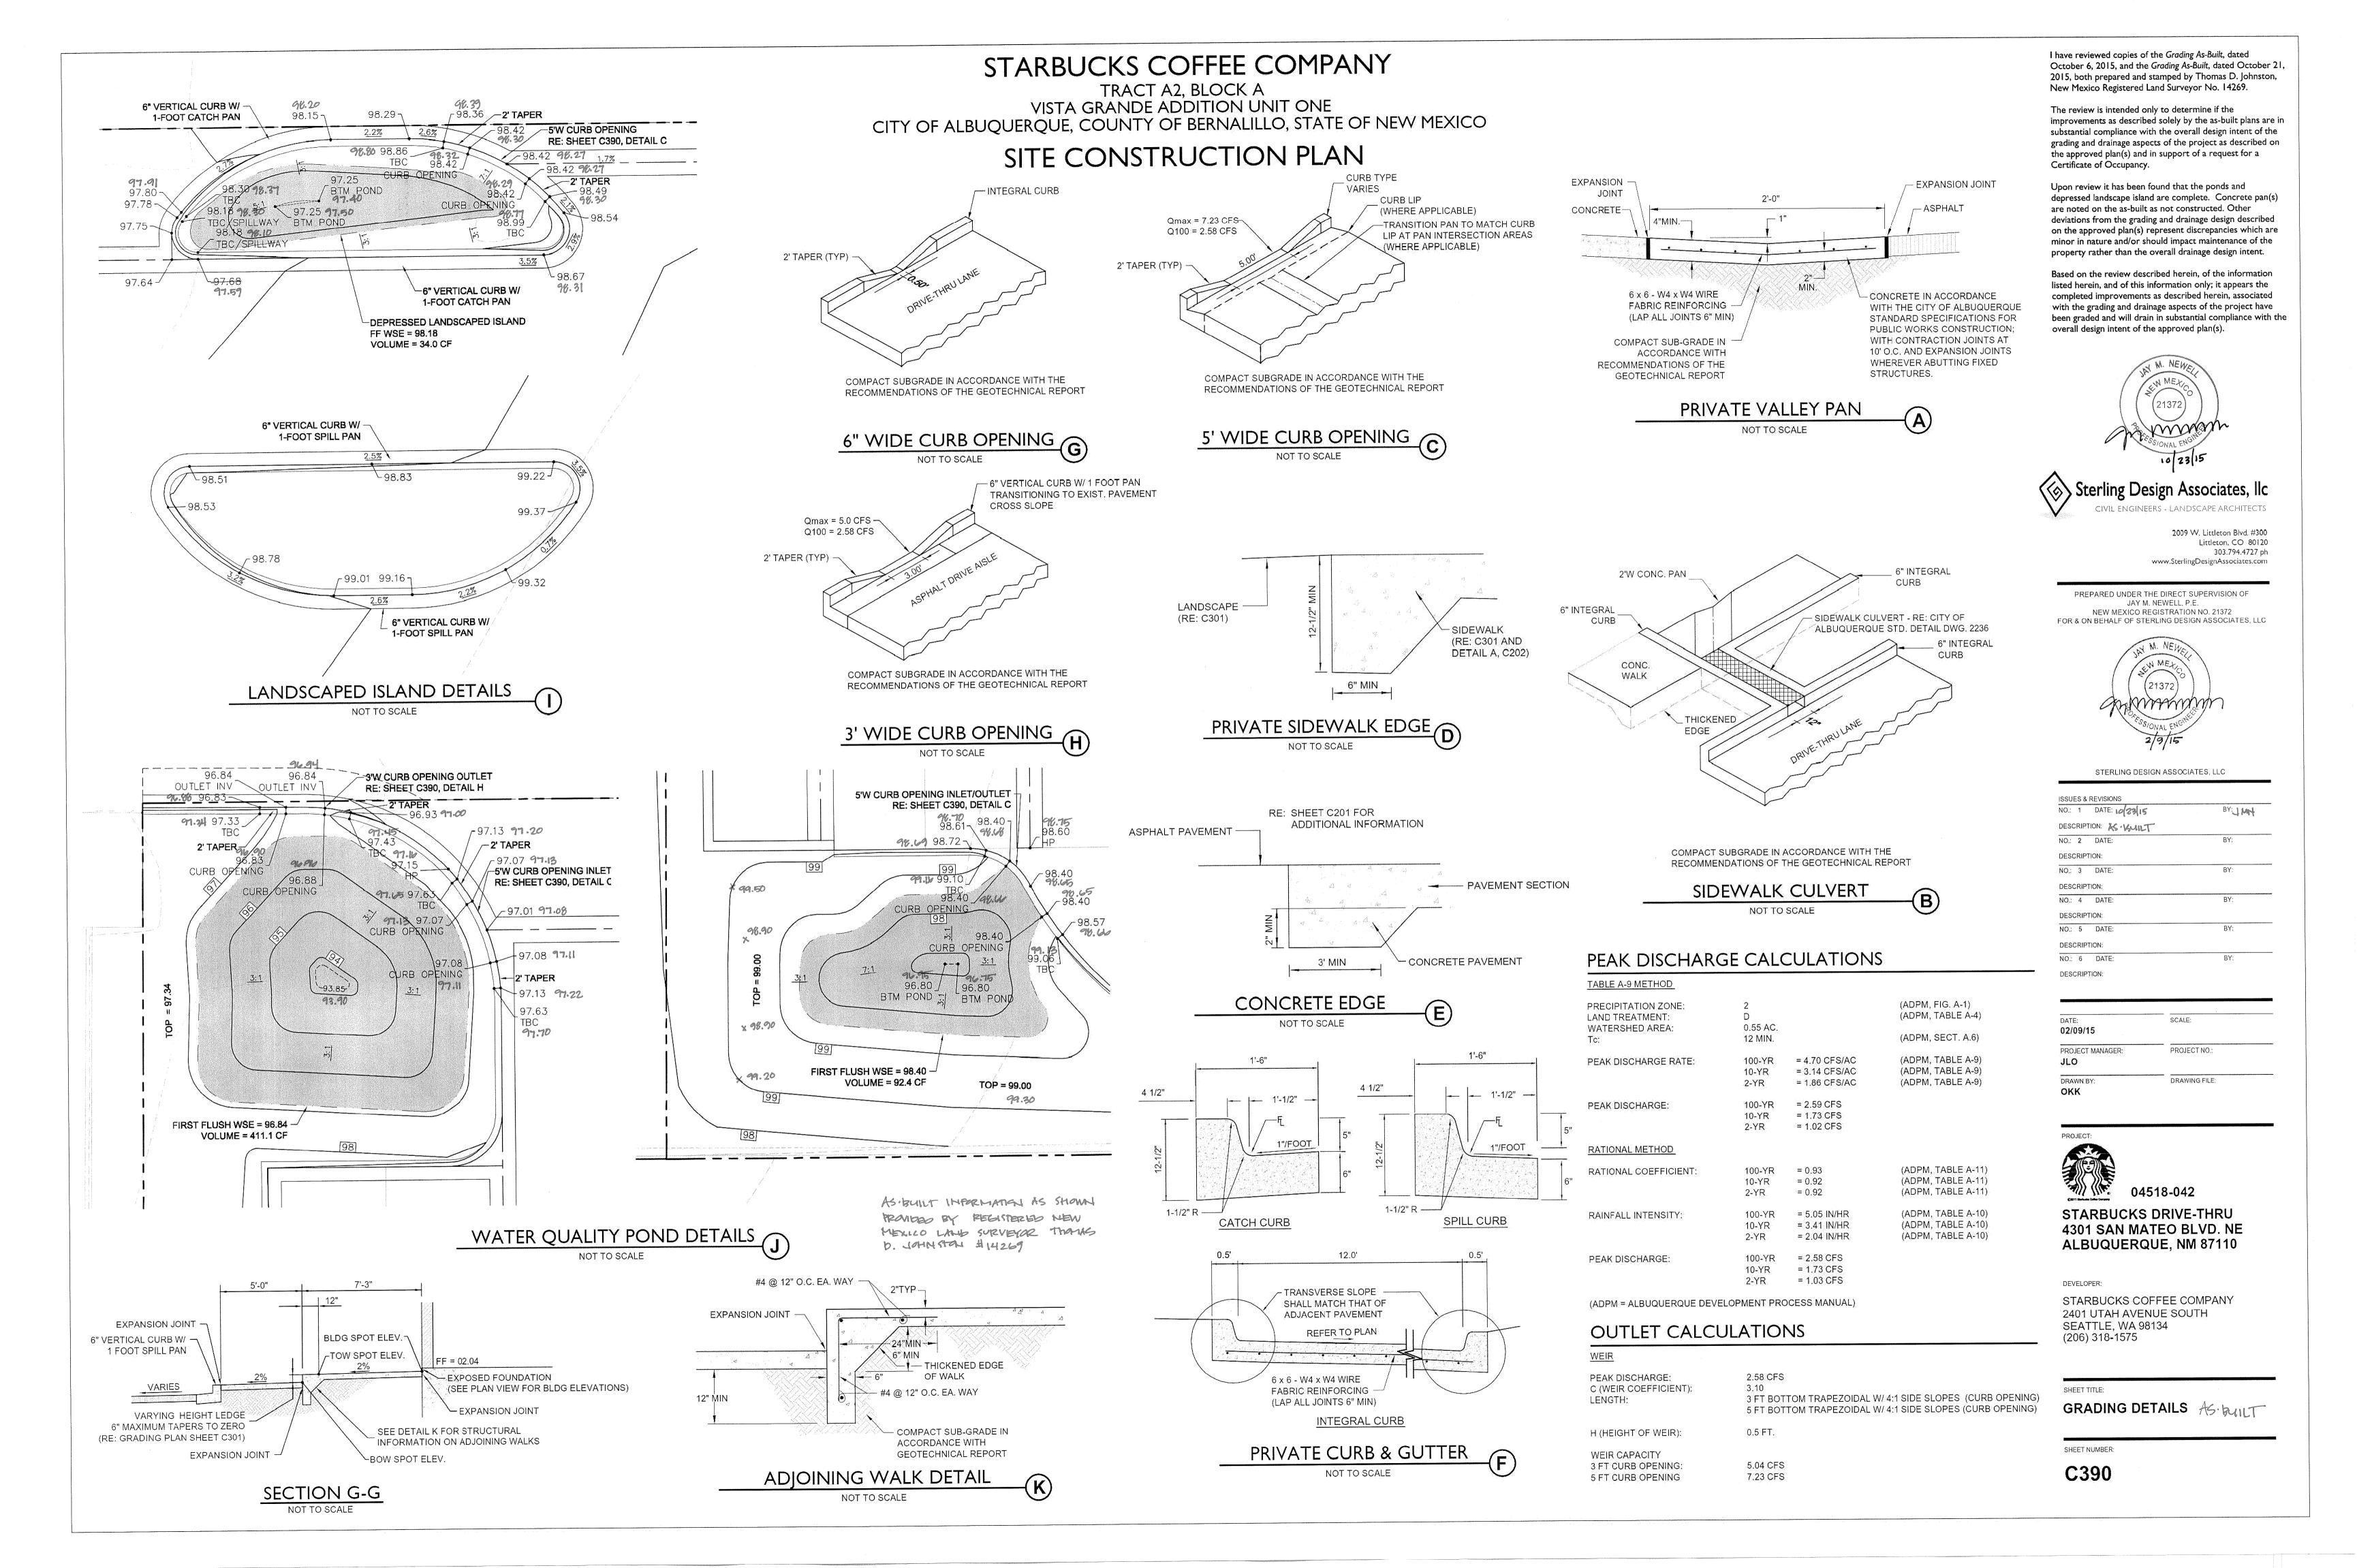



City of Albuquerque

Planning Department Development & Building Services Division DRAINAGE AND TRANSPORTATION INFORMATION SHEET (REV 09/2015)

Project Title: Starbucks Cafe & Drive Thru	Building Permit #:	City Drainage #: G17-D006C
DRB#: EPC#:		Work Order#:
Legal Description: Track A-2, Block A, Vista Grande Addition Unit 1		
City Address: 4301 San Mateo Blvd., Albuquerque, NM 87110		
		Contact: Jay Newell
Phone#: 303-794-4727 Ext. 203 Fax#:		E-mail: jay@sterlingdesignassociates.com
Owner: Western States Retail & Investment Address:		Contact: Alfredo Barrenech
		E-mail: alfredo@go-absolute.net
Architect:CallisonAddress:1453 Third St. Promenade, #400, Santa Monica, CA 90401		Contact: Shane Anderson
		E muile shape and rean @ callisent/l.com
Phone#: <u>310-394-8460</u> Fax#:		E-mail: shane.anderson@callisontkl.com
Other Contact: Wayjohn Surveying		Contact: Thomas Johnston
Address: 330 Louisiana Blvd. NE, Albuquerque, NM 87108		
Phone#: 505-255-2052 Fax#:		E-mail: info@wayjohn.com
DEPARTMENT: X HYDROLOGY/ DRAINAGE TRAFFIC/ TRANSPORTATION MS4/ EROSION & SEDIMENT CONTROL	BUILDING P	APPROVAL/ACCEPTANCE SOUGHT: ERMIT APPROVAL E OF OCCUPANCY
TYPE OF SUBMITTAL:		
<u>X</u> ENGINEER/ ARCHITECT CERTIFICATION		RY PLAT APPROVAL
		FOR SUB'D APPROVAL FOR BLDG. PERMIT APPROVAL
CONCEPTUAL G & D PLAN	FINAL PLAN	
X GRADING PLAN		SE OF FINANCIAL GUARANTEE
DRAINAGE MASTER PLAN		N PERMIT APPROVAL
DRAINAGE REPORT	GRADING PERMIT APPROVAL	
CLOMR/LOMR	SO-19 APPR	OVAL
	PAVING PER	RMIT APPROVAL
TRAFFIC CIRCULATION LAYOUT (TCL)	GRADING/ P	AD CERTIFICATION
TRAFFIC IMPACT STUDY (TIS) EROSION & SEDIMENT CONTROL PLAN (ESC)	WORK ORDER APPROVAL	
EROSION & SEDIMENT CONTROL PLAN (ESC)	CLOMR/LON	1R
OTHER (SPECIFY)	DDE DEGICNU	MEETING
	PRE-DESIGN	ECIFY)
IS THIS A RESUBMITTAL?: <u>Yes</u> <u>X</u> No		(in 1)
DATE SUBMITTED: October 13, 2015 By: Jay M. Ne	well	

COA STAFF: ELECTRONIC SUBMITTAL RECEIVED: ____