

#### GENERAL NOTES

- CONTRACTOR TO VERIFY EXISTING IMPROVEMENTS SHOWN ON THE PLAN.
- 2. CONTRACTOR TO PROTECT IN PLACE, DURING DEMOLITION AND CONSTRUCTION, ALL EXISTING IMPROVEMENTS THAT ARE TO REMAIN AS NOTED ON THE PLAN.
- 3. ANY EXISTING STRUCTURE, IMPROVEMENT OR APPURTENANCE TO REMAIN THAT IS DAMAGED DURING DEMOLITION OR CONSTRUCTION SHALL BE IMMEDIATELY REPAIRED OR REPLACED BY THE CONTRACTOR AT THE CONTRACTOR'S EXPENSE.
- 4. CONTRACTOR SHALL VERIFY AND LOCATE ALL EXISTING UNDERGROUND UTILITIES BEFORE CONSTRUCTION AND PROTECT IN PLACE UNLESS NOTES ON THE PLANS.
- 5. THE CONTRACTOR SHALL EXERCISE CAUTION TECHNIQUES TO PROTECT AND PRESERVE EXISTING PERMANENT SURVEY MONUMENTS. ALL SURVEY MONUMENTS DISTURBED (PROPOSED AND EXISTING) SHALL BE REPLACED AND/OR REHABILITATED IN ACCORDANCE WITH STANDARDS BY A PROFESSIONAL LAND SURVEYOR RETAINED BY THE CONTRACTOR.

#### SITE DATA


LOT AREA	55,027 SF ± 1.26 AC
TOTAL DISTURBED AREA	69,241 SF ± 1.59 AC
DISTURBED AREA OFFICIAL	50,168 SF ± 1.15 AC
DISTURBED AREA OFFSITE	19,073 SF ± 0.44 AC


#### 24-HR EMERGENCY CONTACT

RAISING CANE'S RESTAURANTS, LLC ROBERT MONTGOMERY (972) 769-3357

#### CITY OF ALBUQUERQUE EROSION CONTROL NOTES

- 1. ALL EROSION AND SEDIMENT CONTROL (ESC) WORK ON THESE PLANS, EXCEPT AS OTHERWISE STATED OR PROVIDED HEREON SHALL BE PERMITTED, CONSTRUCTED, INSPECTED, AND MAINTAINED IN ACCORDNACE WITH:
  - A. THE CITY ORDINANCE § 14-5-2-11, THE ESC ORDINANCE,
    B. THE EPA'S 2017 CONSTRUCTION GENERAL PERMIT (CGP) AND
  - B. THE EPA'S 2017 CONSTRUCTION GENERAL PERMIT (CGP) ANI
    C. THE CITY OF ALBUQUERQUE CONSTRUCTION BMP MANUAL
- 2. ALL BMP'S MUST BE INSTALLED PRIOR TO BEGINNING ANY EARTH MOVING ACTIVITIES EXCEPT AS SPECIFIED HEREON IN THE PHASING PLAN. CONSTRUCTION OF EARTHEN BMP'S SUCH AS SEDIMENT TRAPS, SEDIMENT BASINS, AND DIVERSION BERMS SHALL BE COMPLETED AND INSPECTED PRIOR TO ANY OTHER CONSTRUCTION OR EARTHWORK. SELF-INSPECTION IS REQUIRED AFTER INSTALLATION OF THE BMP'S AND PRIOR TO BEGINNING CONSTRUCTION.
- 3. SELF-INSPECTIONS AT A MINIMUM A ROUTINE COMPLIANCE SELF-INSPECTION IS REQUIRED TO REVIEW THE PROJECT FOR COMPLIANCE WITH THE CONSTRUCTION GENERAL PERMIT ONCE EVERY 14 DAYS AND AFTER ANY PRECIPITATION EVENT OF 1/4 INCH OR GREATER UNTIL THE SITE CONSTRUCTION HAS BEEN COMPLETED AND THE SITE DETERMINED AS STABILIZED BY THE CITY. REPORTS OF THESE INSPECTIONS SHALL BE KEPT BY THE PERSON OR ENTITY AUTHORIZED TO DIRECT THE CONSTRUCTION ACTIVITIES ON THE SITE AND MADE AVAILABLE UPON REQUEST.
- 4. CORRECTIVE ACTION REPORTS MUST BE KEPT BY THE PERSON OR ENTITY AUTHORIZED TO DIRECT THE CONSTRUCTION ACTIVITIES ON THE SITE AND MADE AVAILABLE UPON REQUEST.
- 5. STABILIZATION REPORTS MUST BE KEPT BY THE PERSON OR ENTITY AUTHORIZED TO DIRECT THE CONSTRUCTION ACTIVITIES ON THE SITE AND MADE AVAILABLE UPON REQUEST. REPORTS SHOULD INCLUDE RECORDS OF WEED REMOVAL PER CITY ORDINANCE (§ 9-8-1), STERILIZATION, SOIL TEST RESULTS AND RECOMMENDATION, MATERIALS AND MANUFACTURER'S SPECIFICATIONS FOR APPLICATION RATES, ESTIMATED FUNCTIONAL LONGEVITY, METHODS OF APPLICATION, INSPECTION AND MAINTENANCE. THE REDUCED SELF-INSPECTION SCHEDULE IN CGP 4.4.1 APPLIES TO STABILIZED AREA AND ANY DAMAGED OR WORN STABILIZATION MUST BE IDENTIFIED IN THE REPORTS ALONG WITH WEED PROBLEMS. CORRECTIVE ACTIONS FOR STABILIZATION SHALL BE DOCUMENTED IN A STABILIZATION REPORT INCLUDING ACTUAL RATES AND DATES OF STABILIZATION, AND THE MATERIALS AND MANUFACTURER'S SPECIFICATIONS USED.
- 6. BMPS SHALL BE INSPECTED AND MAINTAINED UNTIL ALL DISTURBED AREAS ARE STABILIZED IN ACCORDANCE WITH THE FINAL STABILIZATION CRITERIA (GCP 2.2.14.B). GENERALLY, ALL DISTURBED AREAS, OTHER THAN STRUCTURES AND IMPERVIOUS SURFACES, MUST HAVE UNIFORM PERENNIAL VEGETATION THAT PROVIDES 70 PERCENT OR MORE OF THE COVER PROVIDED BY NATIVE VEGETATION OR SEED THE DISTURBED AREA AND PROVIDE NON-VEGETATIVE MULCH THAT PROVIDES COVER FOR AT LEAST THREE YEARS WITHOUT ACTIVE MAINTENANCE. FINAL STABILIZATION MUST BE APPROVED BY THE CITY OF ALBUQUERQUE PRIOR TO REMOVAL OF BMPS AND DISCONTINUATION OF INSPECTIONS.

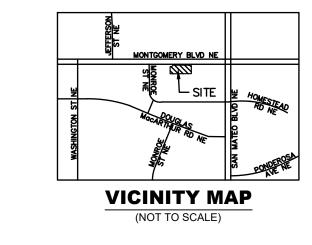

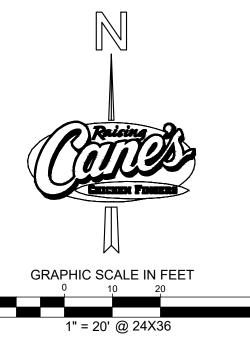

#### LEGEND

PROPERTY LINE

EXISTING CONTOL

PROPOSED STORM PIPE

PROPOSED LIMITS OF LAND-DISTURBING ACTIVITIES

CHIT FENOR TYPE LOSE DETAIL

SF SILT FENCE, TYPE I - SEE DETAIL SHEET
C3.2
CE CONSTRUCTION EXIT/ OFFSITE TRACKING

SP) TEMPORARY SEDIMENTATION POND

RR RIP RAP WITH FILTER FABRIC

ST STOCKPILE

#### SITE SOILS

ALL SOILS ONSITE ARE TYPE EMB, EMBUDO GRAVELLY FINE SANDY LOAM, 0 TO 5 PERCENT SLOPES, HYDROLOGIC SOIL GROUP A.

#### EROSION CONTROL SCHEDULE AND PHASING

THE PROJECT SHALL GENERALLY CONFORM TO THE FOLLOWING PHASING SCHEDULE. REFERENCE THE SWPPP BOOK AND NMED GENERAL PERMIT FOR DETAILED REQUIREMENTS.

#### PHASE 1 - DEMOLITION

- A. INSTALL PERIMETER BMPs INCLUDING THE CONSTRUCTION ENTRANCE/EXIT, SWPPP SIGNAGE, SILT FENCE, AND ALL OTHER NECESSARY BMPs ACCORDING TO THE LOCATION SHOWN ON THE EROSION CONTROL PLAN. CLEAR ONLY THE MINIMUM AREA REQUIRED TO INSTALL BMPs.
- B. SET THE PROJECT OFFICE TRAILER AND PREPARE TEMPORARY PARKING AND STORAGE AREAS.
- C. DENOTE DATES OF BMP INSTALLATION AND MAINTENANCE ON
- SITE-MAPS.
- D. BEGIN DEMOLITION AND CLEARING OF THE SITE.
  E. STABILIZATION OF DISTURBED AREAS MUST BE INITIATED WHENEVER CLEARING, GRADING, OR EARTH DISTURBING ACTIVITIES HAVE CEASED ON ANY PORTION OF THE SITE, OR TEMPORARILY CEASED

AND WILL NOT RESUME WITHIN 14 DAYS PER GENERAL PERMIT

# REQUIREMENTS. PHASE 2 - GRADING

- A. ENSURE APPROPRIATE BMPs ARE IN PLACE DOWNSTREAM OF SITE
- WORK OR WHERE RUNOFF MAY EXIT THE SITE.

  B. BEGIN GRADING THE SITE.
- C. SEED AND RE-VEGETATE SLOPES AS AREAS ARE BROUGHT TO GRADE
   OR STOCKPILES THAT WILL REMAIN INACTIVE FOR 14 DAYS PER
   GENERAL PERMIT REQUIREMENTS.

#### PHASE 3 - UTILITIES

- A. KEEP ALL STORM WATER POLLUTION PREVENTION MEASURES IN
- B. INSTALL UTILITIES, STORM DRAINS, CURB AND GUTTERS.C. INSTALL INLET PROTECTION AS SPECIFIED ON PLAN SHEETS AS
- STORM STRUCTURES ARE INSTALLED.

  D. TEMPORARILY STABILIZE, THROUGHOUT CONSTRUCTION, ANY
  DISTURBED AREAS THAT ARE LIKELY TO REMAIN INACTIVE FOR 14

### PHASE 4 - PAVING

- A. KEEP ALL STORM WATER POLLUTION PREVENTION MEASURES IN
- PLACE.
  B. STABILIZE SUBGRADE.
- C. PAVE PARKING LOT AND SIDEWALKS AS SPECIFIED ON PLAN SHEETS.

#### PHASE 5 - LANDSCAPING AND DEVELOPMENT

- A. INSTALL LANDSCAPING PER THE LANDSCAPE PLANS AND DETAILS.
  B. REMOVE EROSION CONTROL DEVICES WHEN FINAL STABILIZATION IS
- ACHIEVED PER THE TPDES GENERAL PERMIT.

  C. STABILIZE ANY AREAS DISTURBED BY REMOVAL OF BMPs.





Montgomery & San Mateo
ALBUQUERQUE, NM 87112
Restaurant #RC852
P4E-V-AV SCHEME A

Engineer's Information:

# **Kimley** » Horn

© 2022 KIMLEY-HORN AND ASSOCIATES, INC. 13455 Noel Road

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CONTACT: LAUREN NUFFER, P.E.

(972) 770-1300 LAUREN.NUFFER@KIMLEY-HORN.COM LIZ WILLMOT, P.E. LIZ.WILLMOT@KIMLEY-HORN.COM

Professional of Record:



Prototype: P4E-V-AV 2021- 2.0	RELEASE
Prototype Issue Date: 10	.04.2021
Kitchen Issue Date: 08	.02.2021
Design Bulletin Updates:	
Date Issued: Bulletin Number:	

#### 2ND BLDG. RESUBMITTAL

RE	VISIONS:	
	11/12/2021	80% REVIEW SET
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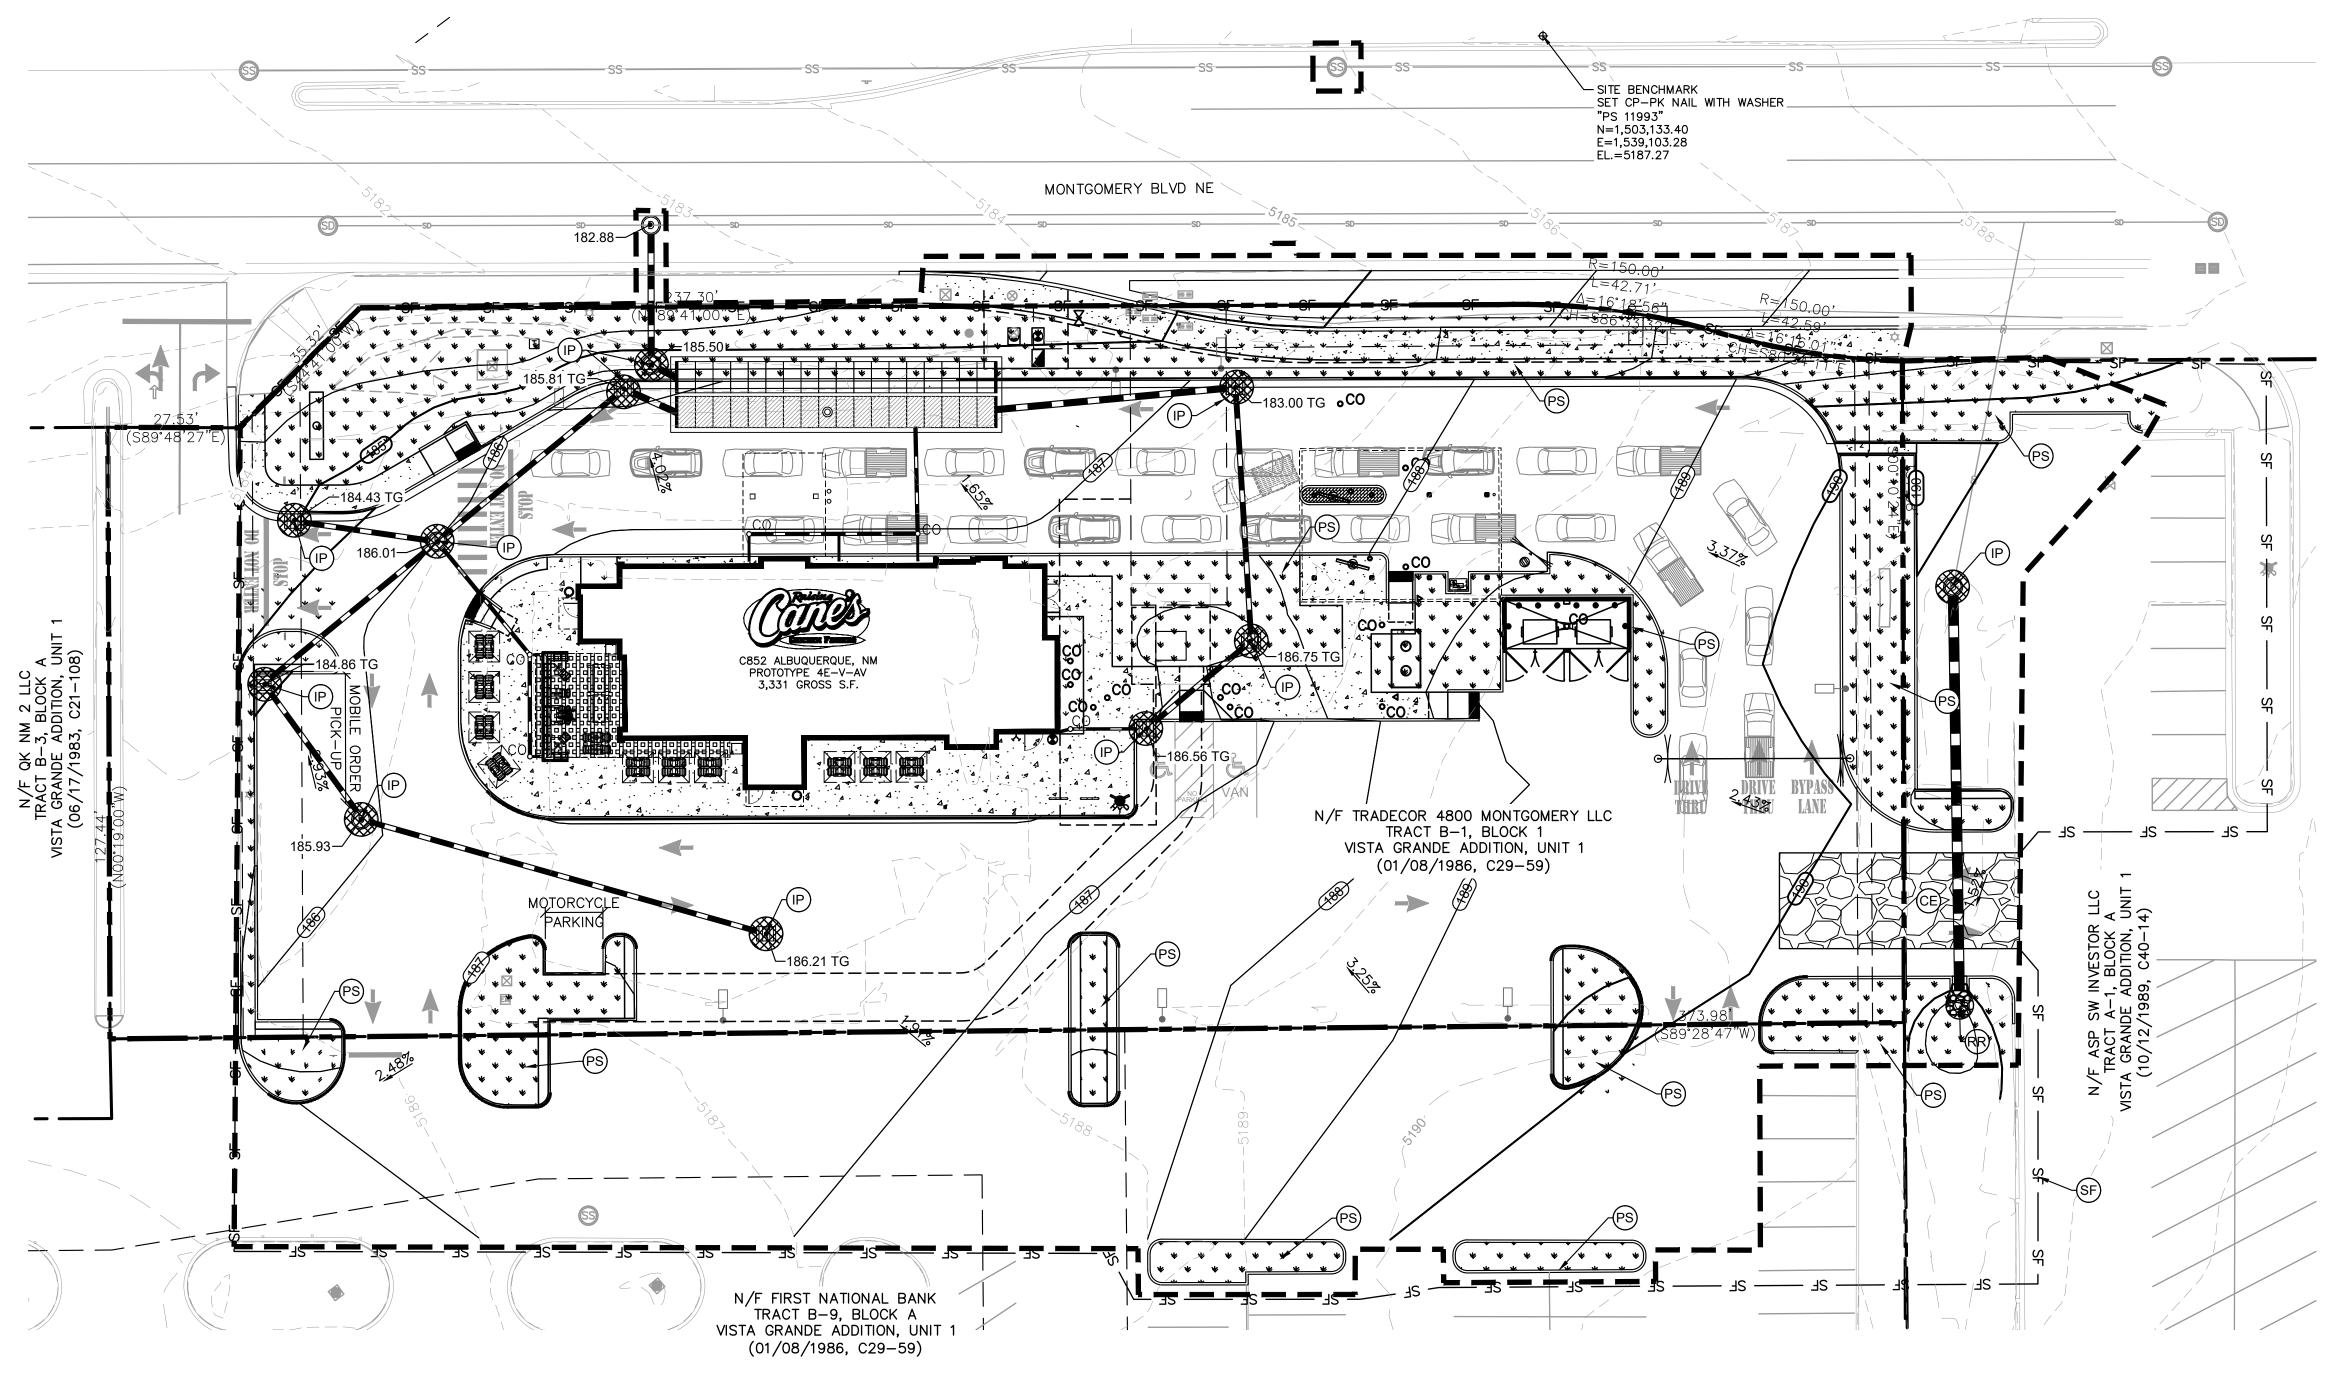
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### EROSION CONTROL PLAN PH. I

Date:	05.25.2022
Project Number:	090042000
Drawn By:	LW/LN

Sheet Number:

C3.0



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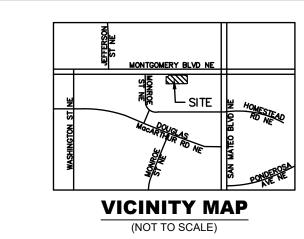
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1" = 20' @ 24X36

LEGEND

PROPOSED LIMITS OF LAND-DISTURBING ACTIVITIES DIRECTION OF OVERLAND FLOW W/ GRADE

(SF) SILT FENCE, TYPE I - SEE DETAIL SHEET (CE) CONSTRUCTION EXIT/ OFFSITE TRACKING PREVENTION

PS PERMANENT STABILIZATION RR) RIP RAP WITH FILTER FABRIC

(IP) INLET SEDIMENT CONTROL DEVICE

#### **EROSION CONTROL SCHEDULE AND PHASING**

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#### PHASE 1 - DEMOLITION

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- PARKING AND STORAGE AREAS. C. DENOTE DATES OF BMP INSTALLATION AND MAINTENANCE ON
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- E. STABILIZATION OF DISTURBED AREAS MUST BE INITIATED WHENEVER CLEARING, GRADING, OR EARTH DISTURBING ACTIVITIES HAVE CEASED ON ANY PORTION OF THE SITE, OR TEMPORARILY CEASED AND WILL NOT RESUME WITHIN 14 DAYS PER GENERAL PERMIT REQUIREMENTS.

#### PHASE 2 - GRADING

- A. ENSURE APPROPRIATE BMPs ARE IN PLACE DOWNSTREAM OF SITE WORK OR WHERE RUNOFF MAY EXIT THE SITE.
- B. BEGIN GRADING THE SITE. C. SEED AND RE-VEGETATE SLOPES AS AREAS ARE BROUGHT TO GRADE OR STOCKPILES THAT WILL REMAIN INACTIVE FOR 14 DAYS PER GENERAL PERMIT REQUIREMENTS.

#### PHASE 3 - UTILITIES

- A. KEEP ALL STORM WATER POLLUTION PREVENTION MEASURES IN
- B. INSTALL UTILITIES, STORM DRAINS, CURB AND GUTTERS.
- C. INSTALL INLET PROTECTION AS SPECIFIED ON PLAN SHEETS AS STORM STRUCTURES ARE INSTALLED.
- D. TEMPORARILY STABILIZE, THROUGHOUT CONSTRUCTION, ANY DISTURBED AREAS THAT ARE LIKELY TO REMAIN INACTIVE FOR 14 DAYS.

#### **WORK ORDER**

- A. KEEP ALL STORM WATER POLLUTION PREVENTION MEASURES IN
- PLACE. B. BEGIN DEMOLITION AND CLEARING OF PAVEMENT IN ROW.
- C. INSTALL UTILITIES, STORM DRAINS, CURB AND GUTTERS, VALLEY GUTTERS, SIDEWALK, ASPHALT PAVEMENT, AND STRIPING PER DRC PLAN SET #642183.

#### PHASE 4 - PAVING

Call before you dig.

- A. KEEP ALL STORM WATER POLLUTION PREVENTION MEASURES IN PLACE.
- B. STABILIZE SUBGRADE.
- C. PAVE PARKING LOT AND SIDEWALKS AS SPECIFIED ON PLAN SHEETS.

#### A. INSTALL LANDSCAPING PER THE LANDSCAPE PLANS AND DETAILS.

- B. REMOVE EROSION CONTROL DEVICES WHEN FINAL STABILIZATION IS
- ACHIEVED PER THE TPDES GENERAL PERMIT. C. STABILIZE ANY AREAS DISTURBED BY REMOVAL OF BMPs.



PHASE 5 - LANDSCAPING AND DEVELOPMENT



Montgomery & San Mateo **ALBUQUERQUE, NM 87112** Restaurant #RC852 P4E-V-AV SCHEME A

Engineer's Information:

© 2022 KIMLEY-HORN AND ASSOCIATES, INC. 13455 Noel Road

Two Galleria Office Tower Suite 700 Dallas, TX 75240 CONTACT: LAUREN NUFFER, P.E (972) 770-1300

LAUREN.NUFFER@KIMLEY-HORN.CO LIZ WILLMOT, P.E. LIZ.WILLMOT@KIMLEY-HORN.COM

Professional of Record:



L			
'	Prototype: P4E-V-AV 2021-		2.0 RELEASE
	Prototype Issue Date:		10.04.2021
	Kitchen Issue Date:		08.02.2021
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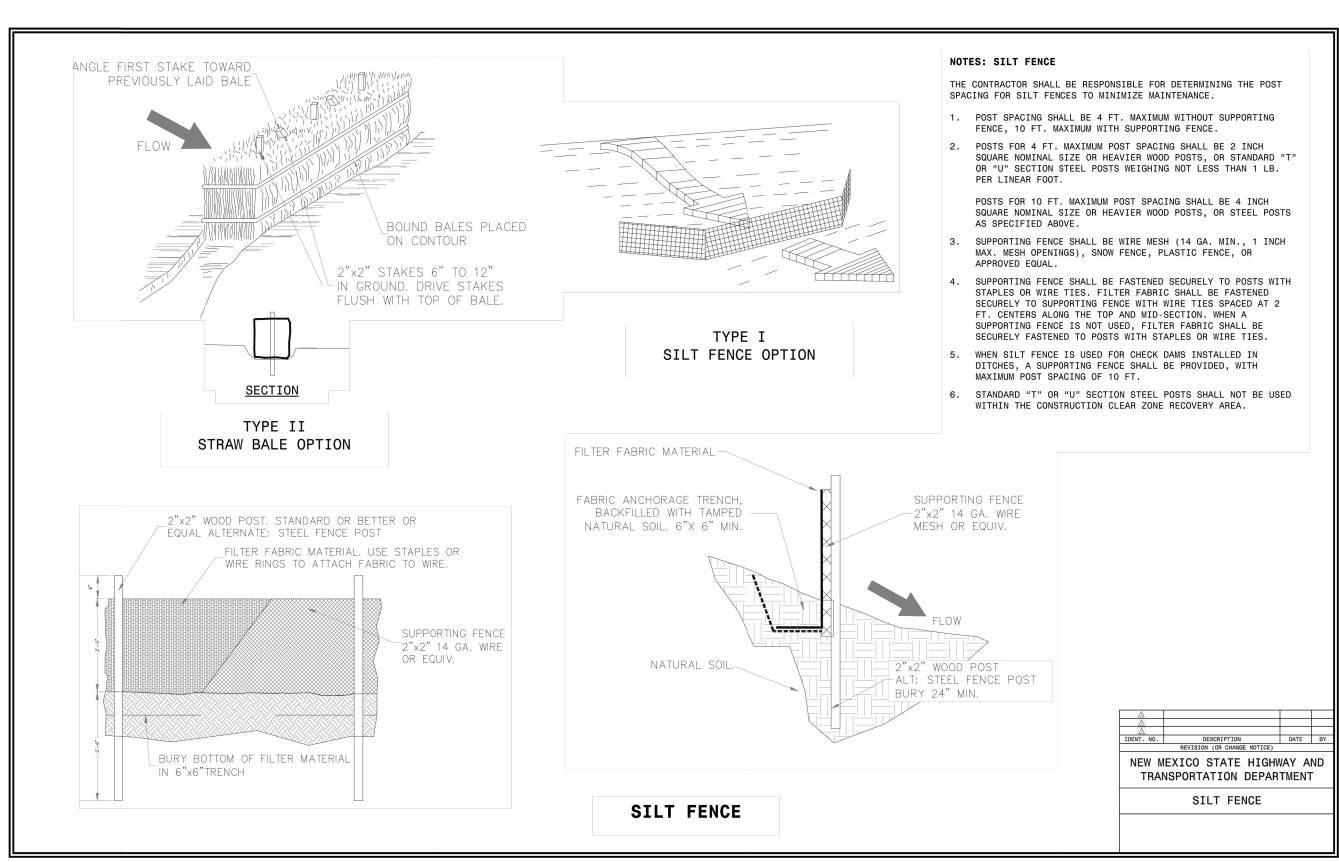
## 2ND BLDG. RESUBMITTAL

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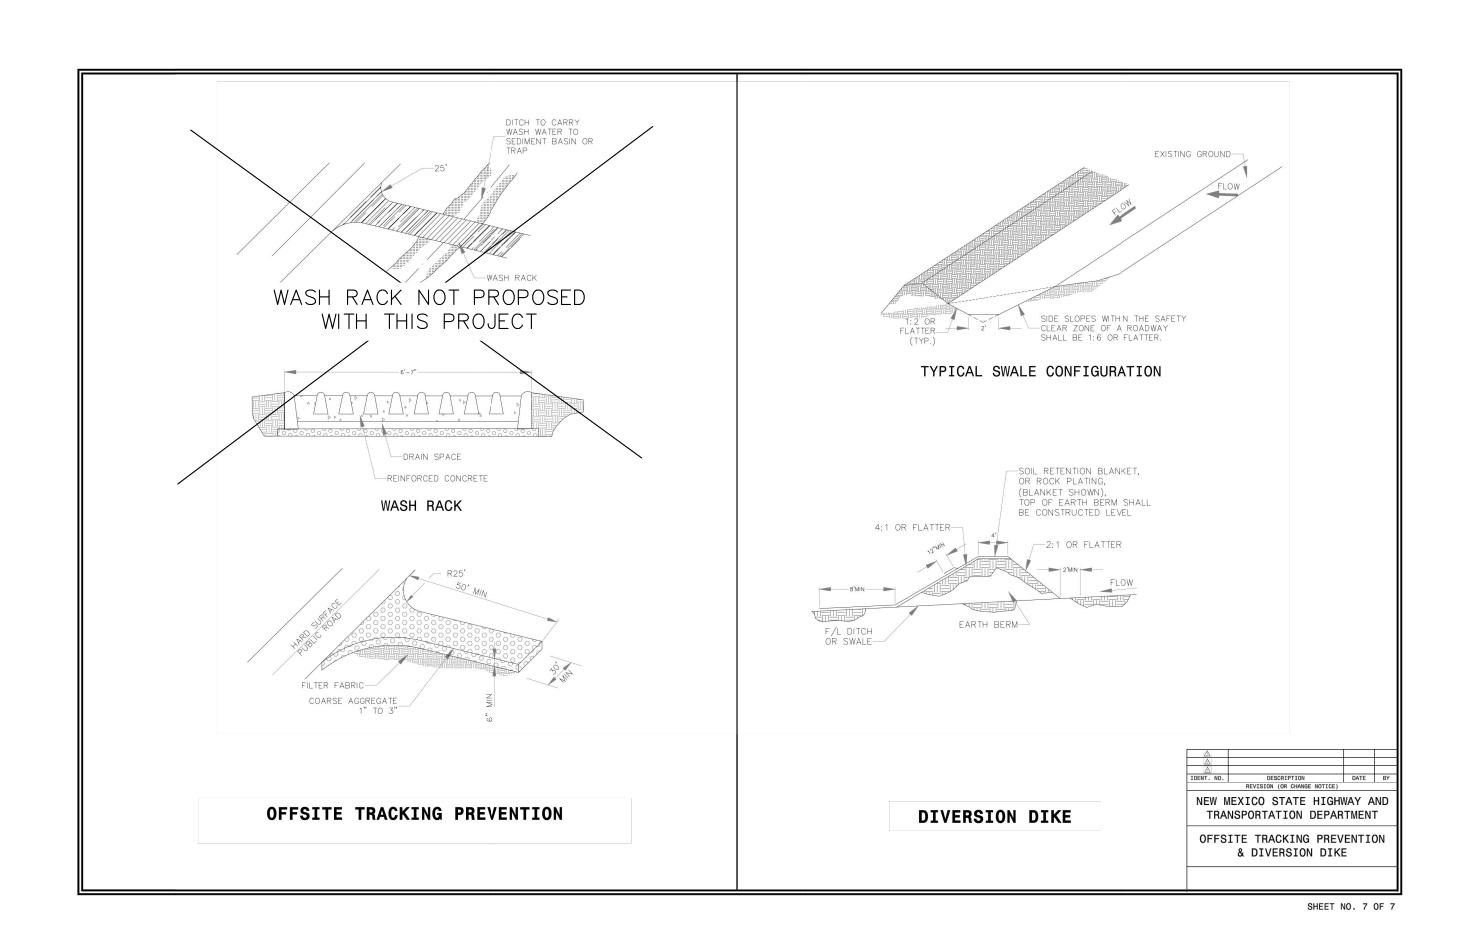
### **EROSION CONTROL** PLAN PH. II


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SHEET NO. 3 OF 7







DATE:

DR. NO:

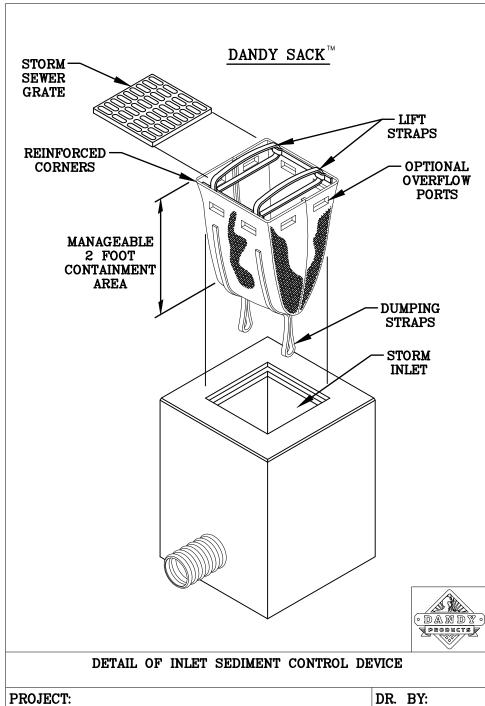CITY/STATE:

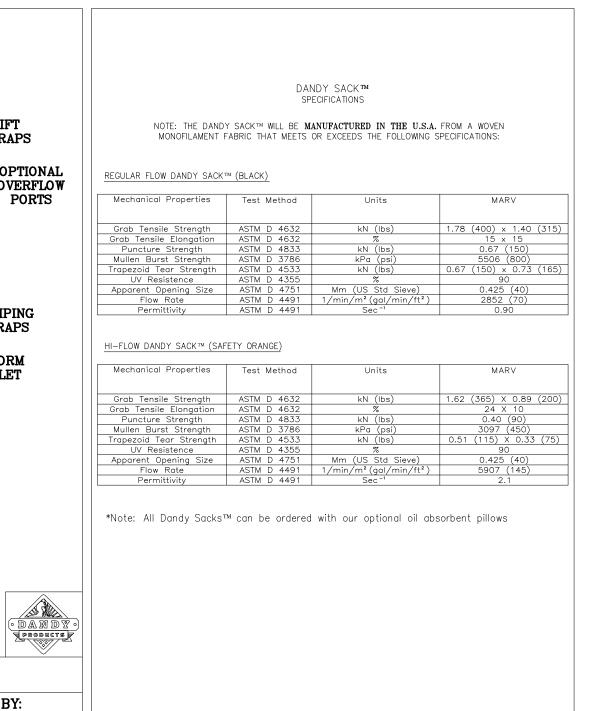

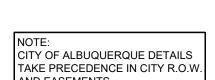





Montgomery & San Mateo
ALBUQUERQUE, NM 87112
Restaurant #RC852
P4E-V-AV SCHEME A

Engineer's Information:

# Kimley»Horn

© 2022 KIMLEY-HORN AND ASSOCIATES, INC. 13455 Noel Road Two Galleria Office Tower Suite 700 Dallas, TX 75240 CONTACT: LAUREN NUFFER, P.E. (972) 770-1300 LAUREN.NUFFER@KIMLEY-HORN.COM LIZ WILLMOT, P.E.

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Sheet Title

# EROSION CONTROL DETAILS

05.25.2022
090042000
LW/LN

Sheet Number:

C3.2