CITY OF ALBUQUERQUE



December 29, 2016

The Design Group David Aube P.E. 120 Vassar SE, Suite 100 Albuquerque, NM 87106

Re: APS Family School East Side 3303 Monroe Street NE Traffic Circulation Layout Engineer's Stamp 12-12-16 (G17-D019A)

Dear Mr. Aube

2.

Based upon the information provided in your submittal received 12-12-16, the above referenced plan cannot be approved for Building Permit until the following comments are addressed:

 Please review and revise plan to provide all information listed on the attached Traffic Circulation Layout checklist.

List the number of parking spaces required by the zoning code as well as the

- proposed number of parking spaces including bicycle and motorcycle parking.
- 3. Clarify the extents of the current phase. Provide a phasing plan.
- 4. The traffic circulation layout must be stamped, signed, and dated by an engineer or architect licensed in the state of New Mexico.
- 5. Identify all existing access easements and rights of way width dimensions.
- Identify the right of way width, medians, curb cuts, and street widths on Monroe St.
 - 7. Please list the width and length for all existing and proposed parking spaces. Some dimensions are not shown.
 - 8. Please dimension the proposed sidewalk widths.
 - 9. Show all drive aisle widths that effect current phasing. Some dimensions are not shown.
 - Label the compact parking spaces by placing the words "COMPACT" on the pavement of each space.
 - 11. The handicap accessible spaces must include an access aisle. Van accessible aisles should be 8ft wide; all others should be 5ft wide.
 - 12. The ADA accessible parking sign must have the required language per 66-7-352.4C NMSA 1978 "Violators Are Subject to a Fine and/or Towing." Please call out detail and location of HC signs.

PO Box 1293

Albuquerque

New Mexico 87103

www.cabq.gov

CITY OF ALBUQUERQUE



- 13. The ADA access aisles shall have the words "NO PARKING" in capital letters, each of which shall be at least one foot high and at least two inches wide, placed at the rear of the parking space so as to be close to where an adjacent vehicle's rear tire would be placed. (66-1-4.1.B NMSA 1978)
- 14. The ADA parking space has a clearly visible, blue, International Symbol of Accessibility painted on the pavement at rear of the space (66-1-4.1.E NMSA 1978) or MUTCD recommends a white symbol on a blue background.
- 15. Show all drive aisle widths and radii. Some dimensions are not shown.
- List radii for all curves shown; for passenger vehicles, the minimum end island radius for passenger vehicles is 15 ft. Radius for delivery trucks, fire trucks, etc. is 25 ft. or larger.
- 17. Provide a min 6" or max 8" high concrete barrier curb or other acceptable barrier between landscaping and parking areas and/or drive aisles. Please call out detail and location of barrier curb.
- 18. Per the zoning code, a 6 ft. wide ADA accessible pedestrian pathway is required from the public sidewalk to the building entrances. Please clearly show this pathway and provide details.
- 19. Please specify the City Standard Drawing Number when applicable.

PO Box 1293

20. Please include a copy of your shared access agreement with the adjacent property owner.

Albuquerque

Resubmit a revised plan along with fully completed Drainage Transportation Information Sheet to front counter personnel for log in and evaluation by Transportation. PDF copies of the plans and submittal package must be emailed to PLNDRS@cabq.gov at time of resubmittal. If you have any questions, please contact me at (505) 924-3630.

New Mexico 87103

Sincerely,

www.cabq.gov

Logan Patz

Senior Engineer, Planning Dept. Development Review Services

LWP via: email

C:

File

DRAINAGE AND TRANSPORTATION INFORMATION SHEET

(REV. 1/28/2003rd)


PROJECT TITLE: APS Family School East Side DRB #: EPC#:	ZONE MAP/DRG. FILE #:G-17200[94 WORK ORDER#:
LEGAL DESCRIPTION: <u>Portions of Tracts D and E, Bo</u> CITY ADDRESS: <u>3303 Monroe Street NE.</u>	ard of Education Addition.
ENGINEERING FIRM: Design Group ADDRESS: 120 Vassar SE, Suite 100 CITY, STATE: Albuquerque, NM	CONTACT: <u>David Aube</u> PHONE: <u>998-6430</u> ZIP CODE: <u>87106</u>
OWNER: APS Facilities ADDRESS: CITY, STATE: Albuquerque, NM	CONTACT: <u>Richard Miller</u> PHONE: <u>848-8835</u> ZIP CODE:
ARCHITECT: The Design Group ADDRESS: 120 Vassar SE, Suite 100 CITY, STATE: Albuquerque, NM	CONTACT: Wendy Caruso PHONE: 242-6880 ZIP CODE: 87106
SURVEYOR: High Mesa Consulting ADDRESS: CITY, STATE: _	CONTACT: Chuck Cala PHONE: 345-4250 ZIP CODE:
CONTRACTOR: TBD ADDRESS: CITY, STATE:	CONTACT: PHONE: ZIP CODE: 871
CHECK TYPE OF SUBMITTAL:	CHECK TYPE OF APPROVAL SOUGHT:
 □ DRAINAGE REPORT □ DRAINAGE PLAN 1st SUBMITTAL, REQUIRE □ DRAINAGE PLAN RESUBMITTAL □ CONCEPTUAL GRADING & DRAINAGE PLA □ GRADING PLAN □ EROSION CONTROL PLAN □ ENGINEER'S CERTIFICATION (HYDROLOG CLOMR/LOMR □ TRAFFIC CIRCULATION LAYOUT (TCL) □ ENGINEERS CERTIFICATION (TCL) □ ENGINEERS CERTIFICATION (DRB APPR. SOTHER 	S. DEV. PLAN FOR SUB'D. APPROVAL S. DEV. PLAN FOR BLDG. PERMIT APPROVAL SECTOR PLAN APPROVAL FINAL PLAT APPROVAL FOUNDATION PERMIT APPROVAL BUILDING PERMIT APPROVAL CERTIFICATE OF OCCUPANCY (PERM.) CERTIFICATE OF OCCUPANCY (TEMP.)
WAS A PRE-DESIGN CONFERENCE ATTENDED: ✓ YES	


DATE SUBMITTED: 12-12-16

BY: David Aube P.E.


Requests for approvals of Site Development Plans and/or Subdivision Plats shall be accompanied by a drainage submittal. The particular nature, location and scope of the proposed development defines the degree of drainage detail. One or more of the following levels of submittal may be required based on the following:

- 1. **Conceptual Grading and Drainage Plan**: Required for approval of Site Development Plans greater than five (5) acres and Sector Plans.
- 2. **Drainage Plans**: Required for building permits, grading permits, paving permits and site plans less than five (5) acres
- 3. **Drainage Report**: Required for subdivisions containing more than ten (10) lots or constituting five (5) acres or more.

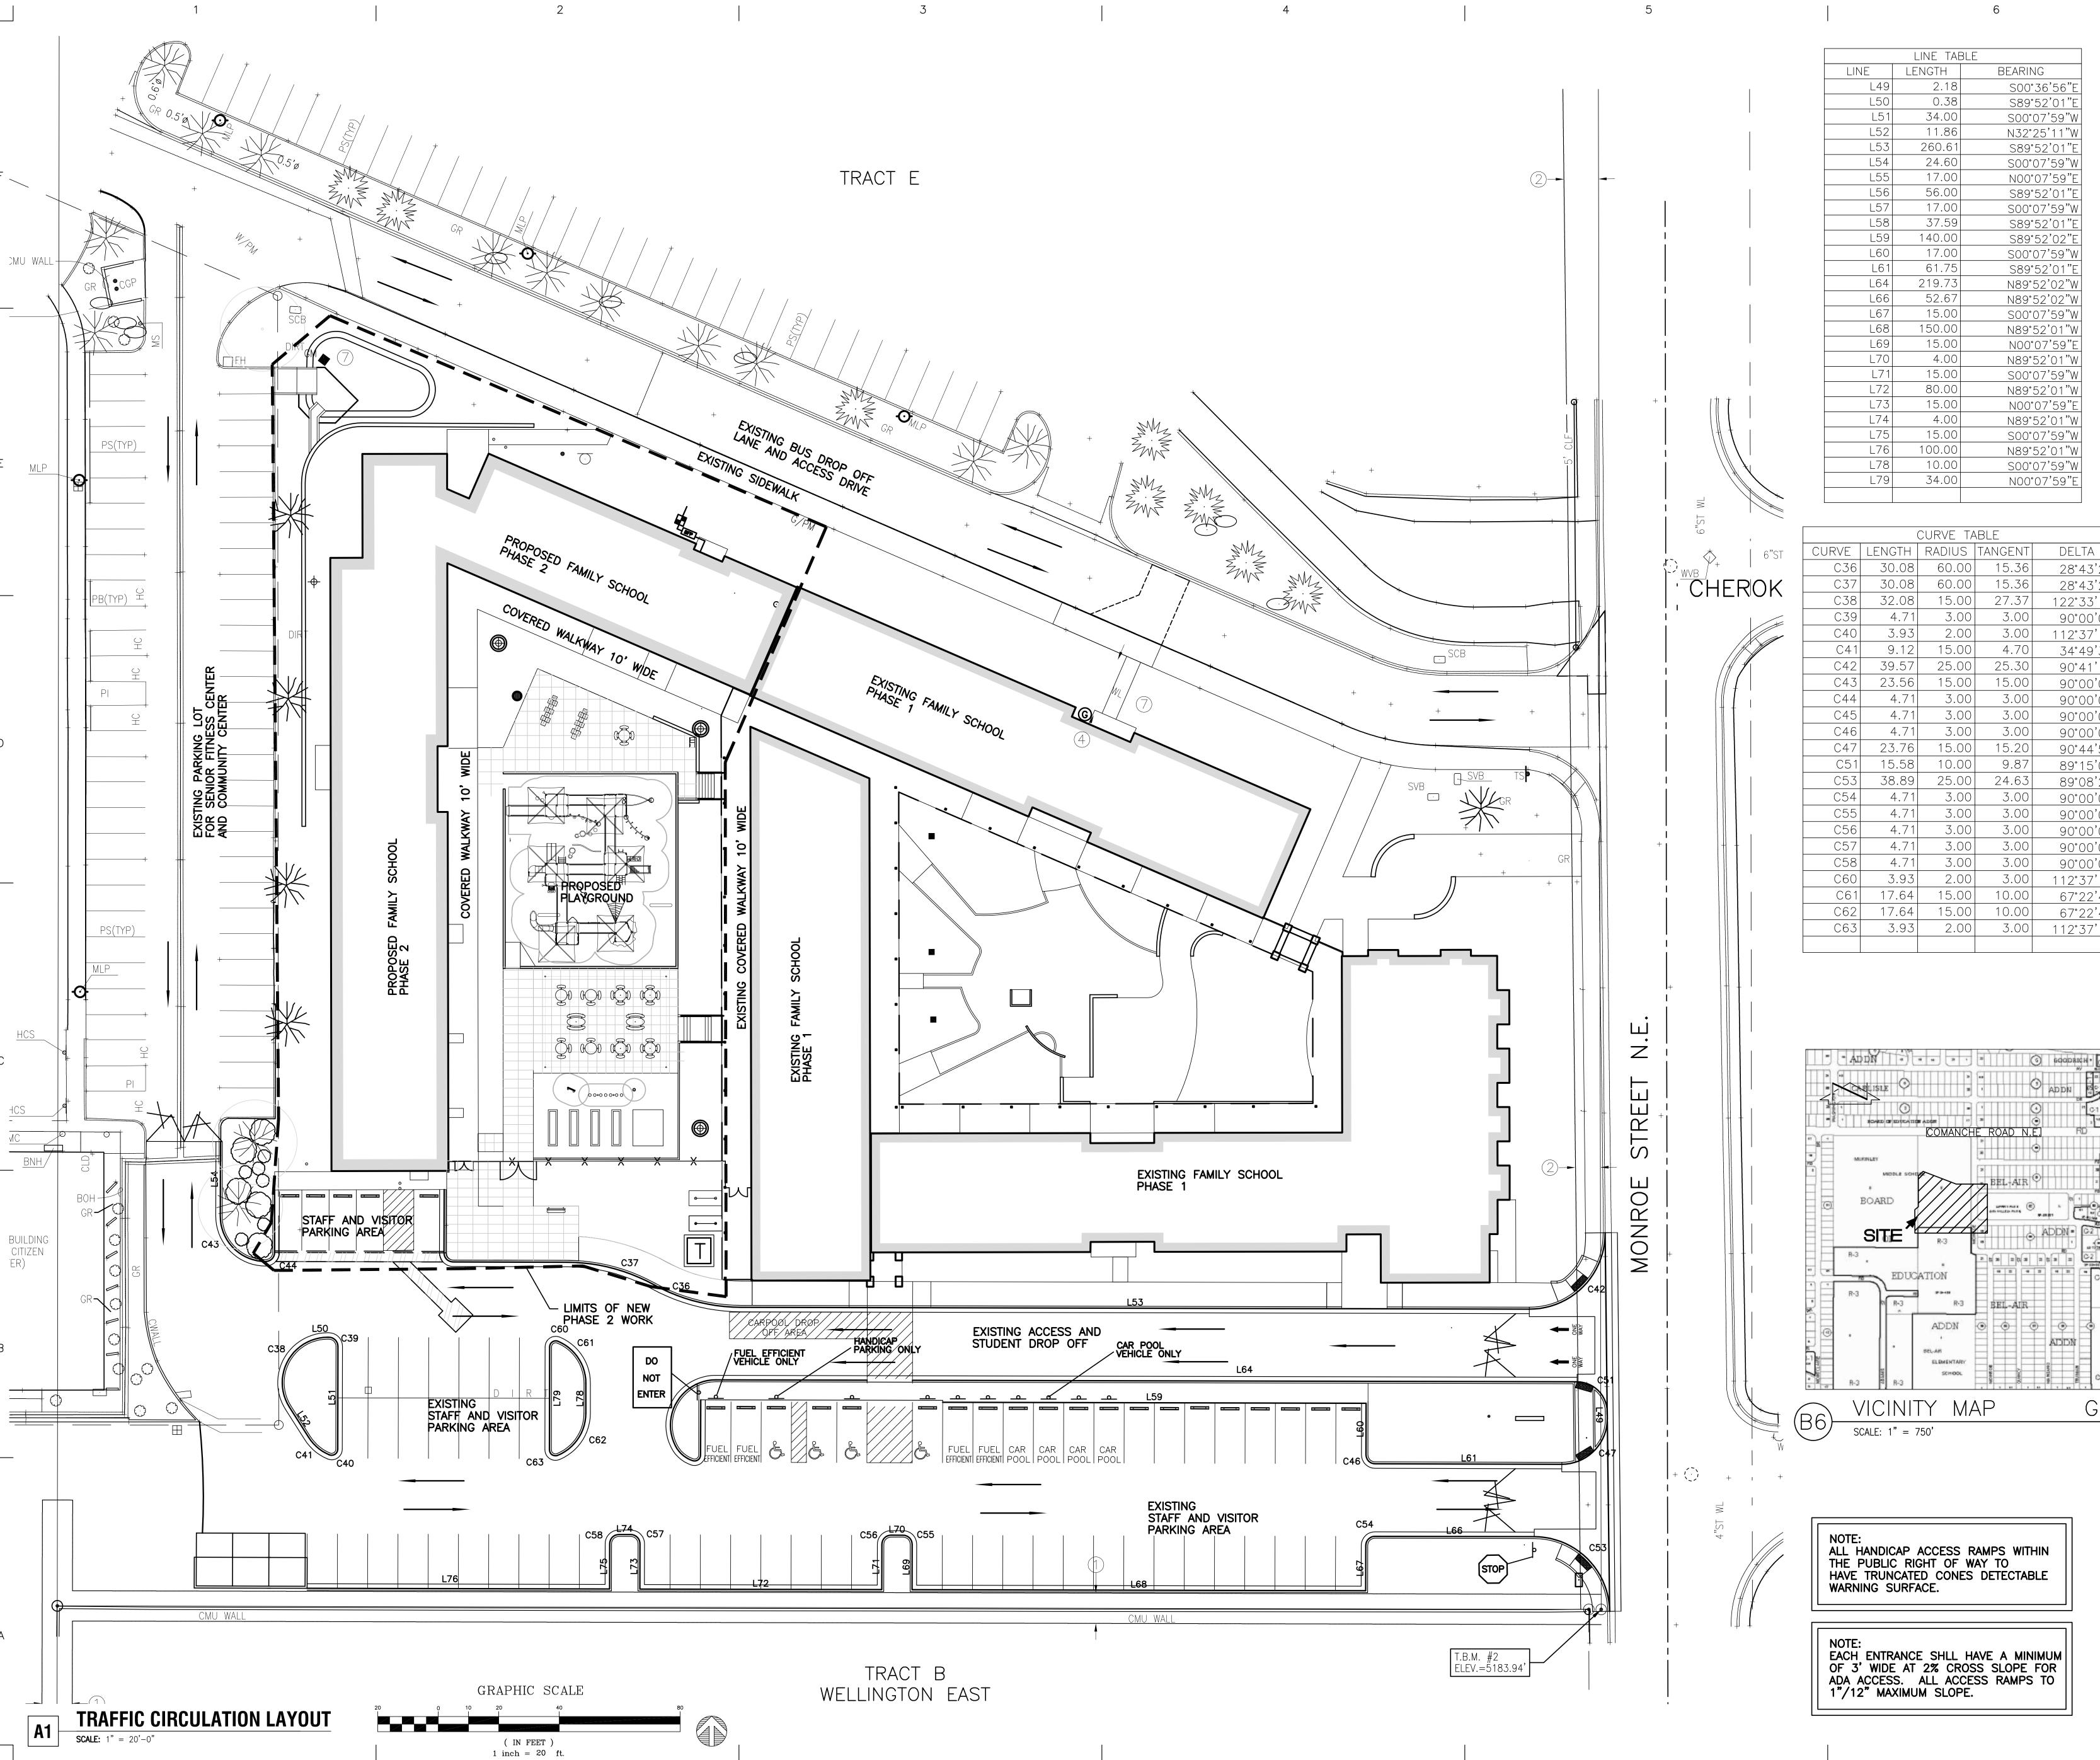

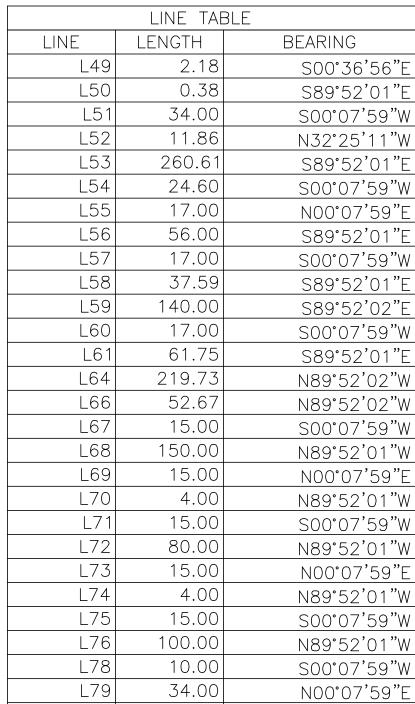

CURVE	LENGIH	RADIUS	TANGENT	DELIA	
C36	30.08	60.00	15.36	28°43'26"	
C37	30.08	60.00	15.36	28°43'26'	
C38	32.08	15.00	27.37	122°33'10'	
C39	4.71	3.00	3.00	90°00'00"	
C40	3.93	2.00	3.00	112°37'12"	
C41	9.12	15.00	4.70	34°49'39"	
C42	39.57	25.00	25.30	90°41'16'	
C43	23.56	15.00	15.00	90°00'00'	
C44	4.71	3.00	3.00	90°00'00'	
C45	4.71	3.00	3.00	90°00'00"	
C46	4.71	3.00	3.00	90°00'00'	
C47	23.76	15.00	15.20	90°44'55"	
C51	15.58	10.00	9.87	89°15'05"	
C53	38.89	25.00	24.63	89°08'26"	
C54	4.71	3.00	3.00	90°00'00'	
C55	4.71	3.00	3.00	90°00'00'	
C56	4.71	3.00	3.00	90°00'00'	
C57	4.71	3.00	3.00	90°00'00'	
C58	4.71	3.00	3.00	90°00'00'	
C60	3.93	2.00	3.00	112°37'12"	
C61	17.64	15.00	10.00	67°22'48'	
C62	17.64	15.00	10.00	67°22'48'	
C63	3.93	2.00	3.00	112°37'12"	
				1	

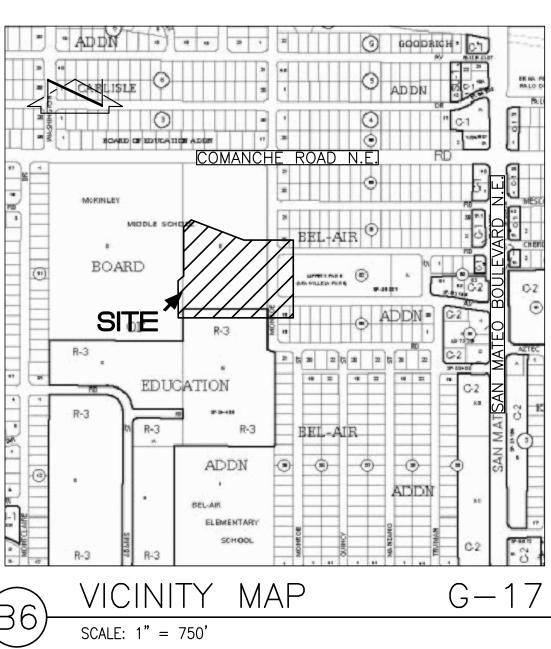

NOTE: ALL HANDICAP ACCESS RAMPS WITHIN THE PUBLIC RIGHT OF WAY TO HAVE TRUNCATED CONES DETECTABLE WARNING SURFACE.
--

NOTE:
EACH ENTRANCE SHLL HAVE A MINIMUM
OF 3' WIDE AT 2% CROSS SLOPE FOR
ADA ACCESS. ALL ACCESS RAMPS TO
1"/12" MAXIMUM SLOPE.

C	lg				
HE HARTI	/ A N +	МА	JEW	SKI	
DESIG	N (\mathbf{J}_{F}	O	UP	
RCHITECTS · ENC PLANNERS · UR					
20 VASSAR	DRIVE	SE	SUITE	: 100)
ALBUQUERQUE,					

PHONE: 505.242.6880 FAX: 505.242.6881 CONSULTANT



PROJECT NAME

No. DATE

DATE: SCALE: 1" = 20'-0" JOB NO.: CAD FILE: 3022MC_C101

SHEET TITLE: TRAFFIC CIRCULATION LAYOUT

SHEET NUMBER:

C-TCL