

EXISTING PLANS, AND THIS INFORMATION MAY BE INCOMPLETE, OR OBSOLETE AT THE TIME OF CONSTRUCTION. THE ENGINEER

REPRESENTATION THERETO, AND ASSUMES NO RESPONSIBILITY

UNDERGROUND INSTALLATION IN OR NEAR THE AREA IN ADVANCE

FULLY RESPONSIBLE FOR ANY AND ALL DAMAGES CAUSED BY ITS

OF AND DURING ANY EXCAVATION WORK. THE CONTRACTOR IS

IN PLANNING AND CONDUCTING EXCAVATIONS, THE CONTRACTOR

ORDINANCES, RULES AND REGULATIONS, IF ANY, PERTAINING TO

THE CONTRACTOR SHALL INSURE THAT NO SOIL ERODES FROM

BERMS AND BY WETTING THE SOIL TO KEEP IT FROM BLOWING.

THE SITE INTO PUBLIC RIGHT-OF-WAY OR ONTO PRIVATE

SHALL COMPLY WITH ALL STATE STATUTES, MUNICIPAL AND LOCAL

PROPERTY. THIS CAN BE ACHIEVED BY CONSTRUCTING TEMPORARY

OR LIABILITY THEREFOR. THE CONTRACTOR SHALL INFORM ITSELF OF THE LOCATION OF ANY UTILITY LINE, PIPELINE OR

FAILURE TO LOCATE, IDENTIFY AND PRESERVE ANY AND ALL

EXISTING UTILITIES, PIPELINES AND UNDERGROUND FACILITIES.

THE LOCATION OF THESE LINES AND FACILITIES.

HAS NOT UNDERTAKEN ANY FIELD VERIFICATION OF THESE

LOCATIONS, LINE SIZES OR MATERIAL TYPE, MAKES NO

08/29/02 DRAWN: LH DESIGNED: SE CHECKED: KK

HUITT-ZOLLARS, INC.

Consulting Engineers

<u>.</u>

Q

Surgic

PROJ. NO.: 14-0204-01

SHEET:

SCALE: 1"=20'

TA

TBC

FL

TSW

10 CONSTRUCT CMU VISUAL SCREEN WALL PER SITE PLAN

BENCHMARK

CHISELED " IN TOP BACK OF CURB BEHIND FOUND DRILL HOLE 5. BACKFILL COMPACTION SHALL BE ACCORDING TO ARTERIAL ELEV. = 34.57

- 2. ALL WORK DETAILED ON THESE PLANS TO BE PERFORMED. EXCEPT AS OTHERWISE STATED OR PROVIDED HERON, SHALL BE CONSTRUCTED IN ACCORDANCE WITH CITY OF ALBUQUERQUE INTERIM STANDARD SPECIFICATIONS FOR PUBLIC WORKS CONSTRUCTION, 1985.
- 3. TWO WORKING DAYS PRIOR TO ANY EXCAVATION, CONTRACTOR MUST CONTACT LINE LOCATING SERVICE, 765-1234, FOR LOCATION OF EXISTING UTILITIES.
- 4. PRIOR TO CONSTRUCTION, THE CONTRACTOR SHALL EXCAVATE AND VERIFY THE HORIZONTAL AND VERTICAL LOCATIONS OF ALL CONSTRUCTIONS. SHOULD A CONFLICT EXIST, THE CONTRACTOR SHALL NOTIFY THE ENGINEER SO THAT THE CONFLICT CAN BE RESOLVED WITH A MINIMUM AMOUNT OF DELAY.
- STREET USE.
- 6. MAINTENANCE OF THESE FACILITIES SHALL BE THE RESPONSIBILITY OF THE OWNER OF THE PROPERTY SERVED.

TYP. COBBLE SWALE 1 SCALE: NTS Q=1.51 cfs **Q** 4.6" DEEP SLOPE = 1.00%

FLOOD ZONE

PER THE FEMA MAP NUMBER 350002 0023 DATED OCTOBER 14. 1983 THE SITE IS NOT LOCATED WITHIN FLOOD HAZARD ZONE AREA. HOWEVER, MONTGOMERY BOULEVARD WHICH BOUNDS THE SITE TO THE NORTH IS DESIGNATED AS BEING IN THE 100-YR FLOOD ZONE.

ENGINEER'S CERTIFICATION

I PERSONALLY INSPECTED THIS SITE AND NO GRADING. FILLING, OR EXCAVATION HAS OCCURRED SINCE THE PREPARATION OF THE TOPOGRAPHY SHOWN ON THIS PLAN.

TOP OF ASPHALT TOP BACK OF CURB FLOWLINE ELEVATION

TOP OF SIDEWALK NAME DATE A.C.E. DESIGN

APPROVALS

INSPECTOR

A.C.E. FIELD

JUN 03 2004 HYDROLOGY SECTION



- 1. PRIOR TO ANY CONSTRUCTION, THE CONTRACTOR SHALL EXCAVATE AND VERIFY THE LOCATION OF ALL POTENTIAL OBSTRUCTIONS. SHOULD A CONFLICT EXIST, THE CONTRACTOR SHALL NOTIFY THE ENGINEER AS SOON AS POSSIBLE TO RESOLVE THE CONFLICT WITH A MINIMUM AMOUNT OF DELAY.
- 2. ALL WORK ON THIS PLAN SHALL BE PERFORMED IN ACCORDANCE WITH APPLICABLE FEDERAL, STATE AND LOCAL LAWS, RULES AND REGULATIONS CONCERNING CONSTRUCTION SAFETY AND HEALTH.
- 3. IF ANY UTILITY LINES, PIPELINES, OR UNDERGROUND UTILITY LINES ARE SHOWN ON THESE DRAWINGS, THEY ARE SHOWN IN AN APPROXIMATE LOCATION ONLY, AND LINES MAY EXIST WHERE NONE ARE SHOWN, THE LOCATION IS BASED UPON INFORMATION PROVIDED BY THE UTILITY OWNER OR FROM EXISTING PLANS, AND THIS INFORMATION MAY BE INCOMPLETE, OR OBSOLETE AT THE TIME OF CONSTRUCTION. THE ENGINEER HAS NOT UNDERTAKEN ANY FIELD VERIFICATION OF THESE LOCATIONS, LINE SIZES OR MATERIAL TYPE, MAKES NO REPRESENTATION THERETO, AND ASSUMES NO RESPONSIBILITY OR LIABILITY THEREFOR. THE CONTRACTOR SHALL INFORM ITSELF OF THE LOCATION OF ANY UTILITY LINE, PIPELINE OR UNDERGROUND INSTALLATION IN OR NEAR THE AREA IN ADVANCE OF AND DURING ANY EXCAVATION WORK. THE CONTRACTOR IS FULLY RESPONSIBLE FOR ANY AND ALL DAMAGES CAUSED BY ITS FAILURE TO LOCATE, IDENTIFY AND PRESERVE ANY AND ALL EXISTING UTILITIES, PIPELINES AND UNDERGROUND FACILITIES. IN PLANNING AND CONDUCTING EXCAVATIONS, THE CONTRACTOR SHALL COMPLY WITH ALL STATE STATUTES, MUNICIPAL AND LOCAL ORDINANCES, RULES AND REGULATIONS, IF ANY, PERTAINING TO THE LOCATION OF THESE LINES AND FACILITIES.
- THE CONTRACTOR SHALL INSURE THAT NO SOIL ERODES FROM THE SITE INTO PUBLIC RIGHT-OF-WAY OR ONTO PRIVATE PROPERTY. THIS CAN BE ACHIEVED BY CONSTRUCTING TEMPORARY BERMS AND BY WETTING THE SOIL TO KEEP IT FROM BLOWING.

5. THE CONTRACTOR SHALL OBTAIN ANY AND ALL PERMITS REQUIRED LEGAL DESCRIPTION BY THE CITY OF ALB. FOR THE COMPLETION OF THE WORK PRIOR TO BEGINNING CONSTRUCTION.

BENCHMARK

ELEV. = 34.57


A PARCEL OF LAND BEING ALL OF TRACT A-1A OF THE VOL-ADDITION WITHIN SECTION 2, TOWNSHIP 10 NORTH, RANGE 3 EAST, NEW MEXICO PRINCIPAL MERIDIAN, CITY OF ALBUQUERQUE, BERNALILLO COUNTY, NEW MEXICO.

S.O. 19 REQUIREMENTS

1. AN EXCAVATION/CONSTRUCTION PERMIT WILL BE REQUIRED BEFORE BEGINNING ANY WORK IN THE CITY RIGHT-OF-WAY. AN APPROVED COPY OF THESE PLANS MUST BE SUBMITTED AT THE SAME TIME OF APPLICATION FOR THIS PERMIT.

SCALE: 1"=20'

- 2. ALL WORK DETAILED ON THESE PLANS TO BE PERFORMED, EXCEPT AS OTHERWISE STATED OR PROVIDED HERON, SHALL BE CONSTRUCTED IN ACCORDANCE WITH CITY OF ALBUQUERQUE INTERIM STANDARD SPECIFICATIONS FOR PUBLIC WORKS CONSTRUCTION, 1985.
- 3. TWO WORKING DAYS PRIOR TO ANY EXCAVATION, CONTRACTOR MUST CONTACT LINE LOCATING SERVICE, 765-1234, FOR LOCATION OF EXISTING UTILITIES.
- 4. PRIOR TO CONSTRUCTION, THE CONTRACTOR SHALL EXCAVATE AND VERIFY THE HORIZONTAL AND VERTICAL LOCATIONS OF ALL CONSTRUCTIONS. SHOULD A CONFLICT EXIST, THE CONTRACTOR SHALL NOTIFY THE ENGINEER SO THAT THE CONFLICT CAN BE RESOLVED WITH A MINIMUM AMOUNT OF DELAY.
- CHISELED " IN TOP BACK OF CURB BEHIND FOUND DRILL HOLE 5. BACKFILL COMPACTION SHALL BE ACCORDING TO ARTERIAL STREET USE.
 - 6. MAINTENANCE OF THESE FACILITIES SHALL BE THE RESPONSIBILITY OF THE OWNER OF THE PROPERTY SERVED.

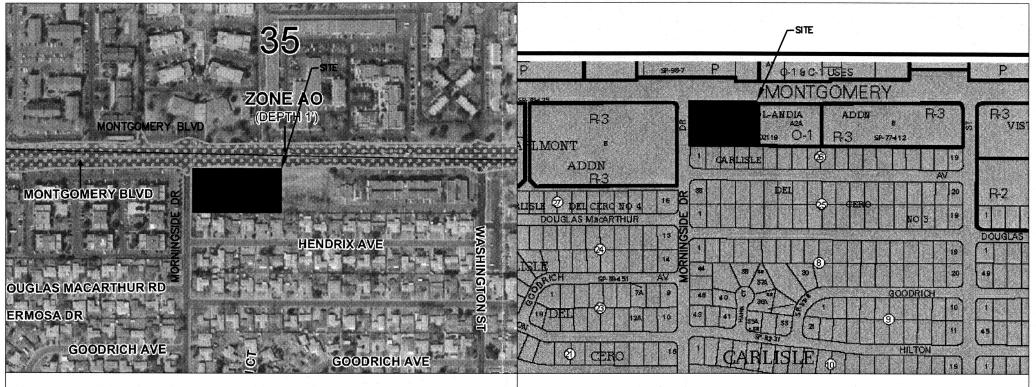

ALBUQUERQUE ZONE ATLAS PG G-17

FLOOD ZONE

PER THE FEMA MAP NUMBER 35001C0138G DATED SEPTEMBER 26, 2008 THE SITE IS NOT LOCATED WITHIN FLOOD HAZARD ZONE AREA. HOWEVER, MONTGOMERY BOULEVARD WHICH BOUNDS THE SITE TO THE NORTH IS DESIGNATED AS BEING IN THE 100-YR FLOOD ZONE.

THE FOLLOWING CALCULATIONS WERE DEVELOPED USING THE CITY OF ALBUQUERQUE DPM SECTION 22.2

SITE CHARACTERISTICS: SITE LOCATION: ZONE 3 PRECIPITATION: P=2.60 inches BUILDING ADDITION WILL REMOVE TREATMENT C AND REPLACE IT WITH TREATMENT D (2,250 SF ADDITION) ALL ON-SITE INFRASTRUCTURE SHOWN IS EXISTING EXCEPT THE BUILDING ADDITION.

LAND TREATMENT: UNCOMPACTED SOIL - TREATMENT A TREATMENT B COMPACTED SOIL - TREATMENT C BUILDINGS & PAVING - TREATMENT D **EXCESS PRECIPITATION:** TREATMENT A E = 0.66 inches TREATMENT B E = 0.92 inches TREATMENT C E = 1.29 inches TREATMENT D E = 2.36 inches PEAK DISCHARGE: TREATMENT A = 1.87 cfs/acre TREATMENT B = 2.60 cfs/acreTREATMENT C = 3.45 cfs/acreTREATMENT D = 5.02 cfs/acreTOTAL AREA = 1.79 AC.

EXISTING TREATMENT A = $0.00 \text{ AC.} = 0.0\% \ 0.00 \text{ AC.} = 0.0\%$ TREATMENT B = 0.27 AC. = 15.1% 0.27 AC. = 15.1%. TREATMENT C = 0.18 AC. = 10.0% 0.13 AC. = 7.3%

ONSITE - EXCESS PRECIPITATION & VOLUMETRIC RUNOFF: EXISTING RUNOFF PER 2002 G&D PLAN: 13,250 cf

WEIGHTED E = [(0.66)(0.00)+(0.92)(0.27)+(1.29)(0.13)+(2.36)(1.39)]/1.79= 2.06 inches

V100-6hr = (2.06)(1.79)/12 = 0.3073 acre ft = 13,385 cf

DEVELOPED DISCHARGE: Q100 = (1.87)(0.00) + (2.60)(0.27) + (3.45)(0.13) + (5.02)(1.39) = 8.13 cfs

FLOOD BOUNDARY MAP # 35001C0138G

CALCULATIONS (REVISED)


TREATMENT D = 1.34 AC. = 74.9% 1.39 AC. = 77.7%

DEVELOPED RUNOFF:

ON-SITE - PEAK DISCHARGE EXISTING DISCHARGE PER 2002 G&D PLAN: 8.50 cfs

DEVELOPED VOLUMETRIC RUNOFF: 13,385 - 13,250 = 135 cf INCREASE IN RUNOFF VOLUME DEVELOPED PEAK DISHARGE: 8.13 - 8.05 = 0.08 cfs INCREASE IN PEAK DISCHARGE

APPROVALS	NAME	DATE
A.C.E. DESIGN		,
INSPECTOR		š ² a
A.C.E. FIELD		

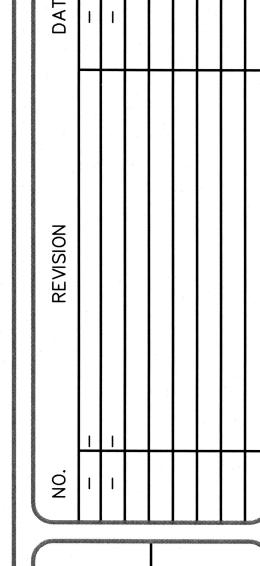

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06/23/11

DATE: DRAWN: JH DESIGNED: JH

CHECKED: JH PROJ. NO.: 17-0956-01

SHEET: