


TRAFFIC CIRCULATION LAYOUT

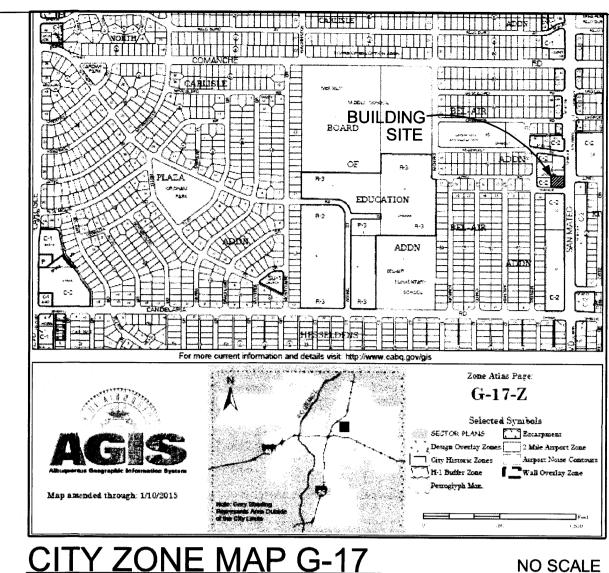

Joe Burwinkle, J 112-119 Pan Ame NO SCALE 4-24-2013 DRAWN BY: CHECKED BY: JAF Concepts.com

nerican Fwy NE 3, NM 87109 1-6866

VERIFIED BY:

CLUFF & HARD) AN MATEO BLVD CUERQUE, NM 87

TENANT FADDOUL, 3301 SA

NECEIV

APR 2 4 2013

LAND DEVELOPMENT SECTIO

PROGRESS

APP'VD PRELIMINAR

PRE-CONSTRUCTION

CONSTRUCTION

SHEET TITLE & NO:

PRELIMINARY

PERMIT

3301 SAN MATEC ALBUQUERQUE,

querque, 505-821

EXECUTIVE SUMMARY

DRAINAGE PLAN <u>NOT</u> REQUIRED. NO CHANGES.
ONLY RESTRIPING & NEW CONCRETE BUMPER BARRIERS.

1. LOCATION IS IN THE BEL-AIR SUBDIVISION

BLK. 61, LOT 6, ZONE MAP 6-17 2. THIS IS A 1980 COMMERCIAL BUILDING THAT HAS BEEN

VACANT FOR THE PAST 5 YEARS. THE NEW OWNER WILL DO A TENANT IMPROVEMENT TO REMODEL THE INTERIOR INTO THEIR NEW MEXICO HEADQUARTERS.

THE FACADE WILL BE IMPROVED TO REFLECT THE IMAGE OF A LARGE LAW FIRM.

THE TOTAL SQUARE FOOTAGE WILL REMAIN THE SAME.

THE CARPORT ON THE WEST WILL BECOME OFFICE SPACE THIS EXISTING CARPORT IS ONLY USED BY MOTORCYCLES & SMALL / COMPACT CARS BECAUSE THE DEPTH OF THE CARPORT & DRIVE IS 36' IN DEPTH. THIS IS NOT USEABLE BECAUSE OF IT'S SIZE. (TOTAL OF 36' FOR BOTH THE DRIVE & PARKING AREA)

3. THE EXISTING ON SITE PARKING IS THE SAME. NEW STRIPING & CONCRETE BUMPER BARRIERS.

WE HAVE REQUESTED APPROVAL FOR NEW OFF SITE PARKING ON AZTEC ROAD N.E.

THE TRAFFIC ON SAN MATEO OR AZTEC WILL NOT CHANGE FOR THE EMPLOYEES (APPROX. 12) ENTERING THIS SITE.

• KEYED NOTES:

- EXISTING UTILITY EASEMENT **EXISTING FENCE EXISTING RETAINING WALL**
- EXISTING SIGN EXISTING LANDSCAPING AREA EXISTING ASPHALT & PARKING EXISTING SIDEWALK
- EXISTING PARKING AREA TO BE RESTRIPED AS SHOWN. NUMBER OF SPACES REMAINS UNCHANGED. EXISTING CONC. CURB
- EXISTING CONC. DRIVEPAD EXISTING 6'-0" CONC. WALK NEW PARKING BUMPER

PARKING CALCULATIONS

FIRST FLOOR: 4,502 SQ. FT. / 200 = 22.5 SECOND FLOOR: 1,878 SQ. FT. / 300 = 6.3 TOTAL SPACES REQUIRED: MASS TRANSIT 10% REDUCTION: 2.8 TOTAL REQUIRED: TOTAL SPACES PROVIDED:

PARKING SPACE DATA: STANDARD ON SITE: 20 COMPACT ON SITE: ADA ON SITE: MEW ON STREET: CREON 2 TOTAL PROVIDED:

LOT SIZE: 18,616 SQ. FT. (.427 ACRES)

UPC CODE: 101706051513241213

1"=10'-0"

PARKING NOTES:

- EXISTING LANDSCAPING LAYOUT TO REMAIN. (GRANDFATHERED IN)
- 2. PARKING SPACE CONFIGURATION TO REMAIN
- UNCHANGED BY TENANT IMPROVEMENT. 3. ALL CONC. PARKING BUMPERS ARE NEW
- 4. ENTIRE PARKING LOT TO BE RESTRIPED AS SHOWN.

ZONING: C-2

DESIGN CRITERIA

AREA CALCULATIONS


NET AREA: NEW: 6,380 S.F. **EXISTING**: 6,434 S.F. ADDED: -54 S.F.

ARCHITECT

Joseph B, Burwinkle, Jr. License No. NM 430 7112-119 Pan American Fwy NE Albuquerque, NM 87109 505-821-6866

TRAFFIC **CIRCULATION** LAYOUT

ALL PRINTS ARE REPRODUCTIONS OF ELECTRONIC DRAWINGS AND THERE IS NO GUARANTEE THAT THE SCALE WILL BE TRUELY PRESENTED. IF YOU PLACE A SCALE ON THE BAR TO THE RIGHT, YOU WILL SEE IF THE SCALE IS CORRECT FOR THIS PRINT.

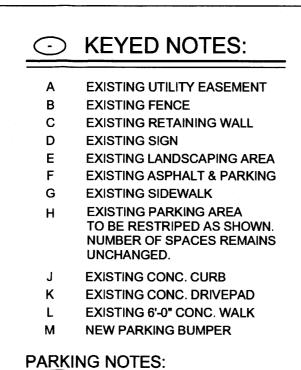

1. EXISTING LANDSCAPING LAYOUT TO REMAIN.

2. PARKING SPACE CONFIGURATION TO REMAIN

4. ENTIRE PARKING LOT TO BE RESTRIPED AS SHOWN.

UNCHANGED BY TENANT IMPROVEMENT.

3. ALL CONC. PARKING BUMPERS ARE NEW

(GRANDFATHERED IN)

F

EXISTING

DUMPSTER

ENCLOSURE

B

A

DADKING CALCIII ATIONS

PARKING CALCULATIONS			
FIRST FLOOR: 4,502 SQ. FT. / 200 =	22.5		
SECOND FLOOR: 1,878 SQ. FT. / 300 =	6.3		
TOTAL SPACES REQUIRED: MASS TRANSIT 10% REDUCTION:	28.8 2.8		
TOTAL REQUIRED: TOTAL SPACES PROVIDED:	26 27		

PARKING SPACE DATA: STANDARD ON SITE: 20 COMPACT ON SITE: ADA ON SITE: NEW ON STREET: TOTAL PROVIDED:

150.00'

12 - EXISTING SPACES ----

F

4 - 8'-6"x20' SPACES ---

SHITTUE

PROPOSED
TENANT IMPROVEMENT
6,380 HEATED SQ. FT.

CODE DATA

CODE DATA:-2009 INTERNATIONAL BUILDING CODE (IBC) 2009 UNIFORM MECHANICAL CODE (UMC) 2009 UNIFORM PLUMBING CODE (UPC) 2011 NATIONAL ELECTRICAL CODE (NEC) 2003 ANSI A 117.1 ACCESSABILITY CODE (AC) 2009 INTERN'L ENERGY CONSRV. CODE (IECC) 2006 INTERNATIONAL FIRE CODE (IFC)

DESIGN CRITERIA

K

E

D

ZONING: C-2

CONSTRUCTION TYPE: 5B (NON SPRINKLED)

OCCUPANT LOAD: 1ST FLOOR: LOBBY / STAIR / **ELEVATOR**

OFFICE AREA 4,194/200= 42 1ST FLOOR TOTAL 4,502 S.F. 42

2ND FLOOR: LOBBY / STAIR / ELEVATOR OFFICE AREA

240 /or) 1,638/200= 16 2ND FLOOR TOTAL 1,878 S.F. 16

1ST & 2ND 6,380 S.F. 58 FLOOR TOTAL

EXIT REQUIREMENTS: (PER TABLE 1015.1) 1ST FLOOR:

B OCCUPANCY 2 EXIT REQUIRED 3 PROVIDED

2ND FLOOR: B OCCUPANCY 1 EXIT REQUIRED 1 PROVIDED

PLUMBING REQUIREMENTS: OCCUPANTS: 58

REQUIRED: WOMEN (29) W.C. LAV. DRINK FTN.

SERVICE SINK PROVIDED:

LAV. DRINK FTN. SERVICE SINK 1

AREA CALCULATIONS SEE SHT. C-2

NET AREA: NEW: 6,380 S.F EXISTING: 6,434 S.F. ADDED: -54 S.F.

ARCHITECT

Joseph B, Burwinkle, Jr. License No. NM 430 7112-119 Pan American Fwy NE Albuquerque, NM 87109 505-821-6866

DESIGNERS

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James A. Fenton, Jr. JAF Concepts PO Box 9252 Albuquerque, New Mexico 87119-925 (505) 315-9644


STRUCTURAL ENGINEER

Mike Walla Walla Engineering Ltd. 6100 Indian School Rd NE #105 Albuquerque, NM (505) 881-3008


MECHANICAL & PLUMBING ENGINEER

David Kenney Mechanical Engineering in the Southwest 2300 Campbell Road N.W. Albuquerque, New Mexico 87104

Dwight Velardy Velarde Engineering Inc. 7008 Vista Del Arroyo Albuquerque, NM 87109 505-883-6016

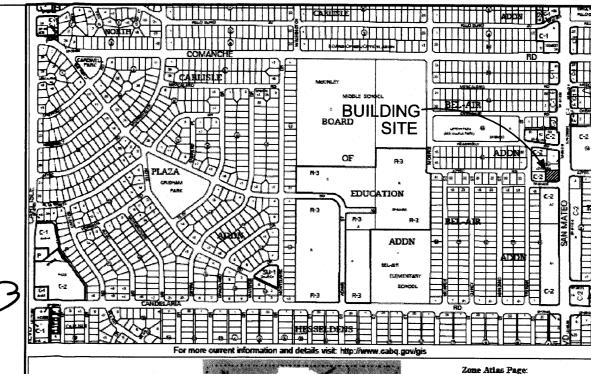



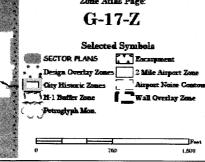

CITY ZONE MAP G-17

NO SCALE

430) wy NE

W 09

Joe Bu. . 7112-119 Pan A.. Albuquerque, 505-821

4-24-2013

 ∞

Pistol

CHECKED BY: JAF Concepts.com

DRAWN BY:

VERIFIED BY:

SCHEDULE OF DRAWINGS

C-1 NEW SITE PLAN **BUILDING DATA BUILDING CODES**

C-2 EXISTING SITE PLAN

A-1.1 DEMOLITION PLAN 1ST & 2ND FLOOR PLANS **EXISTING & PROPOSED OVERLAYS**

A-2.1 ARCHITECTURAL FIRST FLOOR PLAN FURNITURE LAYOUT

A2.2 DIMENSIONED FIRST FLOOR PLAN DOOR & WINDOW SCHEDULE

A-3.1 ARCHITECTURAL SECOND FLOOR PLAN FURNITURE LAYOUT

A-3.2 DIMENSIONED SECOND FLOOR PLAN DOOR & WINDOW SCHEDULE

A-3.3 ROOF PLAN VIEW, WINDOW & DOOR DETAILS & SCHEDULES

A-3.4 INTERIOR ELEVATIONS (RESTROOMS & CABINETS)

A-3.5 INTERIOR ELEVATIONS (RESTROOMS & CABINETS)

A-4.1 BUILDING SECTION A - NORTH TO SOUTH

A-4.2 BUILDING SECTION B - NORTH TO SOUTH

A-4.3 WALL SECTIONS

A-5.1 BUILDING SECTION C - EAST TO WEST A-5.2 BUILDING SECTION D - EAST TO WEST

A-5.3 EXISTING STRUCTURE - NORTH TO SOUTH BUILDING SECTION

A-5.4 PROPOSED STRUCTURE - NOTRH TO SOUTH BUILDING SECTION A-5-5 PARTIAL BUILDING SECTION- EXISTING STRUCTURE

A-6.1 EXISTING AND PROPOSED EAST ELEVATIONS A-6.2 EXISTING AND PROPOSED SOUTH ELEVATIONS

A-6.3 EXISTING AND PROPOSED WEST ELEVATIONS

A-6.4 EXISTING AND PROPOSED NORTH ELEVATIONS

A-7.1 REFLECTED CEILING PLAN-1 A-7.1 FIRST FLOOR REFLECTED CEILING PLAN

A-7.2 SECOND FLOOR REFLECTED CEILING PLAN

S-1 STRUCTURAL NOTES

S-2 SPECIAL INSPECTIONS FOUNDATION PLAN

S-4 2ND FLOOR FRAMING PLAN

S-5 ROOF FRAMING PLAN

S-6 FOUNDATION SECTIONS AND DETAILS

S-7 FRAMING SECTIONS AND DETAILS

FRAMING SECTIONS AND DETAILS S-9 FRAMING SECTIONS AND DETAILS

M-0.0 LEGEND & PROJECT GENERAL NOTES MP-1.1 EQUIPMENT SCHEDULE


MP-1.2 MECHANICAL DETAILS M-1.1 FIRST FLOOR MECHANICAL PLAN M-1.2 SECOND FLOOR MECHANICAL PLAN

M-1.3 ROOF PLAN M-1.4 EQUIPMENT SCHEDULE

P-1.1 FIRST AND SECOND FLOOR PLUMBING PLANS P-1.2 PLUMBING ISOMETRICS

P-1.3 PLUMBING ISOMETRICS

E-101 FIRST FLOOR POWER PLAN

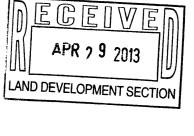

SITE PLAN ON STREET **PARKING** APPLICATION

SHEET TITLE & NO:

PROGRESS

APP'VD PRELIMINARY

CONSTRUCTION

X|*PRE−CONSTRUCTION*

PRELIMINARY

PERMIT

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AZTEC ROAD N.E.

E

K

SUL ATTACH SUPROV 3301 SAN MATEO BOULEVARD N.E. LOT G BLK 61 **BEL-AIR SUBDIVISION ALBUQUERQUE** BERNALILLO COUNTY **NEW MEXICO** SITE PLAN (ON STREET PARKING APPLICATION)

G

G

E


LOT SIZE: 18,616 SQ. FT. (.427 ACRES) UPC CODE: 101706051513241213

F

K

(505) 345-3333 **ELECTRICAL ENGINEER**

E-102 SECOND FLOOR POWER PLAN E-103 ROOF POWER PLAN E-104 POWER RISER E-105 PANEL & LIGHT FIXTURE SCHEDULES E-201 FIRST FLOOR LIGHTING PLAN E-202 SECOND FLOOR LIGHTING PLAN

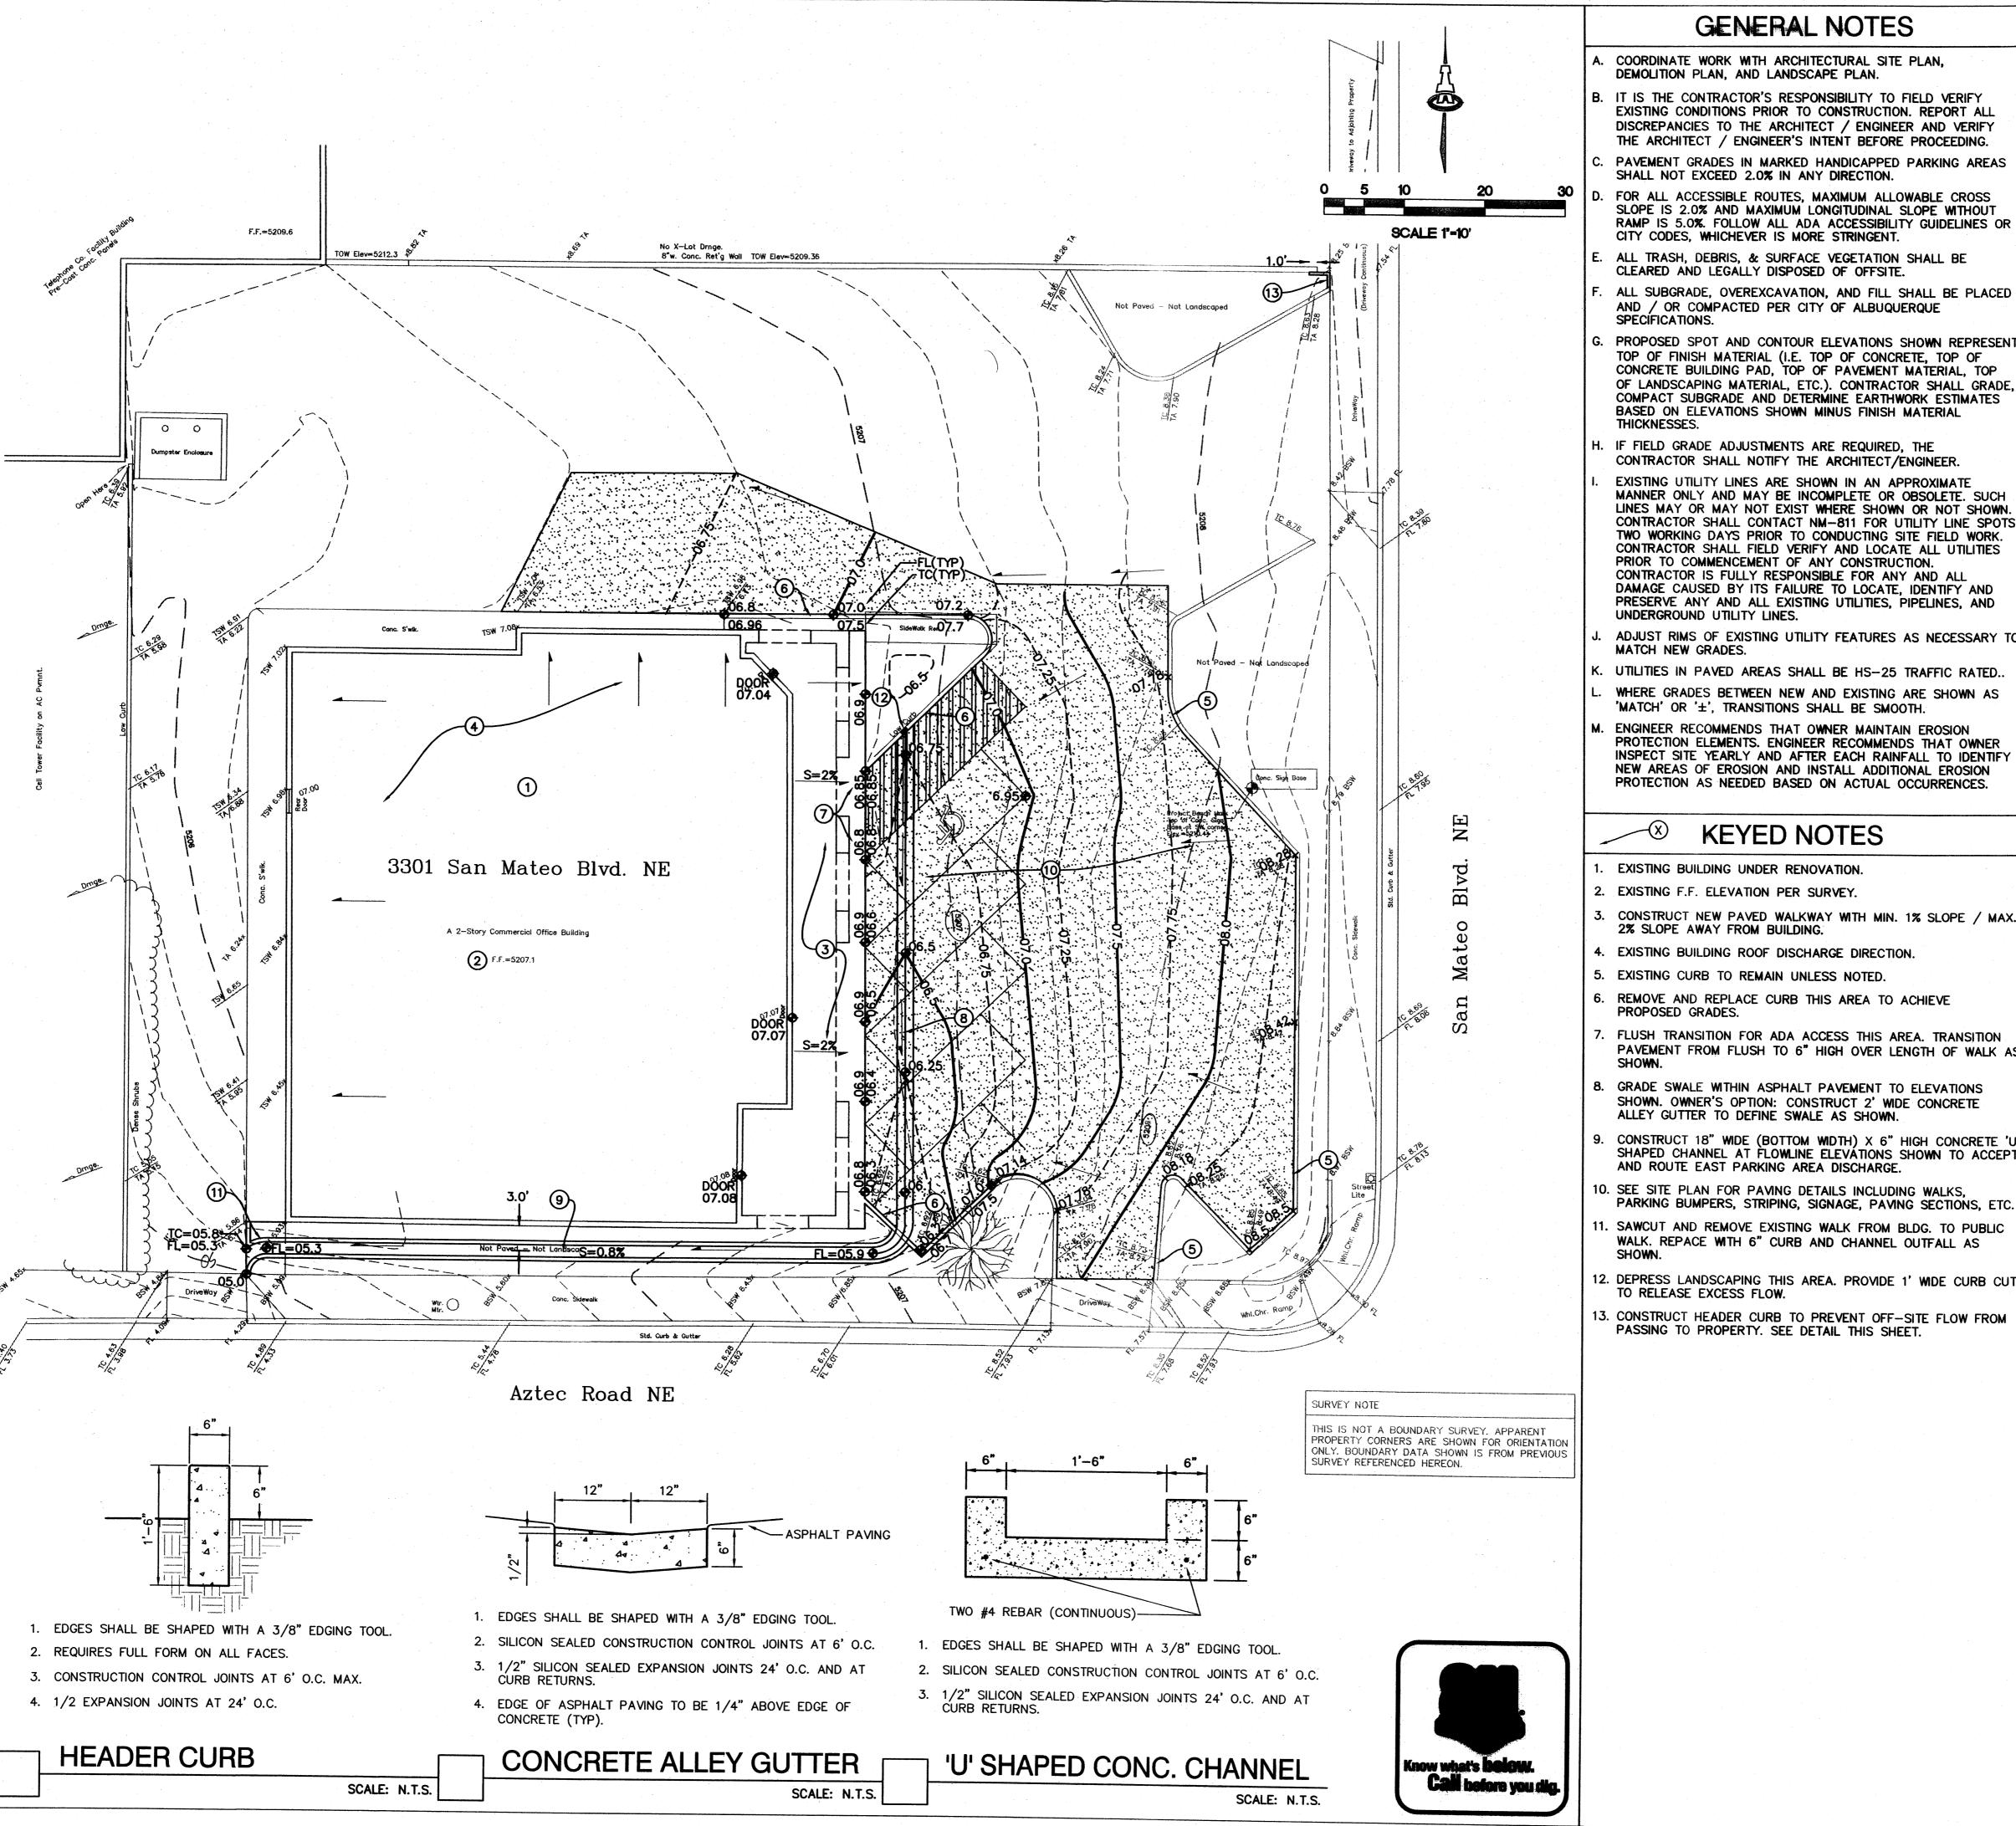

A SO PERSONAL CONTRACTOR


GENERAL NOTES

- A. COORDINATE WORK WITH ARCHITECTURAL SITE PLAN, DEMOLITION PLAN, AND LANDSCAPE PLAN.
- . It is the contractor's responsibility to field verify EXISTING CONDITIONS PRIOR TO CONSTRUCTION. REPORT ALL DISCREPANCIES TO THE ARCHITECT / ENGINEER AND VERIFY THE ARCHITECT / ENGINEER'S INTENT BEFORE PROCEEDING.
- PAVEMENT GRADES IN MARKED HANDICAPPED PARKING AREAS SHALL NOT EXCEED 2.0% IN ANY DIRECTION.
- FOR ALL ACCESSIBLE ROUTES, MAXIMUM ALLOWABLE CROSS SLOPE IS 2.0% AND MAXIMUM LONGITUDINAL SLOPE WITHOUT RAMP IS 5.0%. FOLLOW ALL ADA ACCESSIBILITY GUIDELINES OR CITY CODES, WHICHEVER IS MORE STRINGENT.
- ALL TRASH, DEBRIS, & SURFACE VEGETATION SHALL BE CLEARED AND LEGALLY DISPOSED OF OFFSITE.
- ALL SUBGRADE, OVEREXCAVATION, AND FILL SHALL BE PLACED AND / OR COMPACTED PER CITY OF ALBUQUERQUE SPECIFICATIONS.
- PROPOSED SPOT AND CONTOUR ELEVATIONS SHOWN REPRESENT TOP OF FINISH MATERIAL (I.E. TOP OF CONCRETE, TOP OF CONCRETE BUILDING PAD, TOP OF PAVEMENT MATERIAL, TOP OF LANDSCAPING MATERIAL, ETC.). CONTRACTOR SHALL GRADE, COMPACT SUBGRADE AND DETERMINE EARTHWORK ESTIMATES BASED ON ELEVATIONS SHOWN MINUS FINISH MATERIAL THICKNESSES.
- H. IF FIELD GRADE ADJUSTMENTS ARE REQUIRED, THE CONTRACTOR SHALL NOTIFY THE ARCHITECT/ENGINEER.
- EXISTING UTILITY LINES ARE SHOWN IN AN APPROXIMATE MANNER ONLY AND MAY BE INCOMPLETE OR OBSOLETE. SUCH LINES MAY OR MAY NOT EXIST WHERE SHOWN OR NOT SHOWN. CONTRACTOR SHALL CONTACT NM-811 FOR UTILITY LINE SPOTS TWO WORKING DAYS PRIOR TO CONDUCTING SITE FIELD WORK. CONTRACTOR SHALL FIELD VERIFY AND LOCATE ALL UTILITIES PRIOR TO COMMENCEMENT OF ANY CONSTRUCTION. CONTRACTOR IS FULLY RESPONSIBLE FOR ANY AND ALL DAMAGE CAUSED BY ITS FAILURE TO LOCATE, IDENTIFY AND PRESERVE ANY AND ALL EXISTING UTILITIES, PIPELINES, AND
- ADJUST RIMS OF EXISTING UTILITY FEATURES AS NECESSARY TO MATCH NEW GRADES.
- K. UTILITIES IN PAVED AREAS SHALL BE HS-25 TRAFFIC RATED. WHERE GRADES BETWEEN NEW AND EXISTING ARE SHOWN AS 'MATCH' OR '±', TRANSITIONS SHALL BE SMOOTH.
- M. ENGINEER RECOMMENDS THAT OWNER MAINTAIN EROSION PROTECTION ELEMENTS. ENGINEER RECOMMENDS THAT OWNER INSPECT SITE YEARLY AND AFTER EACH RAINFALL TO IDENTIFY NEW AREAS OF EROSION AND INSTALL ADDITIONAL EROSION PROTECTION AS NEEDED BASED ON ACTUAL OCCURRENCES.

KEYED NOTES

- 1. EXISTING BUILDING UNDER RENOVATION.
- 3. CONSTRUCT NEW PAVED WALKWAY WITH MIN. 1% SLOPE / MAX. 2% SLOPE AWAY FROM BUILDING.
- 4. EXISTING BUILDING ROOF DISCHARGE DIRECTION.
- 5. EXISTING CURB TO REMAIN UNLESS NOTED.
- 6. REMOVE AND REPLACE CURB THIS AREA TO ACHIEVE PROPOSED GRADES.
- FLUSH TRANSITION FOR ADA ACCESS THIS AREA. TRANSITION PAVEMENT FROM FLUSH TO 6" HIGH OVER LENGTH OF WALK AS
- 8. GRADE SWALE WITHIN ASPHALT PAVEMENT TO ELEVATIONS SHOWN. OWNER'S OPTION: CONSTRUCT 2' WIDE CONCRETE ALLEY GUTTER TO DEFINE SWALE AS SHOWN.
- CONSTRUCT 18" WIDE (BOTTOM WIDTH) X 6" HIGH CONCRETE 'U' SHAPED CHANNEL AT FLOWLINE ELEVATIONS SHOWN TO ACCEPT AND ROUTE EAST PARKING AREA DISCHARGE.
- 10. SEE SITE PLAN FOR PAVING DETAILS INCLUDING WALKS,
- 11. SAWCUT AND REMOVE EXISTING WALK FROM BLDG. TO PUBLIC WALK. REPACE WITH 6" CURB AND CHANNEL OUTFALL AS
- 12. DEPRESS LANDSCAPING THIS AREA. PROVIDE 1' WIDE CURB CUT TO RELEASE EXCESS FLOW.
- 13. CONSTRUCT HEADER CURB TO PREVENT OFF-SITE FLOW FROM PASSING TO PROPERTY. SEE DETAIL THIS SHEET.

VICINITY MAP

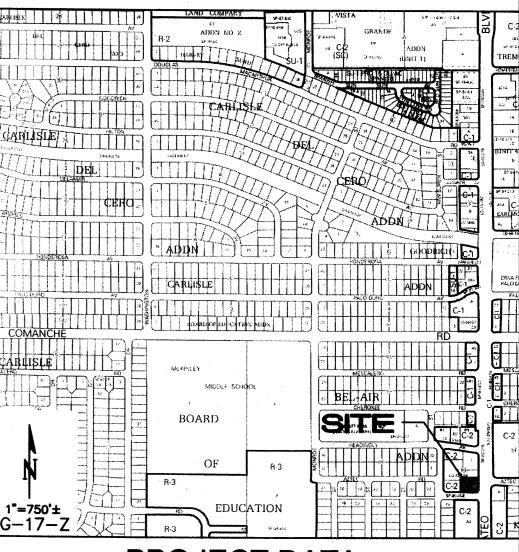

PROJECT DATA

PROPERTY: THE SITE IS A FULLY DEVELOPED PROPERTY LOCATED WITHIN C.O.A. VICINITY MAP G-17. THE SITE IS BOUND TO THE EAST BY SAN MATEO BLVD., TO THE NORTH AND WEST BY DEVELOPED COMMERCIAL PROPERTY AND TO TE SOUTH BY AZTEC RD.

LEGAL DESCRIPTION: TRACT G, BLOCK 61 OF BEL AIR ADDN.

SITE AREA: 0.43 ACRES

3301 SAN MATEO BLVD. N.E.

OFF-SITE: NO OFF-SITE DRAINAGE AFFECTS THIS PROPERTY.

FLOOD HAZARD: PER BERNALILLO COUNTY FIRM MAP #35001C0352H, THE SITE IS LOCATED WITHIN FLOODZONE 'X' DESIGNATED AS AREAS DETERMINED TO BE OUTSIDE 500-YEAR FLOODPLAIN.

DRAINAGE PLAN CONCEPT: IMPROVEMENTS INCLUDE REGRADING OF THE EAST PARKING AREA AND THE CONSTRUCTION OF A CONCRETE RUNDOWN TO CORRECT SIGNIFICANT DRAINAGE PROBLEMS WHICH HAVE RESULTED IN SIGNIFICANT BUILDING FLOODING DURING PAST STORM EVENTS. NO CHANGE TO OVERALL DISCHARGE IS EXPECTED. ALL SITE DISCHARGE WILL CONTINUE TO PASS TO AZTEC ROAD.

ENGINEER: FRED C. ARFMAN, PE

ISAACSON & ARFMAN, P.A. 128 MONROE ST NE, ABQ. NM 87108 PHONE: (505) 268-8828

SURVEYOR: REX J. VOGLER, NM PS #10466

RIO GRANDE SURVEYING CO., P.C. PHONE: (505) 764-8891


BENCHMARK: STA. 'NM_367_6', A NM SHC BRASS CAP IN C.L.

OF SAN MATEO MEDIAN NORTH OF ARVILLA AVE. ELEV. = 5209.956

LEGEND

◆34.4 PROPOSED SPOT ELEVATION PROPOSED CONTOUR (0.5' INCREMENTS) ---- PROPOSED CONTOUR (0.25' INCREMENTS) EXISTING SPOT ELEVATION FLOW ARROW TOP OF CURB ELEVATION

FLOWLINE ELEVATION F.F. FINISH FLOOR ELEVATION EXTENT OF NEW PAVEMENT

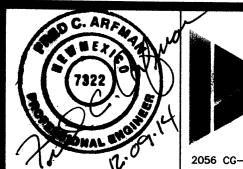

ISAACSON & ARFMAN, P.A Consulting Engineering Associates

128 Monroe Street N.E. Albuquerque, New Mexico 87108 Ph. 505-268-8828 www.iacivil.com

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> Fadduol Law Office 3301 San Mateo Blvd NE

GRADING & DRAINAGE PLAN®

Date:	No. Revision:	Date:	Job No.
05-29-14			2056
Drawn By: BJB			CG-101
Ckd By: FCA			SH OF