



• L E G E N D •

MATERIALS

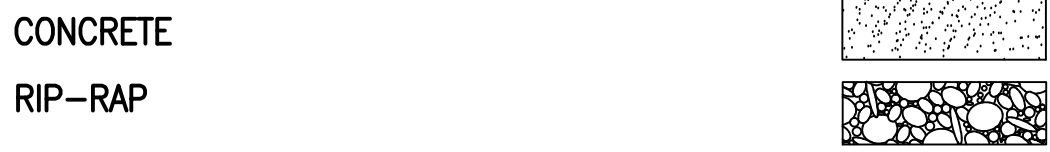


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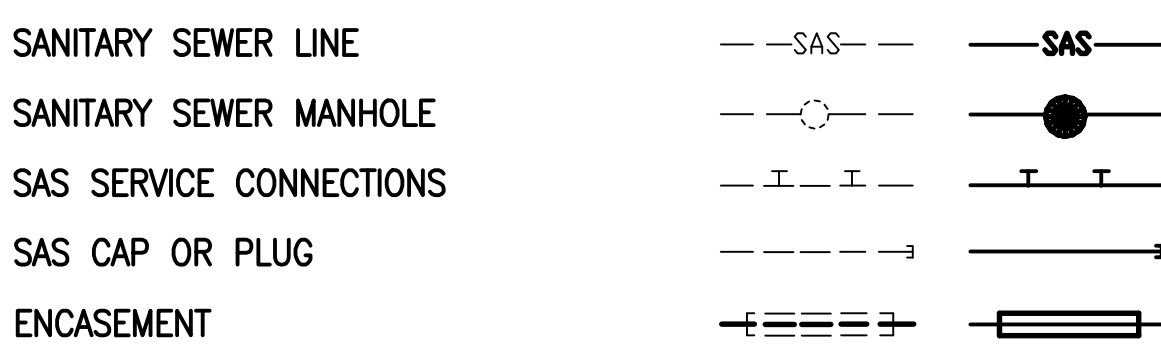
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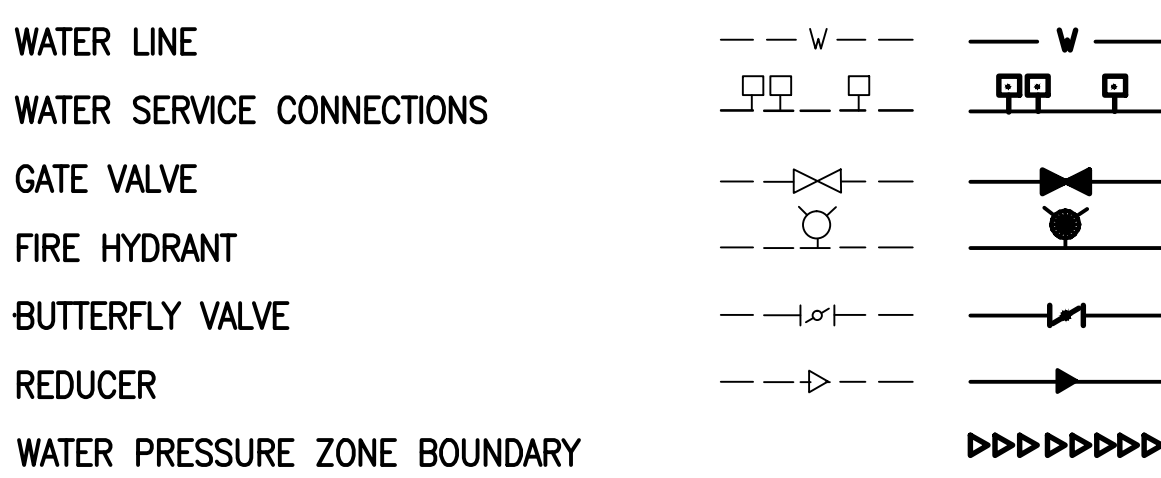
MISCELLANEOUS UTILITIES

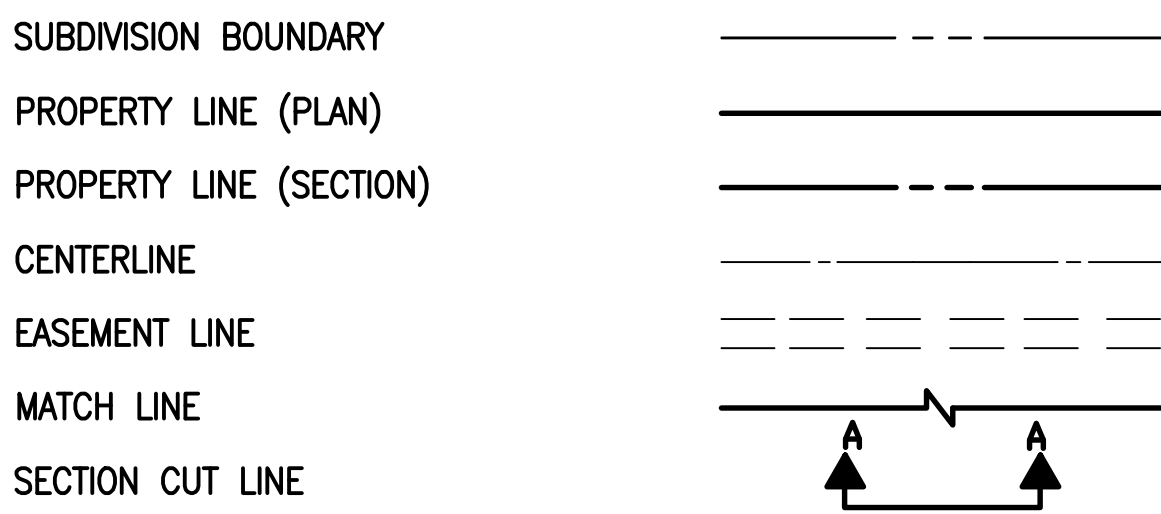


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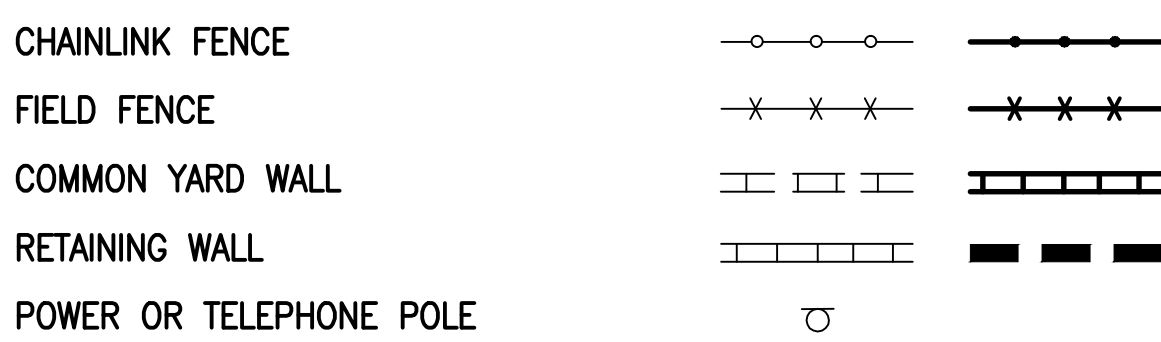
WATER



WATER FITTINGS

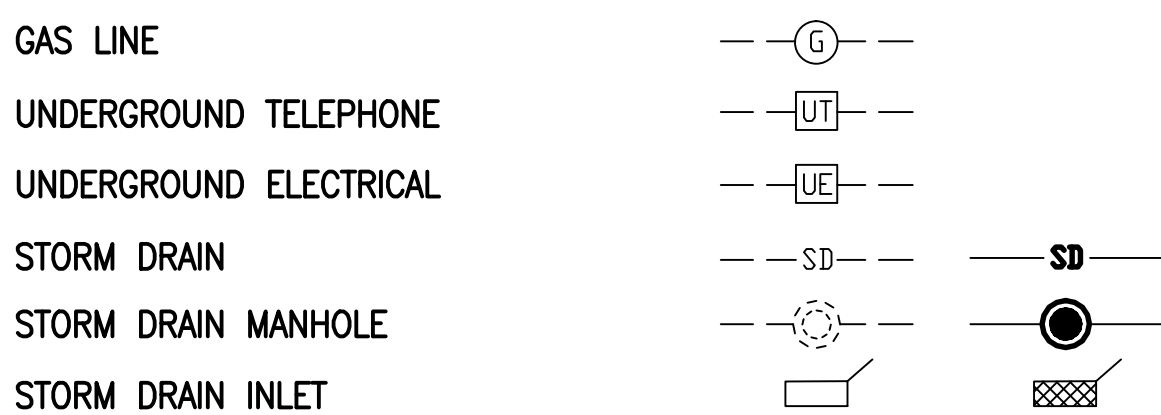

MISCELLANEOUS

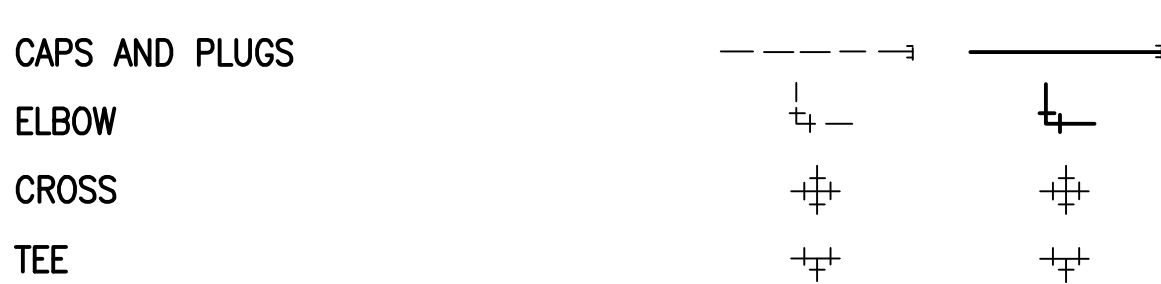

CONSTRUCTION PLANS


for

TRACK AND FIELD IMPROVEMENTS  
CLEVELAND MIDDLE SCHOOL

6910 NATALIE AVENUE N.E.


ALBUQUERQUE, NEW MEXICO

FEBRUARY, 2017

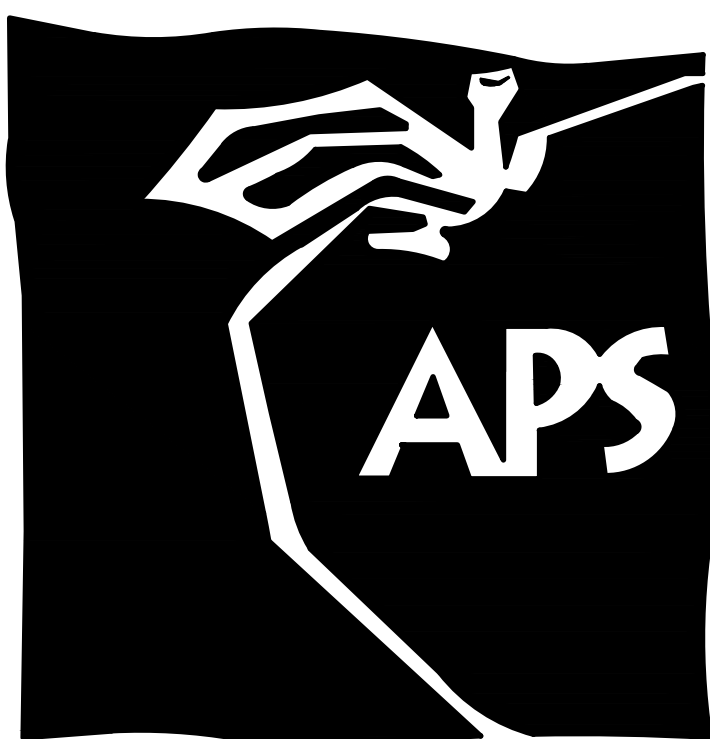

INDEX OF DRAWINGS

SHEET	DESCRIPTION
1	COVER SHEET, VICINITY MAP, GENERAL NOTES AND INDEX OF DRAWINGS
2	DEMOLITION PLAN
3	SITE PLAN
4	PAVING SECTIONS AND DETAILS
5	GRADING PLAN
6	DRAINAGE SECTIONS AND DETAILS
7	DRAINAGE PLAN AND CALCULATIONS
8	EROSION AND SEDIMENT CONTROL PLAN
9	EROSION AND SEDIMENT CONTROL PLAN SECTIONS AND DETAILS

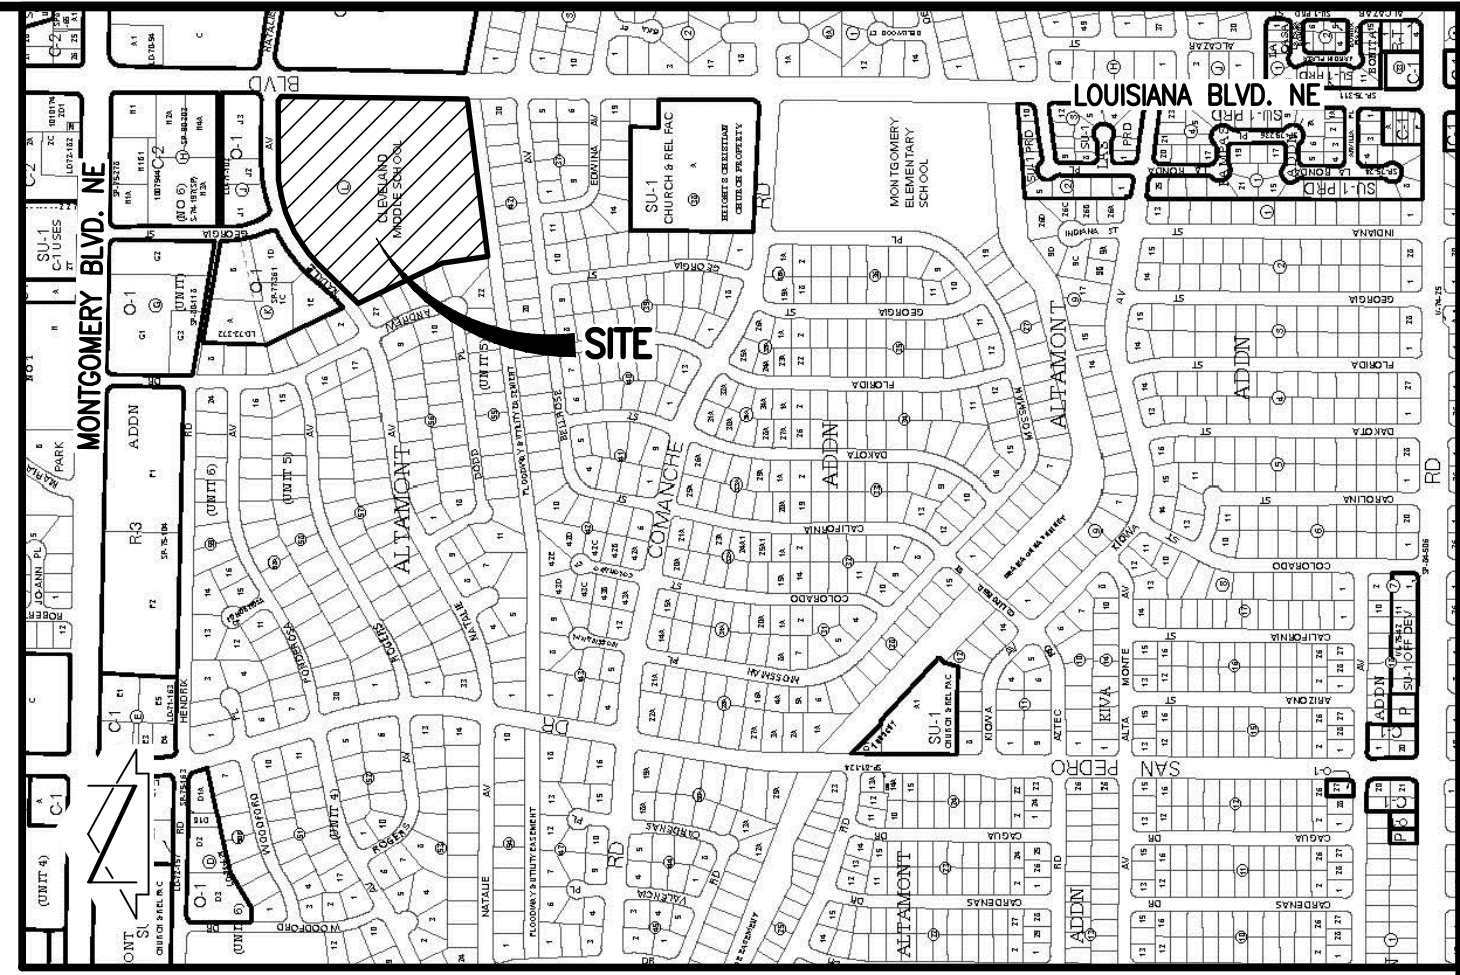

VICINITY MAP  
SCALE: 1"=750'

G-18

GENERAL NOTES

- ALL WORK DETAILED ON THESE PLANS TO BE PERFORMED UNDER CONTRACT SHALL, EXCEPT AS OTHERWISE STATED OR PROVIDED FOR HEREON, BE CONSTRUCTED IN ACCORDANCE WITH THE NEW MEXICO STANDARD SPECIFICATIONS FOR PUBLIC WORKS CONSTRUCTION - 1987, PUBLISHED BY THE NEW MEXICO CHAPTER AMERICAN PUBLIC WORKS ASSOCIATION. (REVISED 12/06)
- TWO (2) WORKING DAYS PRIOR TO ANY EXCAVATION, CONTRACTOR MUST CONTACT NEW MEXICO ONE CALL SYSTEM 811 FOR DESIGNATION (LINE-SPOTTING) OF EXISTING PUBLIC UTILITIES AND EXISTING UTILITIES OWNED AND OPERATED BY ALBUQUERQUE PUBLIC SCHOOLS.
- UTILITY INFORMATION SHOWN HEREON IS BASED UPON ON-SITE SURFACE EVIDENCE, REVIEW OF AVAILABLE CITY OF ALBUQUERQUE DISTRIBUTION MAPS, APS RECORD DRAWINGS AND UTILITY LINE-SPOTS PROVIDED BY HIGH MESA CONSULTING GROUP (APS-SUE 2016.0505). IN ADDITION, UTILITY LINE-SPOTS WERE REQUESTED VIA THE NEW MEXICO ONE CALL SERVICE (TICKET NO. 16N230451). UTILITY LINES SHOWN ON THIS DRAWING ARE SHOWN IN AN APPROXIMATE MANNER ONLY AND SUCH LINES MAY EXIST WHERE NONE ARE SHOWN. IF ANY SUCH EXISTING LINES ARE SHOWN, THE LOCATION IS BASED UPON INFORMATION PROVIDED BY THE OWNER OF SAID UTILITY, AND THE INFORMATION MAY BE INCOMPLETE, OR MAY BE OBSOLETE BY THE TIME CONSTRUCTION COMMENCES. THE SURVEYOR HAS CONDUCTED ONLY PRELIMINARY INVESTIGATION OF THE LOCATION, DEPTH, SIZE, OR TYPE OF EXISTING UTILITY LINES, PIPELINES, OR UNDERGROUND UTILITY LINES. THIS INVESTIGATION IS NOT CONCLUSIVE, AND MAY NOT BE COMPLETE, THEREFORE, MAKES NO REPRESENTATION PERTAINING THERETO, AND ASSUMES NO RESPONSIBILITY OR LIABILITY THEREFOR. THE PROPERTY OWNER, DEVELOPER, OR CONTRACTOR SHALL INFORM ITSELF OF THE LOCATION OF ANY UTILITY LINE, PIPELINE, OR UNDERGROUND UTILITY LINE IN OR NEAR THE AREA OF THE WORK IN ADVANCE OF AND DURING EXCAVATION WORK. THE PROPERTY OWNER, DEVELOPER, OR CONTRACTOR IS FULLY RESPONSIBLE FOR ANY AND ALL DAMAGE CAUSED BY ITS FAILURE TO LOCATE, IDENTIFY AND PRESERVE ANY AND ALL EXISTING UTILITIES, PIPELINES, AND UNDERGROUND UTILITY LINES. IN PLANNING AND CONDUCTING EXCAVATION, THE CONTRACTOR SHALL COMPLY WITH STATE STATUTES, MUNICIPAL AND LOCAL ORDINANCES, RULES AND REGULATIONS, IF ANY, PERTAINING TO THE LOCATION OF THESE LINES AND FACILITIES.
- SHOULD A CONFLICT EXIST BETWEEN THESE PLANS AND ACTUAL FIELD CONDITIONS, THE CONTRACTOR SHALL PROMPTLY NOTIFY THE ENGINEER IN WRITING SO THAT THE CONFLICT CAN BE RESOLVED WITH A MINIMUM AMOUNT OF DELAY FOR ALL PARTIES.
- THE CONTRACTOR SHALL MAINTAIN ACCESS TO ADJACENT PROPERTIES DURING CONSTRUCTION.
- ALL WORK ON THIS PROJECT SHALL BE PERFORMED IN ACCORDANCE WITH APPLICABLE FEDERAL, STATE AND LOCAL LAWS, RULES AND REGULATIONS CONCERNING SAFETY AND HEALTH.
- THE CONTRACTOR SHALL ENSURE THAT NO SOIL ERODES FROM THE SITE INTO PUBLIC RIGHT-OF-WAY OR ONTO PRIVATE PROPERTY.
- THE CONTRACTOR SHALL PROMPTLY CLEAN UP ANY MATERIAL EXCAVATED WITHIN THE PUBLIC RIGHT-OF-WAY SO THAT THE EXCAVATED MATERIAL IS NOT SUSCEPTIBLE TO BEING WASHED DOWN THE STREET.
- CONTRACTOR SHALL NOTIFY THE ENGINEER NOT LESS THAN SEVEN (7) DAYS PRIOR TO STARTING WORK IN ORDER THAT THE ENGINEER MAY TAKE NECESSARY MEASURES TO ENSURE THE PRESERVATION OF SURVEY MONUMENTS. CONTRACTOR SHALL NOT DISTURB PERMANENT SURVEY MONUMENTS WITHOUT THE CONSENT OF THE ENGINEER AND SHALL NOTIFY THE ENGINEER AND BEAR THE EXPENSE OF REPLACING ANY THAT MAY BE DISTURBED WITHOUT PERMISSION. REPLACEMENT SHALL BE DONE ONLY WHEN A CHANGE IS MADE IN THE FINISHED ELEVATION OF THE PAVEMENT OF ANY ROADWAY IN WHICH A PERMANENT SURVEY MONUMENT IS LOCATED. CONTRACTOR SHALL, AT HIS OWN EXPENSE, ADJUST THE MONUMENT COVER TO THE NEW GRADE UNLESS OTHERWISE SPECIFIED.
- ALL PAVEMENT MARKINGS AND TRAFFIC SIGNS SHALL COMPLY WITH THE MANUAL OF UNIFORM TRAFFIC CONTROL DEVICES (MUTCD) PUBLISHED BY THE U.S. DEPARTMENT OF TRANSPORTATION FEDERAL HIGHWAY ADMINISTRATION, LATEST EDITION.
- IF THE REMOVAL OF EXISTING CURB AND GUTTER, SIDEWALK, AND/OR PAVING IS REQUIRED, THE CONTRACTOR SHALL SAWCUT AND/OR REMOVE TO THE NEAREST JOINT. WHEN ABUTTING NEW PAVEMENT TO EXISTING, THE CONTRACTOR SHALL CUT BACK THE EXISTING PAVING TO A STRAIGHT LINE IN ORDER TO REMOVE ANY BROKEN OR CRACKED PAVEMENT. CURB AND GUTTER AND/OR PAVEMENT SHOWN AS EXISTING AND NOT TO BE REMOVED UNDER THIS CONTRACT AND WHICH IS DAMAGED OR DISPLACED BY THE CONTRACTOR SHALL BE REMOVED AND REPLACED BY THE CONTRACTOR AT THE CONTRACTOR'S EXPENSE.
- A DISPOSAL SITE FOR ALL EXCESS EXCAVATION MATERIAL (CONTAMINATED OR OTHERWISE), ASPHALTIC PAVING, CONCRETE PAVING, ETC. SHALL BE OBTAINED BY THE CONTRACTOR IN COMPLIANCE WITH APPLICABLE REGULATIONS. ALL COSTS INCURRED IN OBTAINING A DISPOSAL SITE AND IN HAUL THERETO SHALL BE CONSIDERED INCIDENTAL TO CONSTRUCTION, THEREFORE, NO SEPARATE PAYMENT SHALL BE MADE.
- A BORROW SITE FOR IMPORT MATERIAL SHALL BE OBTAINED BY THE CONTRACTOR IN COMPLIANCE WITH APPLICABLE REGULATIONS. ALL COSTS INCURRED IN OBTAINING A BORROW SITE AND IN HAUL THERETO SHALL BE CONSIDERED INCIDENTAL TO CONSTRUCTION, THEREFORE, NO SEPARATE PAYMENT SHALL BE MADE.
- THE CONTRACTOR SHALL BE RESPONSIBLE FOR SAFELY OBTAINING THE REQUIRED COMPACTION. THE CONTRACTOR SHALL SELECT AND USE METHODS WHICH SHALL NOT BE INJURIOUS OR DAMAGING TO THE EXISTING FACILITIES AND STRUCTURES WHICH SURROUND THE WORK AREA.
- THE CONTRACTOR SHALL CONFINE HIS WORK WITHIN THE CONSTRUCTION LIMITS IN ORDER TO PRESERVE THE EXISTING IMPROVEMENTS AND SO AS NOT TO INTERFERE WITH THE OPERATIONS OF THE EXISTING FACILITIES.
- THE CONTRACTOR SHALL BE RESPONSIBLE FOR SELECTING APPROPRIATE MEANS AND METHODS TO EXCAVATE AND TRENCH AND/OR INSTALL PIPE SO AS TO NOT EXCEED RIGHT-OF-WAY OR EASEMENT LIMITS, AND SO AS NOT TO INTERFERE WITH OTHER UTILITIES OR IMPROVEMENTS. THIS SHALL BE CONSIDERED INCIDENTAL TO CONSTRUCTION, THEREFORE, NO SEPARATE PAYMENT WILL BE MADE.
- THE CONTRACTOR SHALL BE RESPONSIBLE FOR PROTECTING, SUPPORTING AND REPLACING, IF DAMAGED, ALL UTILITIES ENCOUNTERED DURING CONSTRUCTION. THIS SHALL BE CONSIDERED INCIDENTAL TO CONSTRUCTION, THEREFORE, NO SEPARATE PAYMENT WILL BE MADE.
- ALL DIMENSIONS AND RADII OF CURB, CURB RETURNS, AND WALLS ARE SHOWN TO THE FACE OF CURB AND/OR WALL.
- THE CONTRACTOR SHALL NOTIFY THE OWNER 48 HOURS PRIOR TO STRIPING SO THAT LAYOUT CAN BE VERIFIED.
- PRIOR TO CONSTRUCTION, THE CONTRACTOR SHALL EXCAVATE AND VERIFY THE HORIZONTAL AND VERTICAL LOCATION OF ALL POTENTIAL OBSTRUCTIONS. SHOULD A CONFLICT EXIST, THE CONTRACTOR SHALL NOTIFY THE ENGINEER IN WRITING SO THAT THE CONFLICT CAN BE RESOLVED WITH A MINIMUM AMOUNT OF DELAY. THE CONTRACTOR SHALL BE RESPONSIBLE FOR ALL INTERPRETATIONS IT MAKES WITHOUT FIRST CONTACTING THE ENGINEER AS REQUIRED ABOVE.
- WHEN APPLICABLE, CONTRACTOR SHALL SECURE, ON BEHALF OF THE OWNER AND OPERATORS, "TOPSOIL DISTURBANCE PERMIT" FROM THE CITY AND/OR FILE A NOTICE OF INTENT (N.O.I.) WITH THE EPA PRIOR TO BEGINNING CONSTRUCTION.
- ALL FILL SHALL BE CLEAN, FREE FROM VEGETATION, DEBRIS, AND OTHER DELETERIOUS MATERIALS, AND SHALL NOT BE CONTAMINATED WITH HYDROCARBONS OR OTHER CHEMICAL CONTAMINANTS.
- ALL FILL SHALL BE COMPACTED TO A MINIMUM OF 95% ASTM D-1557 UNLESS A GREATER COMPACTION REQUIREMENT IS OTHERWISE SPECIFIED.
- CAUTION: THESE DRAWINGS DO NOT INCLUDE NECESSARY COMPONENTS FOR CONSTRUCTION SAFETY WHICH SHALL REMAIN THE RESPONSIBILITY OF THE CONTRACTOR. ALL EXCAVATION, TRENCHING AND SHORING ACTIVITIES MUST BE CARRIED-OUT IN ACCORDANCE WITH OSHA 29 CFR 1926, SUBPART P-EXCAVATIONS.

JOB NO. 2016.180.3

REV.	SHEETS	CITY	ENGINEER	DATE	USER	DEPARTMENT	DATE	USER	DEPARTMENT	DATE
APPROVAL OF REVISIONS										

	<b>HIGH MESA Consulting Group</b> 6010-B Midway Park Blvd. NE • Albuquerque, New Mexico 87109 Phone: 505.346.4250 • Fax: 505.346.4254 • www.highmesaeng.com		APPROVED FOR CONSTRUCTION
	C.E.		SHEET 1 OF 9

2-6-2017



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**HIGH MESA Consulting Group**  
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**DEMOLITION PLAN**  
**TRACK AND FIELD IMPROVEMENTS**  
**CLEVELAND MIDDLE SCHOOL**  
**6910 NATALIE AVENUE N.E.**

**LEGEND**

AP	ASPHALT PAVEMENT
BBC	BASKETBALL GOAL
BH	BUILDING OVERHANG
BR	BICYCLE RACK
C&G	CURB AND GUTTER
CM	SECURITY CAMERA
CDP	CONCRETE DRIVE PAD
CF	LANDSCAPING CRUSHER FINES
CHC	CONCRETE HEADER CURB
CHW	CONCRETE HEAD WALL
CI	CAST IRON PIPE
CLF	CHAIN LINK FENCE
CMF	CORRUGATED METAL PIPE
CMU	CONCRETE MASONRY WALL
CND	CONDUIT
CO	CLEANOUT
CONC	CONCRETE
CS	CONCRETE RUNDOWN
CSW	CONCRETE SIDEWALK
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GS	GAS SERVICE
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GW	GUY WIRE ANCHOR
ICB	IRRIGATION CONTROL BOX
IVB	IRRIGATION VALVE BOX
LSO	METAL LANDSCAPING DIVIDER
MBC	METAL BUILDING COLUMN
MBN	METAL BENCH
MC/BIB	METER CAN WITH BIB VALVE
MNH	MANHOLE
MHR	METAL HANDRAIL
MLN	METAL LANDING
MPT	METAL PICNIC TABLE
MR	METAL RAMP
MS	METAL STAIRS
MTC	METAL TRASH CAN
OH(1)	OVERHEAD COMMUNICATION (# OF LINES)
OH(1)	OVERHEAD ELECTRIC (# OF LINES)
OHM	OVERHEAD UTILITY MAST
PED	STEEL PIEDestal
POD	BUILDING ROOF DRAIN
SAS	SANITARY SEWER
SD	STORM DRAIN
SDI	STORM DRAIN INLET
SDMH	STORM DRAIN MANHOLE
SP	STEEL POLE
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TC	TOP OF CURB
TCC	TOP OF CONCRETE CHANNEL
TG	TOP OF CONCRETE
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TS	TRAFFIC SIGN
TW	TOP OF WALL
VC	CONCRETE VALLEY GUTTER
W/P/M	WATER LINE BY PAINT MARK
WCP	WOOD COMMUNICATION POLE
WCR	CONCRETE WHEELCHAIR RAMP
WLX	WATER LINE EXPOSED
WPP	WOOD POWER POLE

*	PAINTED UTILITY MARKER
1.0' 0"	DIAMETER OF TREE
	DECIDUOUS TREE
	SHRUB
	YUCCA
	PROPOSED CONCRETE PAVING
	PROPOSED ASPHALT PAVING
	PROPOSED TURF GRASS (FIELD)
	STABILIZED CRUSHER FINES PATH

**BENCHMARKS**

- PROJECT BENCHMARK**  
A 3" BRASS DISK STAMPED "11-019", SET FLUSH WITH THE GROUND, NEAR THE SOUTHEAST QUADRANT OF THE INTERSECTION OF LOUISIANA BOULEVARD AND VERANDA ROAD N.E.  
ELEVATION = 5309.898 FEET (NAVD 1988)
- TEMPORARY BENCHMARK #1 (T.B.M.)**  
A MAG NAIL W/WASHER SET IN ASPHALT, NEAR THE SOUTHWEST CORNER OF THE BAND BUILDING, AS SHOWN ON THIS SHEET.  
ELEVATION = 5291.16 FEET (NAVD 88)
- TEMPORARY BENCHMARK #2 (T.B.M.)**  
A MAG NAIL W/WASHER SET IN AN ASPHALT PATH, NEAR THE NORTHEAST CORNER OF A BASKETBALL COURT, AS SHOWN ON THIS SHEET.  
ELEVATION = 5288.31 FEET (NAVD 88)
- TEMPORARY BENCHMARK #3 (T.B.M.)**  
A CHISELED "4" SET IN A CONCRETE BASKETBALL COURT, NEAR THE SOUTHERN PORTION OF THE SITE, AS SHOWN ON THIS SHEET.  
ELEVATION = 5287.63 FEET (NAVD 88)

**CONSTRUCTION NOTES:**

- TWO (2) WORKING DAYS PRIOR TO ANY EXCAVATION, CONTRACTOR MUST CONTACT NEW MEXICO ONE CALL SYSTEM, 811, FOR DESIGNATION (LINE-SPOTTING) OF EXISTING UTILITIES.
- PRIOR TO CONSTRUCTION, THE CONTRACTOR SHALL EXCAVATE AND VERIFY THE HORIZONTAL AND VERTICAL LOCATION OF ALL POTENTIAL OBSTRUCTIONS. SHOULD A CONFLICT EXIST, THE CONTRACTOR SHALL NOTIFY THE ENGINEER IN WRITING SO THAT THE CONFLICT CAN BE RESOLVED WITH A MINIMUM AMOUNT OF DELAY. THE CONTRACTOR SHALL BE RESPONSIBLE FOR ALL INTERPRETATIONS IT MAKES WITHOUT FIRST CONTACTING THE ENGINEER AS REQUIRED ABOVE.
- ALL WORK ON THIS PROJECT SHALL BE PERFORMED IN ACCORDANCE WITH APPLICABLE FEDERAL, STATE AND LOCAL LAWS, RULES AND REGULATIONS CONCERNING CONSTRUCTION SAFETY AND HEALTH.
- ALL CONSTRUCTION WITHIN PUBLIC RIGHT-OF-WAY SHALL BE PERFORMED IN ACCORDANCE WITH APPLICABLE CITY OF ALBUQUERQUE STANDARDS AND PROCEDURES.
- UTILITY INFORMATION SHOWN HEREON IS BASED UPON ON-SITE SURFACE EVIDENCE, REVIEW OF AVAILABLE CITY OF ALBUQUERQUE DISTRIBUTION MAPS, APS RECORD DRAWINGS AND UTILITY LINE-SPOTS PROVIDED BY HIGH MESA CONSULTING GROUP (APS-SUE 2016.0505). IN ADDITION, UTILITY LINE-SPOTS WERE REQUESTED VIA THE NEW MEXICO ONE CALL SERVICE (TICKET NO. 16N230451). UTILITY LINES SHOWN ON THIS DRAWING ARE SHOWN IN AN APPROXIMATE MANNER ONLY, AND SUCH LINES MAY EXIST WHERE NONE ARE SHOWN. IF ANY SUCH EXISTING LINES ARE SHOWN, THE LOCATION IS BASED UPON INFORMATION PROVIDED BY THE OWNER OF SAID UTILITY, AND THE INFORMATION MAY BE INCOMPLETE, OR MAY BE OBSOLETE BY THE TIME CONSTRUCTION COMMENCES. THE SURVEYOR HAS CONDUCTED ONLY PRELIMINARY INVESTIGATION OF THE LOCATION, DEPTH, SIZE, OR TYPE OF EXISTING UTILITY LINES, PIPELINES, OR UNDERGROUND UTILITY LINES. THIS INVESTIGATION IS NOT CONCLUSIVE, AND MAY NOT BE COMPLETE. THEREFORE, MAKES NO REPRESENTATION PERTAINING THERETO, AND ASSUMES NO RESPONSIBILITY OR LIABILITY THEREFOR. THE PROPERTY OWNER, DEVELOPER, OR CONTRACTOR SHALL INFORM ITSELF OF THE LOCATION OF ANY UTILITY LINE, PIPELINE, OR UNDERGROUND UTILITY LINE IN OR NEAR THE AREA OF THE WORK IN ADVANCE OF AND DURING EXCAVATION WORK. THE PROPERTY OWNER, DEVELOPER, OR CONTRACTOR IS FULLY RESPONSIBLE FOR ANY AND ALL DAMAGE CAUSED BY ITS FAILURE TO LOCATE, IDENTIFY AND PRESERVE ANY AND ALL EXISTING UTILITIES, PIPELINES, AND UNDERGROUND UTILITY LINES. IN PLANNING AND CONDUCTING EXCAVATION, THE CONTRACTOR SHALL COMPLY WITH STATE, MUNICIPAL AND LOCAL ORDINANCES, RULES AND REGULATIONS, IF ANY, PERTAINING TO THE LOCATION OF THESE LINES AND FACILITIES.
- THE GRADES INDICATED ON THIS PLAN ARE FINISHED GRADES UNLESS OTHERWISE INDICATED. THE CONTRACTOR SHALL BE RESPONSIBLE FOR LEAVING SUBGRADE AT ELEVATIONS THAT SHALL ACCOMMODATE PROPOSED IMPROVEMENTS AS INDICATED ON THE PLANS INCLUDING, BUT NOT LIMITED TO, SURFACE DRAINAGE STRUCTURES, PAVING AND LANDSCAPING SURFACING.

**EROSION CONTROL MEASURES:**

- THE CONTRACTOR SHALL ENSURE THAT NO SOIL ERODES FROM THE SITE INTO PUBLIC RIGHT-OF-WAY OR ONTO PRIVATE PROPERTY.
- THE CONTRACTOR SHALL PROMPTLY CLEAN UP ANY MATERIAL EXCAVATED WITHIN THE PUBLIC RIGHT-OF-WAY SO THAT THE EXCAVATED MATERIAL IS NOT SUSCEPTIBLE TO BEING WASHED DOWN THE STREET.
- WHEN APPLICABLE, CONTRACTOR SHALL SECURE "TOPSOIL DISTURBANCE PERMIT" FROM THE CITY AND/OR FILE A NOTICE OF INTENT (N.O.I.) WITH THE EPA PRIOR TO BEGINNING CONSTRUCTION.

**DEMOLITION KEYED NOTES:**

- REMOVE AND DISPOSE OF CONCRETE BASKETBALL COURT
- REMOVE AND RETURN BASKETBALL GOALS TO OWNER (OWNER HAS FIRST RIGHT OF SALVAGE)
- REMOVE AND RELOCATE METER CAN, SEE LANDSCAPE PLANS
- REMOVE AND RELOCATE IRRIGATION VALVE BOXES, SEE LANDSCAPE PLANS
- REMOVE AND RETURN METAL TRASH CAN TO OWNER
- REMOVE AND RETURN FLOCKER BALL GOALS TO OWNER (OWNER HAS FIRST RIGHT OF SALVAGE)
- REMOVE AND RETURN WOOD POWER POLE TO OWNER (OWNER HAS FIRST RIGHT OF SALVAGE)
- NEATLY SAWCUT EXISTING ASPHALT PAVEMENT
- REMOVE AND DISPOSE OF EXISTING ASPHALT PAVEMENT
- EXISTING POWER POLE TO REMAIN
- EXISTING STORM DRAIN / SANITARY SEWER MANHOLE TO REMAIN
- EXISTING CHAIN LINK FENCE TO REMAIN
- EXISTING CONCRETE PAVEMENT TO REMAIN
- EXISTING ASPHALT PAVEMENT TO REMAIN

**SURVEY NOTE:**

THIS IS NOT A BOUNDARY SURVEY; DATA IS SHOWN FOR ORIENTATION ONLY. THE BOUNDARY INFORMATION DEPICTED BY THIS PLAN IS BASED UPON AN BOUNDARY SURVEY PREPARED BY HIGH MESA CONSULTING GROUP, NMPS 15075, DATED 12/21/2016 (2016.180.1). THE TOPOGRAPHIC INFORMATION DEPICTED HEREON IS BASED UPON THE PARTIAL TOPOGRAPHIC AND UTILITY SURVEY PREPARED BY HIGH MESA CONSULTING GROUP, NMPS NO. 15075, DATED 12/21/2016 (2016.180.1).



2-6-2017

DESIGNED BY <u>J.D.S.</u>	NO.	DATE	BY	REVISIONS	JOB NO.
					2016.180.3
DRAWN BY <u>J.Y.R./S.C.C.</u>					DATE
					02-2017
APPROVED BY <u>G.M.</u>					SHEET
					2 OF 9



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File Name: 161803-SH3-DWG Plot Time: 09:45 am

**SITE PLAN**  
**TRACK AND FIELD IMPROVEMENTS**  
**CLEVELAND MIDDLE SCHOOL**  
**6910 NATALIE AVENUE N.E.**

**LEGEND**

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GRV	LANDSCAPING GRAVEL
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1:0'9	DIAMETER OF TREE
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	PROPOSED CONCRETE PAVING
	PROPOSED ASPHALT PAVING
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	PROPOSED BASE COURSE

**BENCHMARKS**

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**CONSTRUCTION NOTES:**

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- PRIOR TO CONSTRUCTION, THE CONTRACTOR SHALL EXCAVATE AND VERIFY THE HORIZONTAL AND VERTICAL LOCATION OF ALL POTENTIAL OBSTRUCTIONS. SHOULD A CONFLICT EXIST, THE CONTRACTOR SHALL NOTIFY THE ENGINEER IN WRITING SO THAT THE CONFLICT CAN BE RESOLVED WITH A MINIMUM AMOUNT OF DELAY. THE CONTRACTOR SHALL BE RESPONSIBLE FOR ALL INTERPRETATIONS. IT MAKES WITHOUT FIRST CONTACTING THE ENGINEER AS REQUIRED ABOVE.
- ALL WORK ON THIS PROJECT SHALL BE PERFORMED IN ACCORDANCE WITH APPLICABLE FEDERAL, STATE AND LOCAL LAWS, RULES AND REGULATIONS CONCERNING CONSTRUCTION SAFETY AND HEALTH.
- ALL CONSTRUCTION WITHIN PUBLIC RIGHT-OF-WAY SHALL BE PERFORMED IN ACCORDANCE WITH APPLICABLE CITY OF ALBUQUERQUE STANDARDS AND PROCEDURES.
- UTILITY INFORMATION SHOWN HEREON IS BASED UPON ON-SITE SURFACE EVIDENCE, REVIEW OF AVAILABLE CITY OF ALBUQUERQUE DISTRIBUTION MAPS, APS RECORD DRAWINGS AND UTILITY LINE-SPOTS PROVIDED BY HIGH MESA CONSULTING GROUP (APS-SUE 2016.0505). IN ADDITION, UTILITY LINE-SPOTS WERE REQUESTED VIA THE NEW MEXICO ONE CALL SERVICE (TICKET NO. 16N230451). UTILITY LINES SHOWN ON THIS DRAWING ARE SHOWN IN AN APPROXIMATE MANNER ONLY, AND SUCH LINES MAY EXIST WHERE NONE ARE SHOWN. IF ANY SUCH EXISTING LINES ARE SHOWN, THE LOCATION IS BASED UPON INFORMATION PROVIDED BY THE OWNER OF SAID UTILITY, AND THE INFORMATION MAY BE INCOMPLETE, OR MAY BE OBSOLETE BY THE TIME CONSTRUCTION COMMENCES. THE SURVEYOR HAS CONDUCTED ONLY PRELIMINARY INVESTIGATION OF THE LOCATION, DEPTH, SIZE, OR TYPE OF EXISTING UTILITY LINES, PIPELINES, OR UNDERGROUND UTILITY LINES. THIS INVESTIGATION IS NOT CONCLUSIVE, AND MAY NOT BE COMPLETE. THEREFORE, MAKES NO REPRESENTATION PERTAINING THERETO, AND ASSUMES NO RESPONSIBILITY OR LIABILITY THEREFOR. THE PROPERTY OWNER, DEVELOPER, OR CONTRACTOR SHALL INFORM ITSELF OF THE LOCATION OF ANY UTILITY LINE, PIPELINE, OR UNDERGROUND UTILITY LINE IN OR NEAR THE AREA OF THE WORK IN ADVANCE OF AND DURING EXCAVATION WORK. THE PROPERTY OWNER, DEVELOPER, OR CONTRACTOR IS FULLY RESPONSIBLE FOR ANY AND ALL DAMAGE CAUSED BY ITS FAILURE TO LOCATE, IDENTIFY AND PRESERVE ANY AND ALL EXISTING UTILITIES, PIPELINES, AND UNDERGROUND UTILITY LINES. IN PLANNING AND CONDUCTING EXCAVATION, THE CONTRACTOR SHALL COMPLY WITH STATE STATUTES, MUNICIPAL AND LOCAL ORDINANCES, RULES AND REGULATIONS, IF ANY, PERTAINING TO THE LOCATION OF THESE LINES AND FACILITIES.
- THE GRADES INDICATED ON THIS PLAN ARE FINISHED GRADES UNLESS OTHERWISE INDICATED. THE CONTRACTOR SHALL BE RESPONSIBLE FOR LEAVING SUBGRADE AT ELEVATIONS THAT SHALL ACCOMMODATE PROPOSED IMPROVEMENTS AS INDICATED ON THE PLANS INCLUDING, BUT NOT LIMITED TO, SURFACE DRAINAGE STRUCTURES, PAVING AND LANDSCAPING SURFACING.

**EROSION CONTROL MEASURES:**

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- WHEN APPLICABLE, CONTRACTOR SHALL SECURE "TOPSOIL DISTURBANCE PERMIT" FROM THE CITY AND/OR FILE A NOTICE OF INTENT (N.O.I.) WITH THE EPA PRIOR TO BEGINNING CONSTRUCTION.

**SITE KEYED NOTES:**

- CONSTRUCT 2" ASPHALT PAVEMENT PER TYPICAL SECTION, SHEET 4
- ADJUST EXISTING SANITARY SEWER MANHOLE TO GRADE AND INSTALL CONCRETE COLLAR PER TYPICAL DETAIL, SHEET 4
- CONSTRUCT ASPHALT TRACK PER TYPICAL SECTION, SHEET 4
- CONSTRUCT MOUNTABLE ROLL CURB PER TYPICAL SECTION, SHEET 4
- CONSTRUCT MOUNTABLE ROLL CURB (DEPRESSED) PER TYPICAL SECTION, SHEET 4
- CONSTRUCT SIDEWALK PER TYPICAL SECTION, SHEET 4
- INSTALL 4" PAINTED "ACCESSIBLE PATH" LINES WITH WHITE PAINT (TRAFFIC RATED OR APPROVED SUBSTITUTE)
- INSTALL 2" PAINTED LANE LINES WITH WHITE PAINT (TRAFFIC RATED OR APPROVED SUBSTITUTE), MINIMUM 2 COATS
- NEW 24"x48" STORM INLET, SEE GRADING PLAN, SHEET 5
- CONSTRUCT CONCRETE HEADER CURB PER TYPICAL SECTION, SHEET 4
- NEW SYNTHETIC TURF FIELD, SEE LANDSCAPE PLANS
- CONSTRUCT CONCRETE APRON PER SECTION, SHEET 4
- INSTALL 12" AGGREGATE BASE COURSE PER TYPICAL SECTION, SHEET 4
- TRANSITION FROM MOUNTABLE (STANDARD) CURB TO MOUNTABLE (DEPRESSED) CURB
- BEGIN CURB TRANSITION
- END CURB TRANSITION

**SURVEY NOTE:**










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2-6-2017

	NEL	DATE	BY	REVISIONS	JOB NO.
DESIGNED BY J.D.S.					2016.180.3
DRAWN BY J.Y.R./S.C.C.					DATE 02-2017
APPROVED BY G.M.					SHEET 3 OF 9





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File Name: 161803-SH4.DWG

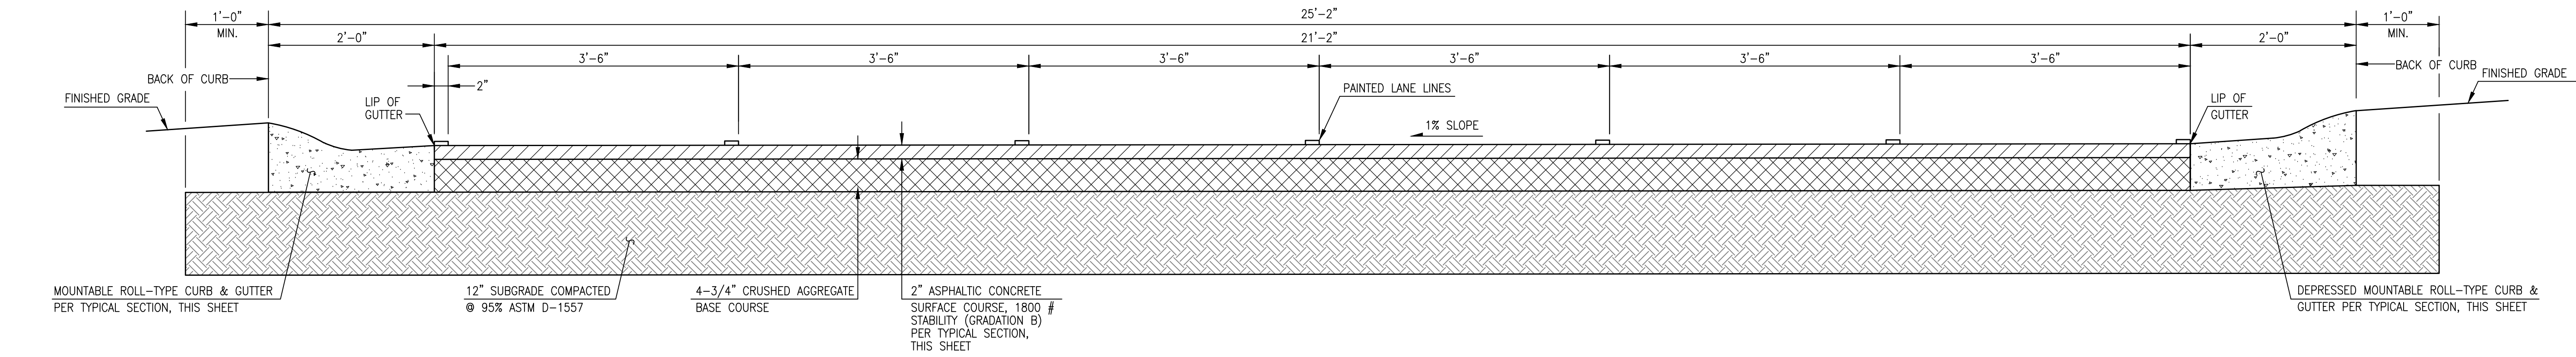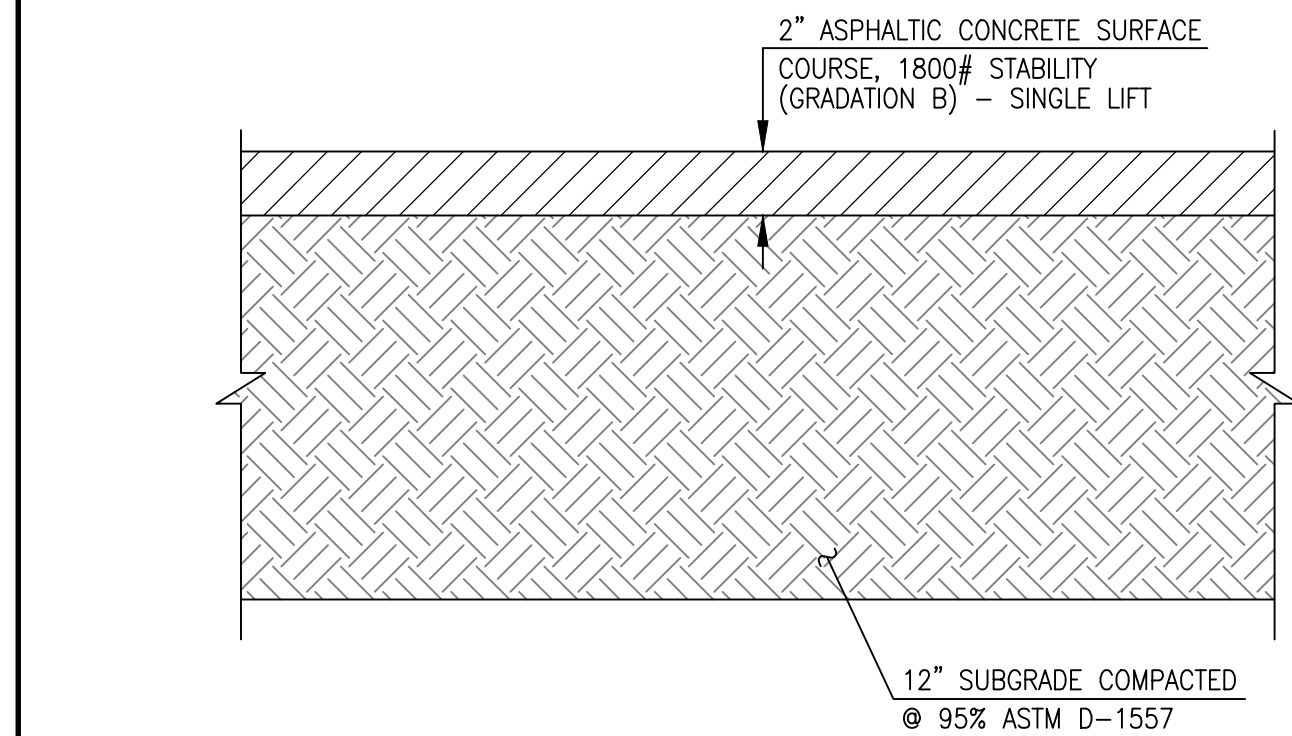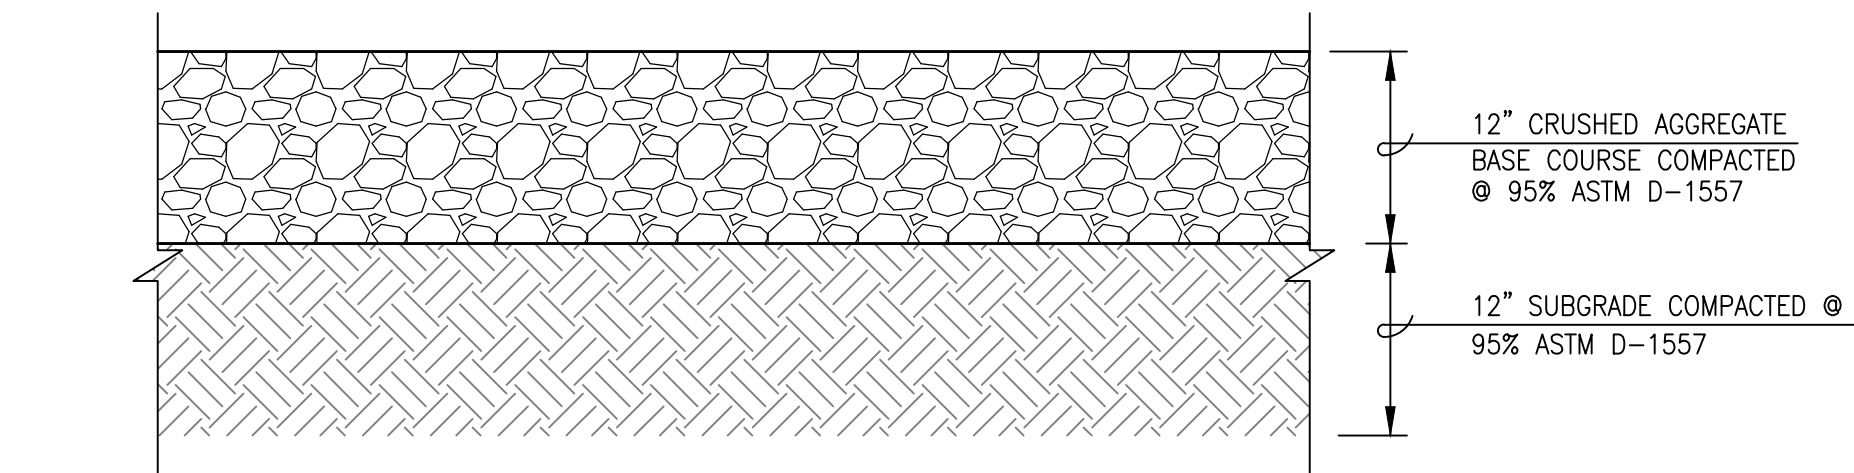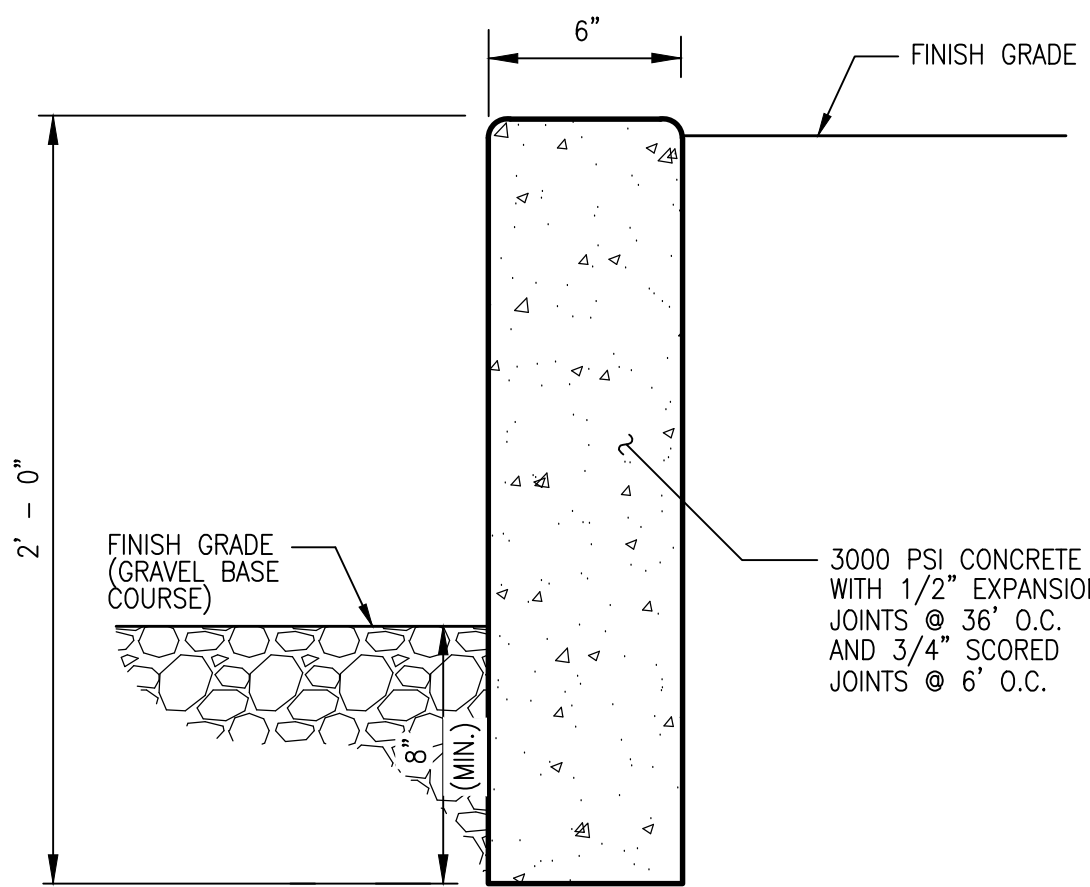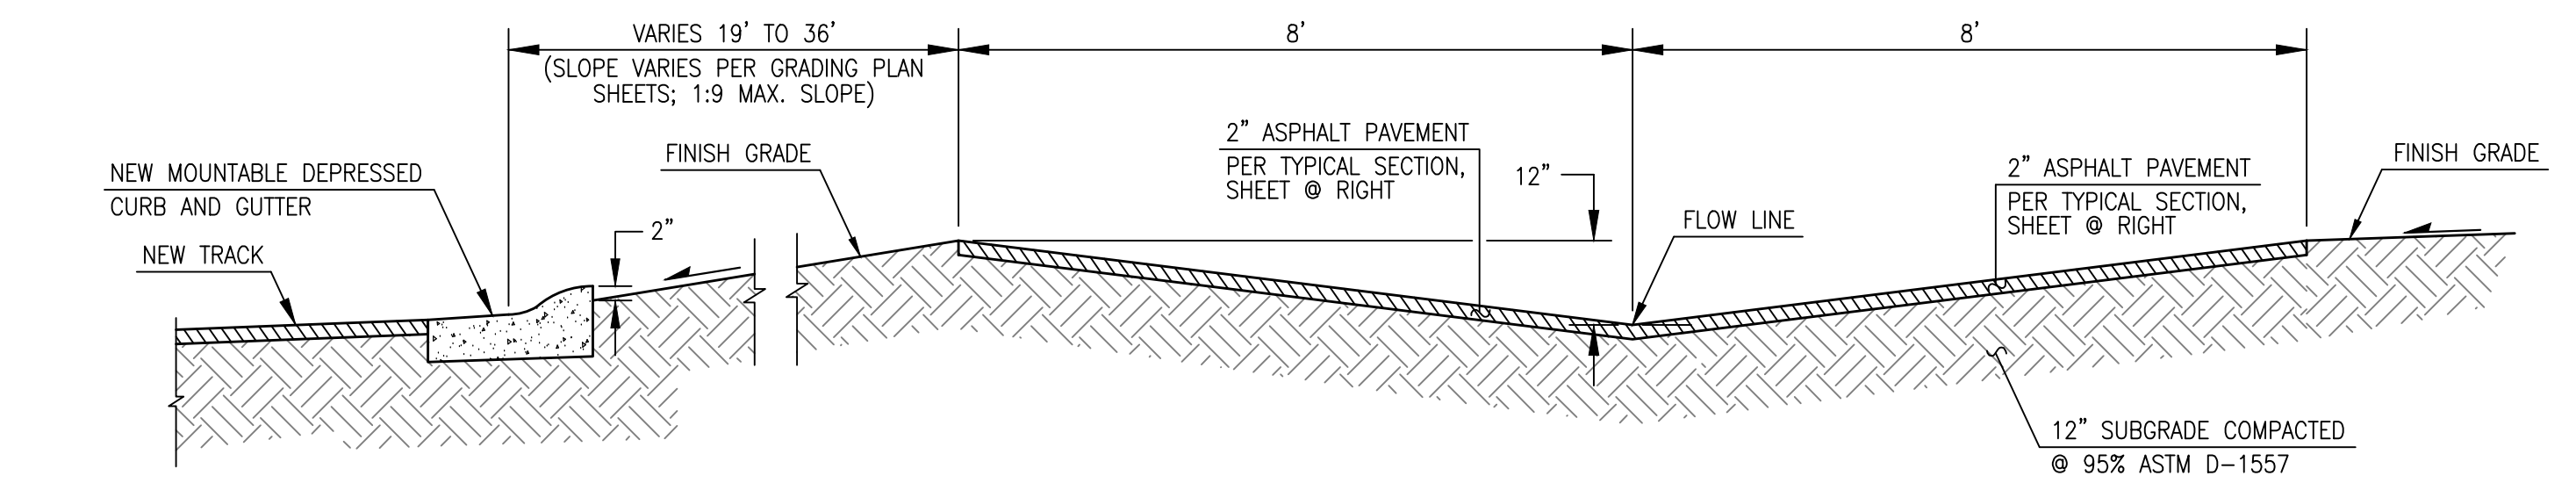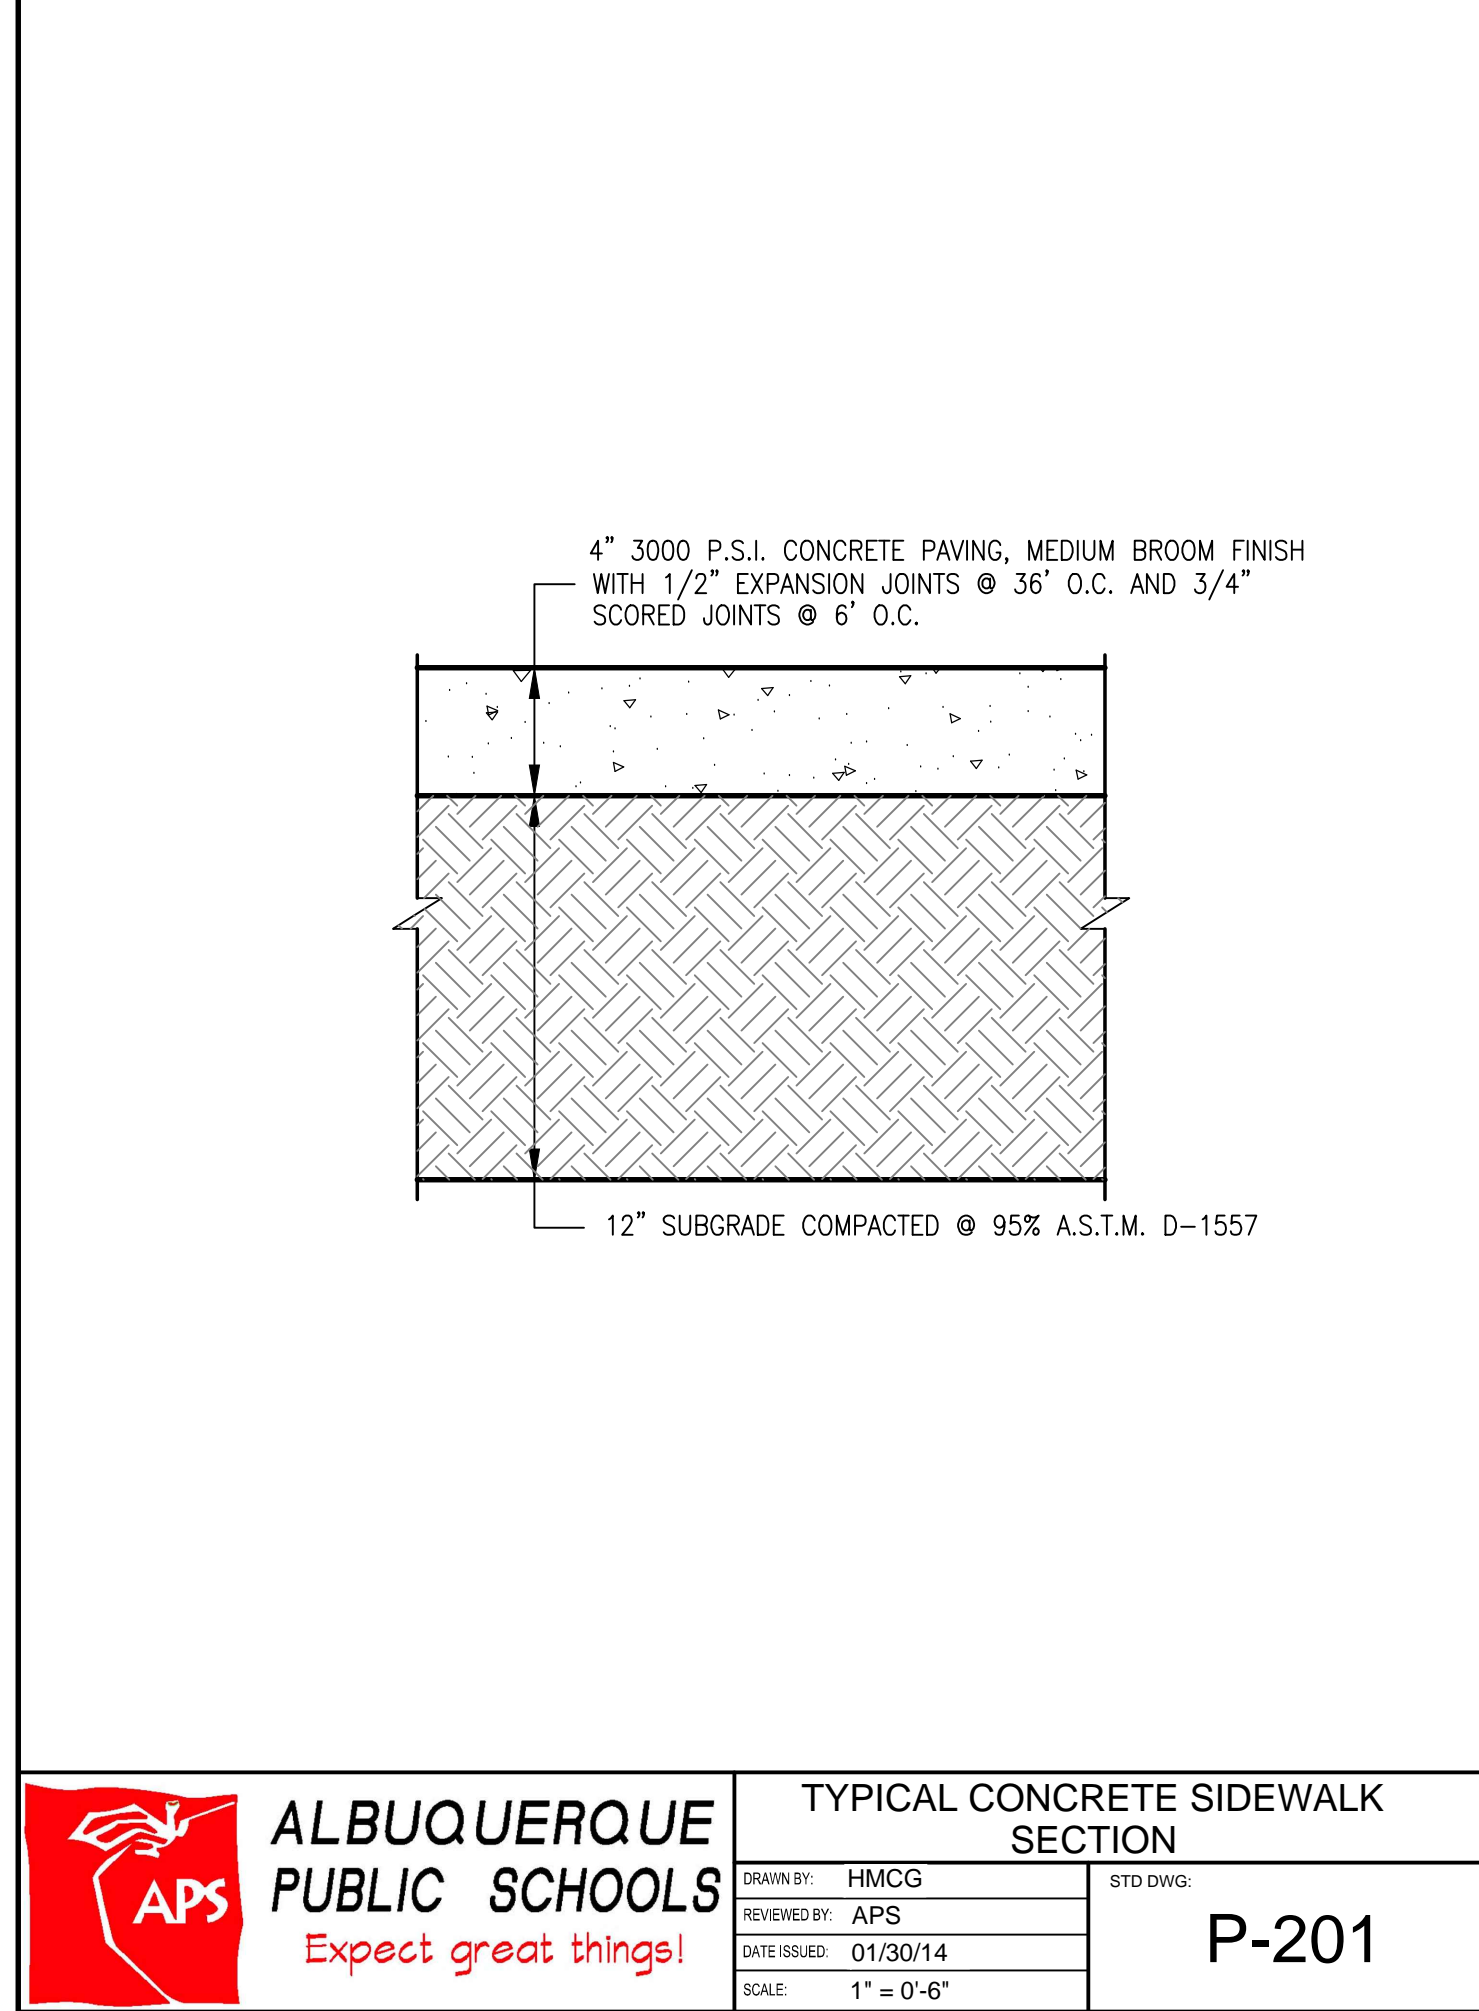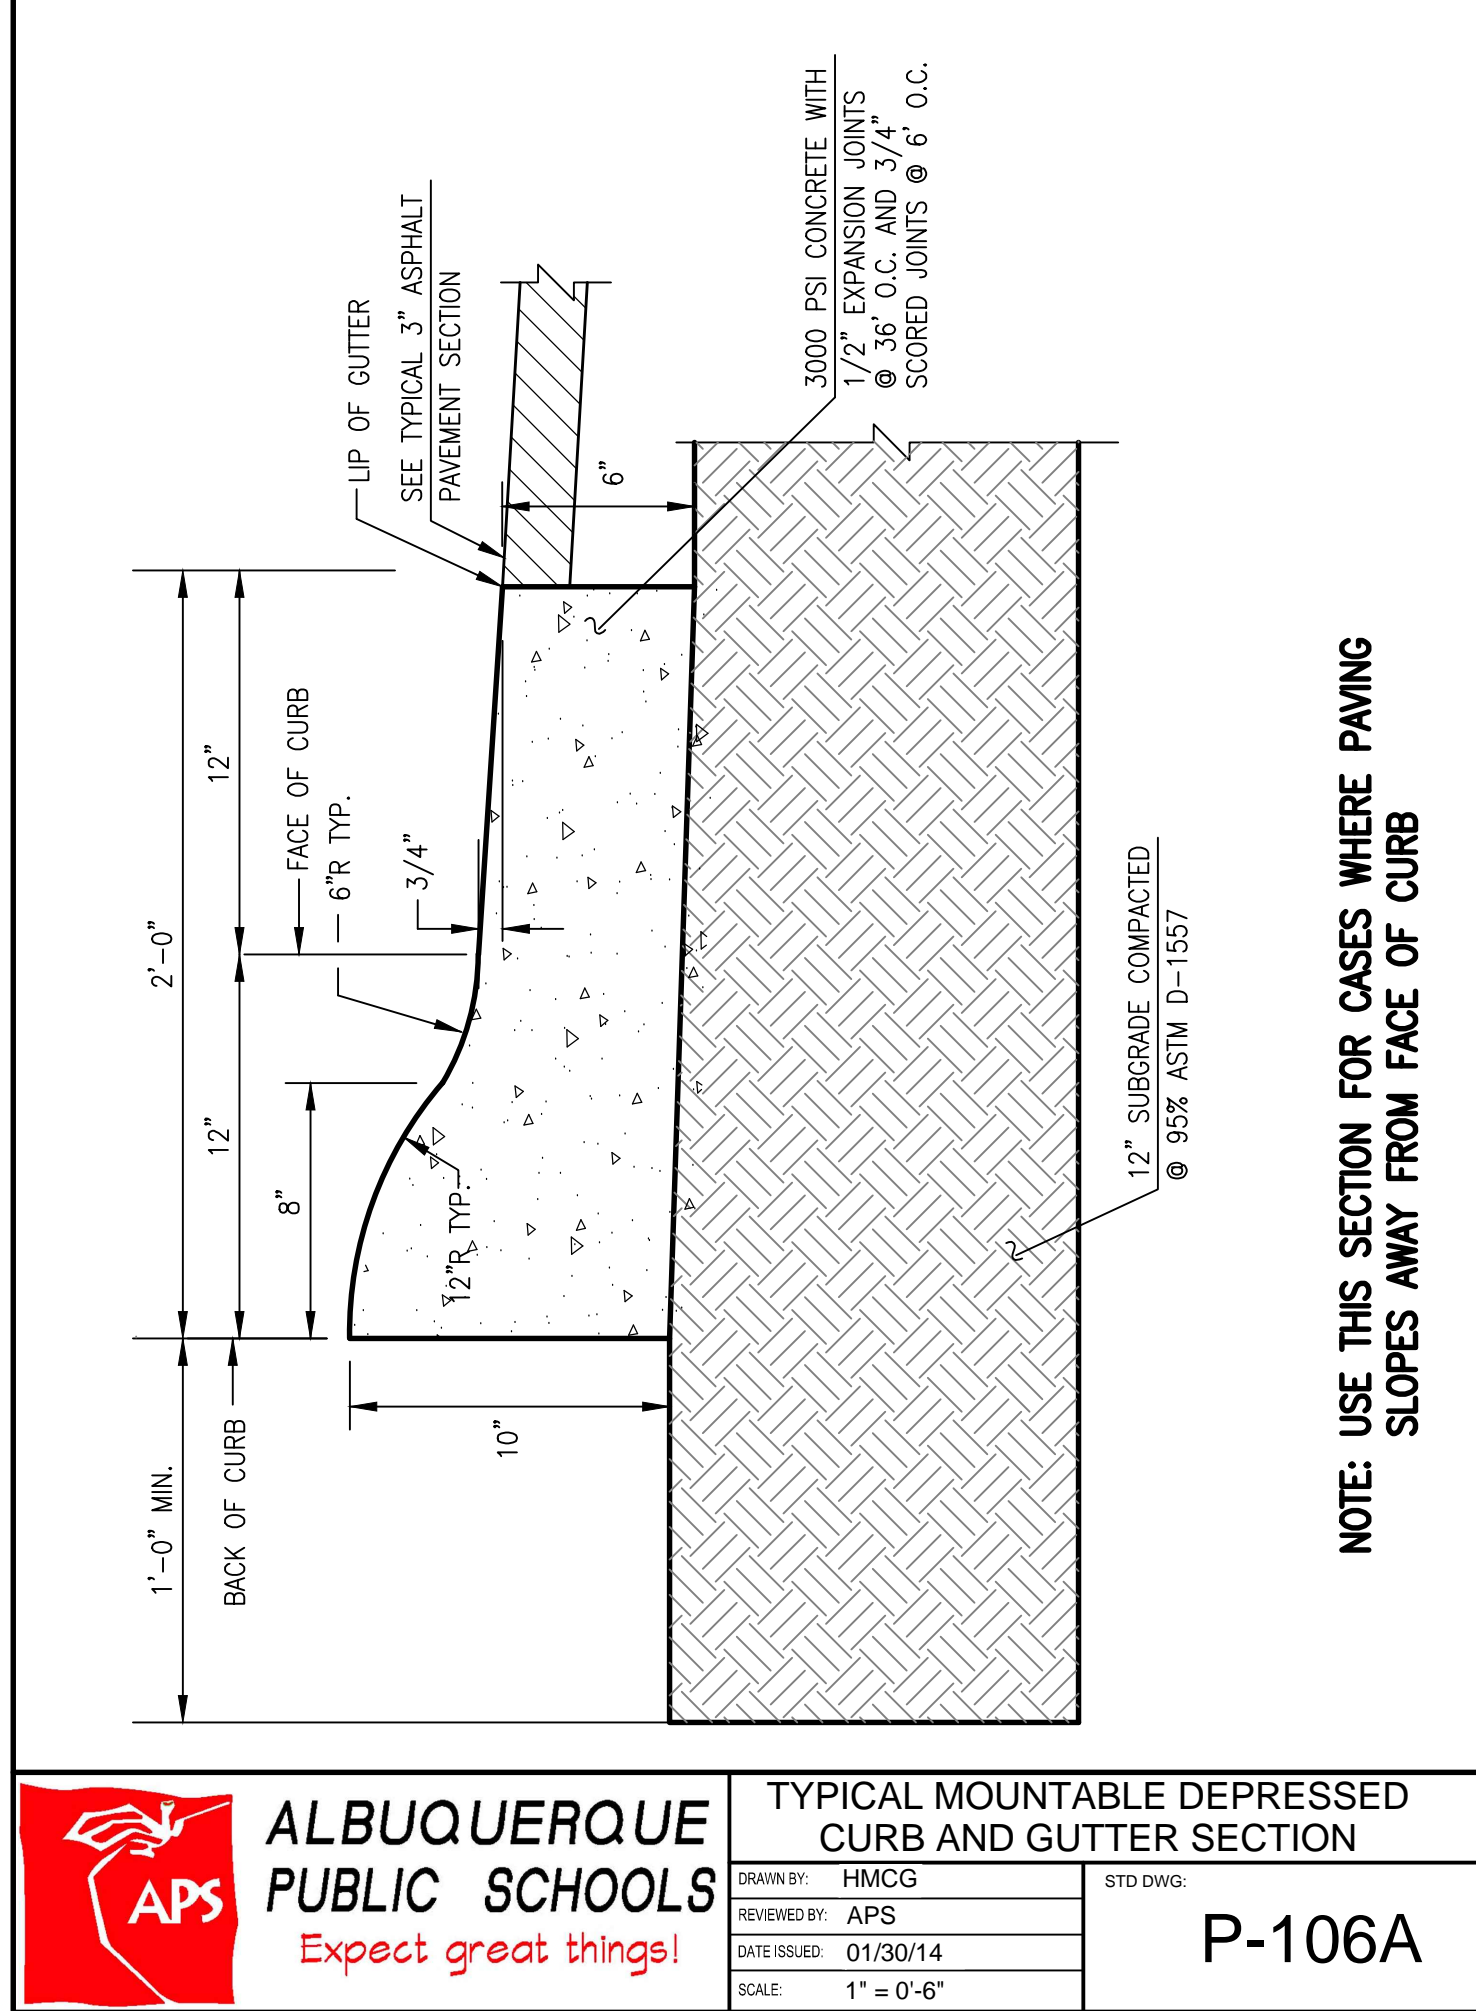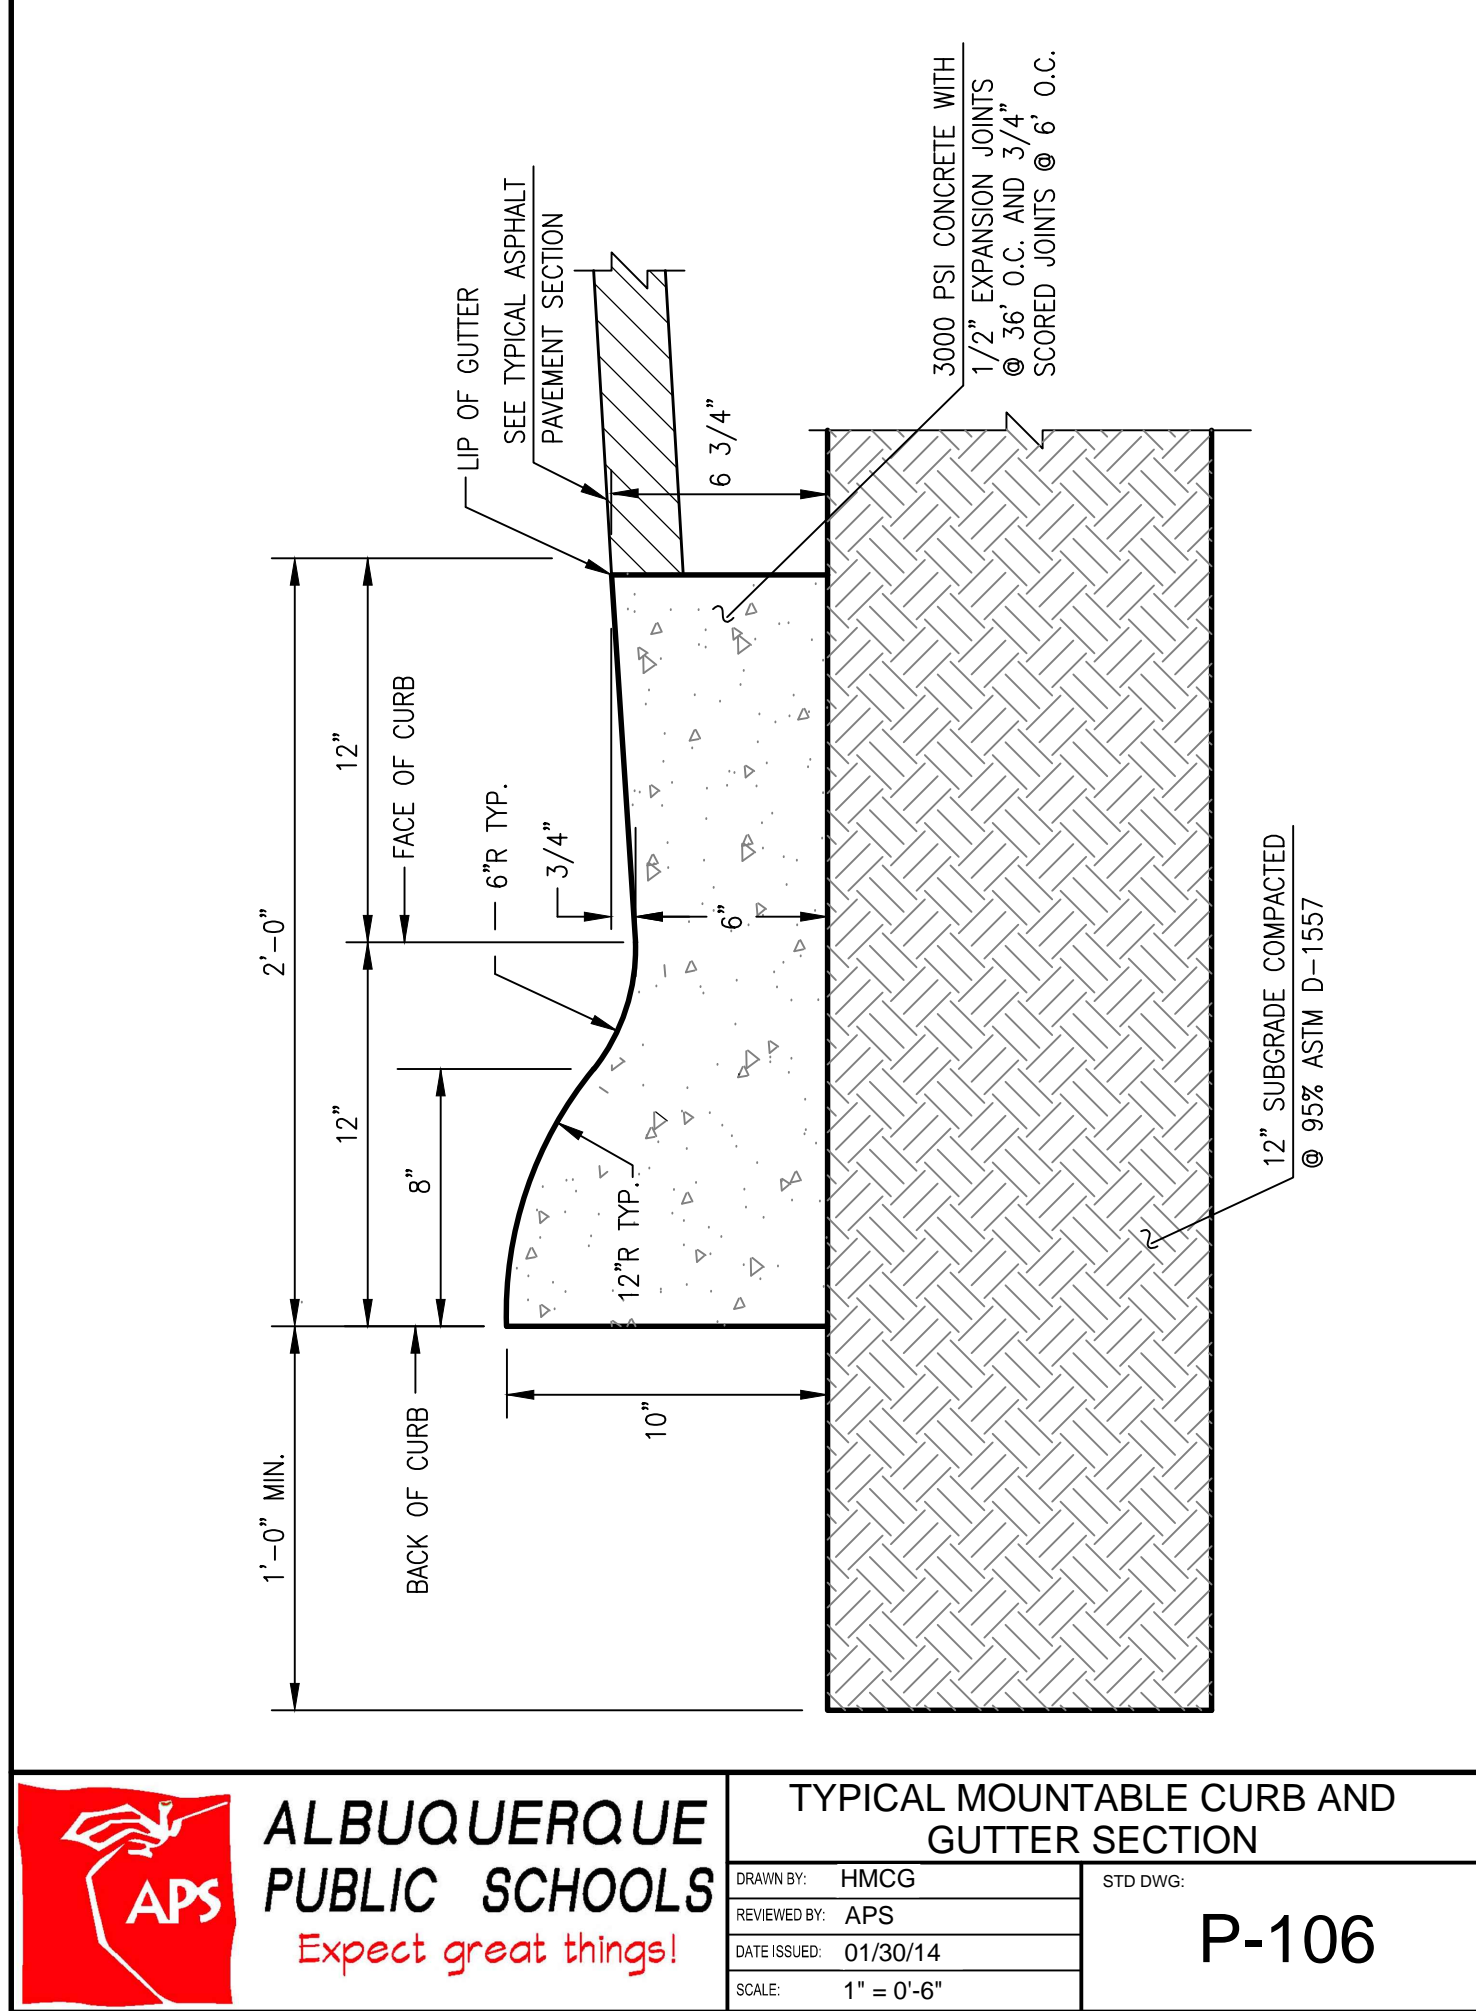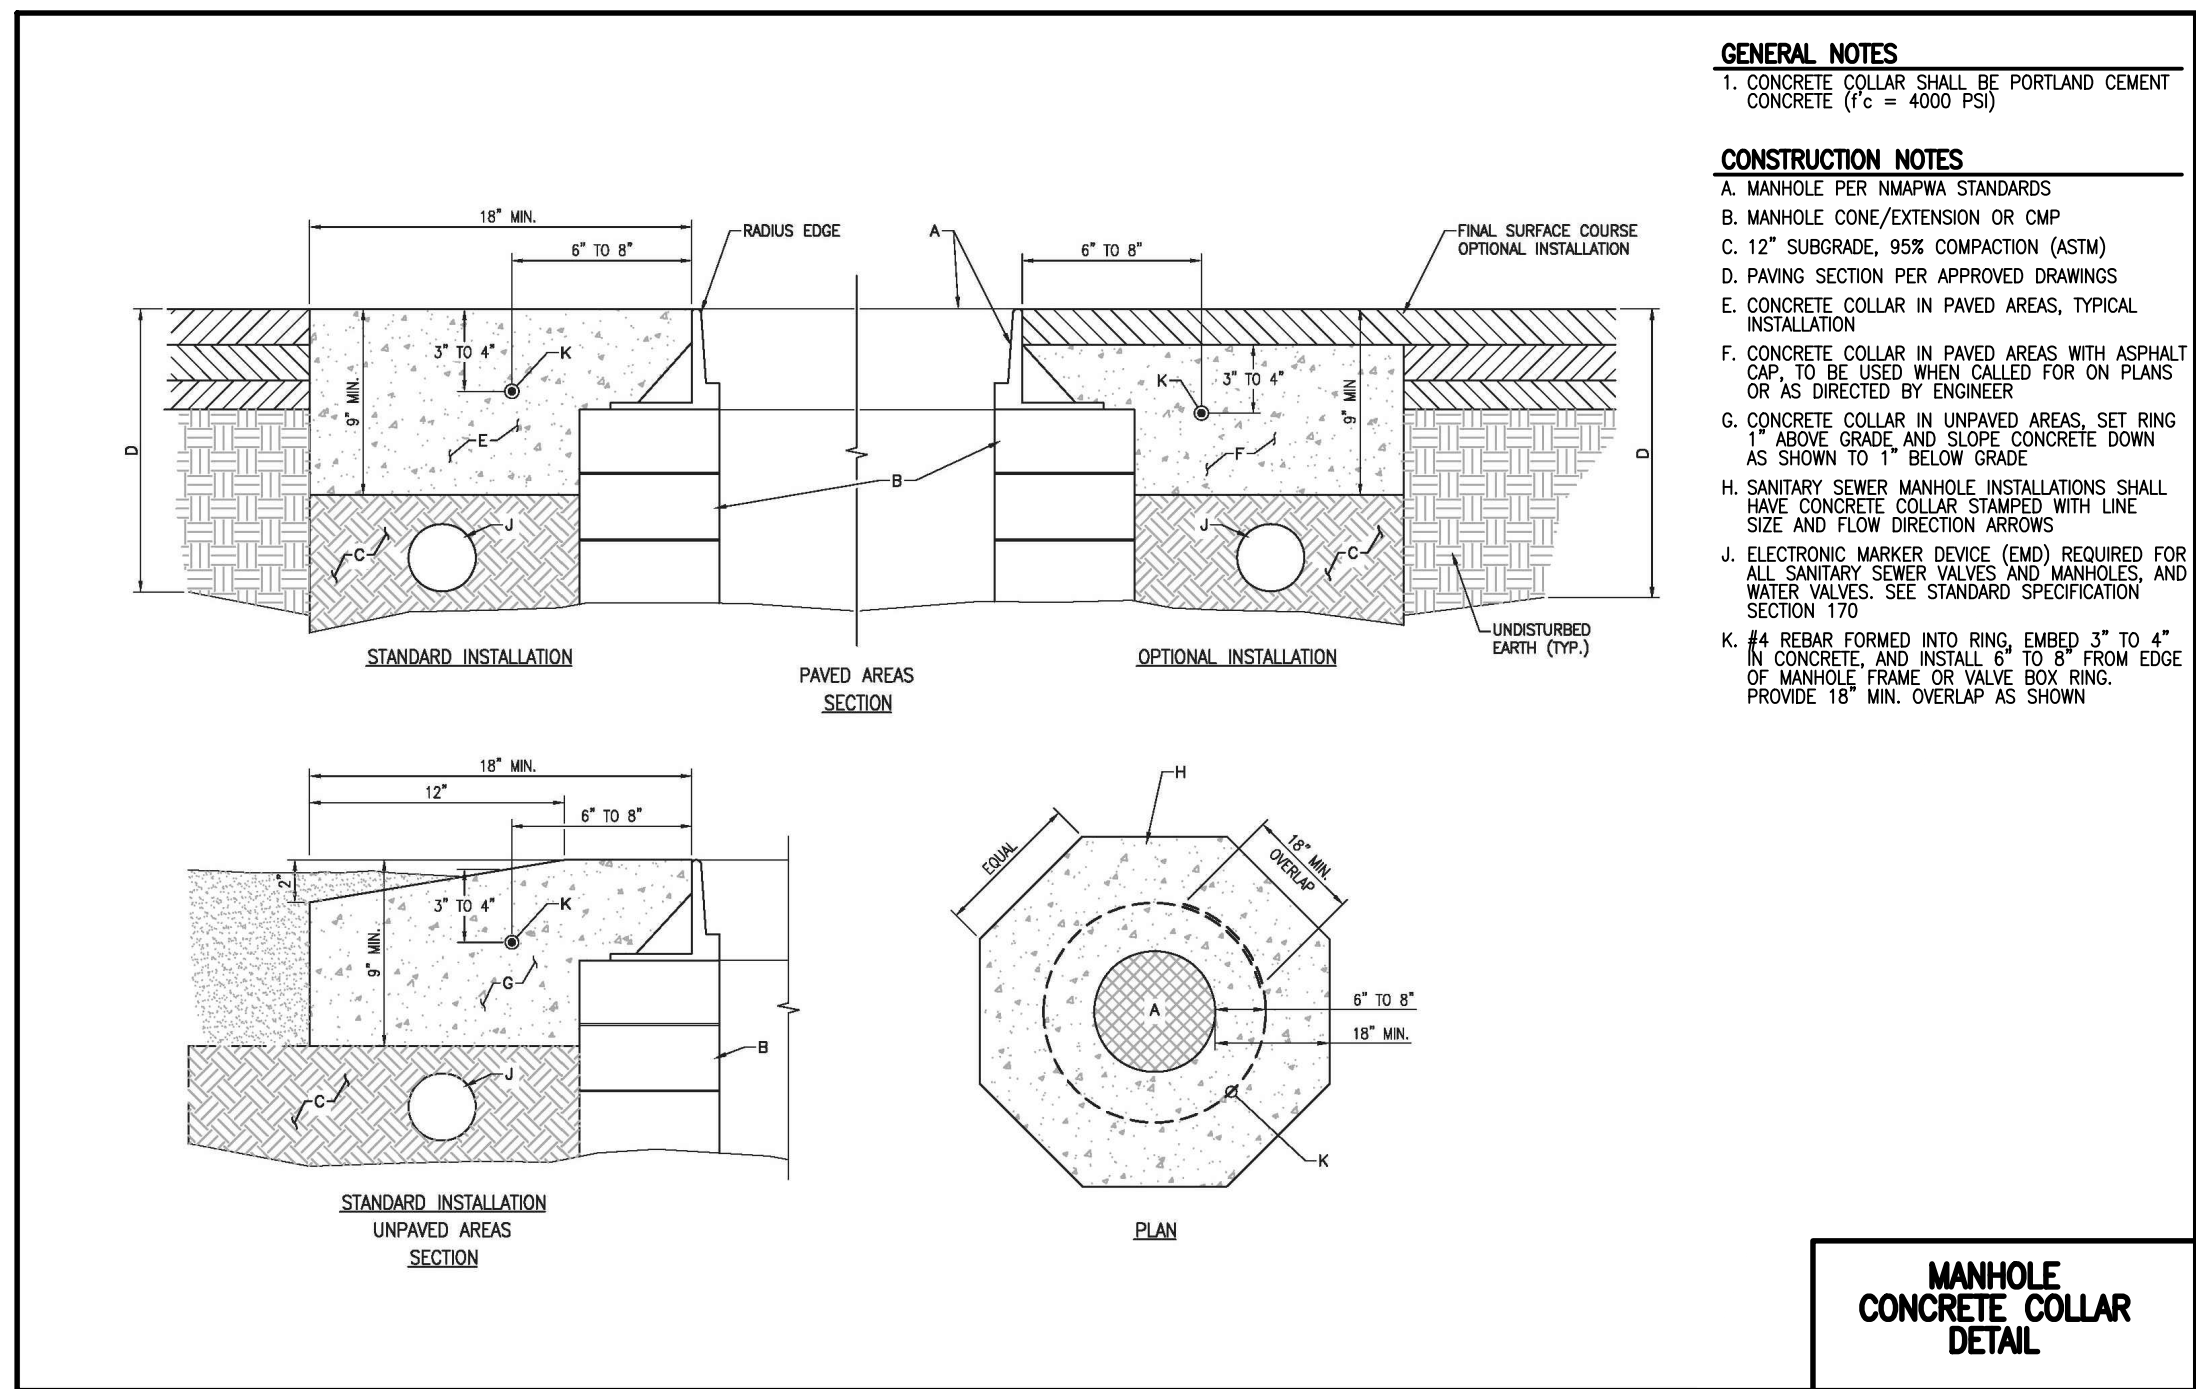**HIGH MESA Consulting Group**  
FORMERLY JEFF MORRISON AND ASSOCIATES  
6010-B Midway Park Blvd. NE • Albuquerque, New Mexico 87109  
Phone: 505.345.6250 • Fax: 505.345.6254 • www.highmesaeng.com

**PAVING SECTIONS AND DETAILS  
TRACK AND FIELD IMPROVEMENTS  
CLEVELAND MIDDLE SCHOOL  
6910 NATALIE AVENUE N.E.**

DESIGNED BY	DATE	BY	REVISIONS	JOB NO.
J.D.S.				2016.180.3
DRAWN BY	DATE	BY	REVISIONS	JOB NO.
J.Y.R./S.C.C.				02-2017
APPROVED BY	DATE	BY	REVISIONS	JOB NO.
G.M.				4 OF 9

2-6-2017  
J. GRAEME MEANS  
NEW MEXICO  
13678  
REGISTERED PROFESSIONAL ENGINEER



























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**GRADING PLAN**  
**TRACK AND FIELD IMPROVEMENTS**  
**CLEVELAND MIDDLE SCHOOL**  
**6910 NATALIE AVENUE N.E.**

## LEGEND

AP	ASPHALT PAVEMENT
BBG	ASPHALT
BOM	BASKETBALL GOAL
BR	BUILDING OVERHANG
BR	BICYCLE RACK
C&G	CURB AND GUTTER
CA	SECURITY CAMERA
CDP	CONCRETE DRIVE PAD
CF	LANDSCAPING CRUSHER FINES
CHC	CONCRETE HEADER CURB
CHW	CONCRETE HEAD WALL
CW	CAST IRON PIPE
CLF	CHAIN LINK FENCE
CMP	CORRUGATED METAL PIPE
CMU	CONCRETE MASONRY WALL
CO	CONDUIT
CO	CLEANOUT
CONC	CONCRETE
CONC	CONCRETE RUNDOWN
CS	CONCRETE STEPS
CSW	CONCRETE SIDEWALK
DBL	DOUBLE
DYS	PAINTED DOUBLE YELLOW TRAFFIC STRIPE
E/PM	ELECTRIC LINE BY PAINT MARK
EA	EDGE OF ASPHALT
EPB	ELECTRIC PULLBOX
FBG	FLUCKER BALL GOAL
F	FLOWLINE
FO	FENCE OPENING
G/PM	GAS LINE BY PAINT MARK
GRV	GAS PRESSURE REGULATOR
GS	LANDSCAPING GRAVEL
GS	GAS SERVICE
GW	GATE
ICB	BUT WIRE ANCHOR
ICB	IRRIGATION CONTROL BOX
IVB	IRRIGATION VALVE BOX
LCB	METAL LANDSCAPING DIVIDER
MCB	METAL BUILDING COLUMN
MEN	METAL BENCH
MC/IB	METAL CAN WITH BIB VALVE
MH	MANHOLE
MHR	METAL HANDRAIL
MLN	METAL LANDING
MPT	METAL PICNIC TABLE
MS	METAL RAMP
MTC	METAL STAIRS
MTC	METAL TRASH CAN
OH(1)	OVERHEAD COMMUNICATION (# OF LINES)
OH(1)	OVERHEAD ELECTRIC (# OF LINES)
OHM	OVERHEAD UTILITY MAINT
PD	STEEL PEDESTAL
RD	BUILDING ROOF DRAIN
SAS	SANITARY SEWER
SDI	STORM DRAIN
SDI	STORM DRAIN INLET
SDMH	STORM DRAIN MANHOLE
SP	STEEL POLE
SW	CONCRETE SIDEWALK
SYS	PAINTED DASHED YELLOW TRAFFIC STRIPE
TA	TOP OF ASPHALT
TC	TOP OF CURB
TCC	TOP OF CONCRETE CHANNEL
TCO	TOP OF CONCRETE
TS	TOP OF GRATE
TW	TRAFFIC SIGN
TW	TOP OF WALL
VG	CONCRETE VALLEY GUTTER
W/PM	WATER LINE BY PAINT MARK
WCR	WOOD COMMUNICATION POLE
WLX	CONCRETE WHEELCHAIR RAMP
WPP	WATER LINE EXPOSED
	WOOD POWER POLE
	PAINTED UTILITY MARKER
	DIAMETER OF TREE
	DECIDUOUS TREE
	SHRUB
	YUCCA
	EXISTING DOUBLE CLEANOUT
	PROPOSED DOUBLE CLEANOUT
	EXISTING SPOT ELEVATION
	PROPOSED SPOT ELEVATION
	EXISTING FLOWLINE
	PROPOSED FLOWLINE
	EXISTING CONTOUR
	PROPOSED CONTOUR
	EXISTING DIRECTION OF FLOW
	PROPOSED DIRECTION OF FLOW
	RIGHT OF WAY LINE
	PUBLIC EASEMENT LINE
	HIGH POINT / DIVIDE
	PROPOSED CONCRETE PAVING
	PROPOSED ASPHALT PAVING
	PROPOSED TURF GRASS (FIELD)
	PROPOSED BASE COURSE

## BENCHMARKS

## PROJECT BENCHMARK

A 3" BRASS DISK STAMPED "11-G19", SET FLUSH WITH THE GROUND, NEAR THE SOUTHEAST QUADRANT OF THE INTERSECTION OF LOUISIANA BOULEVARD AND VERANDA ROAD N.E.  
ELEVATION = 5309.898 FEET (NAVD 1988)

TEMPORARY BENCHMARK #1 (T.B.M.)

A MAG NAIL W/WASHER SET IN ASPHALT, NEAR THE SOUTHWEST CORNER OF THE BAND BUILDING, AS SHOWN ON THIS SHEET.  
ELEVATION = 5291.16 FEET (NAVD 88)

TEMPORARY BENCHMARK #2 (T.B.M.)

A MAG NAIL W/WASHER SET IN AN ASPHALT PATH, NEAR THE  
NORTHEAST CORNER OF A BASKETBALL COURT, AS SHOWN ON THE  
SHEET.

TEMPORARY BENCHMARK #3 (T.B.M.)

A CHISELED "+" SET IN A CONCRETE BASKETBALL COURT, NEAR SOUTHERN PORTION OF THE SITE, AS SHOWN ON THIS SHEET.  
ELEVATION = 5287.63 FEET (NAVD 88)

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15075, DATED 12/21/2016 (2016.180.1). THE TOPOGRAPHIC INFORMATION  
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DATED 12/21/2016 (2016.180.1).



2-6-2017







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DRAWN BY	J.Y.R./S.C.C.					DATE	02-2017
APPROVED BY	G.M.					SHEET	5 OF 9



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File Name: 161803-SH6.DWG | Plot Time: 10:37 am

**DRAINAGE SECTIONS AND DETAILS  
TRACK AND FIELD IMPROVEMENTS  
CLEVELAND MIDDLE SCHOOL  
6910 NATALIE AVENUE N.E.**

DESIGNED BY	<u>J.D.S.</u>	NO.	DATE	BY	REVISIONS	JOB NO.
						2016.180.3
DRAWN BY	<u>J.Y.R./S.C.C.</u>					DATE
						02-2017
APPROVED BY	<u>G.M.</u>					SHEET
						6 OF 9

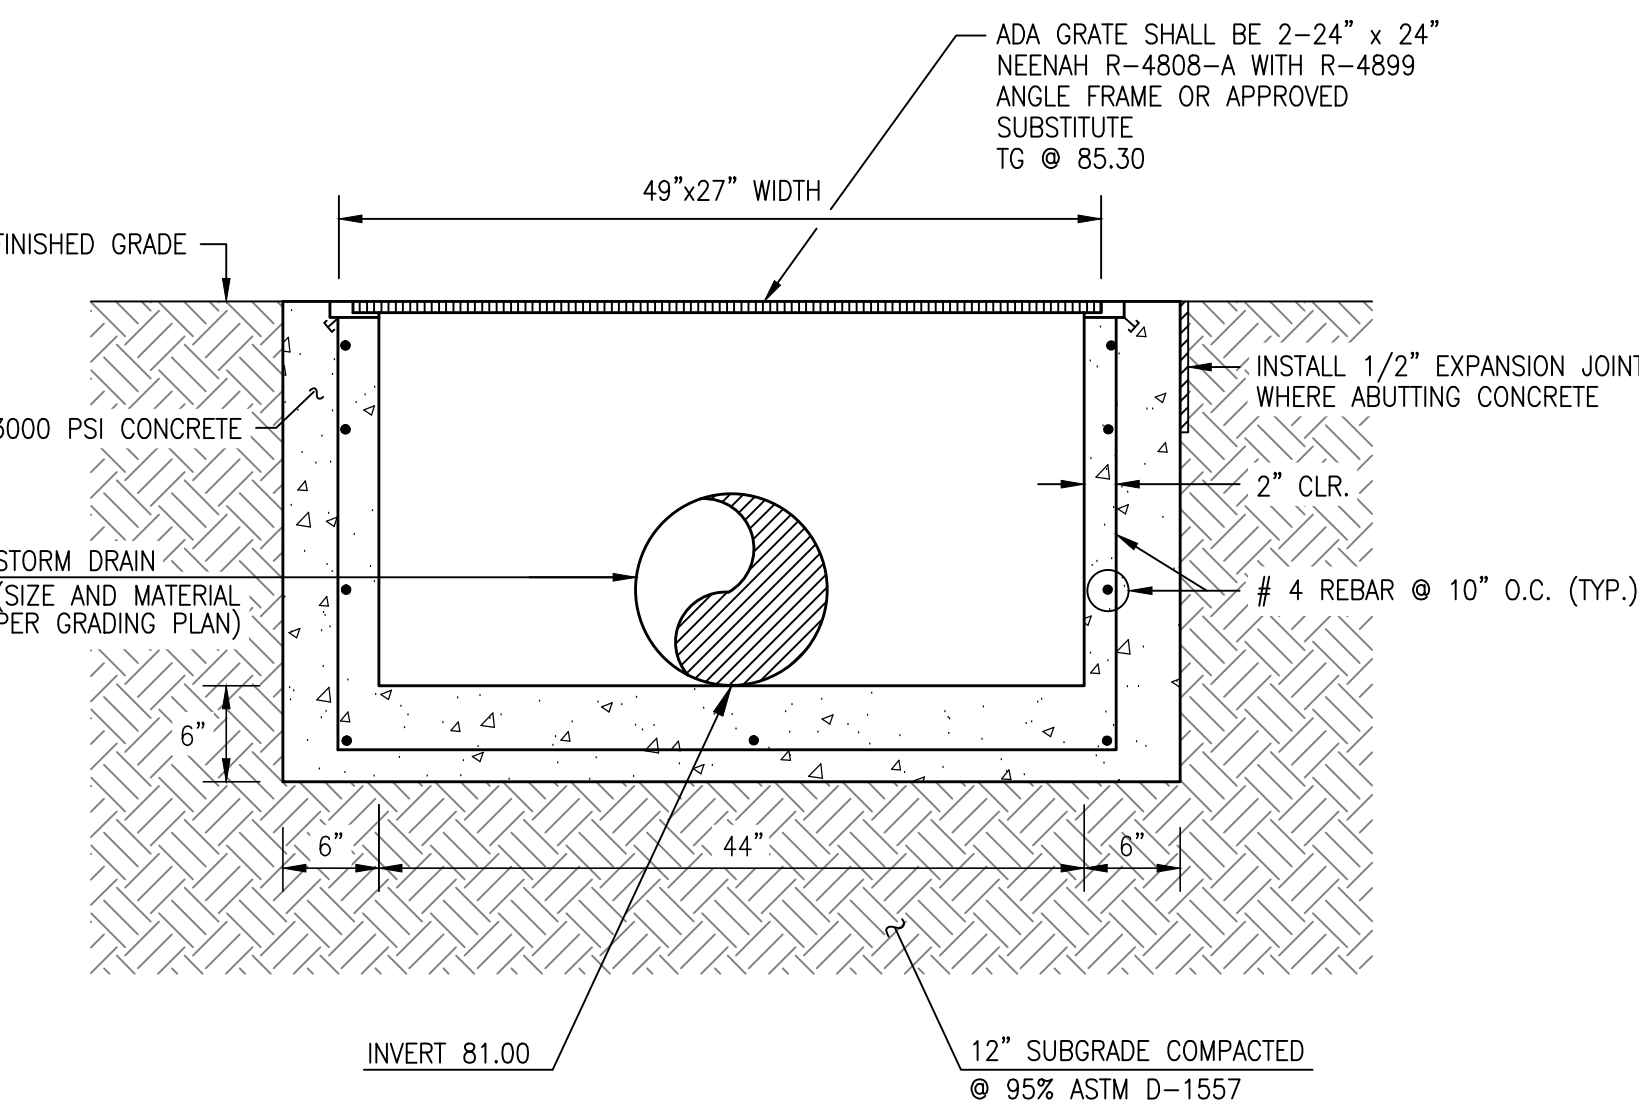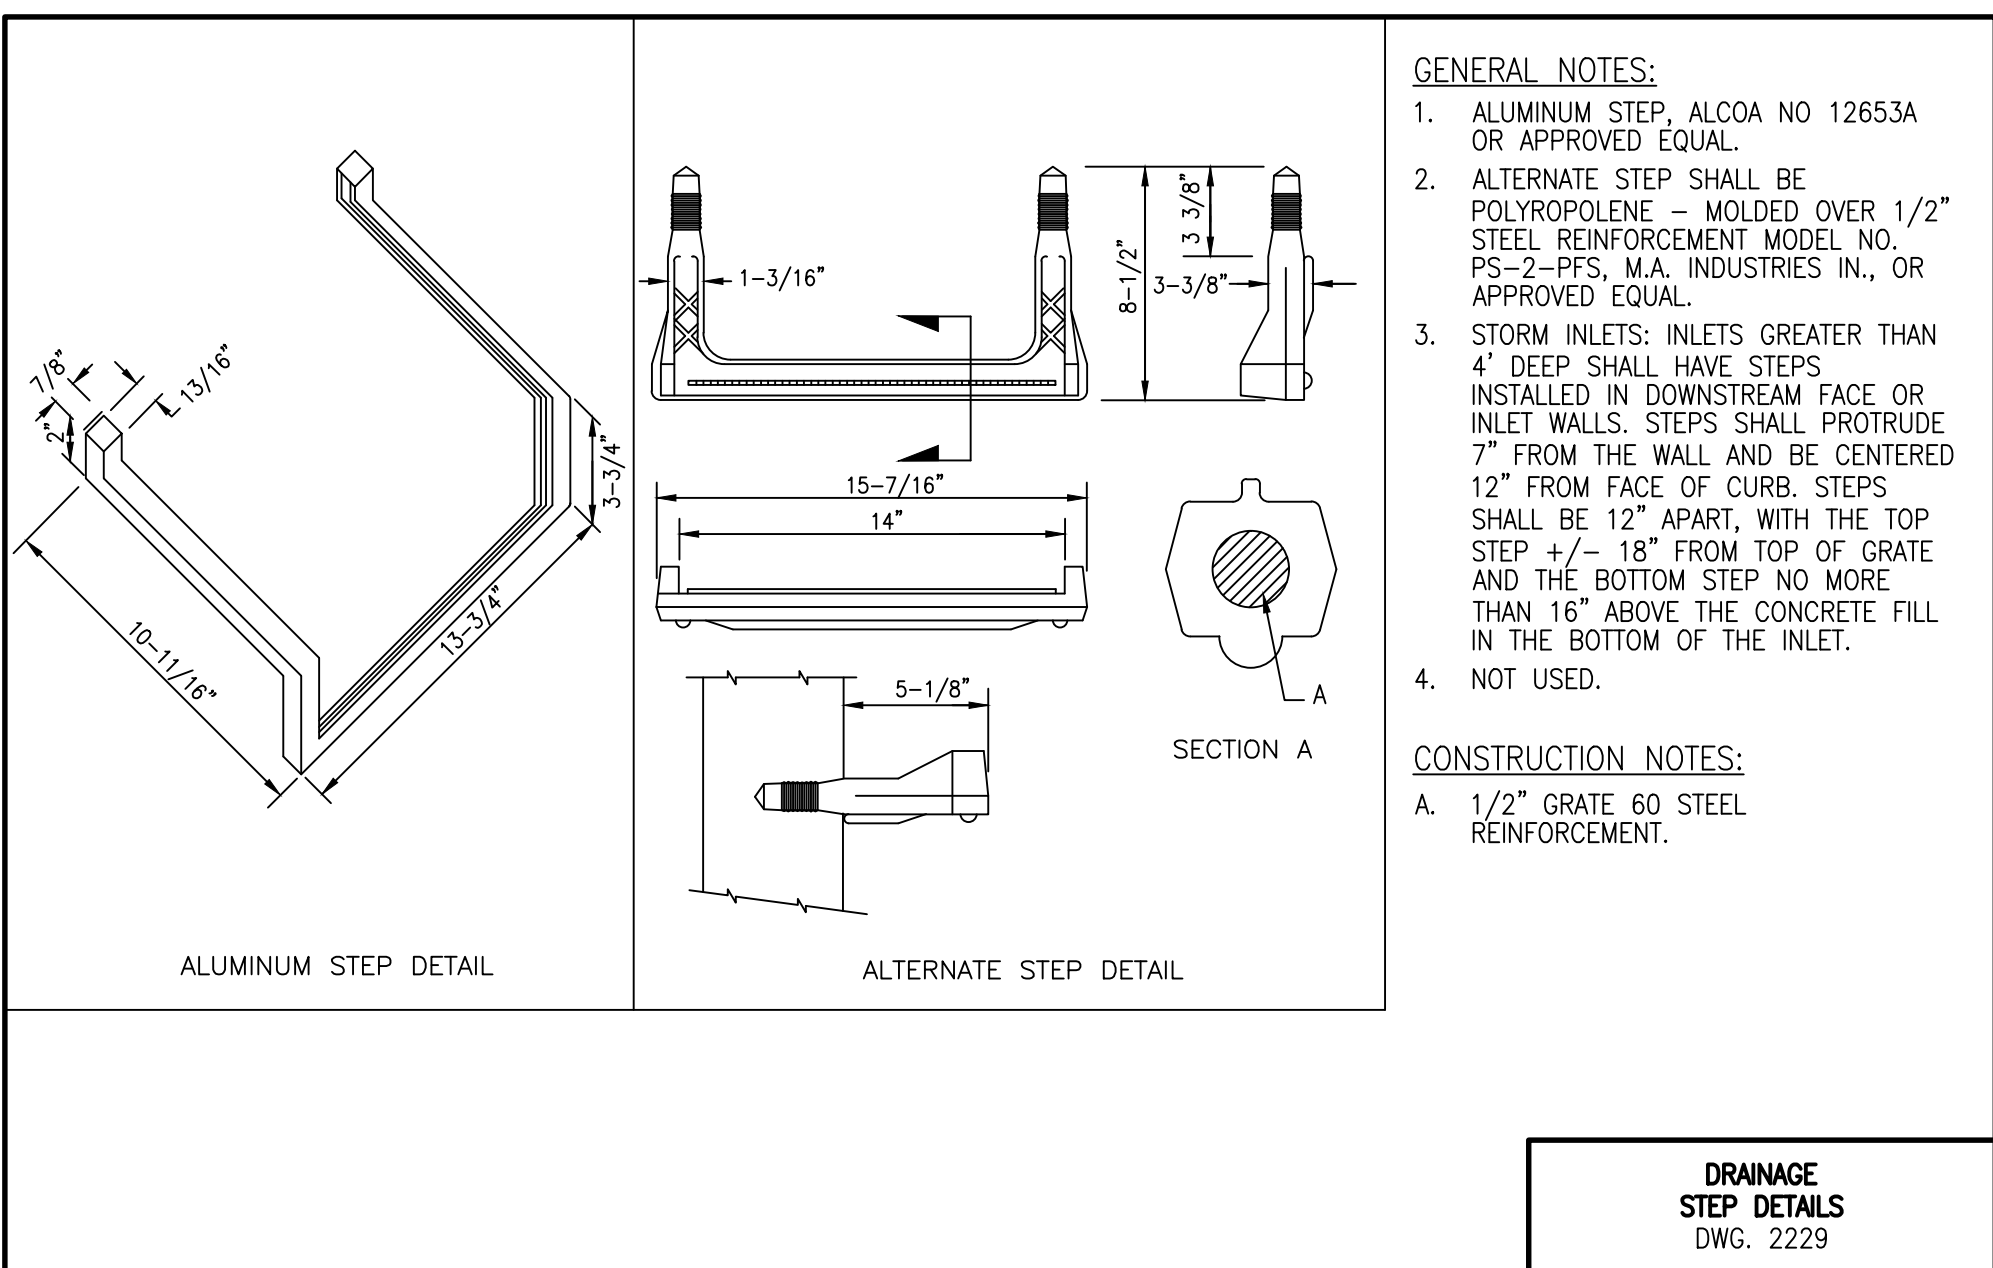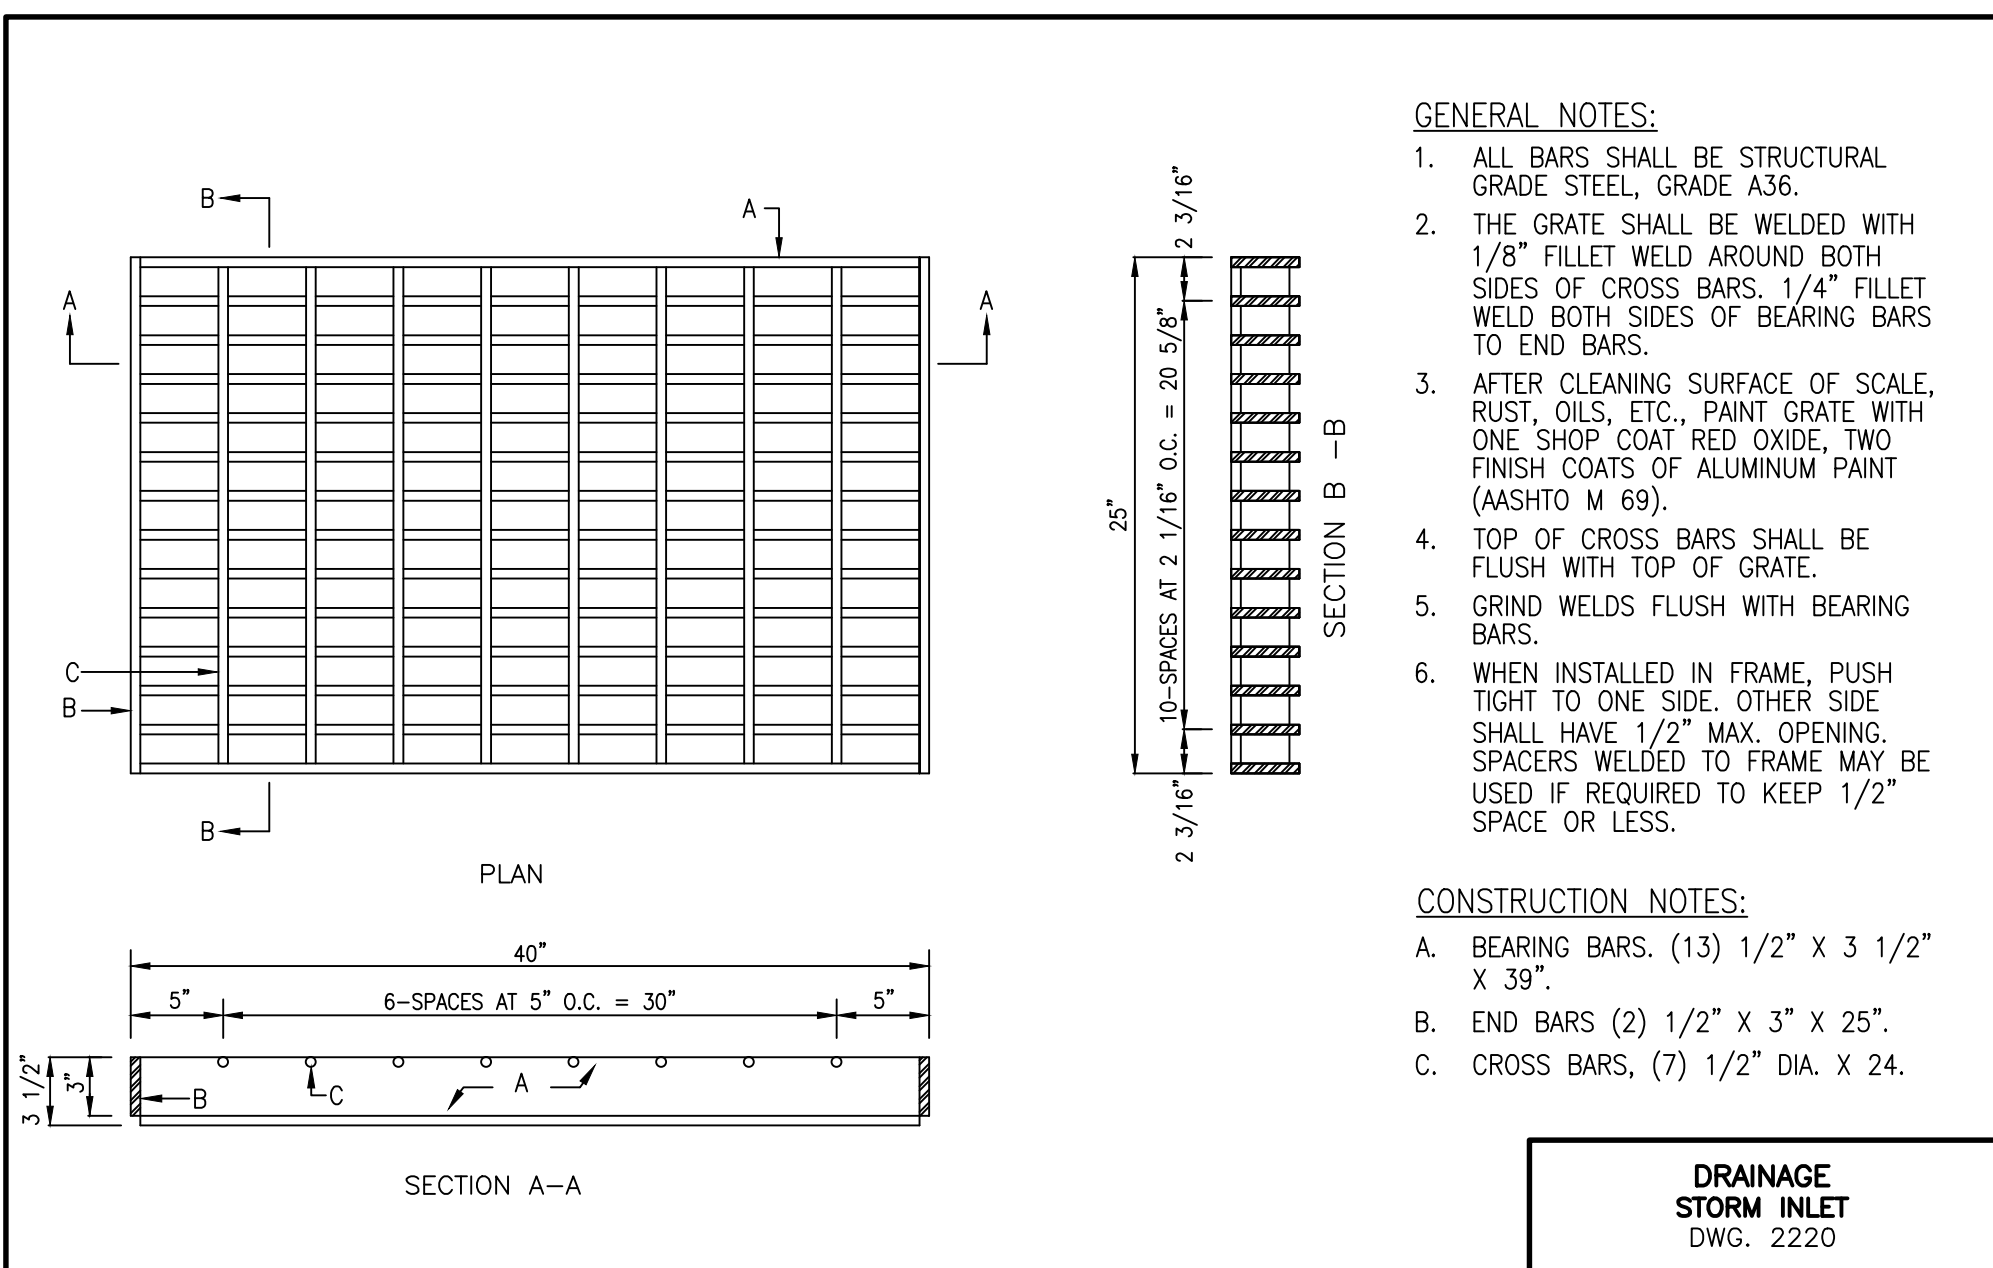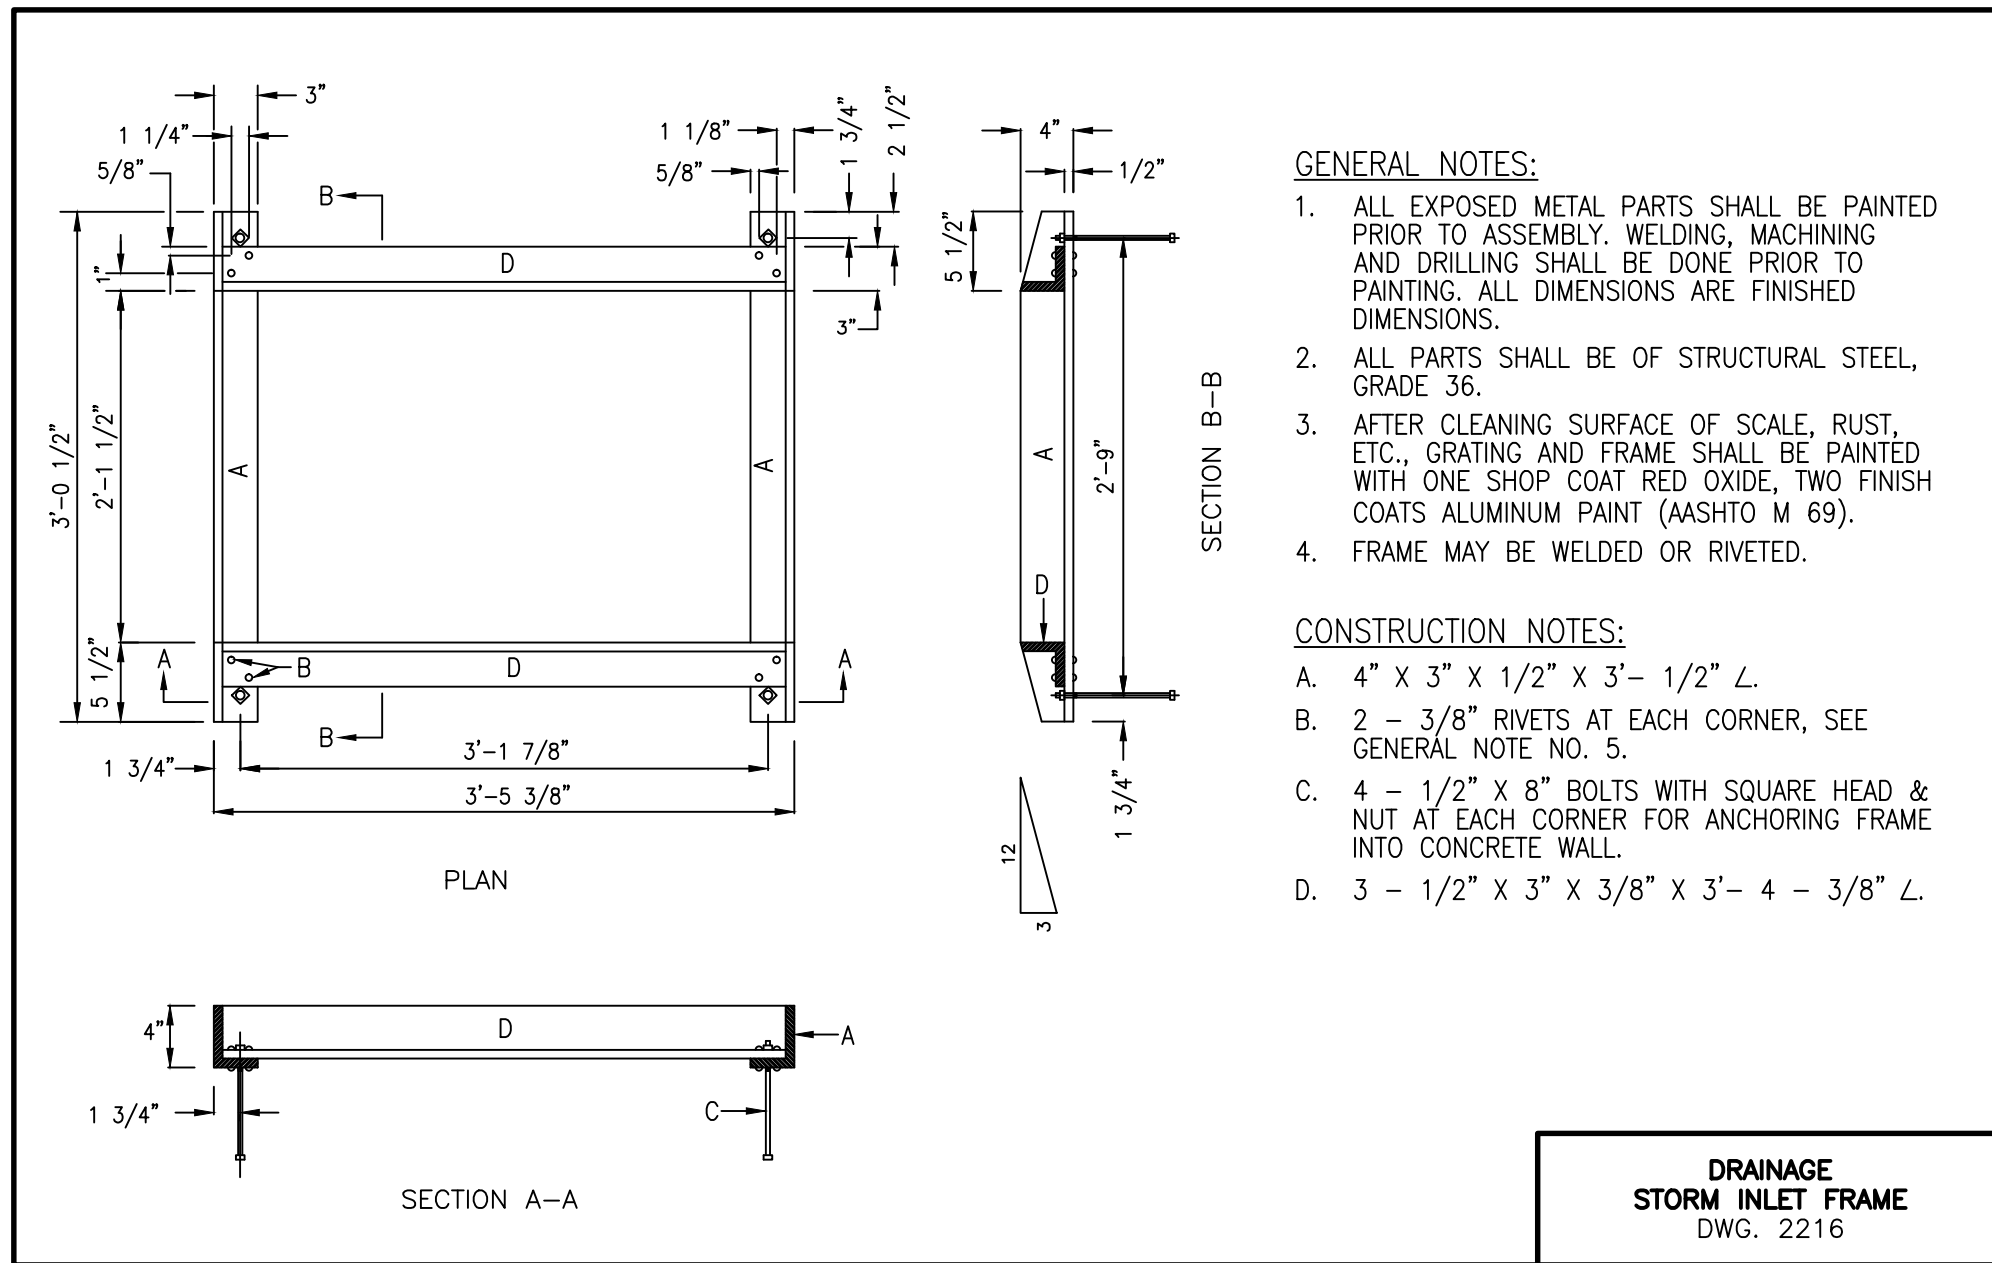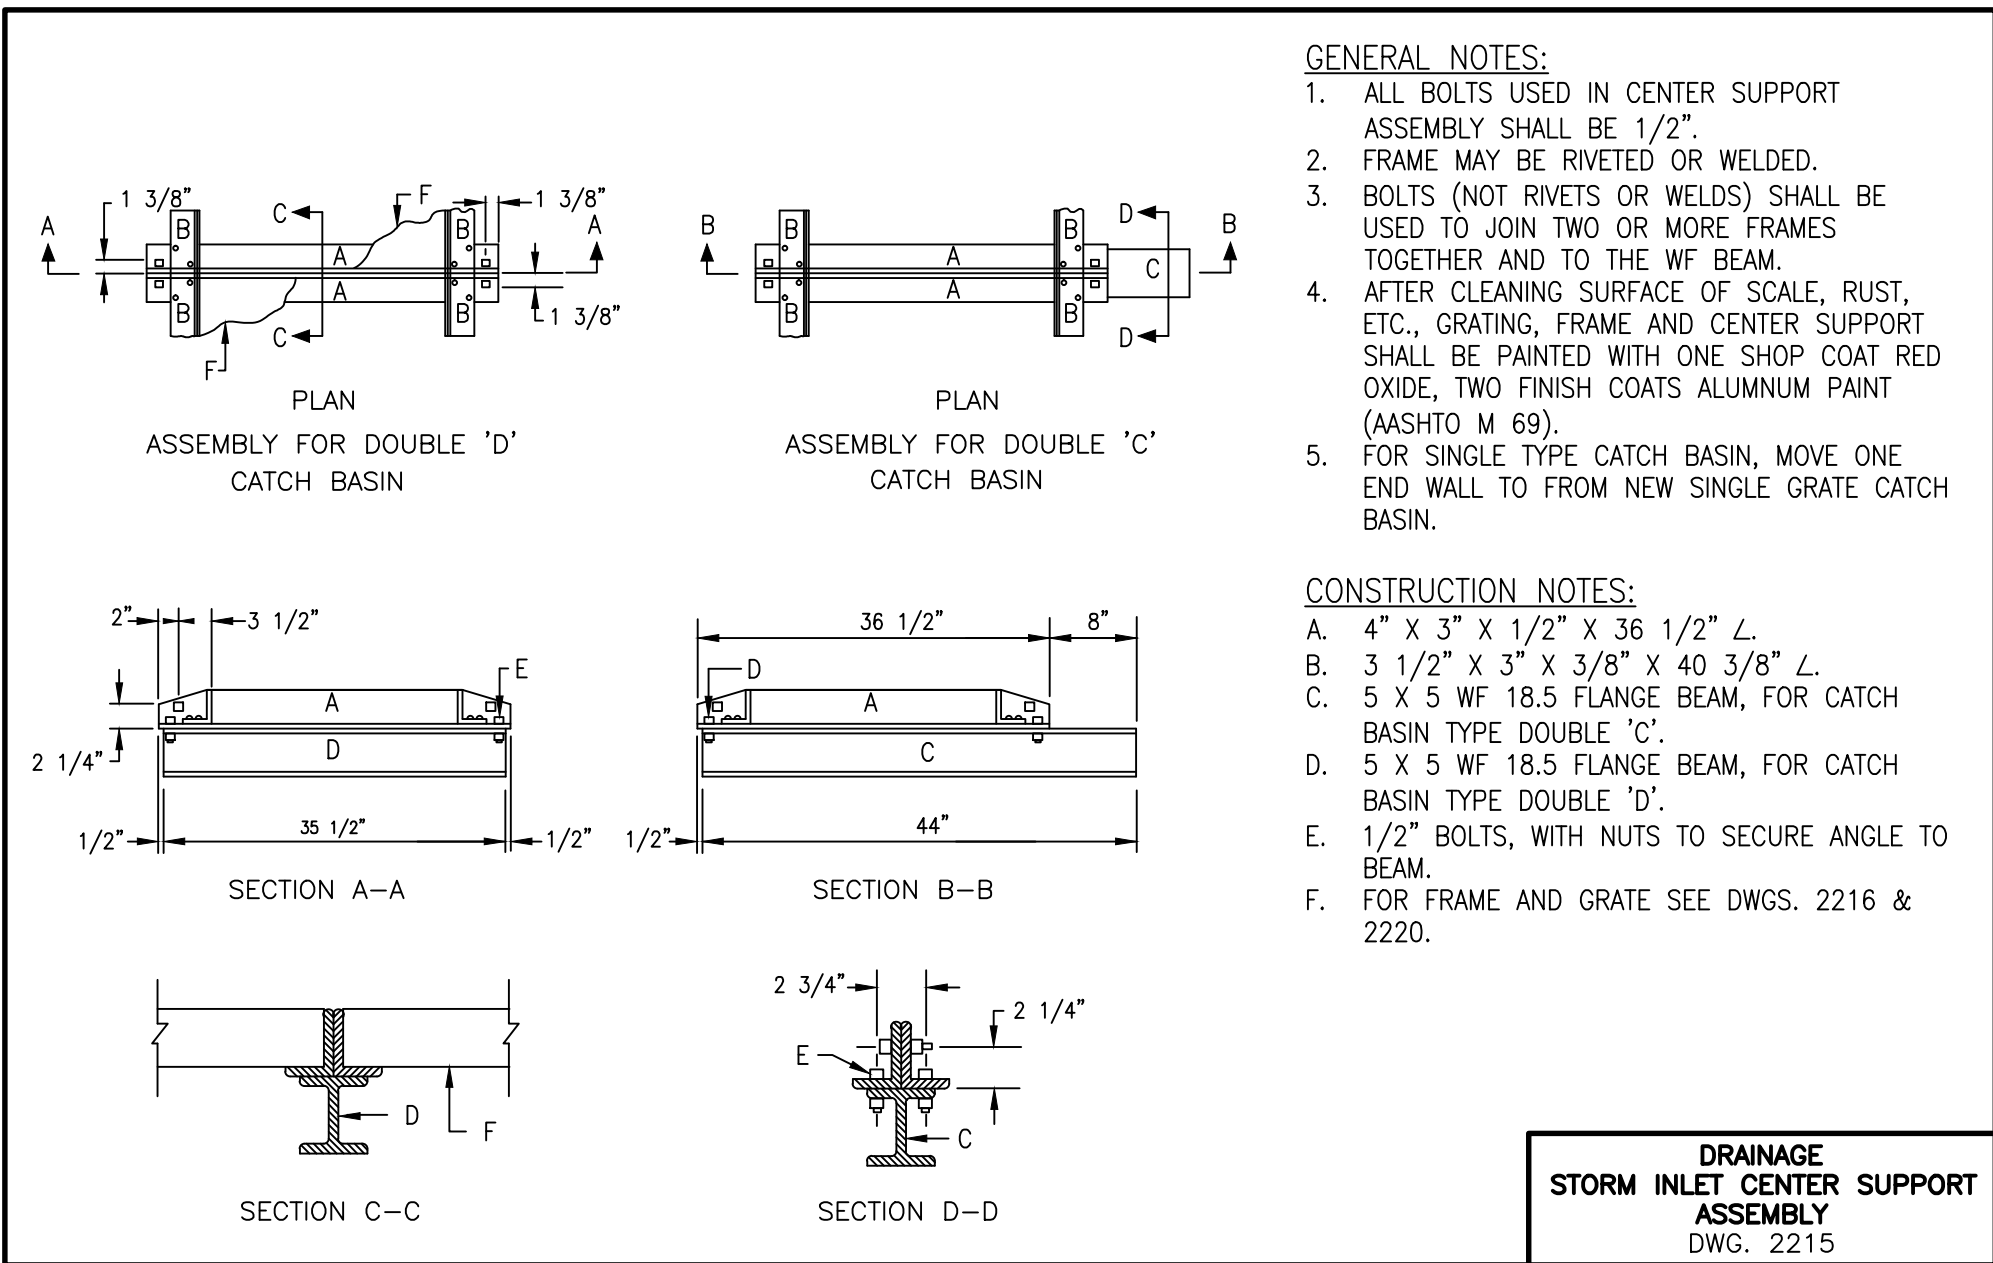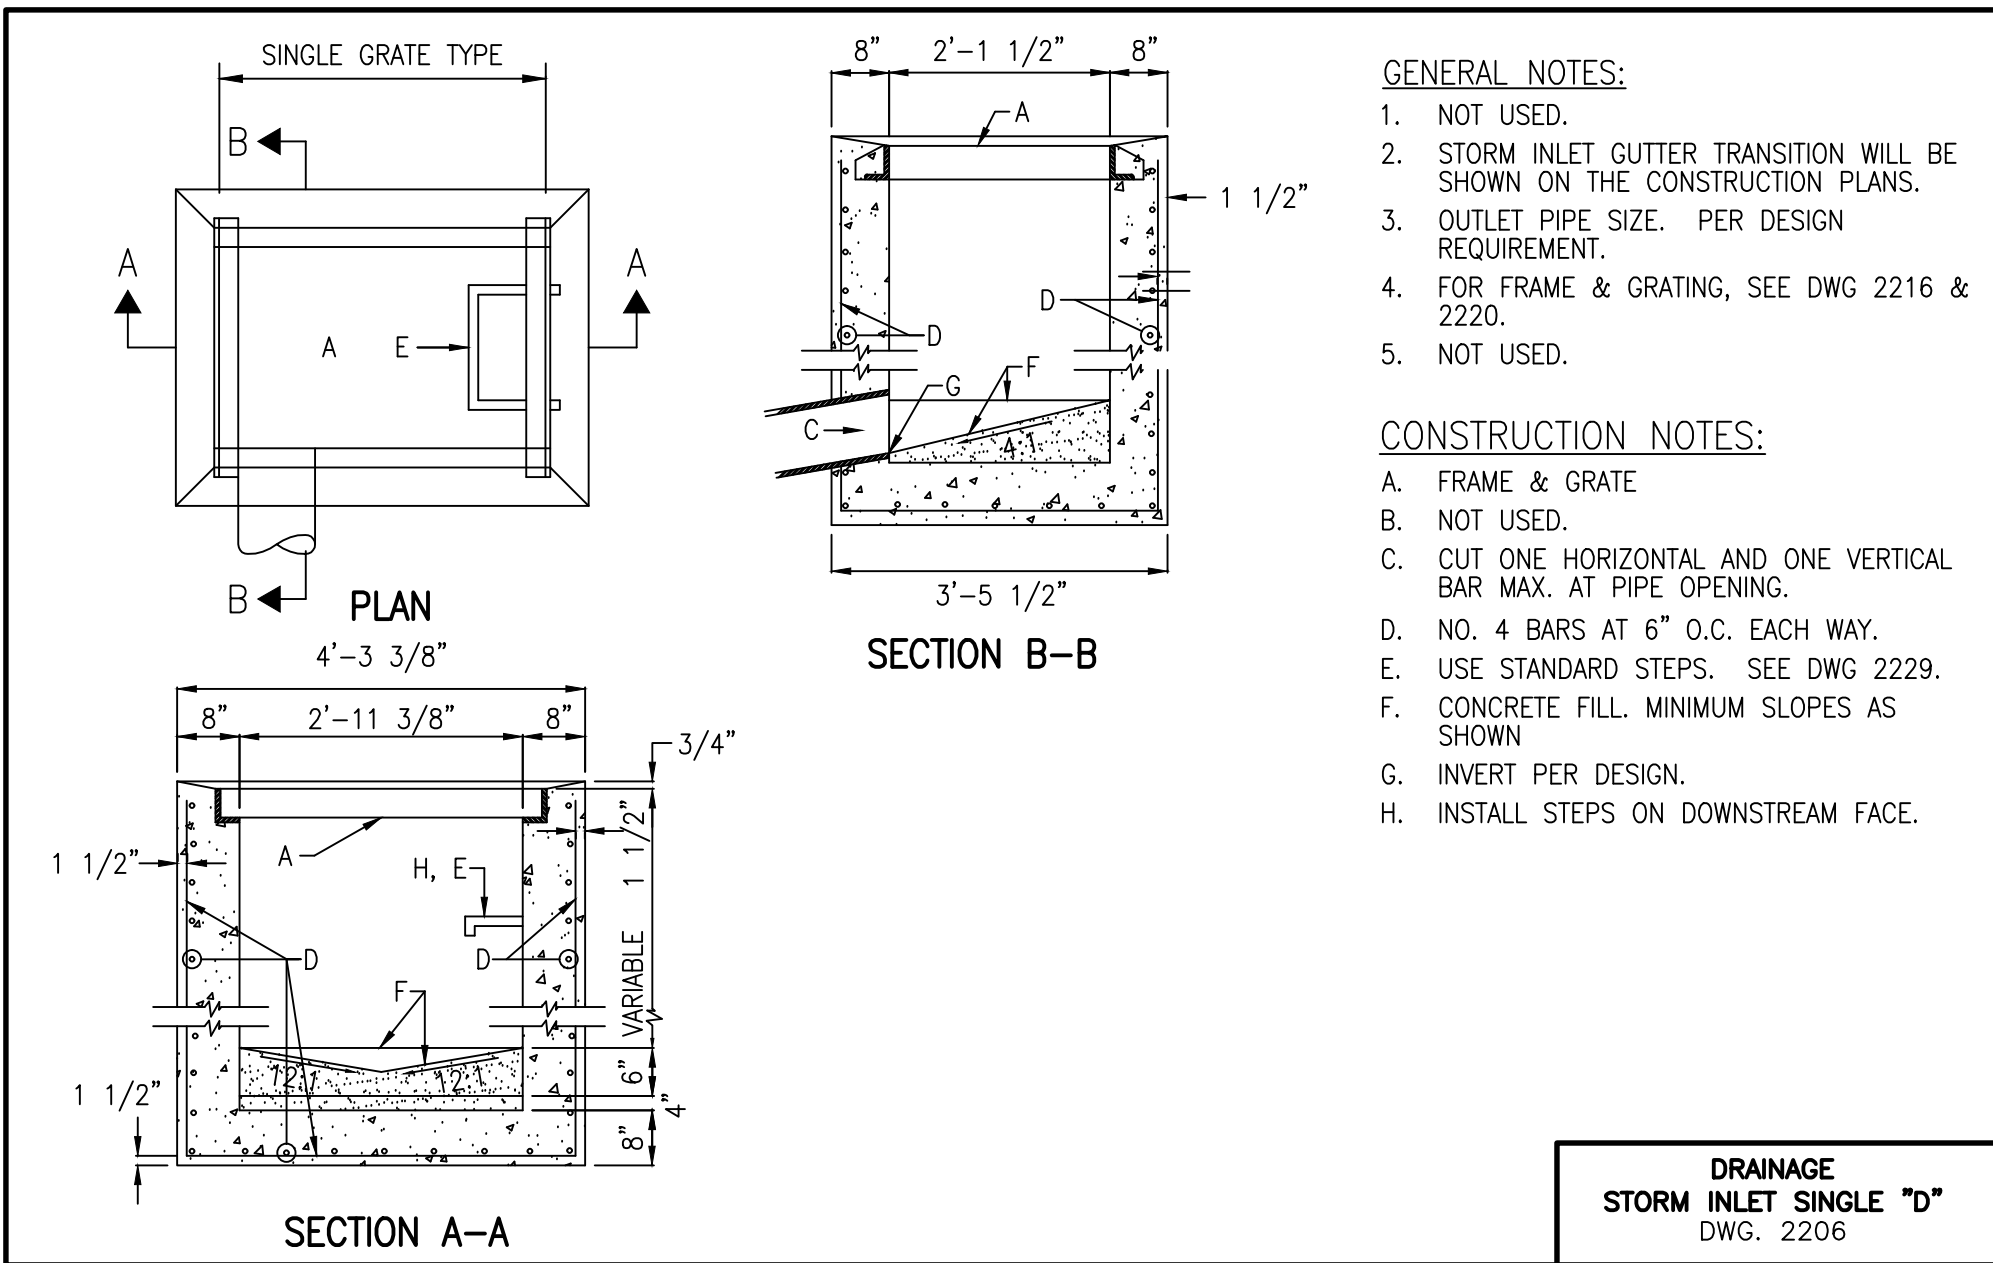

**24"x48" STORM INLET SECTION**  
SCALE: 1" = 1'-0"














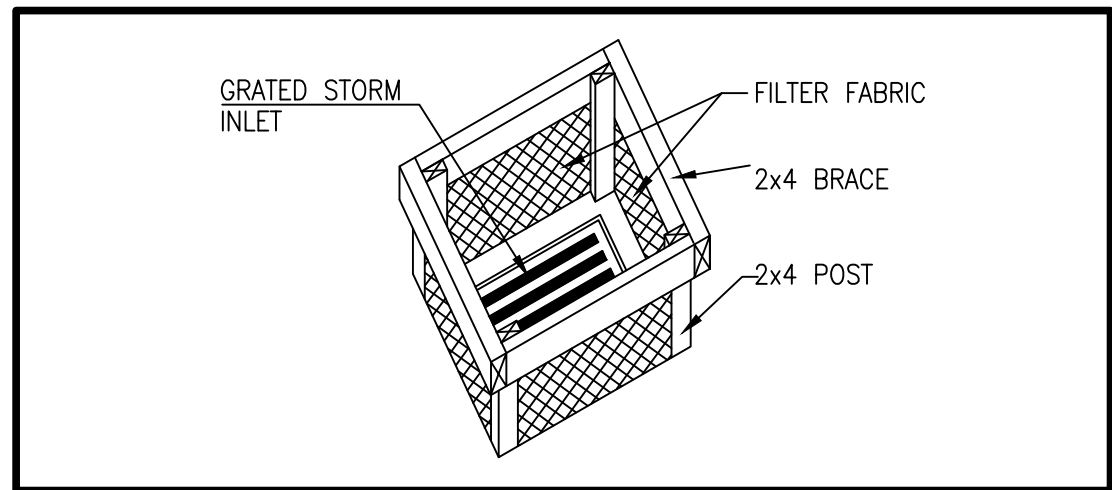


**SILT FENCE INLET PROTECTION**  
NOT TO SCALE

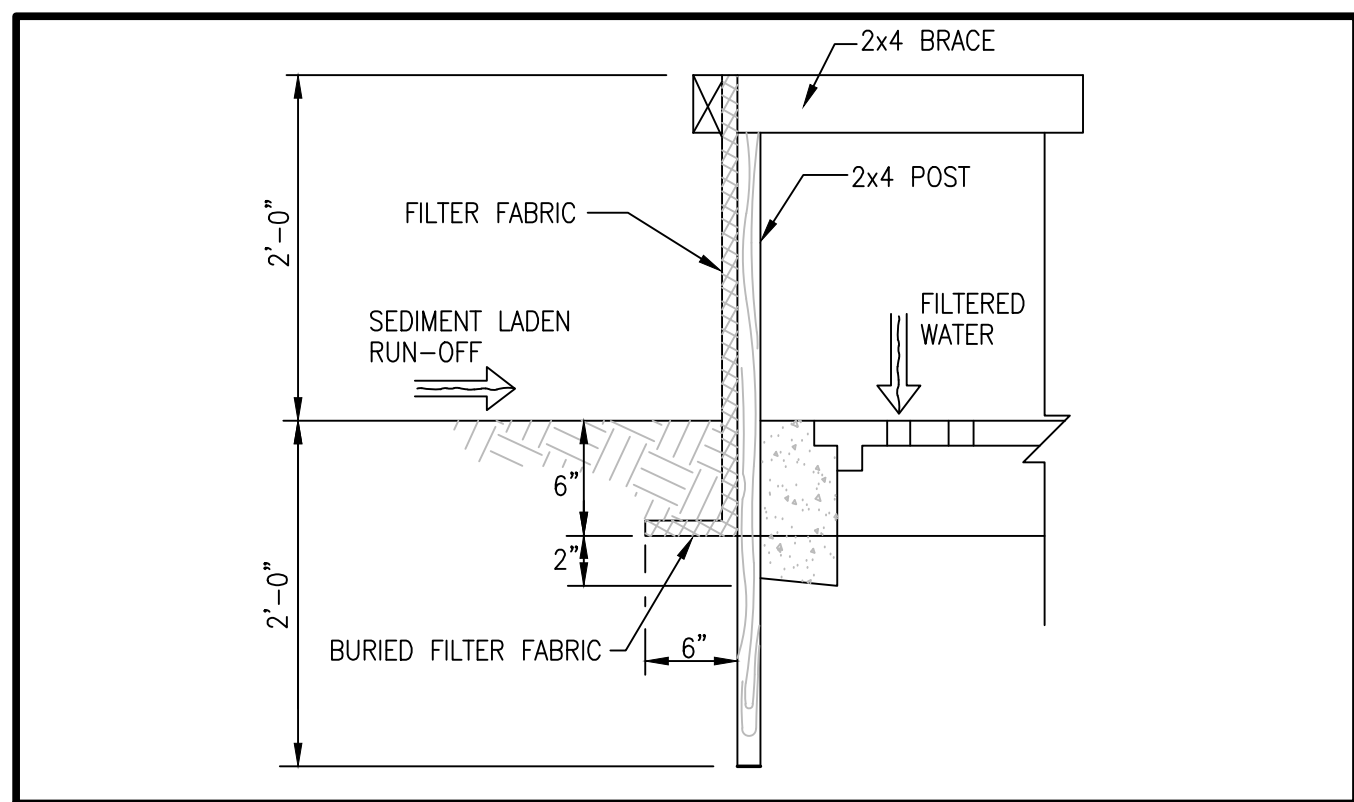


**SILT FENCE INLET PROTECTION SECTION**  
NOT TO SCALE

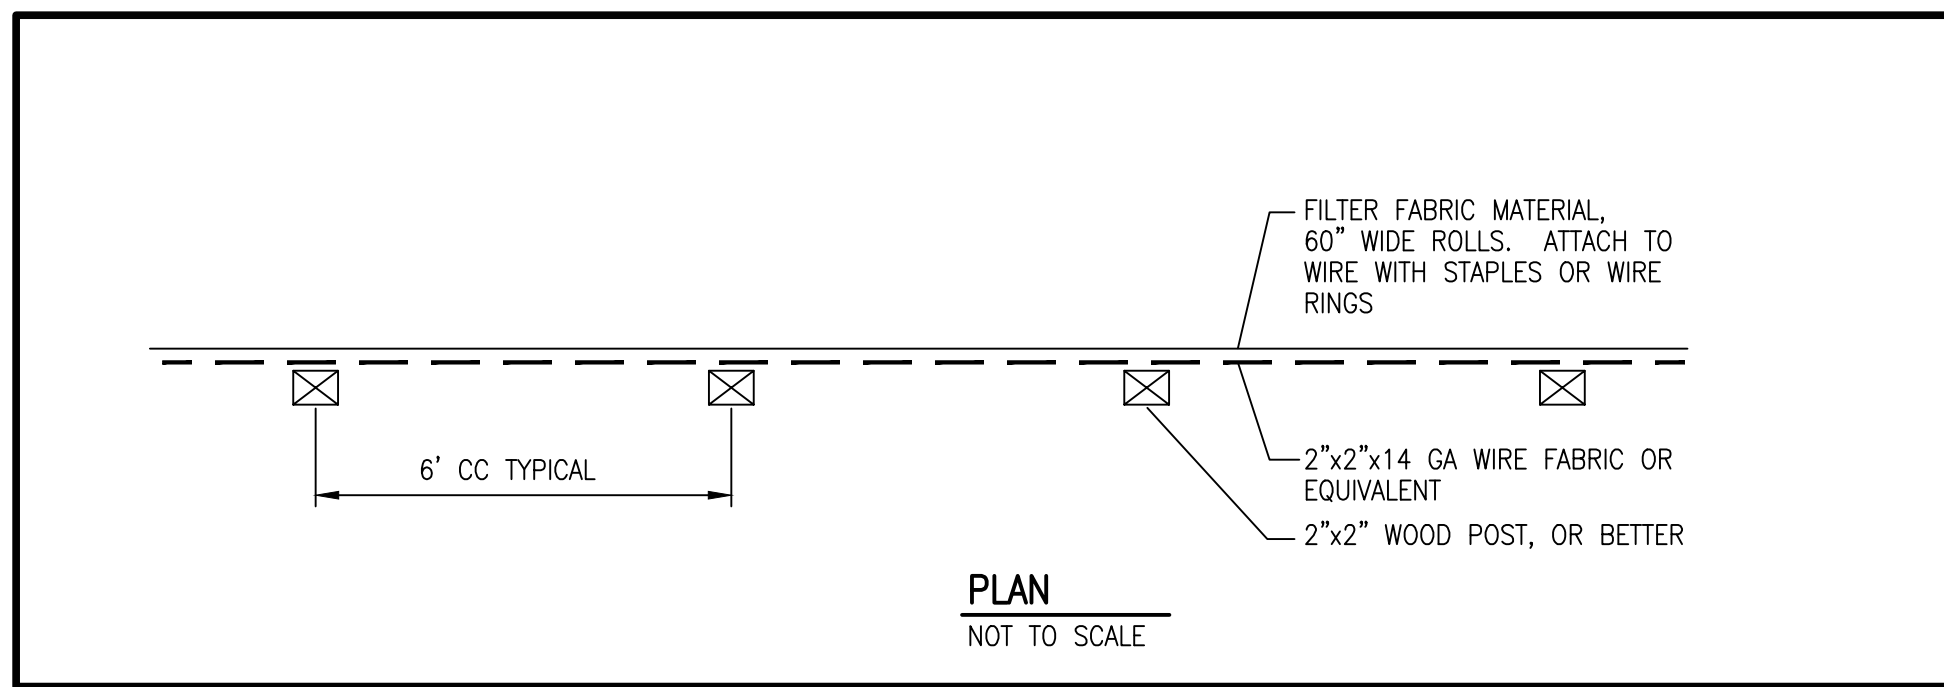


**PLAN**  
NOT TO SCALE

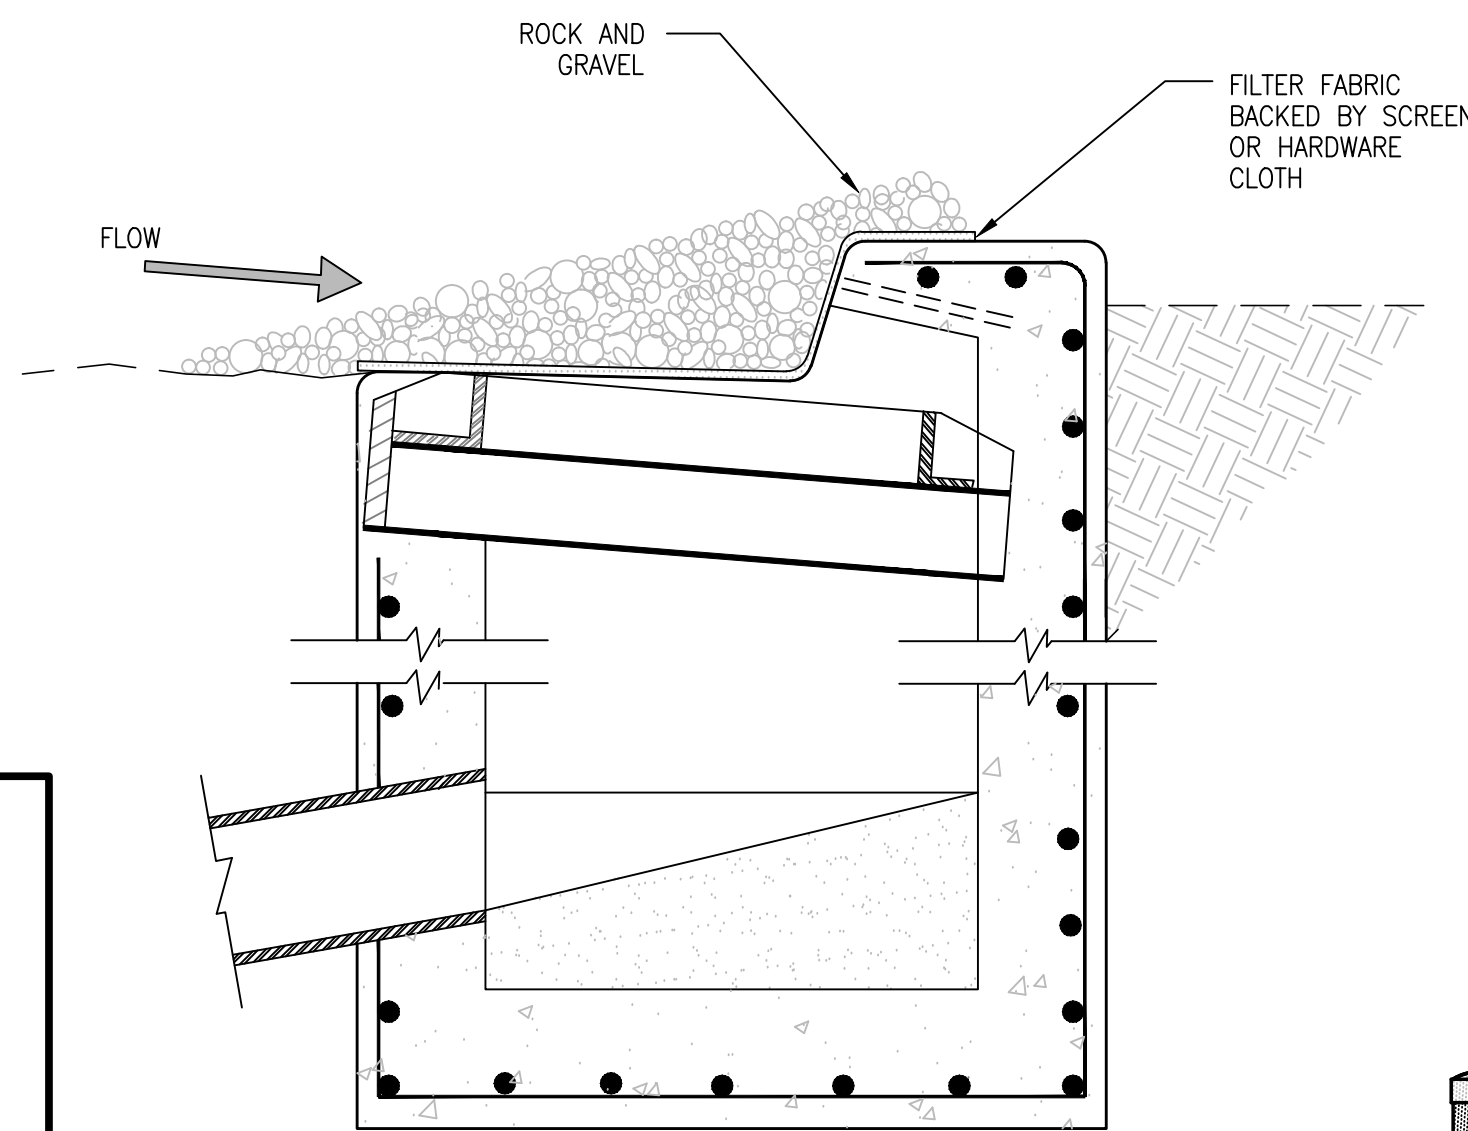

**TYPICAL STORM INLET PROTECTION**  
SCALE: 1" = 1'-0" (OPTIONAL)

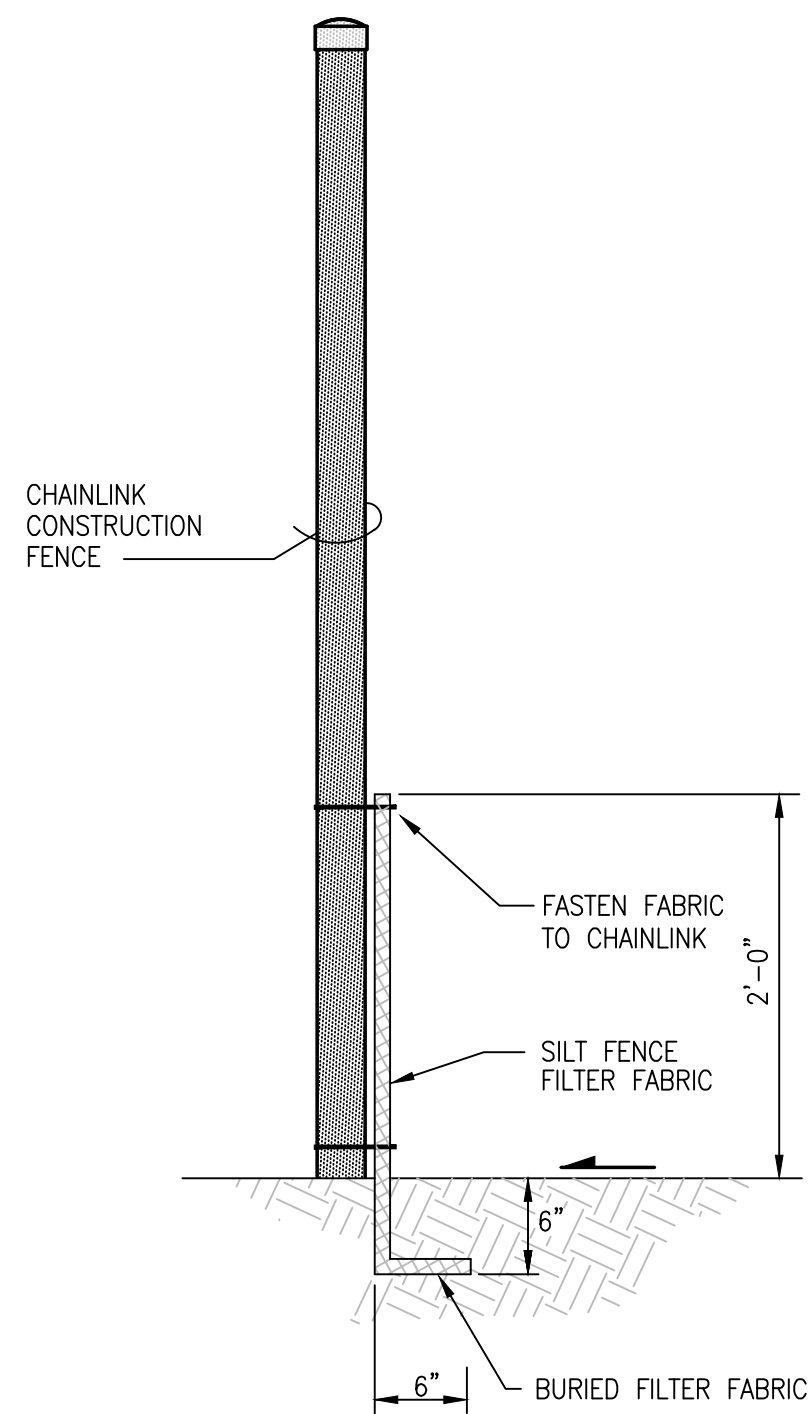

**CONSTRUCTION FENCE/SILT FENCE SECTION**  
SCALE: 1" = 2'-0"

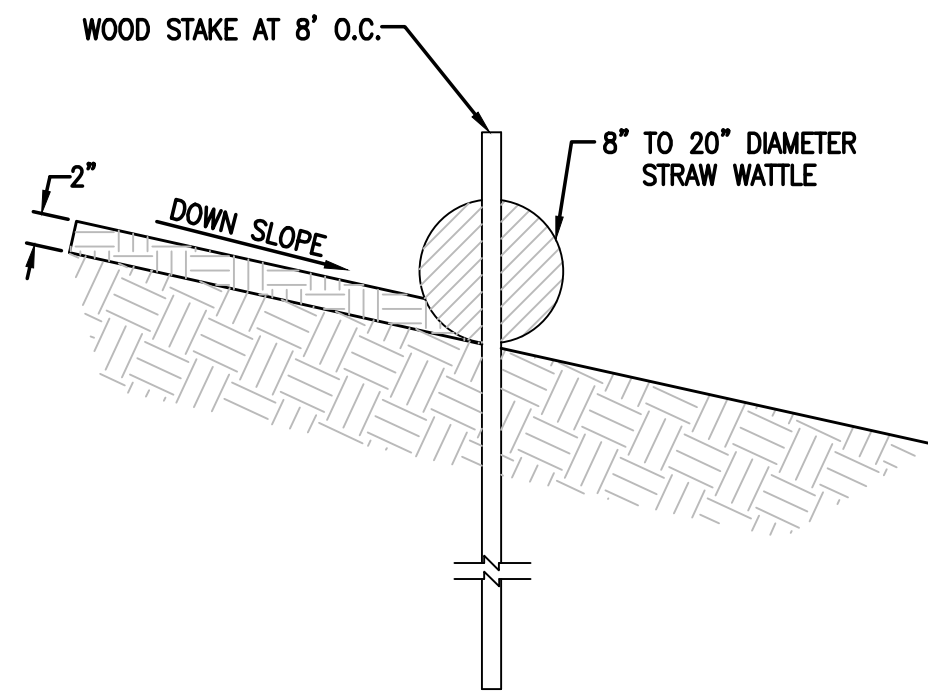


**TYPICAL STRAW WATTLE INSTALLATION SECTION**  
SCALE: 1" = 1'-0" (OPTIONAL)

**SEED MIX FOR SANDY SOILS**

VARIETY/COMMON NAME	GENUS/SPECIES	PLS./ACRE
"PALOMA" INDIAN RICE GRASS	ORYZOPSIS HYMENOIDES	5.0
"VIVA" GALLETA GRASS	HILARIA JAMESII	1.0
"NINER" SIDE OATS GRAMA	BOUTELOUA CURTIPENDULA	3.0
"HATCHITA" BLUE GRAMA	BOUTELOUA GRACILIS	1.0
SAND DROPSSEED (NM REGION)	SPOROBOLUS CRYPTANDRUS	1.0
FOUR-WING SALTBUCH (NM REGION)	ATRIPLEX CANESCENS (DE-WINGED)	1.0
TOTAL RATE:		12.0 LBS./ACRE


**EROSION AND SEDIMENT CONTROL PLAN NOTES:**

1. THIS PLAN ADDRESSES GENERAL AND SPECIFIC MEASURES FOR CONSTRUCTION PHASE EROSION, SEDIMENT AND DUST CONTROL. IT IS INTENDED TO COMPLEMENT THE PROJECT SPECIFIC STORM WATER POLLUTION AND PREVENTION PLAN (SWPPP) PREPARED FOR THIS PROJECT.
2. THE CONTRACTOR SHALL SECURE ALL REQUIRED PERMITS BEFORE BEGINNING CONSTRUCTION.
3. THE CONTRACTOR SHALL INSTALL ALL PERIMETER BMPs BEFORE BEGINNING CONSTRUCTION.
4. FOR PROJECT SPECIFIC PHASING AND INFORMATION, THIS PROJECT SHALL BE IMPLEMENTED IN PHASES TO MINIMIZE THE EXTENT AND DURATION OF SURFACE DISTURBANCE.
5. REFER TO THE GRADING AND DRAINAGE PLAN PREPARED BY HIGH MESA CONSULTING GROUP, DATED 2-6-17.
6. THE CONTRACTOR SHALL ENSURE THAT NO SOIL ERODES FROM THE SITE INTO PUBLIC RIGHT-OF-WAY OR PRIVATE PROPERTY.
7. THE CONTRACTOR SHALL PROMPTLY CLEAN-UP ANY MATERIAL EXCAVATED WITHIN THE PUBLIC RIGHT-OF-WAY SO THAT THE EXCAVATED MATERIAL IS NOT SUSCEPTIBLE TO BEING WASHED DOWN THE STREET.
8. THE CONTRACTOR SHALL CLEAN AND REMOVE ALL FUGITIVE DUST, SOIL AND DEBRIS RESULTING FROM THIS PROJECT FROM THE ADJACENT STREETS AT THE END OF EACH DAY.
9. THE CONTRACTOR SHALL IMPLEMENT AND MAINTAIN ALL GOOD HOUSEKEEPING MEASURES OUTLINED IN THE SWPPP INCLUDING , BUT NOT LIMITED TO, DAILY PICKING UP TRASH , LITTER AND CONSTRUCTION DEBRIS.
10. THE CONTRACTOR SHALL PROMPTLY REMOVE SEDIMENT ACCUMULATION FROM SILT FENCES AND OTHER STRUCTURAL BMPs WITHIN 48 HOURS OF A RAINFALL EVENT.
11. THE CONTRACTOR SHALL IMPLEMENT ONSITE STRUCTURAL EROSION CONTROL MEASURES AS REQUIRED TO COMPLY WITH THE EROSION AND SEDIMENT CONTROL PLAN AND SWPPP. THESE MEASURES MAY INCLUDE BUT ARE NOT LIMITED TO SILT FENCES, EARTHEN DIKES, DRAINAGE DIVERSIONS, SEDIMENT TRAPS, CHECK DAMS, SUBSURFACE DRAINS, PIPE SLOPE DRAINS, LEVEL SPREADERS, STORM WATER RETENTION SYSTEMS, GABIONS AND TEMPORARY OR PERMANENT SEDIMENT DETENTION BASINS. THE FOLLOWING MEASURES ARE PROPOSED FOR THIS PROJECT:
  - a. PERIMETER SILT FENCE
  - b. INTERIOR SILT FENCE
  - c. ONSITE INLET PROTECTION
  - d. SEDIMENT DETENTION BASINS
  - e.
12. THE CONTRACTOR SHALL MINIMIZE OFFSITE VEHICLE TRACKING OF SEDIMENT AND DUST GENERATION.
13. CONCRETE TRUCKS SHALL BE SENT BACK TO THE PLANT FOR WASHING; THE WASHING OF CONCRETE TRUCKS SHALL NOT BE PERMITTED ON THIS SITE UNLESS OTHERWISE PROVIDED FOR BY THIS PLAN. IF PROVIDED FOR BY THIS PLAN, CONCRETE TRUCKS MAY ONLY WASH OUT IN A DESIGNATED AND LINED WASHOUT FACILITY.
14. OFFSITE MATERIAL STORAGE AREAS USED BY THIS PROJECT ARE CONSIDERED PART OF THE PROJECT AND THEREFORE SUBJECT TO THE REQUIREMENTS OF THE EROSION AND SEDIMENT CONTROL PLAN AND SWPPP.
15. UPON COMPLETION OF MASS GRADING, ALL DISTURBED AREAS SHALL BE STABILIZED WITH PERMANENT CONSTRUCTION, LANDSCAPING, VEGETATION AND/OR GRAVEL MULCH. SILT FENCING CAN BE REMOVED UPON SUCCESSFUL ESTABLISHMENT OF VEGETATION.
16. THROUGHOUT THE DURATION OF THIS PROJECT, CONTRACTOR SHALL IMPLEMENT, MAINTAIN AND INSPECT ALL BMPs, KEEPING RECORDS OF EACH INSPECTION IN ACCORDANCE WITH THE SWPPP, AND KEEP RECORDS OF THE INSTALLATION MAINTENANCE, AND REMOVAL OF EACH BMP SPECIFIED BY THIS PLAN OR OTHERWISE PROVIDED FOR THROUGHOUT THE LIFE OF THE PROJECT.
17. THOSE PORTIONS OF THE COMPLETED PROJECT NOT STABILIZED WITH PERMANENT CONSTRUCTION OR FORMAL LANDSCAPING SHALL BE REVEGETATED WITH NATIVE GRASS SEEDING FOR SANDY/CLAY SOILS PER THE SEED MIX SPECIFIED HEREON AND SPECIFICATIONS CONTAINED WITHIN THE SWPPP.
18. FINAL STABILIZATION OF THE PROJECT SITE WILL CONSIST OF THE FOLLOWING MEASURES:
  - a. PERMANENT PAVING
  - b. FORMAL LANDSCAPING
  - c.
  - d.
  - e.
19. TOTAL SITE AREA = 12.3 ACRES (BASED ON 2016 BOUNDARY SURVEY)
20. TOTAL DISTURBED AREA = 4.5 ACRES

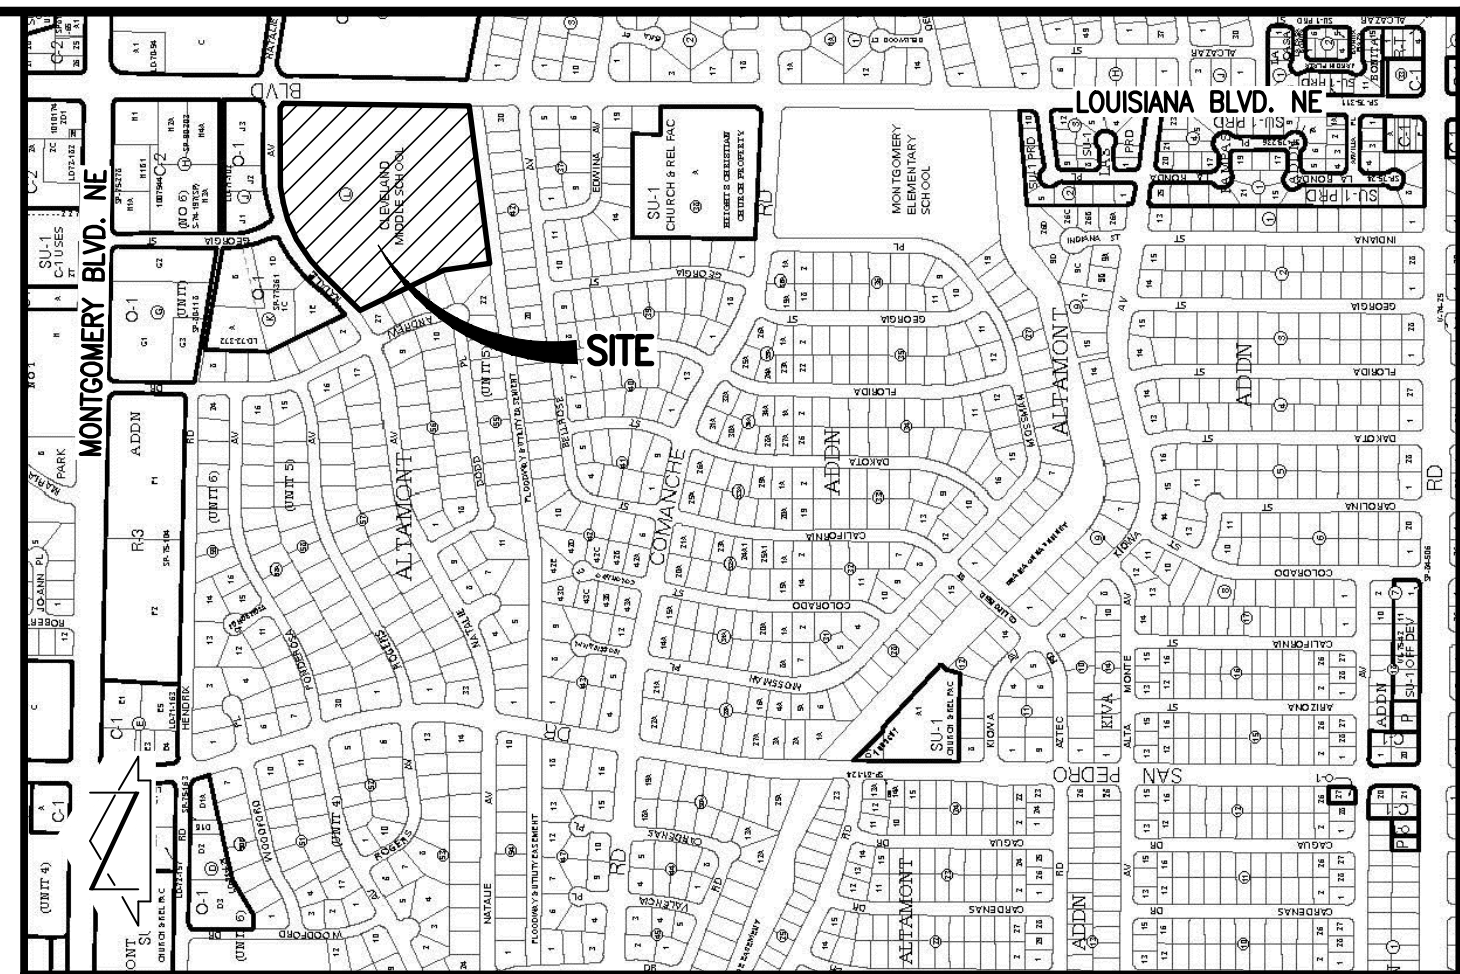

**VICINITY MAP**

SCALE: 1"=750'

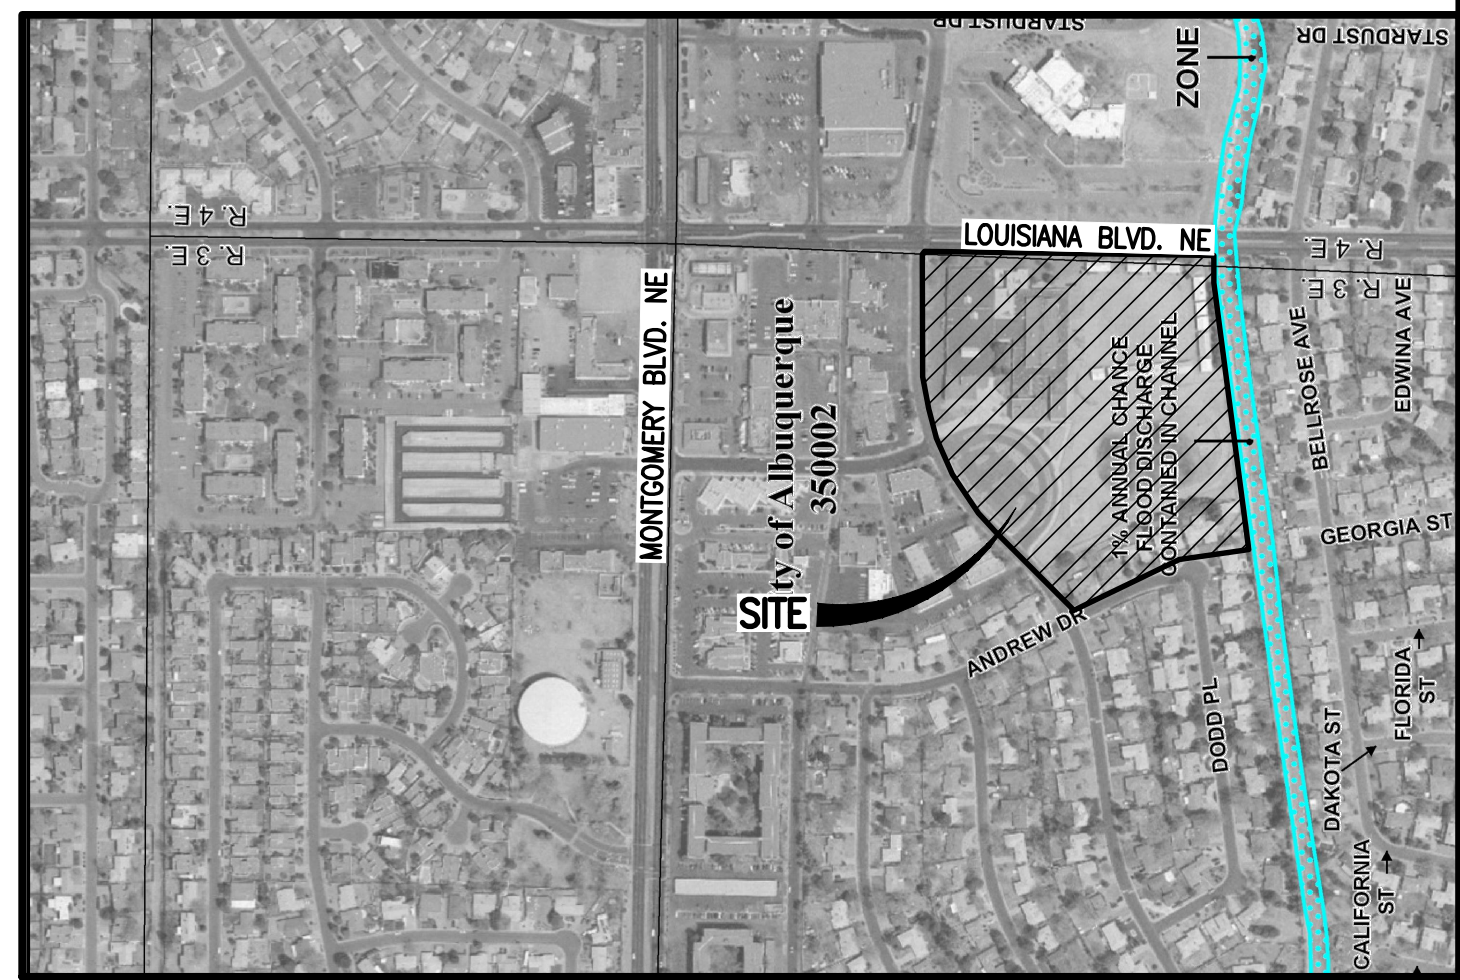


**F.I.R.M.**


SCALE: 1" = 750'

**PANEL 139 OF 825**

DATED: 8-26-2008

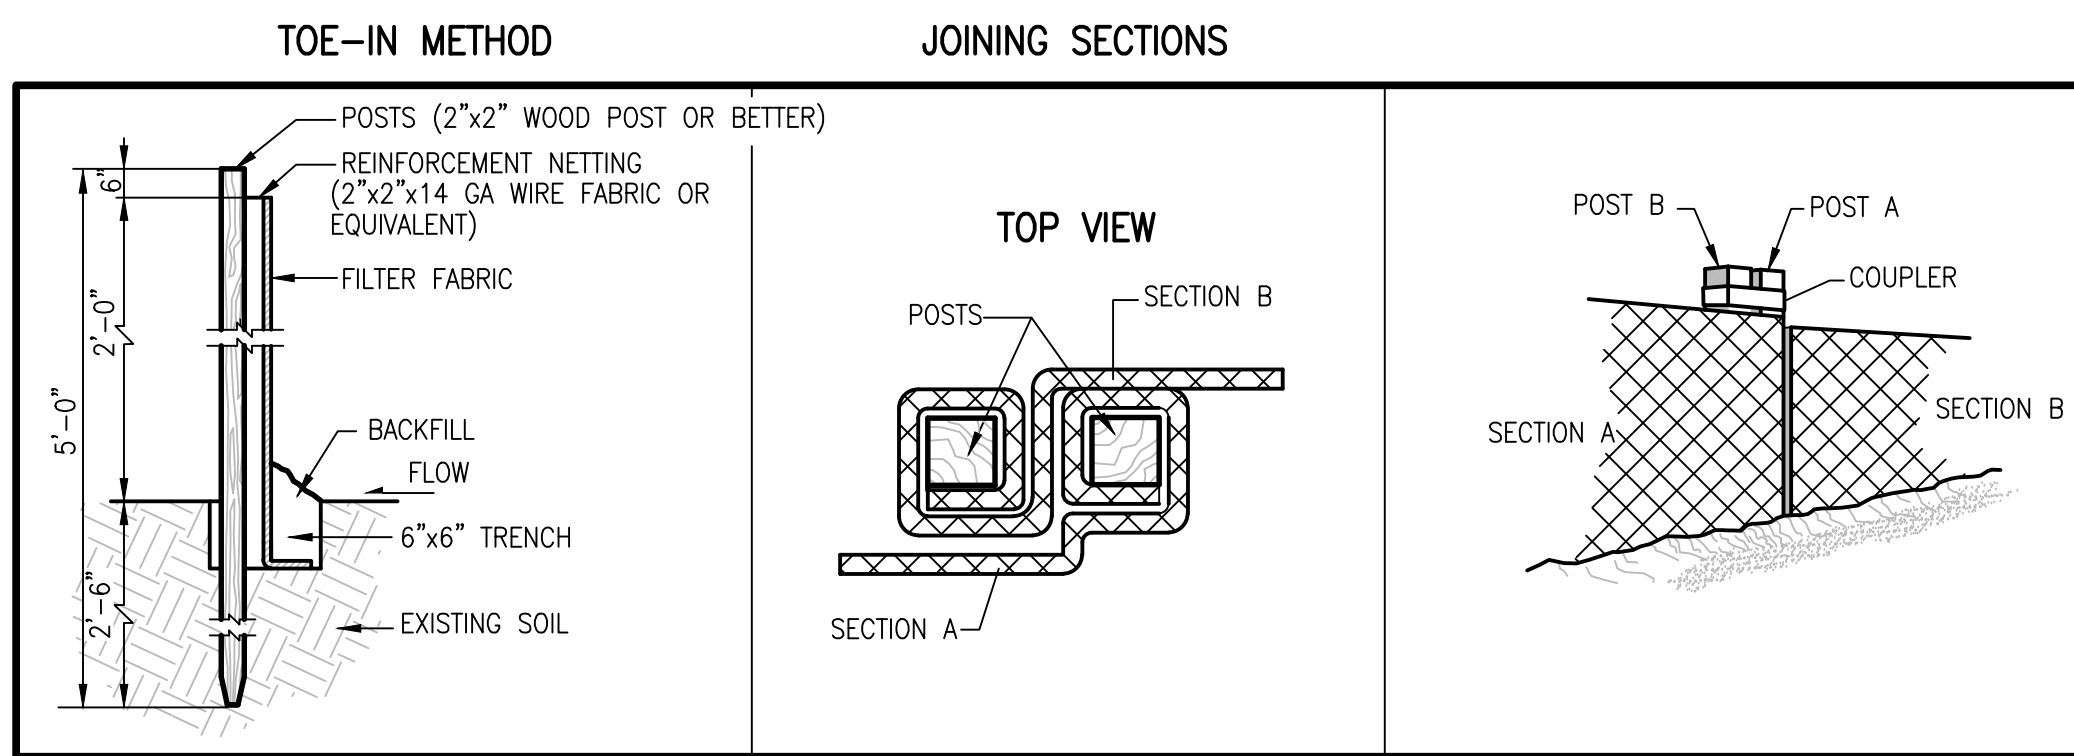

**PREFABRICATED SILT FENCE DETAILS**  
NOT TO SCALE

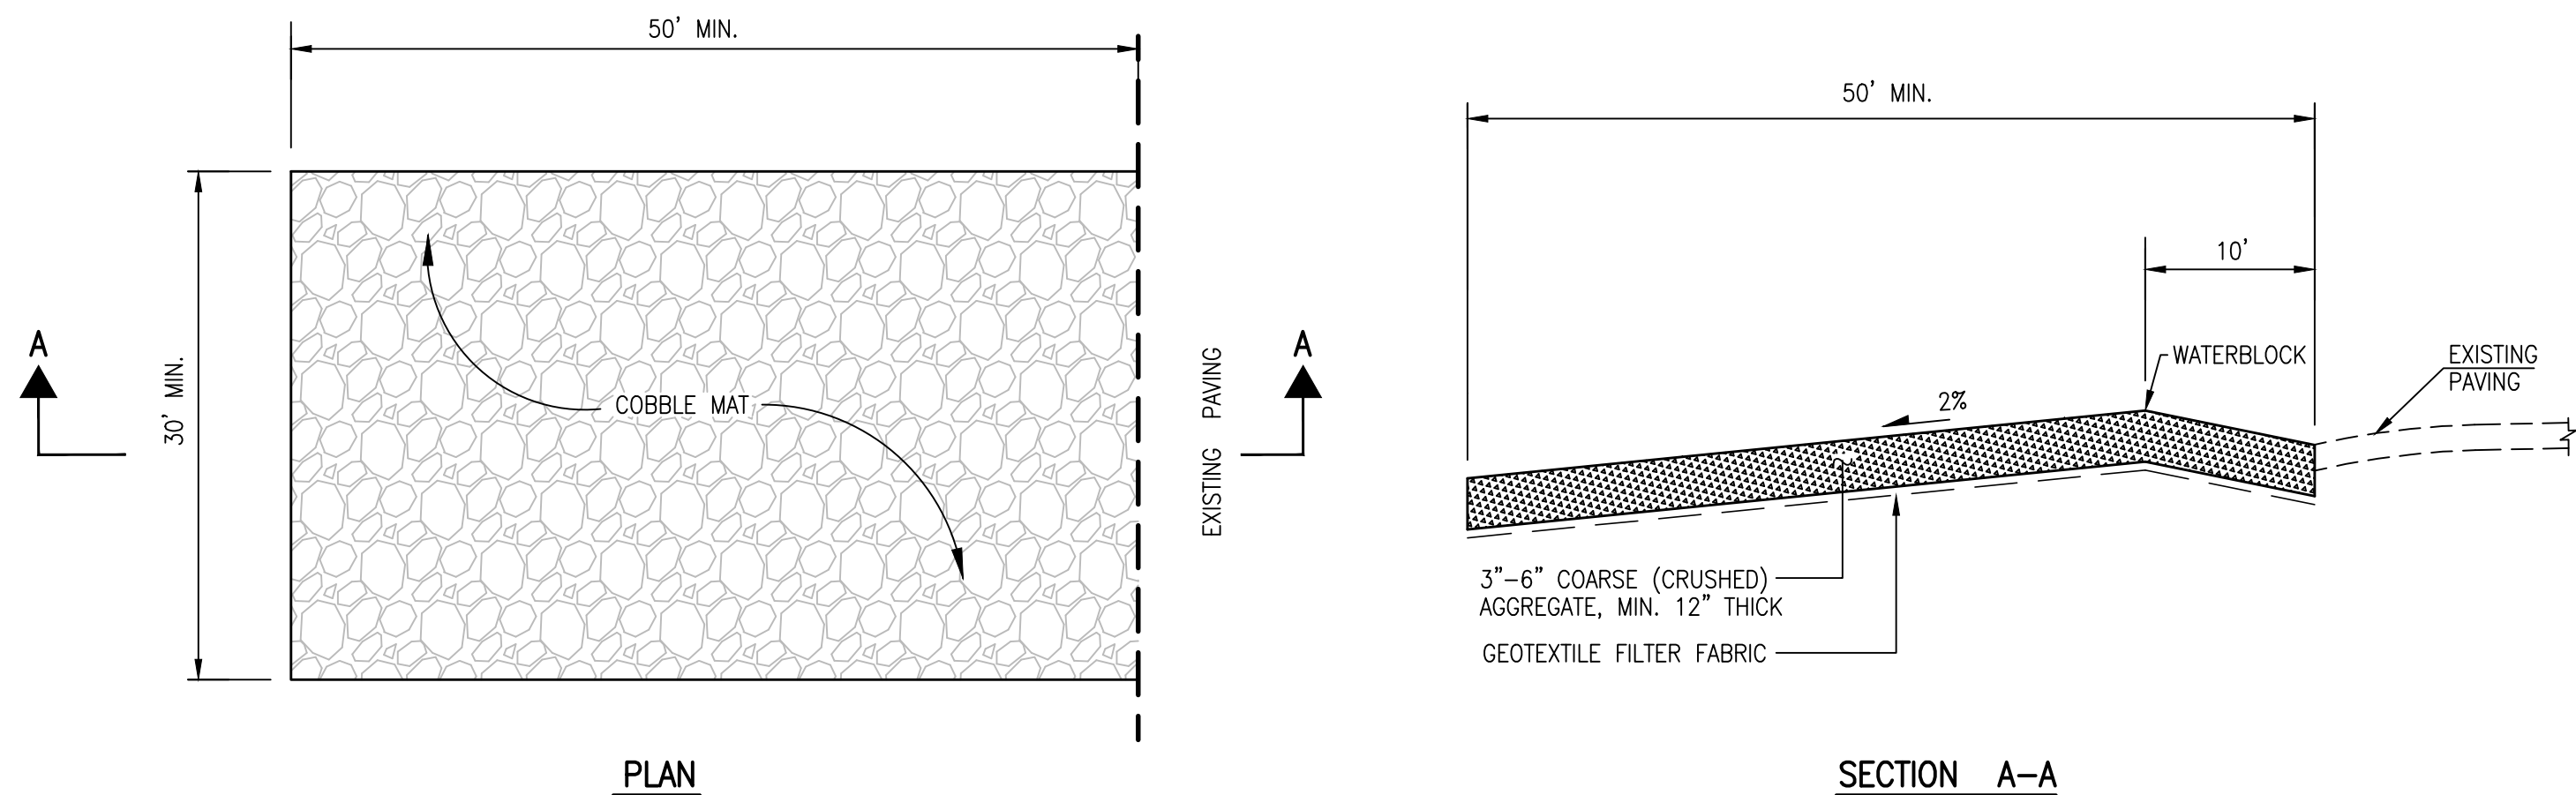

**PLAN**

**CONSTRUCTION ENTRANCE STABILIZATION**

SCALE: 1" = 10'-0" HORIZ.  
1" = 2'-0" VERT.

**SECTION A-A**