
### CITY OF ALBUQUERQUE

Planning Department Alan Varela, Director

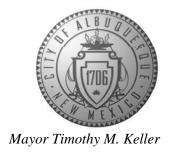

May 22, 2025

David A. Lovato, P.E. Nick Trujillo, P.E. Martin/Martin Consulting Engineers 12499 West Colfax Ave. Lakewood, CO 80215

**RE:** Del Sol Condos

8300 Comanche Rd. NE Grading & Drainage Plan

Engineer's Stamp Date: 05/07/2025

Hydrology File: G19D003A ABQ-PLAN No.: SI-2025-00085

Dear Mr. Lovato:

PO Box 1293

Based upon the information provided in your submittal received 05/08/2025, the Grading & Drainage Plan **is approved** for a Grading Permit and Building Permit. Please include a copy of these stamp approved plans in the construction sets for Building Permit processing along with a copy of this letter.

Albuquerque

#### PRIOR TO CERTIFICATE OF OCCUPANCY:

NM 87103

1. Engineer's Certification, per the DPM Part 6-14 (F): *Engineer's Certification Checklist For Non-Subdivision* is required.

www.cabq.gov

As a reminder, if the project total area of disturbance (including the staging area and any work within the adjacent Right-of-Way) is 1 acre or more, then an Erosion and Sediment Control (ESC) Plan and Owner's certified Notice of Intent (NOI) is required to be submitted to the Stormwater Quality Engineer (Doug Hughes, PE, jhughes@cabq.gov, 505-924-3420) 14 days prior to any earth disturbance.

If you have any questions, please contact me at 505-924-3362 or <u>richardmartinez@cabq.gov</u>.

Sincerely,

Richard Martinez, P.E. Senior Engineer, Hydrology Planning Department

Pilledle

**ABBREVIATIONS:** 

CAST IRON PIPE CENTERLINE CORRUGATED METAL PIPE

APPROXIMATE

CO CLEANOUT CONCRETE CONTOUR CORNER COPPER DEMO DEMOLITION

DIAMETER DIMENSION DIP DUCTILE IRON PIPE DTL. DETAIL ELEVATION ELECTRICAL

EASEMENT

**EXISTING** FIRE DEPARTMENT CONNECTION FLARED END SECTION FINISHED FLOOR ELEVATION

FINISHED GRADE AT WALL FIRE HYDRANT FLOW LINE FT FOOT

GRADE BREAK

GRATE (AREA OR VALLEY INLETS) GATE VALVE

HORIZONTAL ELLIPTICAL REINFORCED CONCRETE PIPE HIGH DENSITY POLYETHYLENE PIPE

HGL HYDRAULIC GRADE LINE HORZ HORIZONTAL

HIGH POINT INVERT LINEAL FEET LOW POINT LEFT MAX MAXIMUM MECHANICAL

MECHANICAL, ELECTRICAL AND PLUMBING

MANHOLE MINIMUM NOT IN CONTRACT PERFORATED PERIM PERIMETER

PERPENDICULAR PRESSURE INDICATOR VALVE

PROPERTY LINE PLBG PLUMBING

PRKG PARKING PRESSURE REDUCING VALVE PVC POLYVINYL CHLORIDE PIPE

PVMT PAVEMENT REINFORCED CONCRETE PIPE RD ROOF DRAIN

R.O.W. RIGHT OF WAY RIGHT SSWR SANITARY SEWER SQUARE FOOT STA STATION STORM SEWER STRC STRUCTURAL SWLK SIDEWALK SQUARE YARD TELE TELEPHONE

TB THRUST BLOCK TEMPORARY TOP OF CURB

TOW TOP OF WALL (RE: NOTE BELOW) TYP. UNDER DRAIN

UNDERGROUND VERTICAL

NOTE: TOW SHALL BE TOP OF WATER ON UTILITY SHEETS ONLY AND TOP OF WALL ON ALL OTHER SHEETS.

# DEL SOL CONDOS DRAINAGE REPAIRS CONSTRUCTION DOCUMENTS

LOCATED WITHIN SECTION 6

TOWNSHIP 10 NORTH, RANGE 4 EAST OF THE NEW MEXICO PRINCIPAL MERIDIAN CITY OF ALBUQUERQUE AND BERNALILLO COUNTY STATE OF NEW MEXICO



	SHEET INDEX
C1.00	COVER SHEET
C1.01	GENERAL NOTES
C1.10	INITIAL CONDITIONS AND DEMOLITION PLAN
C2.00	OVERALL GRADING AND EROSION CONTROL PLAN
C2.01	DETAILED GRADING PLAN - NORTH
C2.02	DETAILED GRADING PLAN - SOUTH
C2.50	EROSION CONTROL DETAILS
C3.00	UTILITY PLAN
C4.00	MAIN STORM SEWER PLAN & PROFILE
C4.10	STORM DETAILS

## DESIGNATION = ALBUQUERQUE CONTROL STATION "4 G20R".

**BENCHMARK:** 

ALBUQUERQUE, NM. = 5426.439 US FEET FOUND 3 INCH BRASS TABLET SET IN THE EAST MOST MEDIAN CURB ON THE NORTH MEDIAN NOSE OF THE INTERSECTION OF COMANCHE ROAD NE AND WYOMING BOULEVARD NE. TBM = 5,426.02 US FEET FOUND MAG NAIL SET IN TOP OF BLOCK WALL AT NORTHEAST PROPERTY CORNER OF SUBJECT PROPERTY.

#### BASIS OF BEARING:

ALL BEARINGS BASED ON THE NEW MEXICO STATE PLAN GRID, NAD83 DATUM.

OR EXCAVATE FOR MARKING OF Damage Prevention UNDERGROUND MEMBER UTILITIES

MARTIN/MARTIN ASSUMES NO RESPONSIBILITY FOR UTILITY LOCATIONS. UNLESS OTHERWISE NOTED, THE UTILITIES SHOWN ON THIS DRAWING ARE BASED ON INFORMATION PROVIDED BY OTHERS AND DEPICTED AS ASCE (38) QUALITY LEVEL D. CONTRACTOR MUST ALSO NOTIFY THE CITY OF ALBUQUERQUE THAT AN 811 CALL OCCURRED.


	PROPERTY LINE	
	RIGHT-OF-WAY LINE	
	SECTION LINE	
	EASEMENT	
	RETAINING WALL	
	CURB & GUTTER	
	CURB & GUTTER (SPILL)	
	CURB & GUTTER (CATCH)	
	HEAVY DUTY DRIVE LANES	
	CONCRETE/ SIDEWALK	A. A
<i> 5750</i>	CONTOURS	5750
	UTILITY CROSSING	#
st	STORM SEWER	ST
ST	STORM MANHOLE	ST
	ROOF DRAIN	RD
	STORM INLET	-
<	FLARED END SECTION	
	SANITARY SEWER	ss
(\$9)	SANITARY MANHOLE	SS
Q.	CLEAN OUT	<b>⊙</b>
	WATER LINE	W
$\otimes$	WATER VALVE	$\otimes$
Q	FIRE HYDRANT	A
⊗ WM	WATER METER	<u></u>
	IRRIGATION LINE	IR
IRR	IRRIGATION CONTROL	
OHE	OVERHEAD ELECTRIC	
E	ELECTRIC LINE	——Е——
$\Diamond$	LIGHT POLE	<b>\$</b>
Ø	POWER POLE	ø
ELEC	ELECTRIC METER	
	TELEPHONE LINE	т_
TEL	TELEPHONE PEDESTAL	Т
	CABLE TV	ст
	GAS LINE	G
	FIBER OPTIC	FO
O.W.	MONITOR WELL	
	SIGN	•
>	DIRECTION OF FLOW	<b>-</b>
	GRADING ARROW	
	DECIDUOUS TREE	
	EVERGREEN TREE	
	BUSH/SHRUB	
ELEV	SPOT ELEVATIONS	ELEV.
X		_

LEGEND

PROPOSED

EXISTING

RTIN/MARTIN

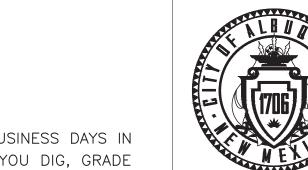

CITY OF ALBUQUERQUE DEPARTMENT OF MUNICIPAL DEVELOPMENT **ENGINEERING DIVISION** 

DEL SOL CONDOS CONSTRUCTION DOCUMENTS

DESIGN REVIEW COMMITTEE

CITY ENGINEER APPROVAL ZONE MAP NO.

CITY PROJECT NO. SHEET 1 OF 10 SHEET NO.

2 7 2 2

Sheet Number:

ALL PROPOSED DESIGN IS BASED ON A SITE SURVEY PROVIDED BY WAYJOHN SURVEYING, INC. DATED JUNE 2024. CONTRACTOR SHALL VERIFY EXISTING CONDITIONS PRIOR TO CONSTRUCTION AND CONTACT ENGINEER IMMEDIATELY OF ANY DISCREPANCIES.

ALL CONSTRUCTION WITHIN CITY RIGHT-OF-WAY OR PUBLIC EASEMENTS MUST BE DONE FROM APPROVED WORK ORDER DOCUMENTS ISSUED BY THE CITY.

ALL WORK ON THIS PROJECT SHALL BE PERFORMED IN ACCORDANCE WITH APPLICABLE FEDERAL, STATE, AND LOCAL LAWS, ORDINANCES, RULES, AND REGULATIONS CONCERNING CONSTRUCTION SAFETY AND HEALTH.

CONTRACTOR SHALL ASSUME THE SOLE AND COMPLETE RESPONSIBILITY FOR THE JOB SITE CONDITIONS DURING THE COURSE OF CONSTRUCTION OF THIS PROJECT, INCLUDING SAFETY OF ALL PERSONS AND PROTECTION OF PROPERTY. THIS REQUIREMENT SHALL APPLY CONTINUOUSLY AND NOT BE LIMITED TO NORMAL WORKING HOURS. CONTRACTOR SHALL DEFEND, INDEMNIFY, AND HOLD HARMLESS THE OWNER AND ENGINEER FROM ANY AND ALL LIABILITY REAL OR 9. CONTRACTOR SHALL PROMPTLY CLEAN UP ANY EXCAVATED MATERIAL WITHIN THE PUBLIC RIGHT-OF-WAY OR PRIVATE ALLEGED. IN CONNECTION WITH THE PERFORMANCE OF WORK ON THIS PROJECT, EXCEPT LIABILITY ARISING FROM THE SOLE NEGLIGENCE OF THE OWNER OR ENGINEER.

ALL EXCAVATION, TRENCHING, AND SHORING ACTIVITIES MUST BE ACCOMPLISHED IN ACCORDANCE WITH OSHA 29CFR 1926.650, SUBPART "P".

AN EXCAVATION / CONSTRUCTION PERMIT WILL BE REQUIRED BEFORE BEGINNING ANY WORK WITHIN CITY RIGHT-OF-WAY.

CONTRACTOR SHALL NOTIFY THE CONSTRUCTION ENGINEER (OR CITY PROJECT MANAGER) NOT LESS THAN SEVEN (7) DAYS PRIOR TO STARTING WORK IN ORDER THAT THE CITY SURVEYOR MAY TAKE NECESSARY MEASURES TO INSURE THE PRESERVATION OF SURVEY MONUMENTS. CONTRACTOR SHALL NOT DISTURB PERMANENT SURVEY MONUMENTS WITHOUT THE CONSENT OF THE CITY SURVEYOR AND SHALL NOTIFY THE CITY SURVEYOR AND BEAR THE EXPENSE OF REPLACING ANY THAT MAY BE DISTURBED WITHOUT PERMISSION. ONLY THE CITY SURVEYOR SHALL REPLACE SURVEY MONUMENTS. WHEN A CHANGE IS MADE IN THE FINISHED ELEVATIONS OF THE PAVEMENT OF ANY ROADWAY IN WHICH A PERMANENT SURVEY MONUMENT IS LOCATED, CONTRACTOR SHALL, AT HIS/HER OWN EXPENSE, ADJUST THE MONUMENT COVER TO THE NEW GRADE UNLESS OTHERWISE SPECIFIED. REFER TO STANDARD SPECIFICATION SECTION 4.4.

CONTRACTOR SHALL ASSIST THE ENGINEER / INSPECTOR IN THE RECORDING OF DATA ON ALL UTILITY LINES AND APPURTENANCES AS REQUIRED BY THE CITY OF ALBUQUERQUE FOR THE PREPARATION OF "AS-BUILT" DRAWINGS. CONTRACTOR SHALL NOT COVER UTILITY LINES OR APPURTENANCES UNTIL ALL DATA HAVE BEEN RECORDED.

CONTRACTOR SHALL ASSUME FINANCIAL RESPONSIBILITY FOR ANY DAMAGE TO EXISTING PAVEMENT, PAVEMENT MARKINGS, SIGNAGE, CURB & GUTTER, A.D.A. RAMPS, AND SIDEWALK DURING CONSTRUCTION APART FROM THOSE SECTIONS INDICATED FOR REMOVAL ON THE PLANS, AND SHALL REPAIR OR REPLACE, PER THE STANDARD SPECIFICATIONS, ANY SUCH DAMAGE.

O. CONTRACTOR SHALL MAINTAIN A GRAFFITI—FREE WORK SITE. CONTRACTOR SHALL PROMPTLY REMOVE ANY AND ALL GRAFFITI FROM EQUIPMENT, WHETHER PERMANENT OR TEMPORARY.

. CONTRACTOR SHALL BE RESPONSIBLE FOR PROVIDING AND MAINTAINING ALL CONSTRUCTION SIGNAGE UNTIL THE PROJECT HAS BEEN ACCEPTED BY THE CITY AND OTHER JURISDICTIONAL AUTHORITIES WHERE APPLICABLE.

#### 「RANSPORTATION

ALL STREET STRIPING ALTERED OR DESTROYED SHALL BE REPLACED WITH PLASTIC REFLECT-ORIZED PAVEMENT MARKING BY CONTRACTOR AT THE SAME LOCATION AS EXISTING OR AS INDICATED ON THIS PLAN SET.

WORK AFFECTING ARTERIAL ROADWAYS MAY REQUIRE TWENTY-FOUR-HOUR CONSTRUCTION.

REMOVAL OF EXISTING CURB & GUTTER AND SIDEWALKS SHALL BE TO THE NEAREST JOINT.

ANY DAMAGE TO THE EXISTING CURB & GUTTER, PAVEMENT, SIDEWALKS, STRIPING, OR SIGNAGE DURING CONSTRUCTION SHALL BE REPLACED AT THE CONTRACTOR'S EXPENSE.

OVERNIGHT PARKING OF CONSTRUCTION EQUIPMENT SHALL NOT OBSTRUCT DRIVEWAYS OR DESIGNATED TRAFFIC LANES. THE CONTRACTOR SHALL NOT STORE ANY EQUIPMENT OR MATERIAL WITHIN THE PUBLIC RIGHT-OF-WAY.

CURB & GUTTER, SIDEWALKS, AND DRIVEPADS SHALL MATCH THE LINE AND GRADE OF ABUTTING EXISTING AREAS AS SHOWN ON THE PLANS OR AS DIRECTED BY THE PROJECT ENGINEER.

THE SUBGRADE PREPARATION SHALL EXTEND ONE (1) FOOT BEYOND THE FREE EDGE OF NEW CURB & GUTTER AND SIDEWALK.

CONTRACTOR SHALL TEST SUBGRADE R-VALUE PRIOR TO CONSTRUCTION. IN THE EVENT THE R-VALUE IS LESS THAN 50, REMOVE TWO FEET OF SUBGRADE MATERIAL AND IMPORT MATERIAL WITH R-VALUE GREATER THAN 50, OR CONTACT THE ENGINEER IMMEDIATELY SO THE PAVEMENT SECTION CAN BE MODIFIED.

AT ALL PAVEMENT REMOVAL AND REPLACEMENTS, SAW-CUT EDGES SHALL BE STRAIGHT AND CLEAN, AND LONGITUDINAL JOINTS SHALL NOT BE PLACED WITHIN WHEEL PATHS. PATCHES SHALL BE REGULAR AND SQUARE OR RECTANGULAR, WITH FOUR STRAIGHT SIDES. FINISHED PAVEMENT SURFACE SHALL BE FLUSH WITH EXISTING PAVEMENT SURFACE, WITH NO SPILLOVER OF ASPHALT OR TACK COAT. CARE MUST BE TAKEN TO AVOID DAMAGING THE INTEGRITY OR APPEARANCE OF SURROUNDING PAVEMENT: IF DAMAGED, THE ENTIRE SURFACE PATCH MUST BE EXPANDED TO COVER DAMAGES.

O. CONTRACTOR WILL ENSURE THE ASPHALT HAS A SMOOTH, UNIFORM EDGE WHEN REMOVING AND REPLACING CURB & GUTTER. IF THE ASPHALT EDGE IS NOT SMOOTH AND UNIFORM, CONTRACTOR SHALL SAW-CUT AND REPLACE A ONE-FOOT STRIP OF ASPHALT ALONG THE FULL SECTION BEING REPLACED; REFER TO C.O.A. STANDARD DRAWING NO. 2465 WITH THE APPROPRIATE PAVING SECTION BASED ON ROADWAY CLASSIFICATION.

1. TWO WEEKS PRIOR TO CONSTRUCTION, THE CONTRACTOR SHALL NOTIFY THE TRANSIT DEPARTMENT OF ANY IMPACT THE PROJECT WILL HAVE ON THE TRANSIT SYSTEM, SUCH AS CAUSING A DETOUR OR THE CLOSURE OR RELOCATION OF A BUS STOP. THE CONTACT PERSON IS DOUGLAS GOFF, OFFICE PHONE 724-3137, CELL PHONE 206-0151, OR E-MAIL: DGOFF@CABQ.GOV

#### DTHER COMMON NOTES

CONTRACTOR SHALL SECURE A "TOPSOIL DISTURBANCE PERMIT" PRIOR TO BEGINNING WORK

CONTRACTOR SHALL DETERMINE IN ADVANCE OF CONSTRUCTION IF OVERHEAD UTILITY LINES, SUPPORT STRUCTURES, GUYS, ETC., ARE AN OBSTRUCTION TO CONSTRUCTION OPERATIONS. IF ANY OBSTRUCTIONS TO CONSTRUCTION OPERATIONS ARE PRESENT, CONTRACTOR SHALL BE RESPONSIBLE FOR COORDINATING WITH THE APPROPRIATE UTILITY 2. EXISTING ELEVATIONS SHOWN ON THIS DRAWING HAVE BEEN DEPICTED FROM BEST AVAILABLE INFORMATION AND OWNER TO REMOVE OR SUPPORT THE UTILITY OBSTRUCTION. ANY COST ASSOCIATED WITH THIS EFFORT SHALL BE THE RESPONSIBILITY OF THE CONTRACTOR.

PNM WILL PROVIDE, AT NO COST TO THE CITY OR THE CONTRACTOR, THE NECESSARY PERSONNEL FOR INSPECTION OR OBSERVATION DEEMED NECSSARY BY PNM WHILE THE CONTRACTOR IS EXPOSING PNM'S CABLES. HOWEVER, THE CONTRACTOR SHALL BE CHARGED THE TOTAL COST ASSOCIATED WITH REPAIRS TO ANY DAMAGED CABLES OR FOR ANY COST ASSOCIATED WITH SUPPORTING OR RELOCATING THE POLES AND CABLES DURING CONSTRUCTION.

EXISTING UTILITY LINE LOCATIONS ARE SHOWN IN AN APPROXIMATE MANNER ONLY; LINES MAY EXIST WHERE NONE ARE SHOWN. THE LOCATION OF ANY SUCH EXISTING LINES IS BASED UPON INFORMATION PROVIDED BY THE UTILITY COMPANY, THE OWNER, OR BY OTHERS, AND THE INFORMATION MAY BE INCOMPLETE OR MAY BE OBSOLETE BY THE TIME CONSTRUCTION BEGINS.

THE ENGINEER HAS UNDERTAKEN NO FIELD VERIFICATION OF THE LOCATION, DEPTH, SIZE, OR TYPE OF EXISTING UNDERGROUND UTILITY LINES. MAKES NO REPRESENTATION PERTAINING THERETO. AND ASSUMES NO RESPONSIBILITY OR LIABILITY THEREFORE. CONTRACTOR SHALL FIELD-VERIFY THE LOCATION OF ANY UTILITY LINE IN OR NEAR THE AREA OF THE WORK IN ADVANCE OF AND DURING EXCAVATION WORK. CONTRACTOR IS FULLY RESPONSIBLE FOR ANY AND ALL DAMAGE CAUSED BY HIS/HER FAILURE TO LOCATE, IDENTIFY, AND PRESERVE ANY AND ALL EXISTING UTILITIES.

6. CONTRACTOR SHALL SUPPORT ALL EXISTING UNDERGROUND UTILITIES WHICH BECOME EXPOSED DURING CONSTRUCTION. PAYMENT FOR SUPPORTING WORK SHALL BE INCIDENTAL TO STORM SEWER, WATER LINE, AND/OR SEWER LINE COSTS.

7. CONTRACTOR SHALL SUPPORT AND MAINTAIN THE INTEGRITY OF ALL UNDERGROUND TELEPHONE, ELECTRIC CABLES, COMMUNICATION CABLES, AND CABLE-TELEVISION UTILITIES AT NO ADDITIONAL COST TO THE OWNER. CABLE SHALL BE SUPPORTED AT A MAXIMUM SPACING OF FIFTEEN (15) FEET. CONTRACTOR SHALL COORDINATE WITH AND MAKE ANY NECESSARY PAYMENT TO UTILITY OWNER FOR DE-ENERGIZATION OF CABLES, OR SUPPORT OF CABLES BY THE 2 UTILITY OWNER.

8. ALL FINAL BACKFILL FOR TRENCHES WITHIN THE COA RIGHT-OF-WAY SHALL BE COMPACTED TO A MINIMUM OF 95% MAXIMUM DENSITY PER ASTM D-1557 AND AS DIRECTED BY STANDARD SPECIFICATIONS SECTION 701.14.2 AND STANDARD DRAWING NO. 2465.

ROADWAY EASEMENTS TO PREVENT ANY EXCAVATED MATERIAL BEING WASHED DOWN THE STREET OR INTO ANY PUBLIC DRAINAGE FACILITY.

10. REMOVALS SHALL BE DISPOSED OF OFF-SITE AND SHALL BE THE RESPONSIBILITY OF THE CONTRACTOR.

11. CONTRACTOR SHALL DISPOSE OF ALL UNSUITABLE MATERIAL IN AN ENVIRONMENTALLY ACCEPT—ABLE MANNER AT A LOCATION ACCEPTABLE TO THE PROJECT MANAGER. THERE WILL BE NO DIRECT COMPENSATION FOR THIS WORK.

12. CONTRACTOR SHALL CONDUCT ALL WORK IN A MANNER WHICH WILL MINIMIZE INTEFERENCE WITH LOCAL TRAFFIC.

13. ALL EXISTING SIGNS, MARKERS, DELINEATORS, ETC. WITHIN THE CONSTRUCTION LIMITS SHALL BE REMOVED, STORED, AND RE-SET BY THE CONTRACTOR.

14. IF CULTURAL RESOURCES, SUCH AS HISTORIC OR PRE-HISTORIC ARTIFACTS, OR HUMAN REMAINS ARE DISCOVERED DURING EXCAVATION OR CONSTRUCTION, WORK SHALL CEASE AND THE CONSTRUCTION ENGINEER SHALL NOTIFY THE COUNTY OFFICE OF THE MEDICAL EXAMINER AT 272-3053. IF THE MEDICAL EXAMINER DETERMINES THAT HUMAN REMAINS ARE NOT PRESENT, THE CONSTRUCTION ENGINEER SHALL NOTIFY THE STATE HISTORIC PRESERVATION OFFICER (SHPO) AT 827-6320.

15. IF OBJECTS OF HISTORICAL, ARCHEOLOGICAL, PALEONTOLOGICAL, OR OTHER OBJECTS OF ANTIQUITY ARE ENCOUNTERED, CONTRACTOR SHALL CEASE OPERATIONS AND IMMEDIATELY NOTIFY OWNER AND PROJECT ENGINEER.

#### CITY OF ALBUQUERQUE EROSION AND SEDIMENT CONTROL NOTES:

1. ALL EROSION AND SEDIMENT CONTROL (ESC) WORK ON THESE PLANS, EXCEPT AS OTHERWISE STATED OR PROVIDED HEREON SHALL BE PERMITTED, CONSTRUCTED, INSPECTED, AND MAINTAINED IN ACCORDANCE WITH:

1.1. THE CITY ORDINANCE § 14-5-2-11, THE ESC ORDINANCE,

1.2. THE EPA'S 2022 CONSTRUCTION GENERAL PERMIT (CGP), AND 1.3. THE CITY OF ALBUQUERQUE CONSTRUCTION BMP MANUAL.

2. ALL BMP'S MUST BE INSTALLED PRIOR TO BEGINNING ANY EARTH MOVING ACTIVITIES EXCEPT AS SPECIFIED HEREON IN THE PHASING PLAN. CONSTRUCTION OF EARTHEN BMP'S SUCH AS SEDIMENT TRAPS, SEDIMENT BASINS, AND DIVERSION BERMS SHALL BE COMPLETED AND INSPECTED PRIOR TO ANY OTHER CONSTRUCTION OR EARTHWORK. SELF-INSPECTION IS REQUIRED AFTER INSTALLATION OF THE BMPS AND PRIOR TO BEGINNING CONSTRUCTION.

3. SELF-INSPECTIONS - IN ACCORDANCE WITH CITY ORDINANCE § 14-5-2-11(C)(1), "AT A MINIMUM A ROUTINE SELF-INSPECTION IS REQUIRED TO REVIEW THE PROJECT FOR COMPLIANCE WITH THE CONSTRUCTION GENERAL PERMIT ONCE EVERY 14 DAYS AND AFTER ANY PRECIPITATION EVENT OF 1/4 INCH OR GREATER UNTIL THE SITE. CONSTRUCTION HAS BEEN COMPLETED AND THE SITE DETERMINED AS STABILIZED BY THE CITY. REPORTS OF THESE INSPECTIONS SHALL BE KEPT BY THE PERSON OR ENTITY AUTHORIZED TO DIRECT THE CONSTRUCTION ACTIVITIES ON THE SITE AND MADE AVAILABLE UPON REQUEST.

4. CORRECTIVE ACTION REPORTS MUST BE KEPT BY THE PERSON OR ENTITY AUTHORIZED TO DIRECT THE CONSTRUCTION ACTIVITIES ON THE SITE AND MADE AVAILABLE UPON REQUEST.

5. FINAL STABILIZATION AND NOTICE OF TERMINATION (NOT) - IN ACCORDANCE WITH CITY ORDINANCE § 14-5-2-11(C)(1), SELF-INSPECTIONS MUST CONTINUE UNTIL THE SITE IS "DETERMINED AS STABILIZED BY THE CITY." THE PROPERTY OWNER/OPERATOR IS RESPONSIBLE FOR DETERMINING WHEN THE "CONDITIONS FOR TERMINATING CGP COVERAGE" PER CGP PART 8.2 ARE SATISFIED AND THEN FOR FILING THEIR NOTICE OF TERMINATION (NOT) WITH THE EPA. EACH OPERATOR MAY TERMINATE CGP COVERAGE ONLY IF ONE OR MORE OF THE CONDITIONS IN PART 8.2.1, 8.2.2, OR 8.2.3 HAS OCCURRED. AFTER FILING THE NOT WITH THE EPA, THE PROPERTY OWNER IS RESPONSIBLE FOR REQUESTING A DETERMINATION OF STABILIZATION FROM THE CITY.

6. WHEN DOING WORK IN THE CITY RIGHT—OF—WAY (E.G. SIDEWALK, DRIVE PADS, UTILITIES, ETC.) PREVENT DIRT FROM GETTING INTO THE STREET. IF DIRT IS PRESENT IN THE STREET, THE STREET SHOULD BE SWEPT DAILY OR PRIOR TO A RAIN EVENT OR CONTRACTOR INDUCED WATER EVENT (E.G. CURB CUT OR WATER TEST).

7. WHEN INSTALLING UTILITIES BEHIND THE CURB, THE EXCAVATED DIRT SHOULD NOT BE PLACED IN THE STREET. WHEN CUTTING THE STREET FOR UTILITIES THE DIRT SHALL BE PLACED ON THE UPHILL SIDE OF THE STREET CUT AND THE AREA SWEPT AFTER THE WORK IS COMPLETE. A WATTLE OR MULCH SOCK MAY BE PLACED AT THE TOE OF THE EXCAVATED DIRT PILE IF SITE CONSTRAINTS DO NOT ALLOW PLACING THE EXCAVATED DIRT ON THE UPHILL SIDE OF THE STREET CUT.

8. ESC PLANS MUST SHOW LONGITUDINAL STREET SLOPE AND STREET NAMES. ON STREETS WHERE THE LONGITUDINAL SLOPE IS STEEPER THAN 2.5%, WATTLES/MULCH SOCKS OR J-HOOD SILT FENCE SHALL BE SHOWN IN THE FRONT YARD SWALE OR ON THE SIDE OF THE STREET.

#### MARTIN/MARTIN, INC. GRADING NOTES:

1. ALL NEWLY CONSTRUCTED OR ALTERATIONS OF ACCESSIBILITY ROUTES (WALKS, RAMPS, ENTRANCES, ETC.) SHALL COMPLY WITH THE RULES AND REGULATIONS SET FORTH BY ADA, ADAAG, CITY, STATE, FEDERAL OR JURISDICTION HAVING AUTHORITY, INCLUDING BUT NOT LIMITED TO: 5% MAXIMUM GRADE ON WALKS WITHOUT HANDRAILS, 8.33% MAXIMUM GRADE ON WALKS WITH HANDRAILS AND LEVEL LANDINGS (MAXIMUM 2% COMPOSITE SLOPE), 2% MAXIMUM CROSS SLOPE ON WALKS AND 2% MAXIMUM COMPOSITE SLOPE IN ACCESSIBLE PARKING/LOADING AREAS. NO TOLERANCE REGARDING MAXIMUM SLOPES WILL BE ALLOWED. DURING CONSTRUCTION, CONTRACTOR SHALL COORDINATE AS NECESSARY WITH OWNER, DEVELOPER, ENGINEER, ARCHITECT, OR DESIGNATED OFFICIAL IF RULES AND REGULATIONS OF ACCESSIBILITY ROUTES CAN NOT BE MET. IN ADDITION, OWNER IS ADVISED THAT REGULAR MAINTENANCE PROGRAMS SHOULD BE IMPLEMENTED AFTER CONSTRUCTION TO KEEP EXISTING ROUTES SAFE, USABLE, AND ADA COMPLIANT.

ARE SHOWN TO THE EXTENT KNOWN. IT IS THE RESPONSIBILITY OF THE CONTRACTOR TO FIELD VERIFY EXISTING GRADE CONDITIONS AT THE LIMITS OF CONSTRUCTION AND AT LOCATIONS THAT INTERFACE WITH EXISTING OR PROPOSED STRUCTURES AND NOTIFY THE ENGINEER OF ANY DISCREPANCIES THAT CONTRADICT THE ENGINEERS INTENT FOR DRAINAGE PATTERNS, MAXIMUM AND MINIMUM SLOPES, AND PROPOSED ELEVATIONS AS SHOWN ON THE PLAN. THE ENGINEER WILL NOT BE LIABLE FOR ANY COSTS ASSOCIATED WITH CHANGES TO THE DESIGN WITHOUT PROPER NOTIFICATION.

3. PROPOSED CONTOURS AND SPOT ELEVATIONS AS SHOWN HEREIN ARE DEFINED AS FINISHED ELEVATION AFTER PAVING, LANDSCAPING, ETC. CONTRACTOR SHALL COORDINATE WITH GEOTECH FOR PAVEMENT THICKNESS AND LANDSCAPE FOR THICKNESS OF TOPSOIL, SOD AND LANDSCAPE MATERIALS.

ALL SPOTS ARE TO FLOWLINE UNLESS OTHERWISE NOTED. FG = FINISHED GRADE, FF = FINISH FLOOR, TOF = TOP OF FOUNDATION, HP = HIGH POINT, LP = LOW POINT, TOW = TOP OF WALL [FINISHED GRADE AT BACK OF WALL], BOW = BOTTOM OF WALL [FINISHED GRADE AT FACE OF WALL], GB = GRADE BREAK, FL = FLOWLINE, TOC = TOP OF CURB.

4. TEMPORARY CUT/FILL SLOPES SHALL NOT EXCEED A STEEPNESS OF [1:1] (H:V). PERMANENT SLOPES SHALL NOT EXCEED [4:1] (H:V) [UNLESS NOTED OTHERWISE] IN AREAS TO BE SEEDED OR SODDED.

5. CONTRACTOR SHALL ADJUST ALL EXISTING AND PROPOSED MANHOLE RIMS, VALVE BOXES, ETC. TO MATCH FINAL

#### MARTIN/MARTIN, INC. GENERAL NOTES:

IN ADDITION TO THE CITY OF ALBUQUERQUE STANDARD NOTES, THE FOLLOWING SHALL APPLY:

THE CONTRACTOR SHALL HAVE ONE [1] SIGNED COPY OF PLANS APPROVED BY THE CITY OF ALBUQUERQUE AND ONE COPY OF THE APPROPRIATE DESIGN AND CONSTRUCTION STANDARDS AND SPECIFICATIONS ON THE JOB SITE AT ALL

THE CONTRACTOR SHALL BE SOLELY AND COMPLETELY RESPONSIBLE FOR CONDITIONS AT AND ADJACENT TO THE JOB SITE, INCLUDING, BUT NOT LIMITED TO, SAFETY OF ALL PERSONS AND PROPERTY DURING PERFORMANCE OF THE WORK, TRENCH EXCAVATION AND SHORING, TRAFFIC CONTROL AND SECURITY. THIS REQUIREMENT SHALL APPLY CONTINUOUSLY AND NOT BE LIMITED TO NORMAL WORKING HOURS.

3. THE CITY OF ALBUQUERQUE/OWNER/ENGINEER CONSTRUCTION REVIEW OF THE CONTRACTOR'S PERFORMANCE IS NOT INTENDED TO INCLUDE REVIEW OF THE ADEQUACY OF THE CONTRACTOR'S SAFETY MEASURES IN, ON OR NEAR THE CONSTRUCTION SITE.

4. ALL TRENCHES SHALL BE ADEQUATELY SUPPORTED AND THE SAFETY OF WORKERS PROVIDED FOR AS REQUIRED BY THE MOST RECENT OCCUPATIONAL SAFETY AND HEALTH ADMINISTRATION [OSHA] "SAFETY AND HEALTH REGULATIONS FOR CONSTRUCTION." THESE REGULATIONS ARE DESCRIBED IN SUBPART P, PART 1926 OF THE CODE OF FEDERAL REGULATIONS. SHEETING AND SHORING SHALL BE UTILIZED WHERE NECESSARY TO PREVENT ANY EXCESSIVE WIDENING OR SLOUGHING OF THE TRENCH WHICH MAY BE DETRIMENTAL TO HUMAN SAFETY, TO THE PIPE BEING PLACED, OR TO ANY EXISTING SITE IMPROVEMENTS OR STRUCTURES. THE CONTRACTOR MAY BE REQUIRED TO USE AN APPROVED PILING INSTEAD OF SHEETING AND SHORING.

CONTRACTOR SHALL OBTAIN ALL PERMITS FOR STREET CUTS, UTILITY INTERRUPTIONS AND TRAFFIC CONTROL

AT LEAST FIVE [5] WORKING DAYS PRIOR TO THE BEGINNING OF CONSTRUCTION, A TRAFFIC CONTROL PLAN SHALL BE SUBMITTED TO THE CITY OF ALBUQUERQUE. THE TRAFFIC CONTROL PLAN SHALL BE PREPARED BY A CERTIFIED TRAFFIC CONTROL SUPERVISOR AND SHALL BE IN CONFORMANCE WITH THE MANUAL ON UNIFORM TRAFFIC CONTROL DEVICES. NO WORK SHALL BEGIN UNTIL ALL TRAFFIC CONTROL DEVICES HAVE BEEN PLACED IN ACCORDANCE WITH THE PLAN. THE CONTRACTOR SHALL CONTINUOUSLY MAINTAIN THE TRAFFIC CONTROL DEVICES FOR THE ENTIRE DURATION OF THE PROJECT OR UNTIL THE ROADWAY HAS BEEN OPENED AND THE PERMANENT TRAFFIC CONTROL DEVICES HAVE BEEN INSTALLED.

ALL TRENCH BACKFILL AND SUBGRADE PREPARATION SHALL BE TESTED TO ENSURE COMPLIANCE WITH CITY OF ALBUQUERQUE STANDARDS AND SHALL BE TESTED AT CITY OF ALBUQUERQUE REQUIRED FREQUENCIES BY A CITY OF ALBUQUERQUE APPROVED PRIVATE SOILS TESTING FIRM. TEST RESULTS SHALL BE SUBMITTED TO, REVIEWED, AND APPROVED BY, THE CITY OF ALBUQUERQUE ENGINEERING DIVISION PRIOR TO INSTALLING BASE COURSE, ASPHALT OR CONCRETE ON PREPARED SUBGRADE. ALL BASE COURSE DENSITY SHALL ALSO BE TESTED BY THE PRIVATE SOILS FIRM AT CITY OF ALBUQUERQUE REQUIRED FREQUENCIES TO ENSURE COMPLIANCE WITH CITY OF ALBUQUERQUE REQUIREMENTS. BASE COURSE TEST RESULTS SHALL ALSO BE APPROVED BY THE CITY OF ALBUQUERQUE ENGINEERING DIVISION PRIOR TO INSTALLING PAVEMENT. ALL CONCRETE AND ASPHALT PLACED SHALL BE TESTED IN ACCORDANCE WITH CITY OF ALBUQUERQUE MINIMUM MATERIALS TESTING STANDARDS. TEST RESULTS SHALL BE REVIEWED AND APPROVED BY THE CITY OF ALBUQUERQUE ENGINEERING DIVISION PRIOR TO INITIATION OF THE REQUIRED [2] YEAR WARRANTY PERIOD.

8. CONTRACTOR SHALL CONFORM TO ALL FEDERAL, STATE AND LOCAL HEALTH AND SAFETY RULES AND REGULATIONS.

THE CONTRACTOR SHALL BE RESPONSIBLE FOR PROTECTING ALL UTILITIES DURING CONSTRUCTION AND FOR COORDINATING WITH THE APPROPRIATE UTILITY COMPANY FOR ANY UTILITY CROSSINGS REQUIRED. REPAIR OF DAMAGED UTILITIES SHALL BE AT THE CONTRACTORS EXPENSE, INCLUDING BUT NOT LIMITED TO UNKNOWN UNDERGROUND UTILITIES.

10. EXISTING FENCES, TREES, SIDEWALKS, CURBS AND GUTTERS, LANDSCAPING, STRUCTURES, AND IMPROVEMENTS DESTROYED, DAMAGED OR REMOVED DUE TO CONSTRUCTION OF THIS PROJECT SHALL BE REPLACED OR RESTORED IN LIKE KIND AT THE CONTRACTOR'S EXPENSE, UNLESS OTHERWISE INDICATED ON THESE PLANS.

11. THE CONTRACTOR SHALL BE SOLELY RESPONSIBLE FOR MAINTAINING REASONABLE ACCESS TO AND FROM ALL OF THE ADJACENT PROPERTIES THROUGHOUT THE COURSE OF THE WORK. THE CONTRACTOR SHALL BE REQUIRED TO MEET (INDIVIDUALLY OR COLLECTIVELY) WITH ALL ADJACENT PROPERTY OWNERS WHO'S DRIVEWAY ACCESS WILL BE AFFECTED BY THE WORK. AS CONSTRUCTION CONDITIONS CHANGE AND THE WORK PROGRESSES, THE CONTRACTOR SHALL BE REQUIRED TO PERIODICALLY UPDATE THOSE PROPERTY OWNERS SO THAT THEY ARE KEPT INFORMED ABOUT THEIR ACCESS.

12. THE CONTRACTOR SHALL BE RESPONSIBLE FOR REMOVING STORM RUNOFF AND ANY GROUNDWATER ENCOUNTERED DURING THE CONSTRUCTION OF ANY PORTION OF THIS PROJECT. GROUNDWATER SHALL BE PUMPED, PIPED, REMOVED AND DISPOSED OF IN A MANNER WHICH DOES NOT CAUSE FLOODING OF EXISTING STREETS NOR EROSION ON ABUTTING PROPERTIES IN ORDER TO CONSTRUCT THE IMPROVEMENTS SHOWN ON THESE PLANS. NO CONCRETE SHALL BE PLACED WHERE GROUNDWATER IS VISIBLE OR UNTIL THE GROUNDWATER TABLE HAS BEEN LOWERED BELOW THE PROPOSED IMPROVEMENTS. ANY UNSTABLE AREAS, AS A RESULT OF GROUNDWATER, ENCOUNTERED DURING THE CONSTRUCTION OF THE PROPOSED IMPROVEMENTS SHALL BE STABILIZED AS AGREED UPON BY THE CONTRACTOR, THE CITY OF ALBUQUERQUE, AND THE GEOTECHNICAL ENGINEER AT THE TIME OF OCCURRENCE.

13. THE CONTRACTOR IS RESPONSIBLE FOR FIELD LOCATING AND VERIFYING ELEVATIONS OF ALL EXISTING SEWER MAINS. WATER MAINS, CURBS, GUTTERS AND OTHER UTILITIES AT THE POINT OF CONNECTION SHOWN ON THE PLANS, AND AT ANY UTILITY CROSSINGS PRIOR TO INSTALLING ANY OF THE NEW IMPROVEMENTS. IF A CONFLICT EXISTS AND/OR A DESIGN MODIFICATION IS REQUIRED. THE CONTRACTOR SHALL COORDINATE WITH THE ENGINEER TO MODIFY THE DESIGN.

14. PRIOR TO THE COMMENCEMENT OF ANY CONSTRUCTION, THE CONTRACTOR SHALL CONTACT ALL UTILITIES TO COORDINATE SCHEDULES.

15. CONTRACTOR SHALL NOTIFY ALL BUSINESSES/RESIDENTS IN WRITING 48 HOURS PRIOR TO ANY SHUT-OFF IN SERVICE. THE NOTICES MUST HAVE CONTRACTOR'S PHONE NUMBER AND NAME OF CONTACT PERSON. AND EMERGENCY PHONE NUMBER FOR AFTER HOURS CALLS. ALL SHUT OFFS MUST BE APPROVED BY THE CITY OF ALBUQUERQUE UTILITY DIVISION, AND CITY OF ALBUQUERQUE VALVES AND APPURTENANCES SHALL BE OPERATED BY ALBUQUERQUE PERSONNEL, UNLESS WRITTEN PERMISSION IS GIVEN OTHERWISE.

16. ALL PUBLIC IMPROVEMENT WORK, INCLUDING CORRECTION WORK, SHALL BE INSPECTED BY A CITY OF ALBUQUERQUE REPRESENTATIVE WHO SHALL HAVE THE AUTHORITY TO HALT CONSTRUCTION WHEN STANDARD CONSTRUCTION PRACTICES ARE NOT BEING ADHERED TO. THE CITY OF ALBUQUERQUE RESERVES THE RIGHT TO ACCEPT OR REJECT ANY SUCH MATERIALS AND WORKMANSHIP THAT DOES NOT CONFORM TO ITS ENGINEERING CODE OF STANDARDS AND SPECIFICATIONS FOR THE DESIGN AND CONSTRUCTION OF PUBLIC IMPROVEMENTS. CONTRACTOR IS RESPONSIBLE FOR BEING AWARE OF, NOTIFYING, COORDINATING AND SCHEDULING ALL INSPECTIONS REQUIRED FOR FINAL APPROVALS AND PROJECT ACCEPTANCE.


17. THE CONTRACTOR SHALL NOT OPERATE ANY CONSTRUCTION VEHICLES NOR PERFORM ANY CONSTRUCTION OPERATIONS BEFORE 7 AM OR AFTER 6 PM, MONDAY THROUGH FRIDAY OR BEFORE 8 AM AND AFTER 5 PM ON SATURDAYS. NO WORK WILL BE ALLOWED ON SUNDAYS OR HOLIDAYS. THE CITY OF ALBUQUERQUE RESERVES THE RIGHT TO FURTHER RESTRICT OR MODIFY THESE HOURS OF OPERATION IF CONDITIONS WARRANT.

18. THE CONTRACTOR SHALL WARRANT ALL WORK TO BE FREE FROM DEFECTS IN WORKMANSHIP AND MATERIALS FOR A PERIOD OF [1]-YEAR FROM THE DATE OF ACCEPTANCE INTO THE WARRANTY PERIOD OF ALL CONSTRUCTION CALLED FOR BY THE PUBLIC IMPROVEMENTS AGREEMENT WITH THE CITY OF ALBUQUERQUE.

19. DURING CONSTRUCTION AND UPON COMPLETION OF CONSTRUCTION, THE SITE SHALL BE CLEANED AND RESTORED TO A CONDITION EQUAL TO, OR BETTER THAN, THAT WHICH EXISTED BEFORE CONSTRUCTION

20. THE OWNER/DEVELOPER AND/OR THEIR ASSIGNS IS HEREBY NOTIFIED THAT IT IS TYPICAL AND LIKELY THAT SOME MOVEMENT OF THE SURFACE GRADES WILL OCCUR OVER TIME DUE TO VARIOUS FACTORS THAT ARE NOT IN CONTROL OF THE DESIGNERS. THUS, A ROUTINE AND DILIGENT MAINTENANCE PROGRAM IS REQUIRED TO MAINTAIN THE PROPER GRADING AND DRAINAGE THROUGHOUT THE PROJECT.



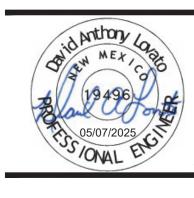

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Sheet Number:

SHEET 2 OF 10

City of Albuquerque

**Planning Department** 

**Development Review Services** 

**HYDROLOGY SECTION** 

**APPROVED** 

THE APPROVAL OF THESE PLANS/REPORTS SHALL NOT BE CONSTRUED TO PERMIT VIOLATIONS OF ANY CITY ORDINANCE OR STATE LAW, AND

SHALL NOT PREVENT THE CITY OF ALBUQUERQUE FROM REQUIRING

CORRECTIONS FOR ERRORS OR DIMENSIONS IN PLANS, SPECIFICATIONS, OR CONSTRUCTION DOCUMENTS. SUCH APPROVED PLANS/REPORTS SHALL

NOT BE CHANGED, MODIFIED OR ALTERED WITHOUT AUTHORIZATION. THE APPROVAL OF THESE PLANS/REPORTS SHALL EXPIRE TWO (2)

YEARS AFTER THE APPROVAL DATE IF NO BUILDING PERMIT HAS BEEN PULLED ON THE DEVELOPMENT.

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HydroTrans #

SECTION LINE EASEMENT \_\_ \_ \_ \_ \_ \_ \_ RETAINING WALL CURB & GUTTER **ASPHALT** CONCRETE/ 1. A. A. A. A. A. A. A. SIDEWALK — — — *— 5750*— — — — CONTOURS ----ST----STORM SEWER ST STORM MANHOLE STORM INLET FLARED END SECTION SANITARY SEWER ----SS-----S SANITARY MANHOLE WATER LINE --------WATER VALVE FIRE HYDRANT WATER METER IRRIGATION LINE -----IRR IRRIGATION CONTROL OVERHEAD ELECTRIC ----OHE----ELECTRIC LINE ----E---- $\Diamond$ LIGHT POLE POWER POLE ELECTRIC METER ELEC ----TELEPHONE PEDESTAL CABLE TV ----------SIGN DECIDUOUS TREE EVERGREEN TREE BUSH/SHRUB ------GAS LINE -----DRIVE DESCRIPTIONS DRIVE

**LEGEND** 

PROPERTY LINE

RIGHT-OF-WAY LINE

DEMOLITION

EXISTING

#### NOTES:

- 1. SEE SHEET C1.00 FOR LEGEND, BASIS OF BEARING, AND
- ABBREVIATIONS LIST. SEE SHEET C1.01 FOR ADDITIONAL NOTES. 2. THE ENGINEER ASSUMES NO RESPONSIBILITY FOR BURIED UTILITIES. THE CONTRACTOR IS RESPONSIBLE FOR LOCATING AND PROTECTING ALL UTILITIES PRIOR TO AND DURING CONSTRUCTION.
- 3. CONTRACTOR SHALL COORDINATE ALL DEMOLITION ACTIVITIES WITH THE HOA. 4. EXISTING SIDEWALK, CURB, AND GUTTER CONCRETE SHALL BE
- PROTECTED AT DEMOLITION LIMITS.
- 5. ALL MATERIAL TO BE LEGALLY DISPOSED OF OFFSITE. 6. ALL LANDSCAPING DISTURBED DURING CONSTRUCTION SHALL BE REPLACED IN KIND. CONTRACTOR SHALL PROTECT EXISTING TREES, SHRUBS, AND LANDSCAPING OUTSIDE OF PROJECT LIMITS.
- STRUCTURES NOT DESIGNATED FOR REMOVAL SHALL BE ADJUSTED TO FINAL FINISHED GRADE. 8. ANY DAMAGE TO THE EXISTING PUBLIC ROADWAYS SHALL BE REPAIRED TO CITY OF ALBUQUERQUE STANDARDS.

7. ALL EXISTING MANHOLES, WATER VALVES, AND EXISTING UTILITY


9. CONTRACTOR SHALL PROVIDE TRAFFIC CONTROL FOR ALL WORK WITHIN THE ROW.

#### **BENCHMARK:**

DESIGNATION = ALBUQUERQUE CONTROL STATION "4\_G20R", ALBUQUERQUE, NM. = 5426.439 US FEET FOUND 3 INCH BRASS TABLET SET IN THE EAST MOST MEDIAN CURB ON THE NORTH MEDIAN NOSE OF THE INTERSECTION OF COMANCHE ROAD NE AND WYOMING BOULEVARD NE.


TBM = 5,426.02 US FEET FOUND MAG NAIL SET IN TOP OF BLOCK WALL AT NORTHEAST PROPERTY CORNER OF SUBJECT PROPERTY.

ALL PROPOSED DESIGN IS BASED ON A SITE SURVEY PROVIDED BY WAYJOHN SURVEYING, INC. DATED JUNE 2024. CONTRACTOR SHALL VERIFY EXISTING CONDITIONS PRIOR TO CONSTRUCTION AND CONTACT ENGINEER IMMEDIATELY OF ANY DISCREPANCIES.

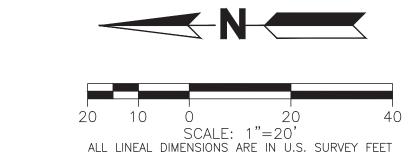

CONTRACTOR SHALL NOTIFY ENGINEER OF ANY DISCREPANCIES WITH THE PROPOSED ELEVATIONS SHOWN IN THESE PLANS. ENGINEER WILL NOT BE LIABLE FOR ANY COST ASSOCIATED WITH CHANGES TO THE DESIGN WITHOUT PROPER NOTIFICATION.

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Sheet Number:

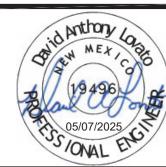SHEET 3 OF 10

- OPERATIONS SHALL BE DISCONTINUED WHEN FUGITIVE DUST SIGNIFICANTLY IMPACTS ADJACENT PROPERTY. IF EARTHWORK IS COMPLETE OR DISCONTINUED AND DUST FROM THE SITE CONTINUES TO CREATE PROBLEMS, THE CONTRACTOR SHALL IMMEDIATELY INSTITUTE MITIGATIVE MEASURES AND SHALL CORRECT DAMAGE TO ADJACENT PROPERTY.
- 5. PERMANENT OR TEMPORARY SOIL STABILIZATION MEASURES SHALL BE APPLIED TO DISTURBED AREAS WITHIN 30 DAYS AFTER FINAL GRADE IS REACHED ON ANY PORTION OF THE SITE. UNLESS SPECIFIED OTHERWISE, TEMPORARY VEGETATION SHALL BE INSTALLED ON ALL DISTURBED AREAS WHERE PERMANENT SURFACE IMPROVEMENTS ARE NOT SCHEDULED FOR INSTALLATION WITHIN THREE MONTHS. TEMPORARY VEGETATION SHALL BE A VIGOROUS, DROUGHT TOLERANT, NATIVE SPECIES MIX. PROJECT SCHEDULING SHOULD TAKE ADVANTAGE OF SPRING OR FALL PLANTING SEASONS FOR NATURAL GERMINATION, BUT SEEDED AREAS SHALL BE IRRIGATED, IF CONDITIONS MERIT. REFER TO THE LANDSCAPE PLAN FOR FINAL LANDSCAPING.
- 6. TEMPORARY FENCES SHALL BE INSTALLED ALONG ALL BOUNDARIES OF THE CONSTRUCTION LIMITS OR PROPERTY LINES AS SHOWN ON THE APPROVED EROSION CONTROL PLAN, TO PREVENT GRADING ON PROPERTY NOT OWNED BY THE OWNER/DEVELOPER. IN ADDITION, THE CITY OF ALBUQUERQUE MAY REQUIRE ADDITIONAL TEMPORARY FENCES IF FIELD CONDITIONS WARRANT.
- 7. THE CONTRACTOR SHALL PREVENT SEDIMENT, DEBRIS AND ALL OTHER POLLUTANTS FROM ENTERING THE STORM SEWER SYSTEM DURING ALL DEMOLITION, EXCAVATION, TRENCHING, GRADING OR OTHER CONSTRUCTION OPERATIONS THAT ARE PART OF THIS PROJECT. THE CONTRACTOR SHALL BE HELD RESPONSIBLE FOR REMEDIATION OF ANY ADVERSE IMPACTS TO ADJACENT WATERWAYS, ROADWAYS, WETLANDS, ETC., RESULTING FROM WORK DONE AS PART OF THIS PROJECT.
- 8. THE CONTRACTOR AND/OR THEIR AUTHORIZED AGENTS SHALL REMOVE ALL SEDIMENT, MUD, CONSTRUCTION DEBRIS, OR OTHER POTENTIAL POLLUTANTS THAT MAY HAVE BEEN INADVERTENTLY DISCHARGED TO, OR ACCUMULATED IN, THE FLOWLINES AND PUBLIC RIGHT-OF-WAY AS A RESULT OF CONSTRUCTION ACTIVITIES ASSOCIATED WITH THIS SITE DEVELOPMENT OR CONSTRUCTION PROJECT.
- 9. THE GRADING CONTRACTOR AND/OR THEIR AUTHORIZED AGENTS SHALL ENSURE THAT ALL LOADS OF CUT AND FILL MATERIAL IMPORTED TO OR EXPORTED FROM THIS SITE SHALL BE PROPERLY COVERED TO PREVENT LOSS OF THE MATERIAL DURING TRANSPORT ON PUBLIC ROADWAYS.
- 10.APPROVED EROSION AND SEDIMENT CONTROL "BEST MANAGEMENT PRACTICES" [BMP] SHALL BE MAINTAINED AND KEPT IN GOOD REPAIR FOR THE DURATION OF THIS PROJECT. AT A MINIMUM, THE CONTRACTOR OR HIS AGENT SHALL INSPECT ALL BMPS WEEKLY AND AFTER SIGNIFICANT PRECIPITATION EVENTS. ALL NECESSARY MAINTENANCE AND REPAIR SHALL BE COMPLETED IN A TIMELY MANNER. ACCUMULATED SEDIMENT AND DEBRIS SHALL BE REMOVED FROM A BMP WHEN THE SEDIMENT LEVEL REACHES ONE HALF THE HEIGHT OF THE BMP OR. AT ANY TIME THAT SEDIMENT OR DEBRIS ADVERSELY IMPACTS THE FUNCTIONING OF THE
- 11.WATER USED IN THE CLEANING OF CONCRETE TRUCK DELIVERY CHUTES SHALL BE DISCHARGED INTO A PREDEFINED, BERMED CONTAINMENT AREA ON THE JOB SITE. THE REQUIRED CONTAINMENT AREA IS TO BE BERMED SO THAT WASH WATER IS TOTALLY CONTAINED. WASH WATER DISCHARGED INTO THE CONTAINMENT AREA SHALL BE ALLOWED TO INFILTRATE OR EVAPORATE. DRIED CONCRETE WASTE SHALL BE REMOVED FROM THE CONTAINMENT AREA AND PROPERLY DISPOSED OF. SHOULD A PREDEFINED BERMED CONTAINMENT AREA NOT BE AVAILABLE DUE TO THE PROJECT SIZE, OR LACK OF AN AREA WITH A SUITABLE GROUND SURFACE FOR ESTABLISHING A CONTAINMENT AREA, PROPER DISPOSAL OF READY MIX WASHOUT AND RINSE OFF WATER AT THE JOB SITE SHALL CONFORM TO THE APPROVED TECHNIQUES AND PRACTICES IDENTIFIED IN THE COLORADO DEPARTMENT OF PUBLIC HEALTH & ENVIRONMENT'S TRAINING VIDEO ENTITLED "BUILDING FOR A CLEANER ENVIRONMENT, READY MIX WASHOUT TRAINING". AND ITS ACCOMPANYING MANUAL ENTITLED, "READY MIX WASHOUT GUIDEBOOK, VEHICLE AND EQUIPMENT WASHOUT AT CONSTRUCTION SITES." THE DIRECT OR INDIRECT DISCHARGE OF WATER CONTAINING WASTE CONCRETE TO THE STORM SEWER SYSTEM IS PROHIBITED. INFORMATION ABOUT, OR COPIES OF THE VIDEO AND TRAINING MANUAL ARE AVAILABLE FROM THE WATER QUALITY CONTROL DIVISION, COLORADO DEPARTMENT OF PUBLIC HEALTH & ENVIRONMENT, 4300 CHERRY CREEK DRIVE SOUTH, DENVER, COLORADO 80222-1530, 303-692-3555

- 2. AN EXCAVATION/CONSTRUCTION PERMIT WILL BE REQUIRED BEFORE BEGINNING ANY WORK WITHIN CITY RIGHT-OF-WAY. AN APPROVED COPY OF THE GRADING AND DRAINAGE PLAN MUST ACCOMPANY THE EXCAVATION/CONSTRUCTION PERMIT REQUEST.
- 3. ALL WORK TO BE PERFORMED WITHIN THE PUBLIC RIGHT-OF-WAY OR EASEMENT SHALL BE CONSTRUCTED IN ACCORDANCE WITH CITY STANDARD SPECIFICATIONS.
- 4. PRIOR TO CONSTRUCTION, THE CONTRACTOR SHALL EXCAVATE AND VERIFY THE HORIZONTAL AND VERTICAL LOCATIONS OF ALL CONSTRUCTIONS TO IDENTIFY A CONFLICT. SHOULD A CONFLICT EXIST, THE CONTRACTOR SHALL NOTIFY THE ENGINEER SO THAT THE CONFLICT CAN BE RESOLVED WITH A MINIMUM OF DELAY.
- 5. BACKFILL COMPACTION SHALL BE ACCORDING TO CITY STANDARD SPECIFICATIONS. THE FACILITY IS TO BE INSPECTED AND ACCEPTED BY THE CITY PRIOR TO OBTAINING A PERMANENT CERTIFICATE OF OCCUPANY.
- 7. MAINTENANCE OF THESE FACILITIES SHALL BE THE RESPONSIBILITY OF THE OWNER OF THE PROPERTY SERVED.

#### PRIVATE DRAINAGAGE FACILITIES WITHIN CITY RIGHT-OF-WAY:

REV. 12/2022

NOTICE TO CONTRACTOR

(SPECIAL ORDER 19 ~ "SO−19")

- 1. BUILD SIDEWALK CULVERT PER COA STD DWG 2236.
- 2. CONTACT STORM MAINTENANCE AT (505) 857-8033 TO SCHEDULE A MEETING PRIOR TO FORMING.
- 3. AN EXCAVATION PERMIT WILL BE REQUIRED BEFORE BEGINNING ANY WORK WITHIN CITY RIGHT-OF-WAY. 4. ALL WORK ON THIS PROJECT SHALL BE PERFORMED IN ACCORDANCE WITH APPLICABLE FEDERAL, STATE AND LOCAL LAWS,
- RULES AND REGULATIONS CONCERNING CONSTRUCTION SAFETY AND HEALTH. 5. TWO WORKING DAYS PRIOR TO ANY EXCAVATION, THE CONTRACTOR MUST CONTACT NEW MEXICO ONE CALL, DIAL "811" [OR (505) 260-1990 FOR THE LOCATION OF EXISTING UTILITIES.
- 6. PRIOR TO CONSTRUCTION, THE CONTRACTOR SHALL EXCAVATE AND VERIFY THE LOCATIONS OF ALL OBSTRUCTIONS. SHOULD A CONFLICT EXIST, THE CONTRACTOR SHALL NOTIFY THE ENGINEER SO THAT THE CONFLICT CAN BE RESOLVED WITH A MINIMUM AMOUNT OF DELAY.
- 7. BACKFILL COMPACTION SHALL BE ACCORDING TO TRAFFIC/STREET USE.
- 8. MAINTENANCE OF THE FACILITY SHALL BE THE RESPONSIBILITY OF THE OWNER OF THE PROPERTY BEING SERVED.
- 9. WORK ON ARTERIAL STREETS MAY BE REQUIRED ON A 24-HOUR BASIS.
- 10. CONTRACTOR MUST CONTACT STORM MAINTENANCE AT (505) 857-8033 TO SCHEDULE A CONSTRUCTION INSPECTION. FOR EXCAVATING AND BARRICADING INSPECTIONS, CONTACT CONSTRUCTION COORDINATION AT 924-3416.

- 1. SEE SHEET C1.00 FOR LEGEND, BASIS OF BEARING, AND ABBREVIATIONS LIST. SEE SHEET C1.01 FOR ADDITIONAL NOTES.
- 2. SEE SHEET C1.01 FOR EROSION CONTROL DETAILS.
- 3. CONTOURS ARE SHOWN AT 0.5' INTERVALS. 4. CONTRACTOR TO VERIFY HORIZONTAL AND VERTICAL ELEVATIONS OF
- MATCH EXISTING LOCATIONS AND EXISTING CURB AND GUTTER AT LEAST TWO WEEKS PRIOR TO CONSTRUCTION. NOTIFY ENGINEER OF ANY DISCREPANCIES GREATER THAN 0.05'.
- 5. PROPOSED CONTOURS AND SPOT ELEVATIONS AS SHOWN HEREIN ARE DEFINED AS FINISHED ELEVATION AFTER PAVING, LANDSCAPING, ETC.
- 6. ALL CONSTRUCTION SHALL BE IN ACCORDANCE WITH THE CITY OF ALBUQUERQUE STANDARDS AND SPECIFICATIONS UNLESS NOTED OTHERWISE.

#### **BENCHMARK:**

City of Albuquerque **Planning Department Development Review Services** HYDROLOGY SECTION

> DESIGNATION = ALBUQUERQUE CONTROL STATION "4\_G20R", ALBUQUERQUE, NM. = 5426.439 US FEET FOUND 3 INCH BRASS TABLET SET IN THE EAST MOST MEDIAN CURB ON THE NORTH MEDIAN NOSE OF THE INTERSECTION OF COMANCHE ROAD NE AND WYOMING BOULEVARD NE. TBM = 5,426.02 US FEET FOUND MAG NAIL SET IN TOP OF BLOCK WALL AT NORTHEAST PROPERTY CORNER OF SUBJECT PROPERTY.


#### **EROSION CONTROL BMP NOTES:**

<u>INITIAL:</u> INSTALL — CF, SSA, CWA

MAINTAIN - CF, SSA, CWA INSTALL - IP

STABILIZATION IS ACHIEVED.

INITIAL BMPS TO BE REMOVED. INTERIM BMPS TO BE REMOVED ONCE FINAL

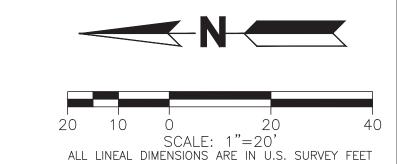

CONTRACTOR SHALL NOTIFY ENGINEER OF ANY DISCREPANCIES WITH THE PROPOSED ELEVATIONS SHOWN IN THESE PLANS. ENGINEER WILL NOT BE LIABLE FOR ANY COST ASSOCIATED WITH CHANGES TO THE DESIGN WITHOUT PROPER NOTIFICATION.

**PROJECT** 

LOCATION

**PROPOSED** 

VICINITY MAP

SCALE: 1"=200

RIGHT-OF-WAY LINE

SECTION LINE

EASEMENT

RETAINING WALL

STORM SEWER

STORM MANHOLE

ROOF DRAIN

INLET

FLARED END SECTION


SIGN

GRADING ARROW

BUSH/SHRUB

DESCRIPTIONS

SPOT ELEVATIONS

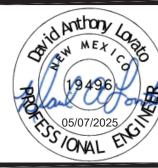


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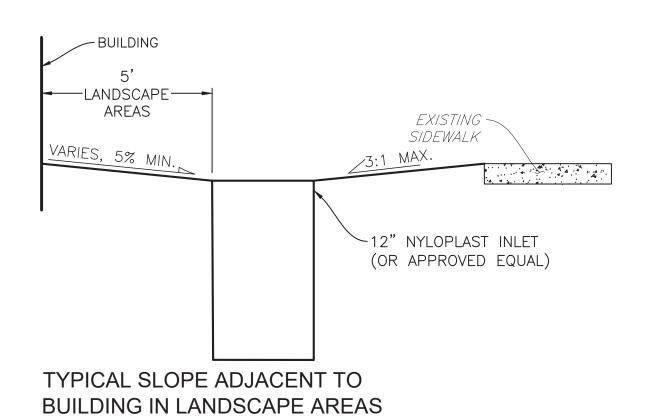
SHEET 4 OF 10







#### NOTES:

- 1. SWALE FOLLOWS GRADE OF EXISTING SIDEWALK AND SHALL BE
- INSTALLED DIRECTLY OVER THE PROPOSED STORM MAIN.
  2. PROTECT EXISTING LIGHTING AND ELECTRICAL UNITS.

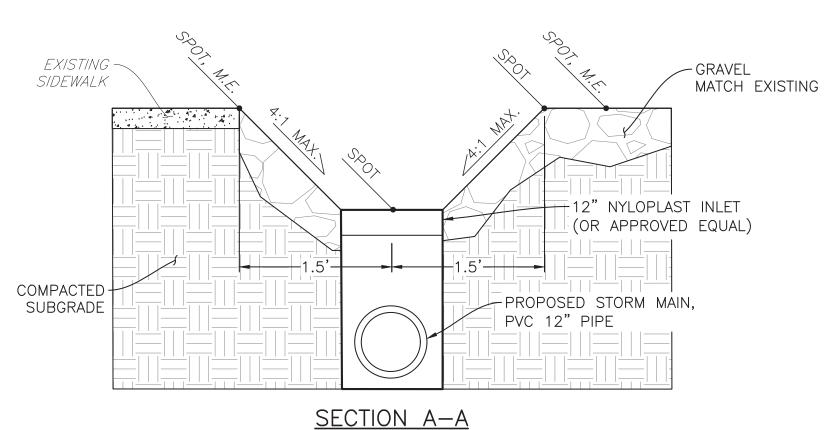

NOT TO SCALE

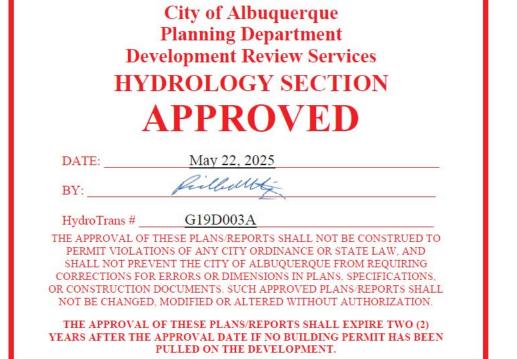

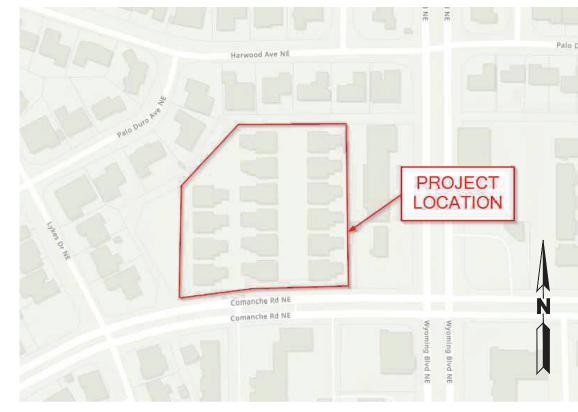

VICINITY MAP SCALE: 1"=200'

#### <u>LEGEND</u>

EXISTING		PROPOSED
	PROPERTY LINE	
	RIGHT-OF-WAY LINE	
	SECTION LINE	
	EASEMENT	
	RETAINING WALL	
	CURB & GUTTER	
	CONTOURS	5750
	STORM SEWER	ST
ST	STORM MANHOLE	0
	ROOF DRAIN	RD
	INLET	
<	FLARED END SECTION	
	SIGN	•
	GRADING ARROW	
	DECIDUOUS TREE	
	EVERGREEN TREE	
	BUSH/SHRUB	
DRIVE	DESCRIPTIONS	DRIVE
ELE	SPOT ELEVATIONS	


### NOTES:

- SEE SHEET C1.00 FOR LEGEND, BASIS OF BEARING, AND ABBREVIATIONS LIST. SEE SHEET C1.01 FOR ADDITIONAL NOTES.
   CONTOURS ARE SHOWN AT 0.5' INTERVALS.
- 3. CONTRACTOR TO VERIFY HORIZONTAL AND VERTICAL ELEVATIONS OF MATCH EXISTING LOCATIONS AND EXISTING CURB AND GUTTER AT LEAST TWO WEEKS PRIOR TO CONSTRUCTION. NOTIFY ENGINEER OF ANY DISCREPANCIES GREATER THAN 0.05'.
- 4. PROPOSED CONTOURS AND SPOT ELEVATIONS AS SHOWN HEREIN ARE DEFINED AS FINISHED ELEVATION AFTER PAVING, LANDSCAPING, ETC.
- 5. ALL CONSTRUCTION SHALL BE IN ACCORDANCE WITH THE CITY OF ALBUQUERQUE STANDARDS AND SPECIFICATIONS UNLESS NOTED OTHERWISE
- 6. CONTRACTOR SHALL CONFIRM DEPTHS OF ALL EXISTING UTILITIES BELOW AREAS TO BE REGRADED TO ENSURE ADEQUATE COVER IS STILL BEING PROVIDED IN FINAL CONDITION. NOTIFY ENGINEER OF ANY DISCREPANCIES.

#### **BENCHMARK:**

DESIGNATION = ALBUQUERQUE CONTROL STATION "4\_G20R", ALBUQUERQUE, NM. = 5426.439 US FEET FOUND 3 INCH BRASS TABLET SET IN THE EAST MOST MEDIAN CURB ON THE NORTH MEDIAN NOSE OF THE INTERSECTION OF COMANCHE ROAD NE AND WYOMING BOULEVARD NE.

TBM = 5,426.02 US FEET FOUND MAG NAIL SET IN TOP OF BLOCK WALL AT NORTHEAST PROPERTY CORNER OF SUBJECT PROPERTY.

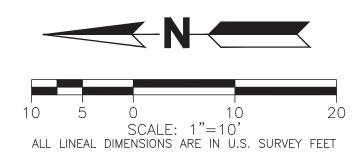


CONTRACTOR SHALL NOTIFY ENGINEER OF ANY DISCREPANCIES WITH THE PROPOSED ELEVATIONS SHOWN IN THESE PLANS. ENGINEER WILL NOT BE LIABLE FOR ANY COST ASSOCIATED WITH CHANGES TO THE DESIGN WITHOUT PROPER NOTIFICATION.

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SHEET 5 OF 10



Not to Scale

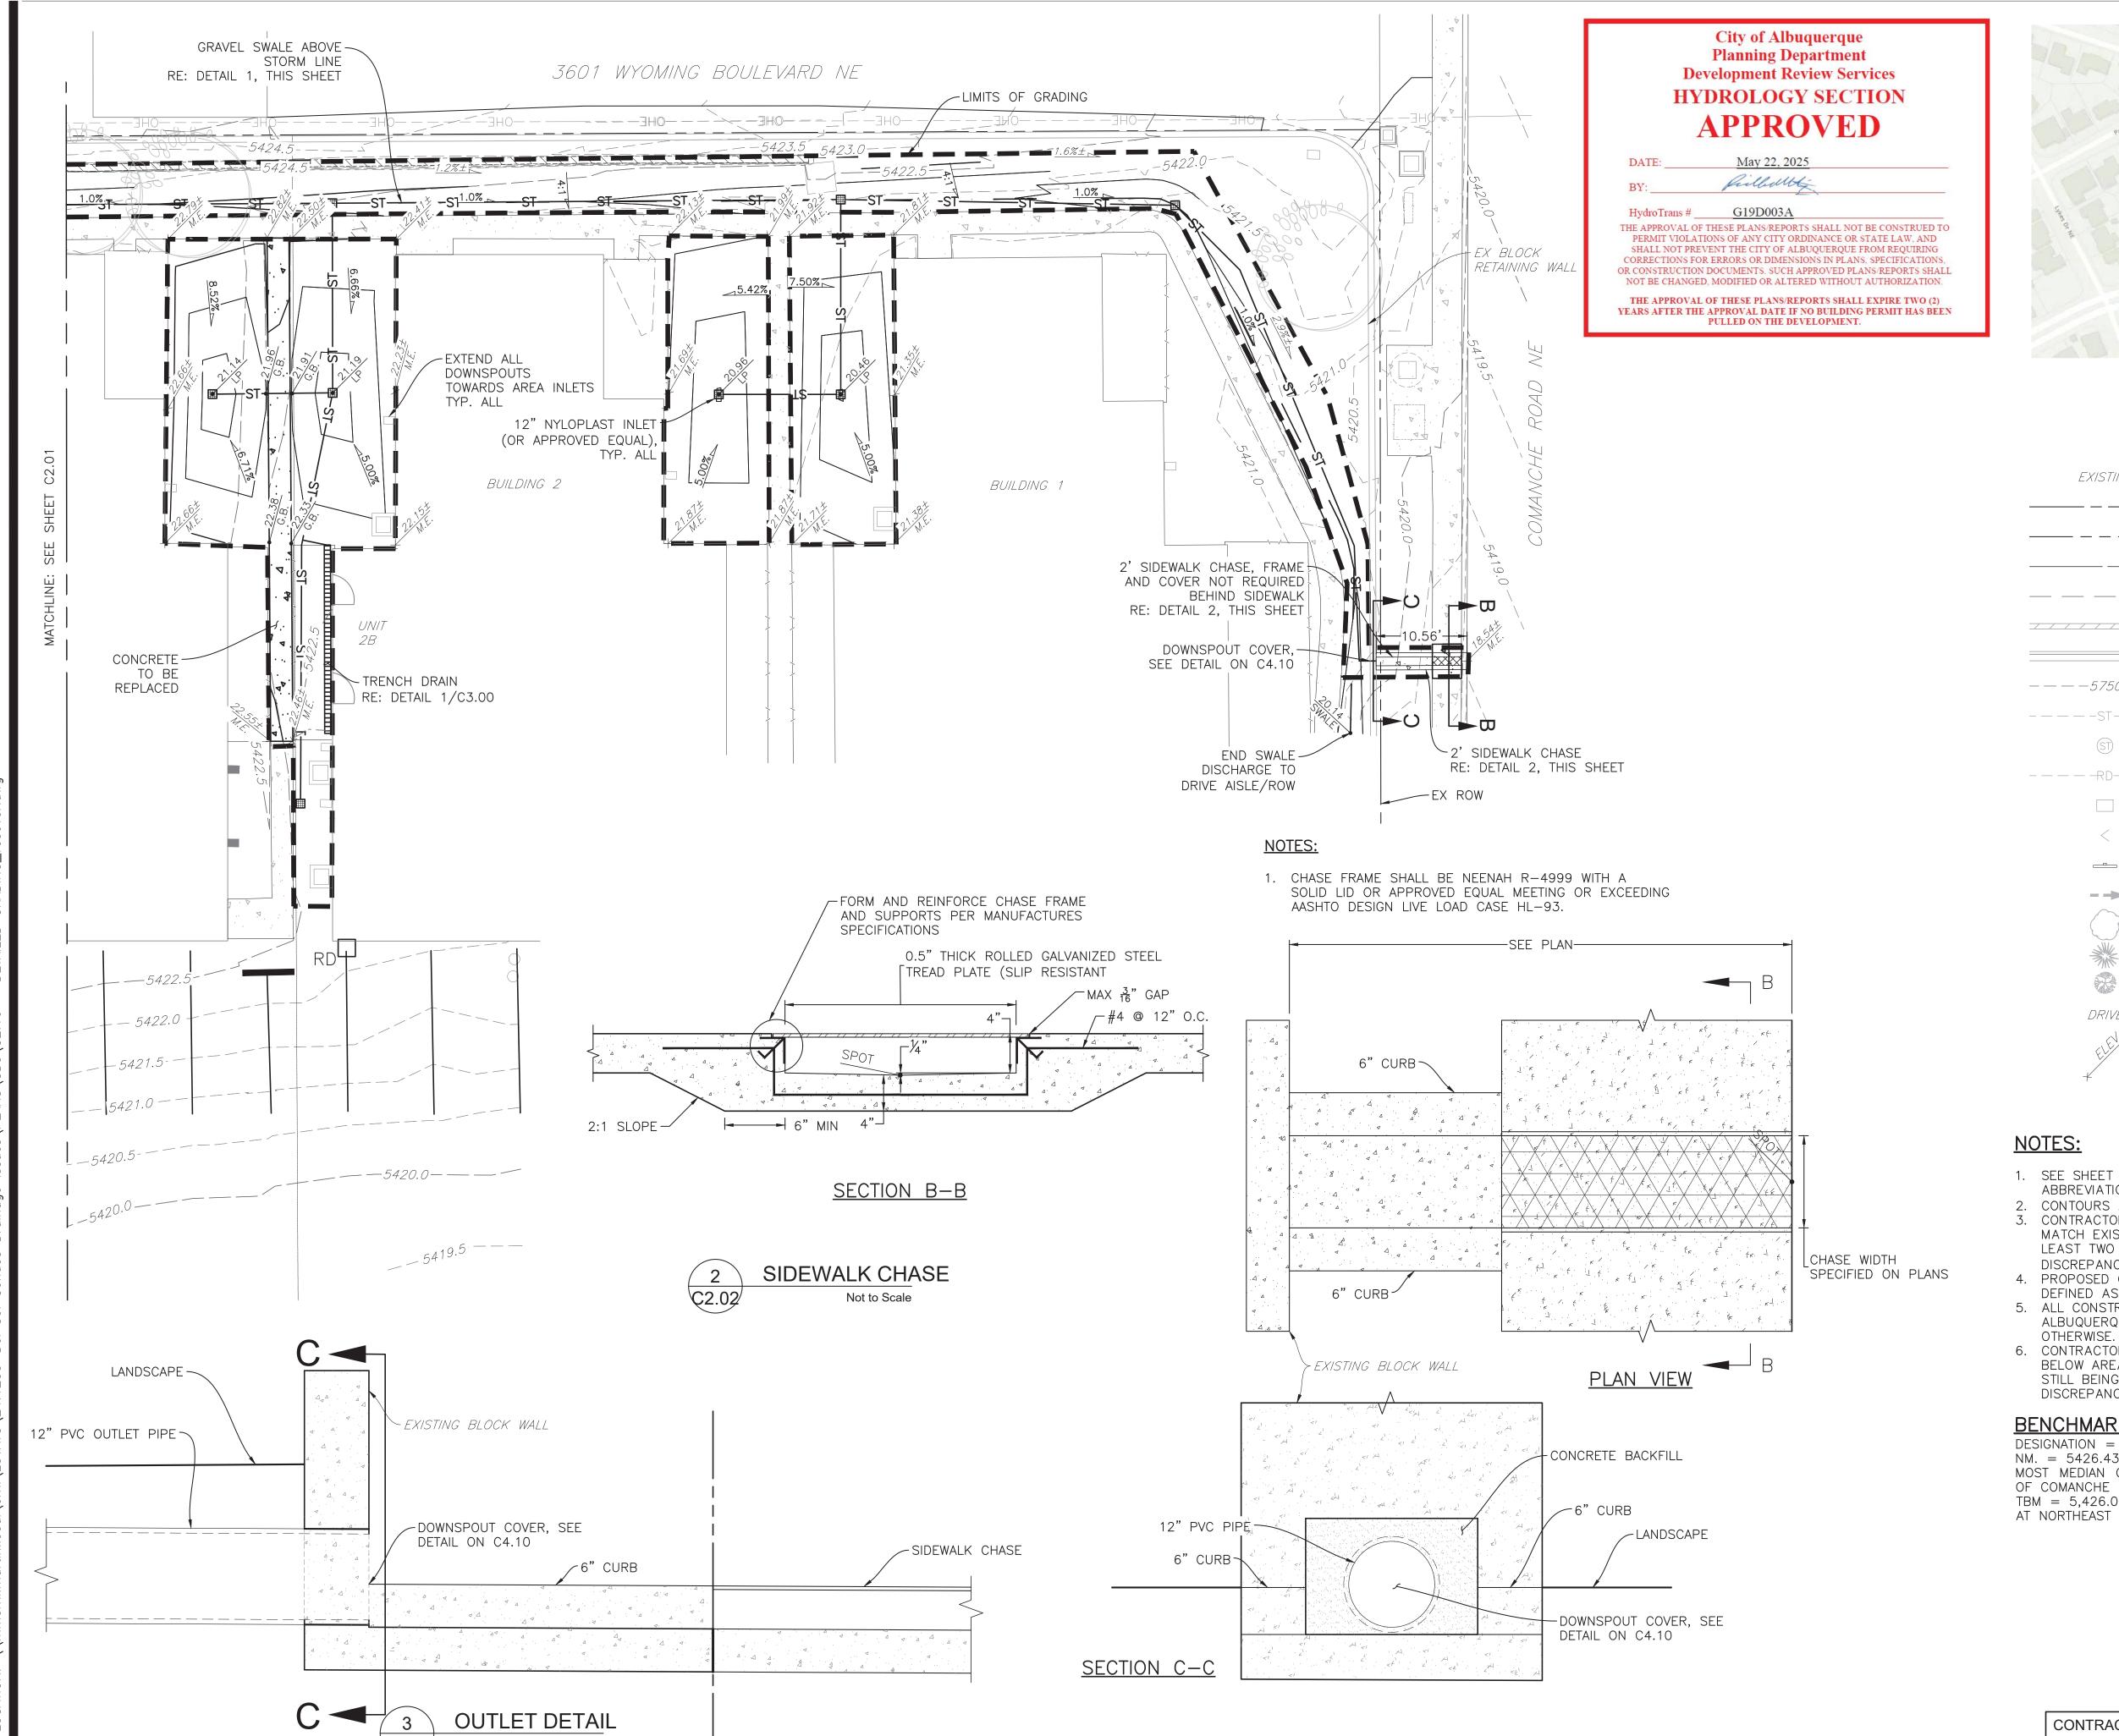

VICINITY MAP SCALE: 1"=200'

#### **LEGEND**


EXISTING		PROPOSED
	PROPERTY LINE	
	RIGHT-OF-WAY LINE	
	SECTION LINE	
	EASEMENT	
	RETAINING WALL	
	CURB & GUTTER	
_ <i> 5750</i>	CONTOURS	5750
ST	STORM SEWER	ST
ST	STORM MANHOLE	0
RD	ROOF DRAIN	RD
	INLET	-
<	FLARED END SECTION	
	SIGN	•
	GRADING ARROW	-
	DECIDUOUS TREE	
	EVERGREEN TREE	
	BUSH/SHRUB	
DRIVE	DESCRIPTIONS	DRIVE
ELEV	SPOT ELEVATIONS	

#### NOTES:


- 1. SEE SHEET C1.00 FOR LEGEND, BASIS OF BEARING, AND
- ABBREVIATIONS LIST. SEE SHEET C1.01 FOR ADDITIONAL NOTES. 2. CONTOURS ARE SHOWN AT 0.5' INTERVALS.
- 3. CONTRACTOR TO VERIFY HORIZONTAL AND VERTICAL ELEVATIONS OF MATCH EXISTING LOCATIONS AND EXISTING CURB AND GUTTER AT LEAST TWO WEEKS PRIOR TO CONSTRUCTION. NOTIFY ENGINEER OF ANY DISCREPANCIES GREATER THAN 0.05'.
- 4. PROPOSED CONTOURS AND SPOT ELEVATIONS AS SHOWN HEREIN ARE
- DEFINED AS FINISHED ELEVATION AFTER PAVING, LANDSCAPING, ETC. 5. ALL CONSTRUCTION SHALL BE IN ACCORDANCE WITH THE CITY OF ALBUQUERQUE STANDARDS AND SPECIFICATIONS UNLESS NOTED
- 6. CONTRACTOR SHALL CONFIRM DEPTHS OF ALL EXISTING UTILITIES BELOW AREAS TO BE REGRADED TO ENSURE ADEQUATE COVER IS STILL BEING PROVIDED IN FINAL CONDITION. NOTIFY ENGINEER OF ANY DISCREPANCIES.

#### **BENCHMARK:**

DESIGNATION = ALBUQUERQUE CONTROL STATION "4\_G20R", ALBUQUERQUE, NM. = 5426.439 US FEET FOUND 3 INCH BRASS TABLET SET IN THE EAST MOST MEDIAN CURB ON THE NORTH MEDIAN NOSE OF THE INTERSECTION OF COMANCHE ROAD NE AND WYOMING BOULEVARD NE. TBM = 5,426.02 US FEET FOUND MAG NAIL SET IN TOP OF BLOCK WALL AT NORTHEAST PROPERTY CORNER OF SUBJECT PROPERTY.

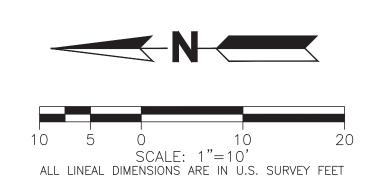


CONTRACTOR SHALL NOTIFY ENGINEER OF ANY DISCREPANCIES WITH THE PROPOSED ELEVATIONS SHOWN IN THESE PLANS. ENGINEER WILL NOT BE LIABLE FOR ANY COST ASSOCIATED WITH CHANGES TO THE DESIGN WITHOUT PROPER NOTIFICATION.

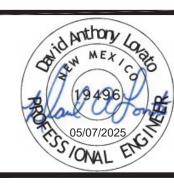


Sheet Number:

SHEET 6 OF 10

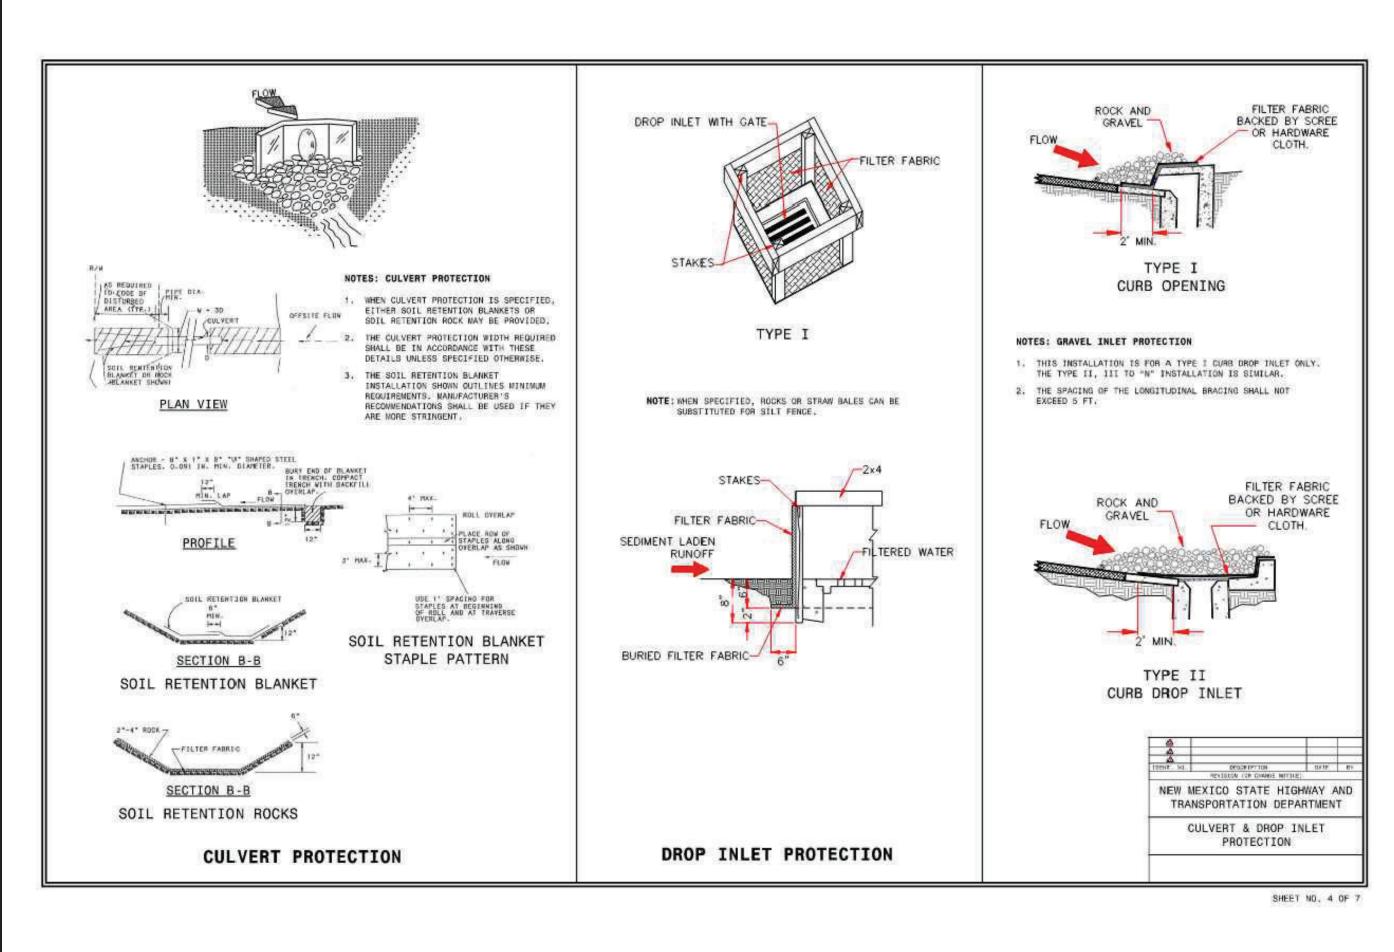

SM-3 Construction Fence (CF)

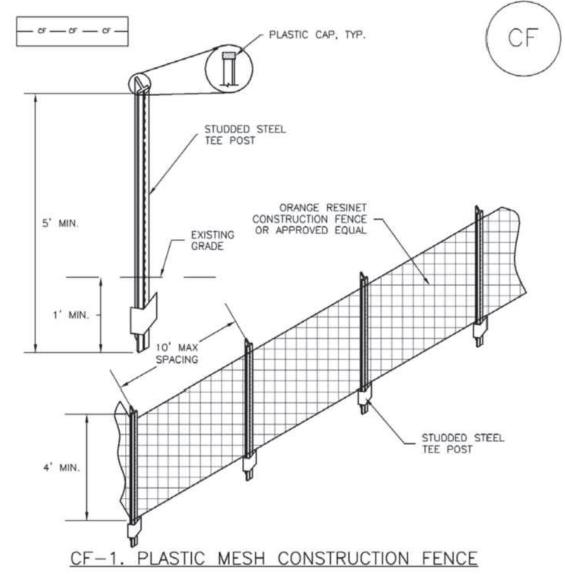

CONSTRUCTION FENCE INSTALLATION NOTES

SEE PLAN VIEW FOR:

 LOCATION OF CONSTRUCTION FENCE.

2. CONSTRUCTION FENCE SHOWN SHALL BE INSTALLED PRIOR TO ANY LAND DISTURBING

3. CONSTRUCTION FENCE SHALL BE COMPOSED OF ORANGE, CONTRACTOR—GRADE MATERIAL THAT IS AT LEAST 4' HIGH. METAL POSTS SHOULD HAVE A PLASTIC CAP FOR SAFETY.

4. STUDDED STEEL TEE POSTS SHALL BE UTILIZED TO SUPPORT THE CONSTRUCTION FENCE. MAXIMUM SPACING FOR STEEL TEE POSTS SHALL BE 10'.

5. CONSTRUCTION FENCE SHALL BE SECURELY FASTENED TO THE TOP, MIDDLE, AND BOTTOM OF EACH POST.

Urban Drainage and Flood Control District Urban Storm Drainage Criteria Manual Volume 3 November 2010

Urban Drainage and Flood Control District Urban Storm Drainage Criteria Manual Volume 3

Manual Volume 3

SM-3

CONSTRUCTION FENCE MAINTENANCE NOTES

**Construction Fence (CF)** 

1. INSPECT BMPs EACH WORKDAY, AND MAINTAIN THEM IN EFFECTIVE OPERATING CONDITION. MAINTENANCE OF BMPs SHOULD BE PROACTIVE, NOT REACTIVE. INSPECT BMPs AS SOON AS POSSIBLE (AND ALWAYS WITHIN 24 HOURS) FOLLOWING A STORM THAT CAUSES SURFACE EROSION, AND PERFORM NECESSARY MAINTENANCE.

 FREQUENT OBSERVATIONS AND MAINTENANCE ARE NECESSARY TO MAINTAIN BMPs IN EFFECTIVE OPERATING CONDITION. INSPECTIONS AND CORRECTIVE MEASURES SHOULD BE DOCUMENTED THOROUGHLY.

3. WHERE BMPs HAVE FAILED, REPAIR OR REPLACEMENT SHOULD BE INITIATED UPON DISCOVERY OF THE FAILURE.

4. CONSTRUCTION FENCE SHALL BE REPAIRED OR REPLACED WHEN THERE ARE SIGNS OF DAMAGE SUCH AS RIPS OR SAGS. CONSTRUCTION FENCE IS TO REMAIN IN PLACE UNTIL THE UPSTREAM DISTURBED AREA IS STABILIZED AND APPROVED BY THE LOCAL JURISDICTION.

5. WHEN CONSTRUCTION FENCES ARE REMOVED, ALL DISTURBED AREAS ASSOCIATED WITH THE INSTALLATION, MAINTENANCE, AND/OR REMOVAL OF THE FENCE SHALL BE COVERED WITH TOPSOIL, SEEDED AND MULCHED, OR OTHERWISE STABILIZED AS APPROVED BY LOCAL JURISDICTION.

NOTE: MANY JURISDICTIONS HAVE BMP DETAILS THAT VARY FROM UDFCD STANDARD DETAILS. CONSULT WITH LOCAL JURISDICTIONS AS TO WHICH DETAIL SHOULD BE USED WHEN DIFFERENCES ARE NOTED.

(DETAIL ADAPTED FROM TOWN OF PARKER, COLORADO, NOT AVAILABLE IN AUTOCAD)

City of Albuquerque
Planning Department
Development Review Services
HYDROLOGY SECTION
APPROVED

DATE: May 22, 2025


BY: May 22, 2025

BY: G19D003A

The approval of these plans/reports shall not be construed to permit violations of any city ordinance or state law, and shall not prevent the city of albuquerque from requiring corrections for errors or dimensions in plans, specifications, or construction documents. Such approved plans/reports shall not be changed, modified or altered without authorization.

The approval of these plans/reports shall expire two (2) years after the approval date if no building permit has been pulled on the development.

TAYOU West Colfax Avenue Lakewood, Colorado 8021 303.431.6100

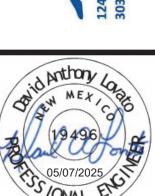

DEL SOL CONDOS
DRAINAGE ISSUES
CONSTRUCTION DOCUMENTS

No. Issue / Revision Date Name

1 FIRST CITY SUBMITTAL 12/20/2024 NT

2 SECOND CITY SUBMITTAL 02/28/2025 NT

3 THIRD CITY SUBMITTAL 05/08/2025 NT

TRIEDMAN

OVATO


ALL TECHNICAL DRAWINGS,
EREOF, ARE PROPRIETARY
COMMERCIALLY EXPLOITED

t Manager N. IRUJILLO
Design By N. TRUJILLO
Drawn By J. FRIEDMAN
In Charge D. LOVATO
SHOWN HEREIN INCLUDING ALL TECHNICAL E
SENTATION & MODELS THEREOF, ARE PRO

Sheet Number:

C2.50

SHFFT 7 OF 10

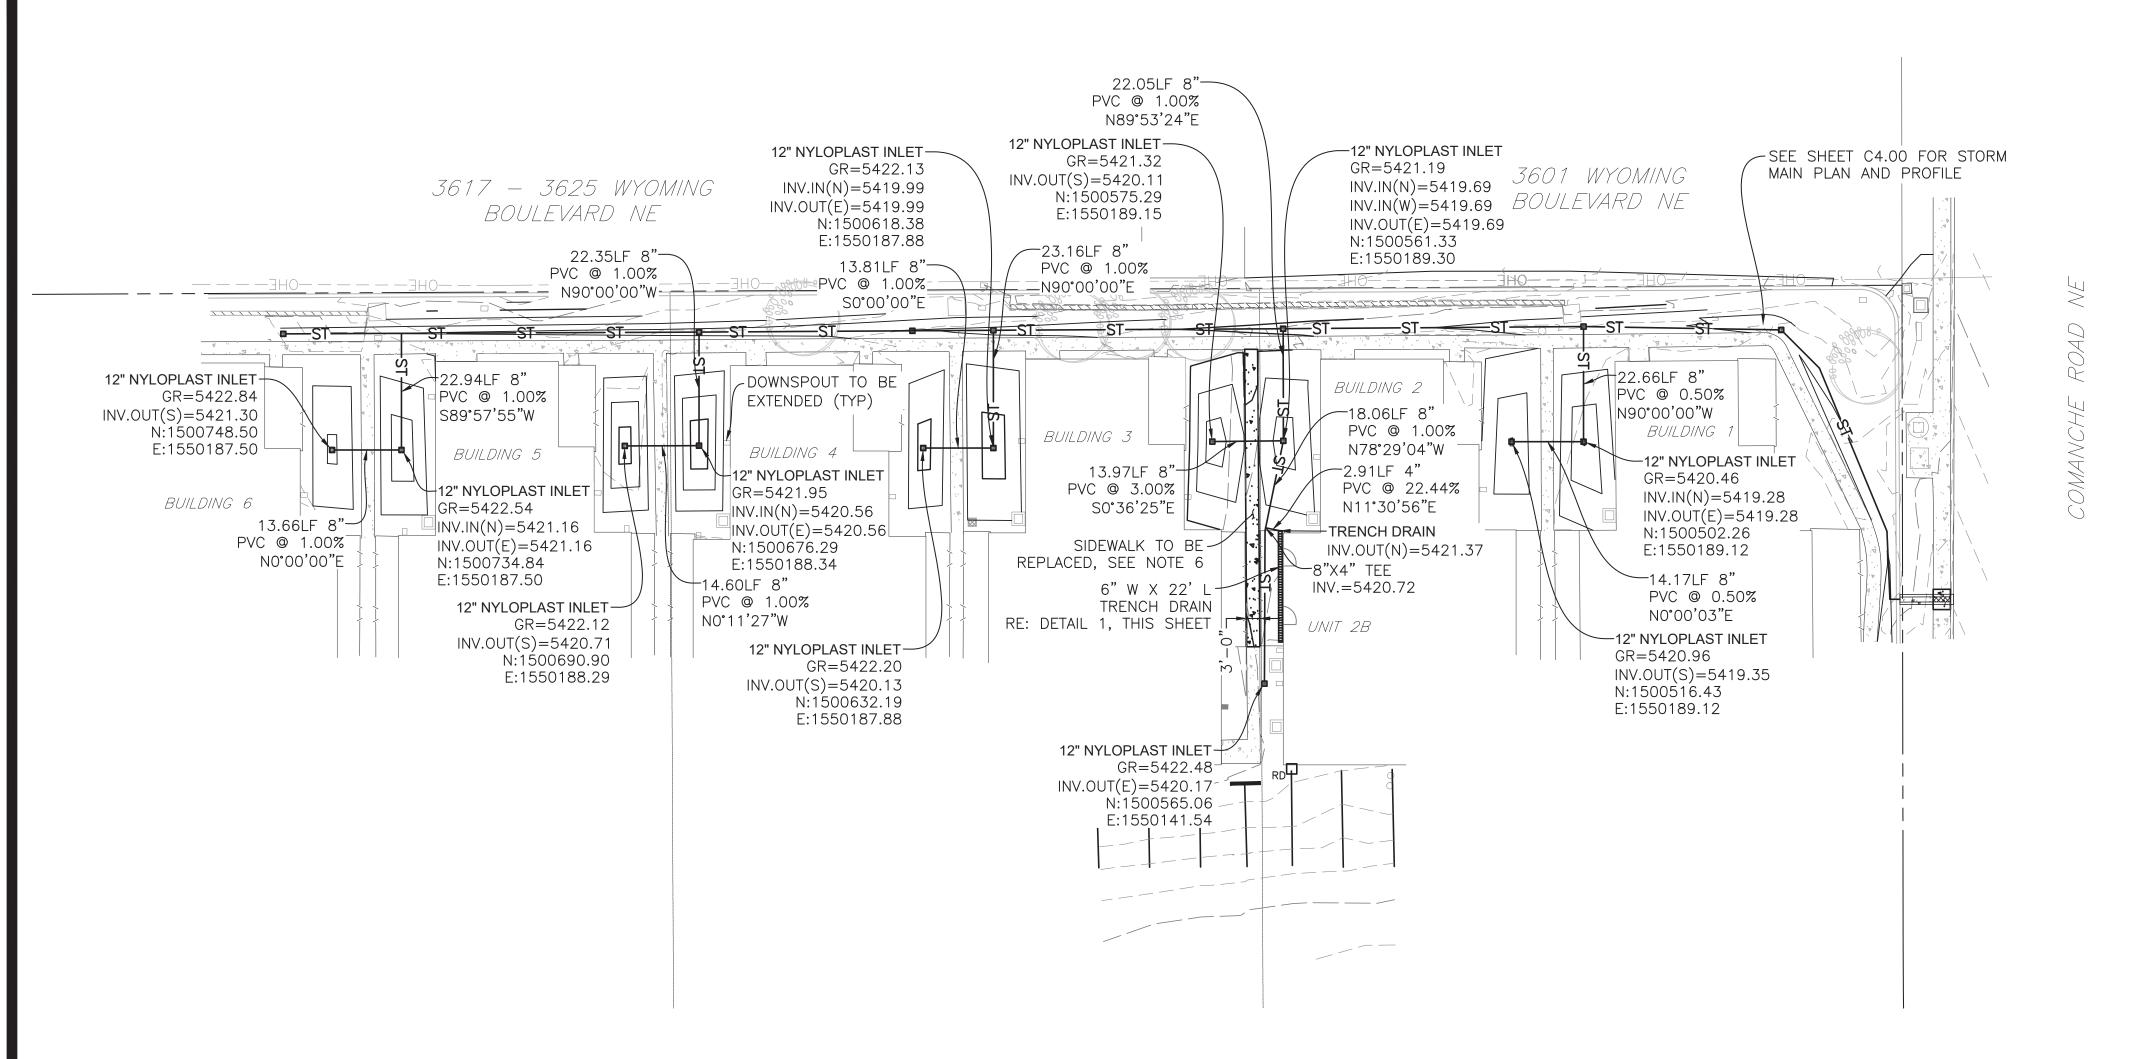

#### **STORM SEWER NOTES:**

- 1. ALL MATERIALS AND CONSTRUCTION SHALL BE IN ACCORDANCE WITH THE CITY OF ALBUQUERQUE ENGINEERING STANDARDS, MATERIAL SPECIFICATIONS, AND DRAWINGS [LATEST REVISION]. ALL STORM SEWER CONSTRUCTION SHALL BE APPROVED AND INSPECTED BY THE CITY OF ALBUQUERQUE.
- 2. CONTRACTOR SHALL VERIFY HORIZONTAL AND VERTICAL LOCATIONS OF EXISTING STORM SEWER POINTS OF CONNECTION PRIOR TO CONSTRUCTION OF ANY PROPOSED STORM SEWER.
- 3. ALL JOINTS AND JOINTING MATERIAL SHALL CONFORM TO THE FOLLOWING MINIMUM REQUIREMENTS. (REFER TO MHFD SPECIFICATION 33 41 00 FOR ADDITIONAL INFORMATION):
  - A. RUBBER GASKET JOINTS FOR TONGUE AND GROOVE OR BELL AND SPIGOT PIPE USING A CONFINED GASKET JOINT SHALL CONSIST OF AN O-RING RUBBER GASKET OR OTHER APPROVED GASKET CONFIGURATION AND SHALL CONFORM TO THE REQUIREMENTS OF ASTM 361, ASTM C443, ASTM C1619, OR ASTM C1628 FOR THE PIPE DESIGNATED. UNLESS OTHERWISE APPROVED BY ENGINEER, THE STANDARD JOINT CONFIGURATION SHALL BE AS NOTED IN MHFD SUBSECTION
  - B. RUBBER GASKET JOINTS FOR TONGUE AND GROOVE OR BELL AND SPIGOT PIPE USING A SINGLE OFFSET JOINT SHALL CONSIST OF A NON-CIRCULAR RUBBER GASKET OR OTHER APPROVED GASKET CONFIGURATION AND SHALL CONFORM TO THE REQUIREMENTS OF ASTM C76 OR ASTM 361 FOR THE PIPE DESIGNATED. UNLESS OTHERWISE APPROVED BY ENGINEER, THE STANDARD JOINT CONFIGURATION SHALL BE AS NOTED IN SUBSECTION MHFD 3.04.F.
  - C. GASKETS MAY BE NATURAL RUBBER, ISOPRENE OR NEOPRENE CONFORMING TO ASTM C1619.
- 4. DISTANCES FOR STORM SEWER PIPE ARE THE HORIZONTAL DISTANCES FROM CENTER OF MANHOLE TO CENTER OF MANHOLE. THEREFORE, DISTANCES SHOWN ON PLANS ARE APPROXIMATE AND COULD VARY DUE TO VERTICAL ALIGNMENT AND MANHOLE
- 5. ALL STORM SEWERS SHALL HAVE CLASS "B" BEDDING UNLESS OTHERWISE SHOWN. BEDDING MATERIAL SHALL CONFORM TO ASTM C-33 OR D-448, GRADATION NO. 67.
- 6. THE FLEXIBLE PLASTIC JOINT SEALING COMPOUND SHALL BE "RAMNEK," RUBBERNECK OR APPROVED EQUAL.
- 7. THE CONNECTION OF A NEW STORM SEWER TO AN EXISTING MANHOLE/INLET MAY REQUIRE CHANGES IN ELEVATIONS OR MODIFICATION TO EXISTING STRUCTURES. USE OF A PRE-CAST CONCRETE STRUCTURE OR MANHOLE/INLET RECONSTRUCTION IS AT THE DISCRETION OF THE CITY OF ALBUQUERQUE.
- 8. CONTRACTOR SHALL IMMEDIATELY REMOVE DEBRIS DEPOSITED INTO PUBLIC MANHOLES AND OTHER PUBLIC STRUCTURES TO ELIMINATE THE POSSIBILITY OF PROPERTY DAMAGE DUE TO THE DEBRIS CAUSING BACKUP INTO PRIVATE PROPERTIES. IF IT IS DETERMINED THAT DEBRIS CAUSED A BACKUP, THE CONTRACTOR SHALL BE HELD RESPONSIBLE FOR DAMAGES.
- 9. NO TREES SHALL BE PLANTED WITHIN ANY SEWER EASEMENT OR WITHIN TEN [10] FEET OF ANY PUBLIC MANHOLES, PIPES OR INLETS.
- 10. RIM ELEVATIONS SHOWN ARE APPROXIMATE ONLY AND ARE NOT TO BE TAKEN AS FINAL ELEVATIONS. CONTRACTOR SHALL USE PRECAST CONCRETE ADJUSTMENT RINGS TO ADJUST THE MANHOLE FRAME TO THE REQUIRED FINAL GRADE, SUCH THAT THERE IS NO MORE THAN EIGHTEEN [18] INCHES FROM FINISHED GRADE TO THE TOP OF THE CONE SECTION. THE RIM SHALL BE LEFT 1/8-INCH TO 1/4-INCH BELOW FINISHED ASPHALT.
- 11. MANHOLE COVERS SHALL BE ALIGNED TO PROVIDE A MINIMUM OF THREE [3] FEET CLEARANCE BETWEEN THE MANHOLE RING AND THE LIP OF GUTTER.


### NOTES:


- 1. SEE SHEET C1.00 FOR LEGEND, BASIS OF BEARING, AND ABBREVIATIONS LIST. SEE SHEET C1.01 FOR ADDITIONAL
- 2. ADJUST ALL UTILITY SURFACE EXPRESSION AFFECTED BY GRADING TO FINISH GRADE.
- 3. CONTRACTOR SHALL PROVIDE A MINIMUM 18" CLEARANCE AT ALL UTILITY CROSSINGS.
- 4. CONTRACTOR SHALL REPAIR/ADJUST ALL EXISTING IRRIGATION SYSTEMS IMPACTED BY GRADING AND DRAINAGE IMPROVEMENTS.
- 5. ALL LANDSCAPE INLETS SHALL BE 12" AREA INLETS WITH DOME GRATE OR APPROVED EQUAL UNLESS NOTED
- 6. ALL SIDEWALK REPLACEMENT SHALL BE 4" THICK 4000 PSI

#### **BENCHMARK:**

DESIGNATION = ALBUQUERQUE CONTROL STATION "4\_G20R", ALBUQUERQUE, NM. = 5426.439 US FEET FOUND 3 INCH BRASS TABLET SET IN THE EAST MOST MEDIAN CURB ON THE NORTH MEDIAN NOSE OF THE INTERSECTION OF COMANCHE ROAD NE AND WYOMING BOULEVARD NE.


TBM = 5,426.02 US FEET FOUND MAG NAIL SET IN TOP OF BLOCK WALL AT NORTHEAST PROPERTY CORNER OF SUBJECT

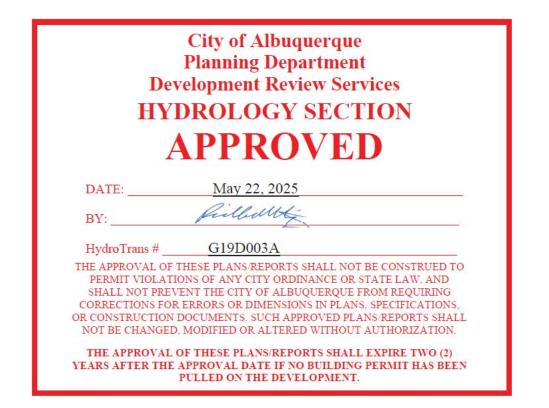

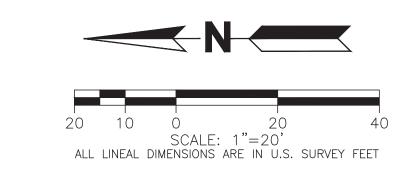


EXISTING		PROPOSED
	— PROPERTY LINE —	
	- SECTION LINE	
	— EASEMENT —	
	RETAINING WALL	
	CURB & GUTTER =	
	UTILITY CROSSING	#
	STORM SEWER -	ST
(ST)	STORM MANHOLE	
	ROOF DRAIN -	RD
	STORM INLET	
<	FLARED END SECTION	
	SANITARY SEWER -	SS
(\$5)	SANITARY MANHOLE	
Q.	CLEAN OUT	©
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$\otimes$	WATER VALVE	$\otimes$
2	FIRE HYDRANT	A
⊗ wM	WATER METER —	<u> </u>
IR	IRRIGATION LINE -	IR
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E	ELECTRIC LINE -	E
$\Diamond$	LIGHT POLE	<b>*</b>
Ø	POWER POLE	ø
ELEC	ELECTRIC METER	
	TELEPHONE LINE -	тт
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	CABLE TV —	CT
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O.W.	MONITOR WELL	
DRIVE	DESCRIPTIONS	DRIVE

**LEGEND** 

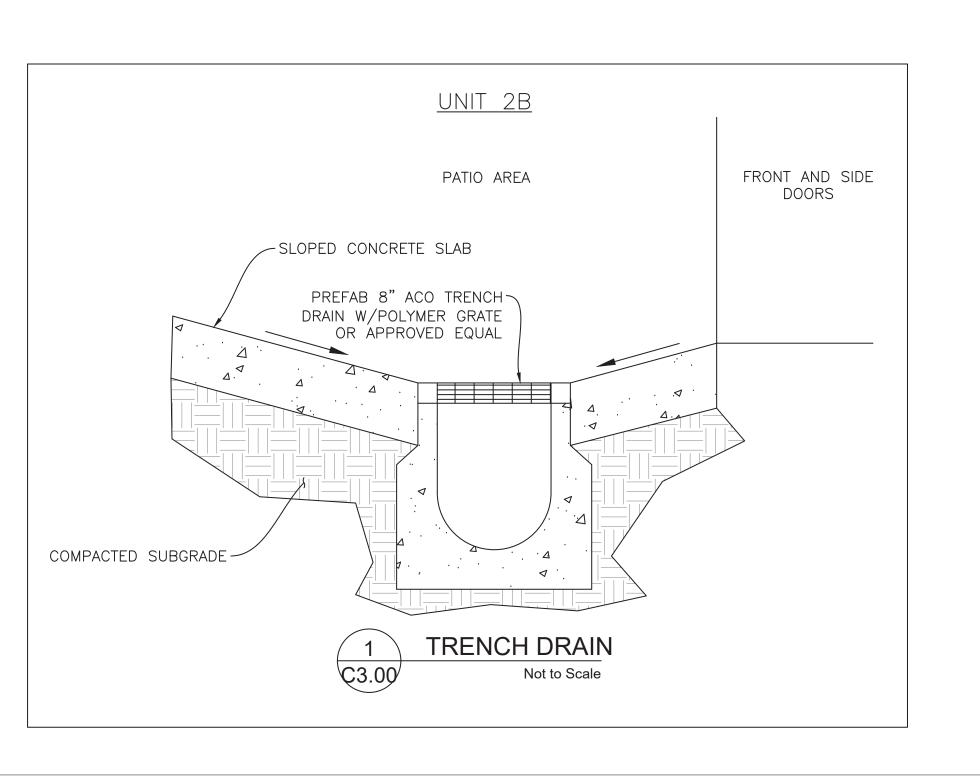





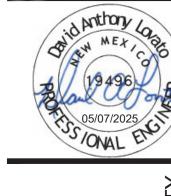

DR.

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Sheet Number:

SHEET 8 OF 10

EX GROUND AT - CENTER OF PIPE -

58.56LF 12" PVC @ 1.00%

41.97LF 12" PVC @ 1.00%

NV.IN(N) = S NV.OUT(S) = S

3+00

\_\_15.94LF 12"<u>\_</u> PVC @ 1.00%

2+50


23.25LF 12"

PVC @ 1.00%

93

.IN(W)=5420.9 .IN(N)=5420.9 .OUT(S)=5420

3+50

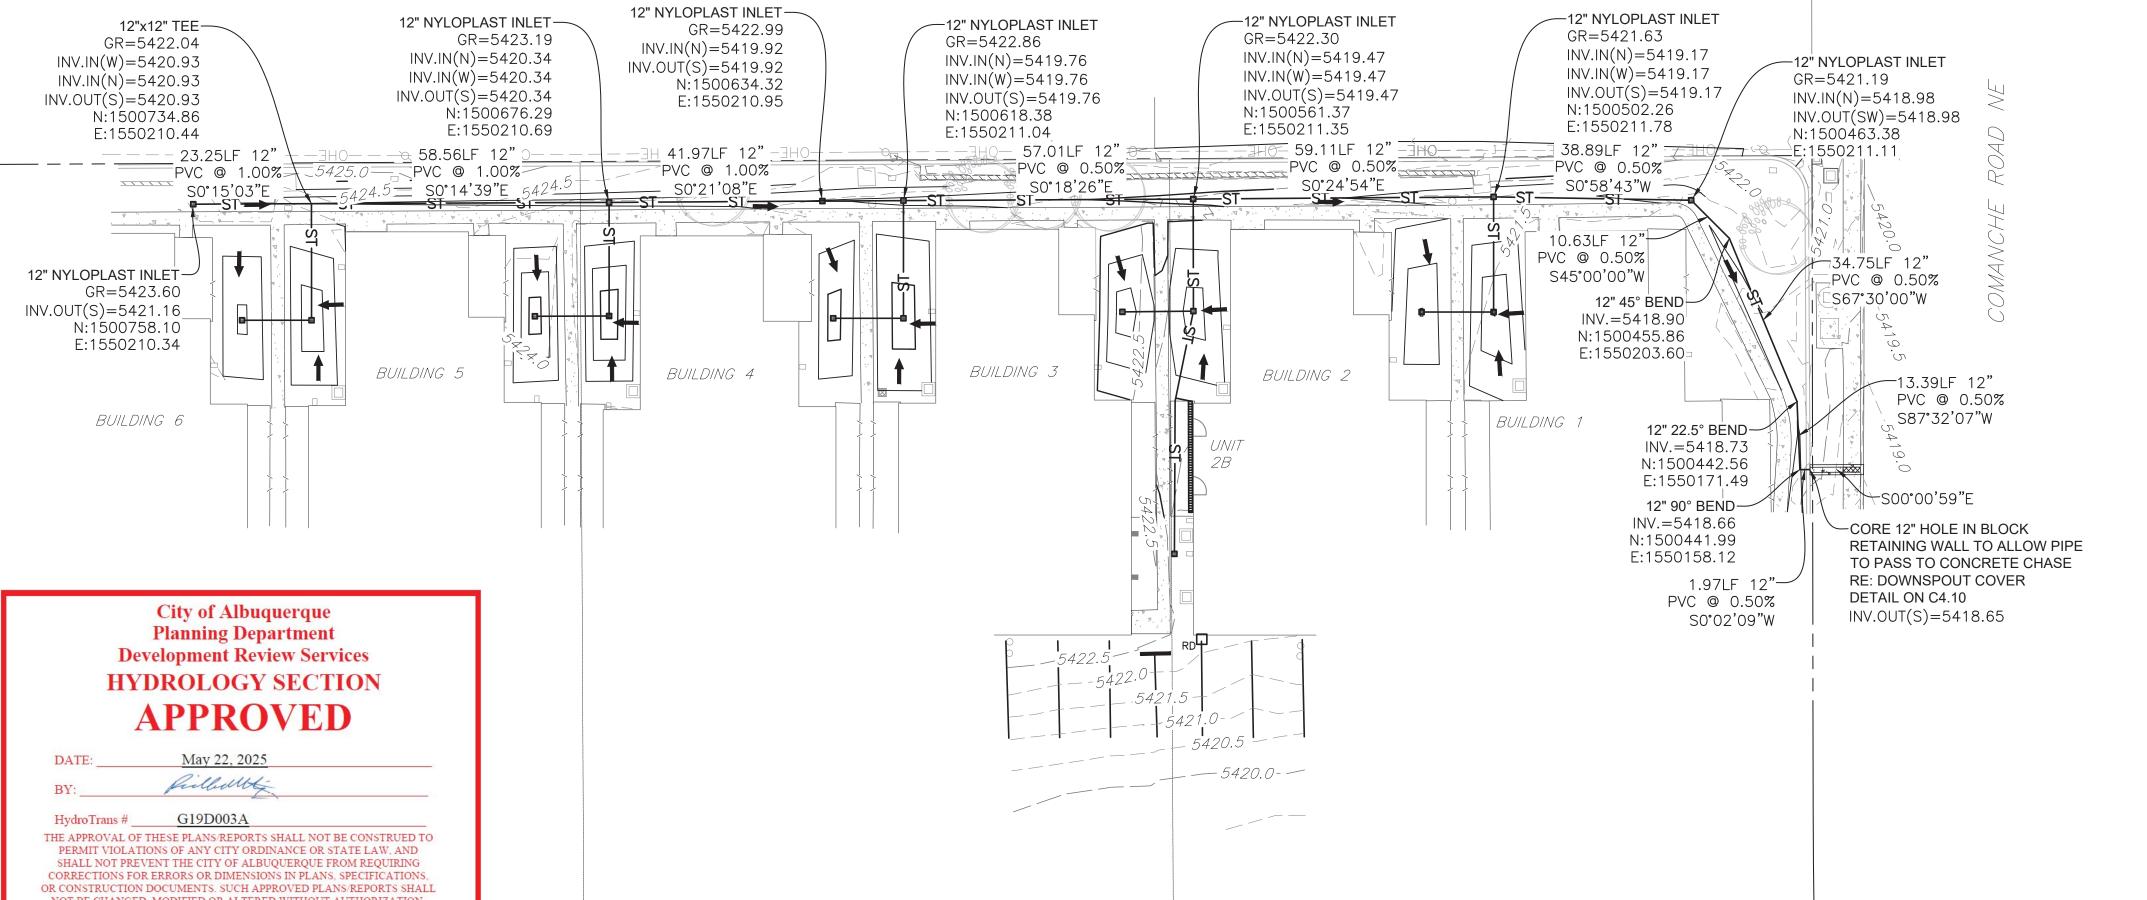

#### **NOTES:**

- 1. SEE SHEET C1.00 FOR LEGEND, BASIS OF BEARING, AND ABBREVIATIONS LIST. SEE SHEET C1.01 FOR ADDITIONAL NOTES.
- 2. REFER TO SHEET C3.00 FOR DETAILS OF STORM LATERALS.
- 3. ADJUST ALL UTILITY SURFACE EXPRESSION AFFECTED BY GRADING TO FINISH GRADE. 4. CONTRACTOR SHALL PROVIDE A MINIMUM 18"
- CLEARANCE AT ALL UTILITY CROSSINGS. 5. CONTRACTOR SHALL REPAIR/ADJUST ALL
- EXISTING IRRIGATION SYSTEMS IMPACTED BY GRADING AND DRAINAGE IMPROVEMENTS. 6. ALL LANDSCAPE INLETS SHALL BE 12" AREA INLETS WITH DOME GRATE OR APPROVED

#### **BENCHMARK:**

12" 22.5° BEND STA 0+40.51 EL=5419.84

34.751 F 12" PVC @ 0.50%

13.39LF 12" (NV. INV. INV. OUT(W) = 54.18 (NV. OUT(W) = 54.18 (NV.

0+50

10.63LF 12"

PVC @ 0.50%

38.89LF 12" PVC @ 0.50%

1+00

59.11LF 12" PVC @ 0.50%

1+50

INV.IN(N)=5419.17 INV.IN(W)=5419.17 INV.OUT(S)=5419.17

5425

-DRAINS TO GUTTER.
ULTIMATE OUTFALL IS
STREET INLET AT LYKES

DR INTERSECTION.

5415 10.57LF 2' WIDE

@ 0.50%

SIDEWALK CHASE

PVC @ 0.50%


<sub>-</sub>3.46' SIDEWALK


INV.IN(E)=5418.66 INV.OUT(S)=5418.66 INV.IN(N)=5418.65 INV.OUT(S)=5418.65 INV.IN(N)=5418.60

DESIGNATION = ALBUQUERQUE CONTROL STATION "4\_G20R", ALBUQUERQUE, NM. = 5426.439 US FEET FOUND 3 INCH BRASS TABLET SET IN THE EAST MOST MEDIAN CURB ON THE NORTH MEDIAN NOSE OF THE INTERSECTION OF COMANCHE ROAD NE AND WYOMING BOULEVARD

EQUAL UNLESS NOTED OTHERWISE.

TBM = 5,426.02 US FEET FOUND MAG NAIL SET IN TOP OF BLOCK WALL AT NORTHEAST PROPERTY CORNER OF SUBJECT PROPERTY.

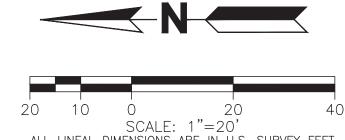

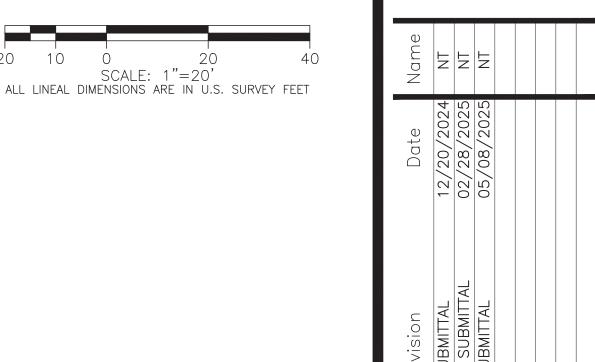

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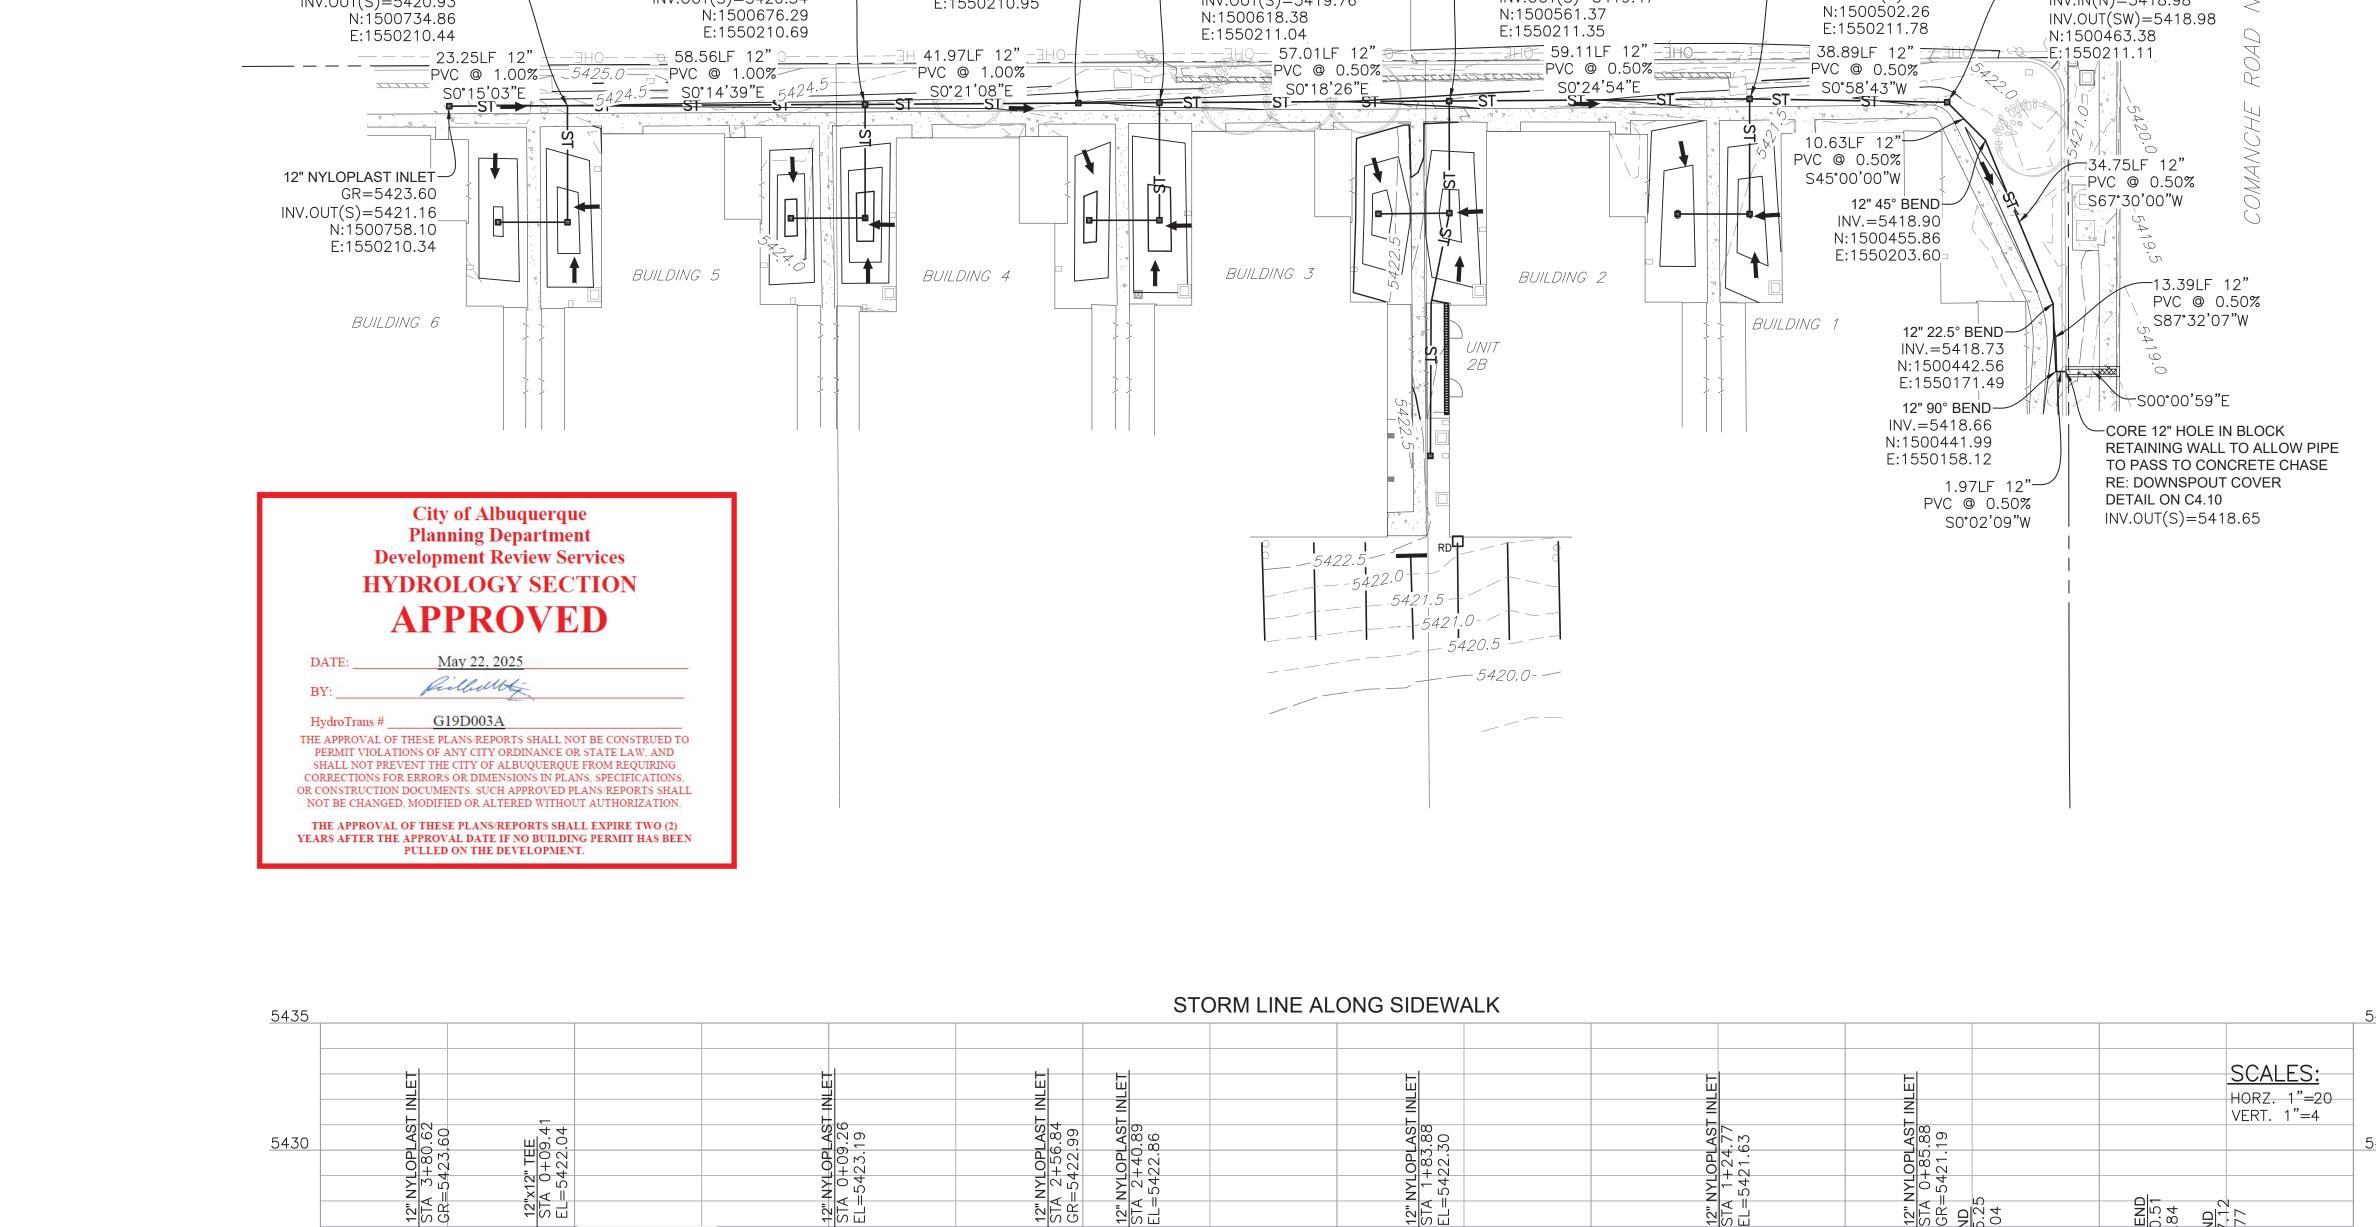
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Sheet Number:

SHEET 9 OF 10



PROPOSED GRADE AT -CENTER OF SWALE

57.01LF 12" PVC @ 0.50%

/.IN(N)=5419.47 /.IN(W)=5419.47 /.OUT(S)=5419.47

2+00


5425

5420

<u>5415</u>

<u>5410</u>

4+00

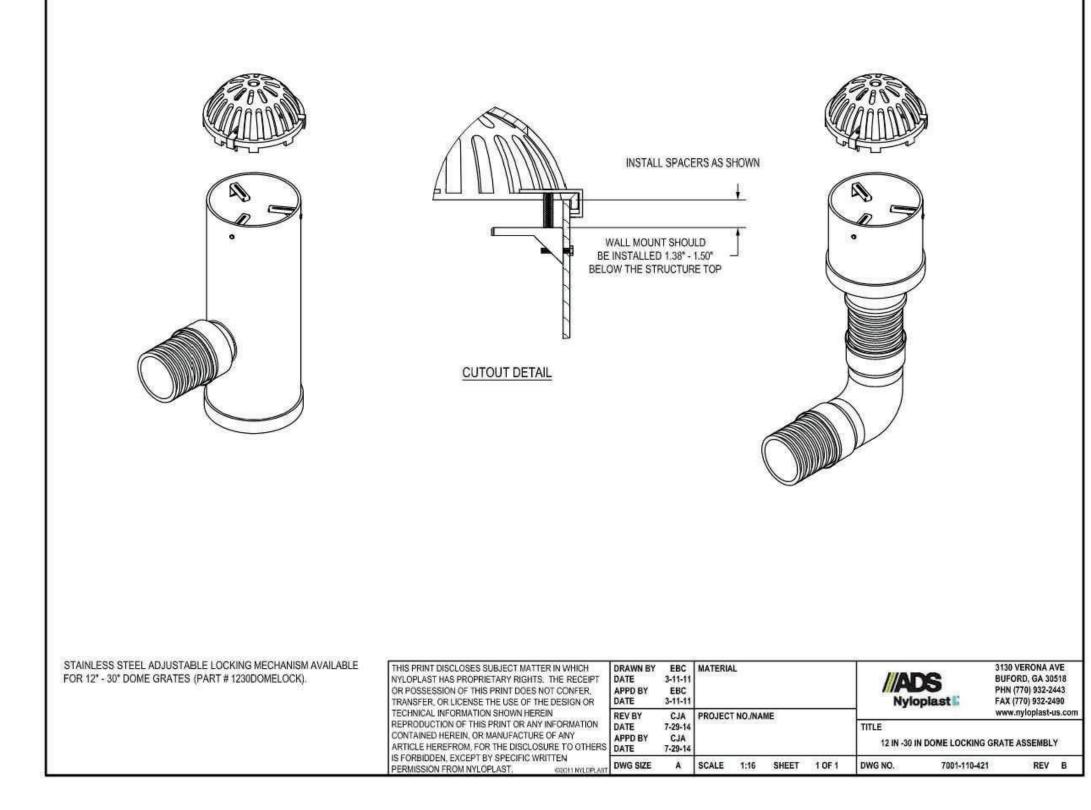




HydroTrans # G19D003A

THE APPROVAL OF THESE PLANS/REPORTS SHALL NOT BE CONSTRUED TO PERMIT VIOLATIONS OF ANY CITY ORDINANCE OR STATE LAW, AND SHALL NOT PREVENT THE CITY OF ALBUQUERQUE FROM REQUIRING CORRECTIONS FOR ERRORS OR DIMENSIONS IN PLANS, SPECIFICATIONS, OR CONSTRUCTION DOCUMENTS. SUCH APPROVED PLANS/REPORTS SHALL

NOT BE CHANGED, MODIFIED OR ALTERED WITHOUT AUTHORIZATION.


THE APPROVAL OF THESE PLANS/REPORTS SHALL EXPIRE TWO (2)
YEARS AFTER THE APPROVAL DATE IF NO BUILDING PERMIT HAS BEEN PULLED ON THE DEVELOPMENT.

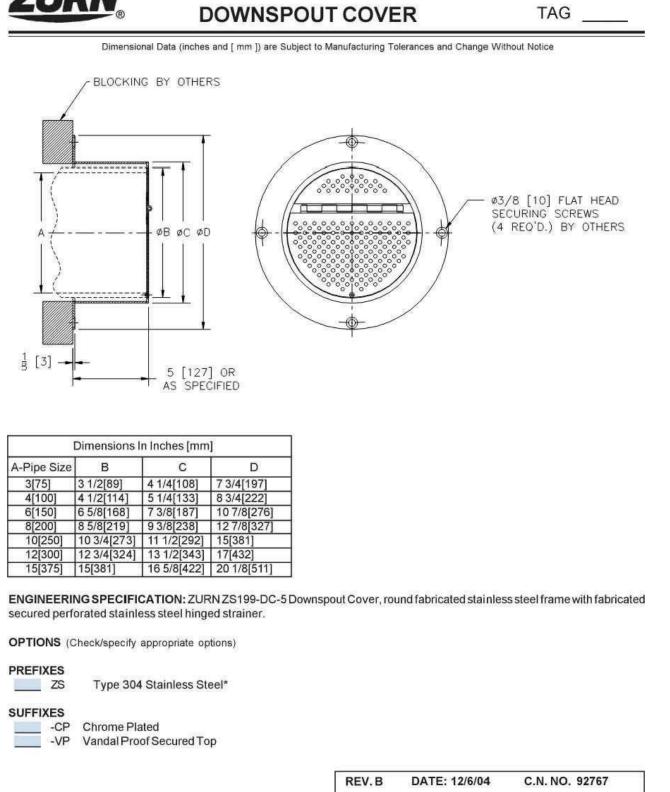

ZURN INDUSTRIES, INC. • SPECIFICATION DRAINAGE OPERATION • 1801 Pittsburgh Ave. • Erie, PA 16514
Phone: 814/455-0921 • Fax: 814/454-7929 • World Wide Web: www.zurn.com
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\*REGULARLY FURNISHED UNLESS OTHERWISE SPECIFIED



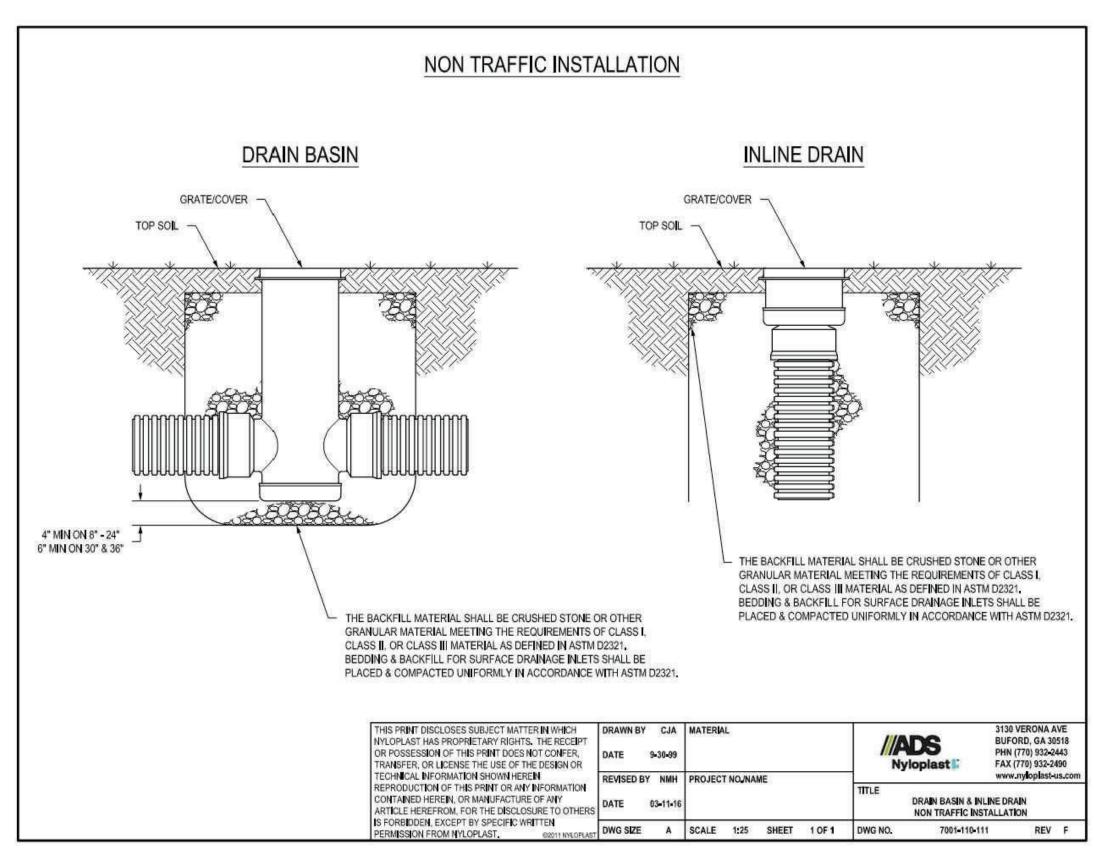

19496 05/07/2025

DEL SOL CONDOS
DRAINAGE ISSUES
CONSTRUCTION DOCUMENTS
STORM SEWER DETAILS


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_	LN.	02/28/2025	SECOND CITY SUBMITTAL	2
	N	12/20/2024	FIRST CITY SUBMITTAL	<b>—</b>
	Name	Date	No. Issue / Revision	O Z

3y N. TRUJILLO
3y J. FRIEDMAN
4e D. LOVATO
INCLUDING ALL TECHNICAL DRAWINGS,
MODELS THEREOF, ARE PROPRIETARY

TRUJI
Design By N. TRUJI
Drawn By J. FRIED
Sipal In Charge D. LOVAT

Sheet Number:

C4.10

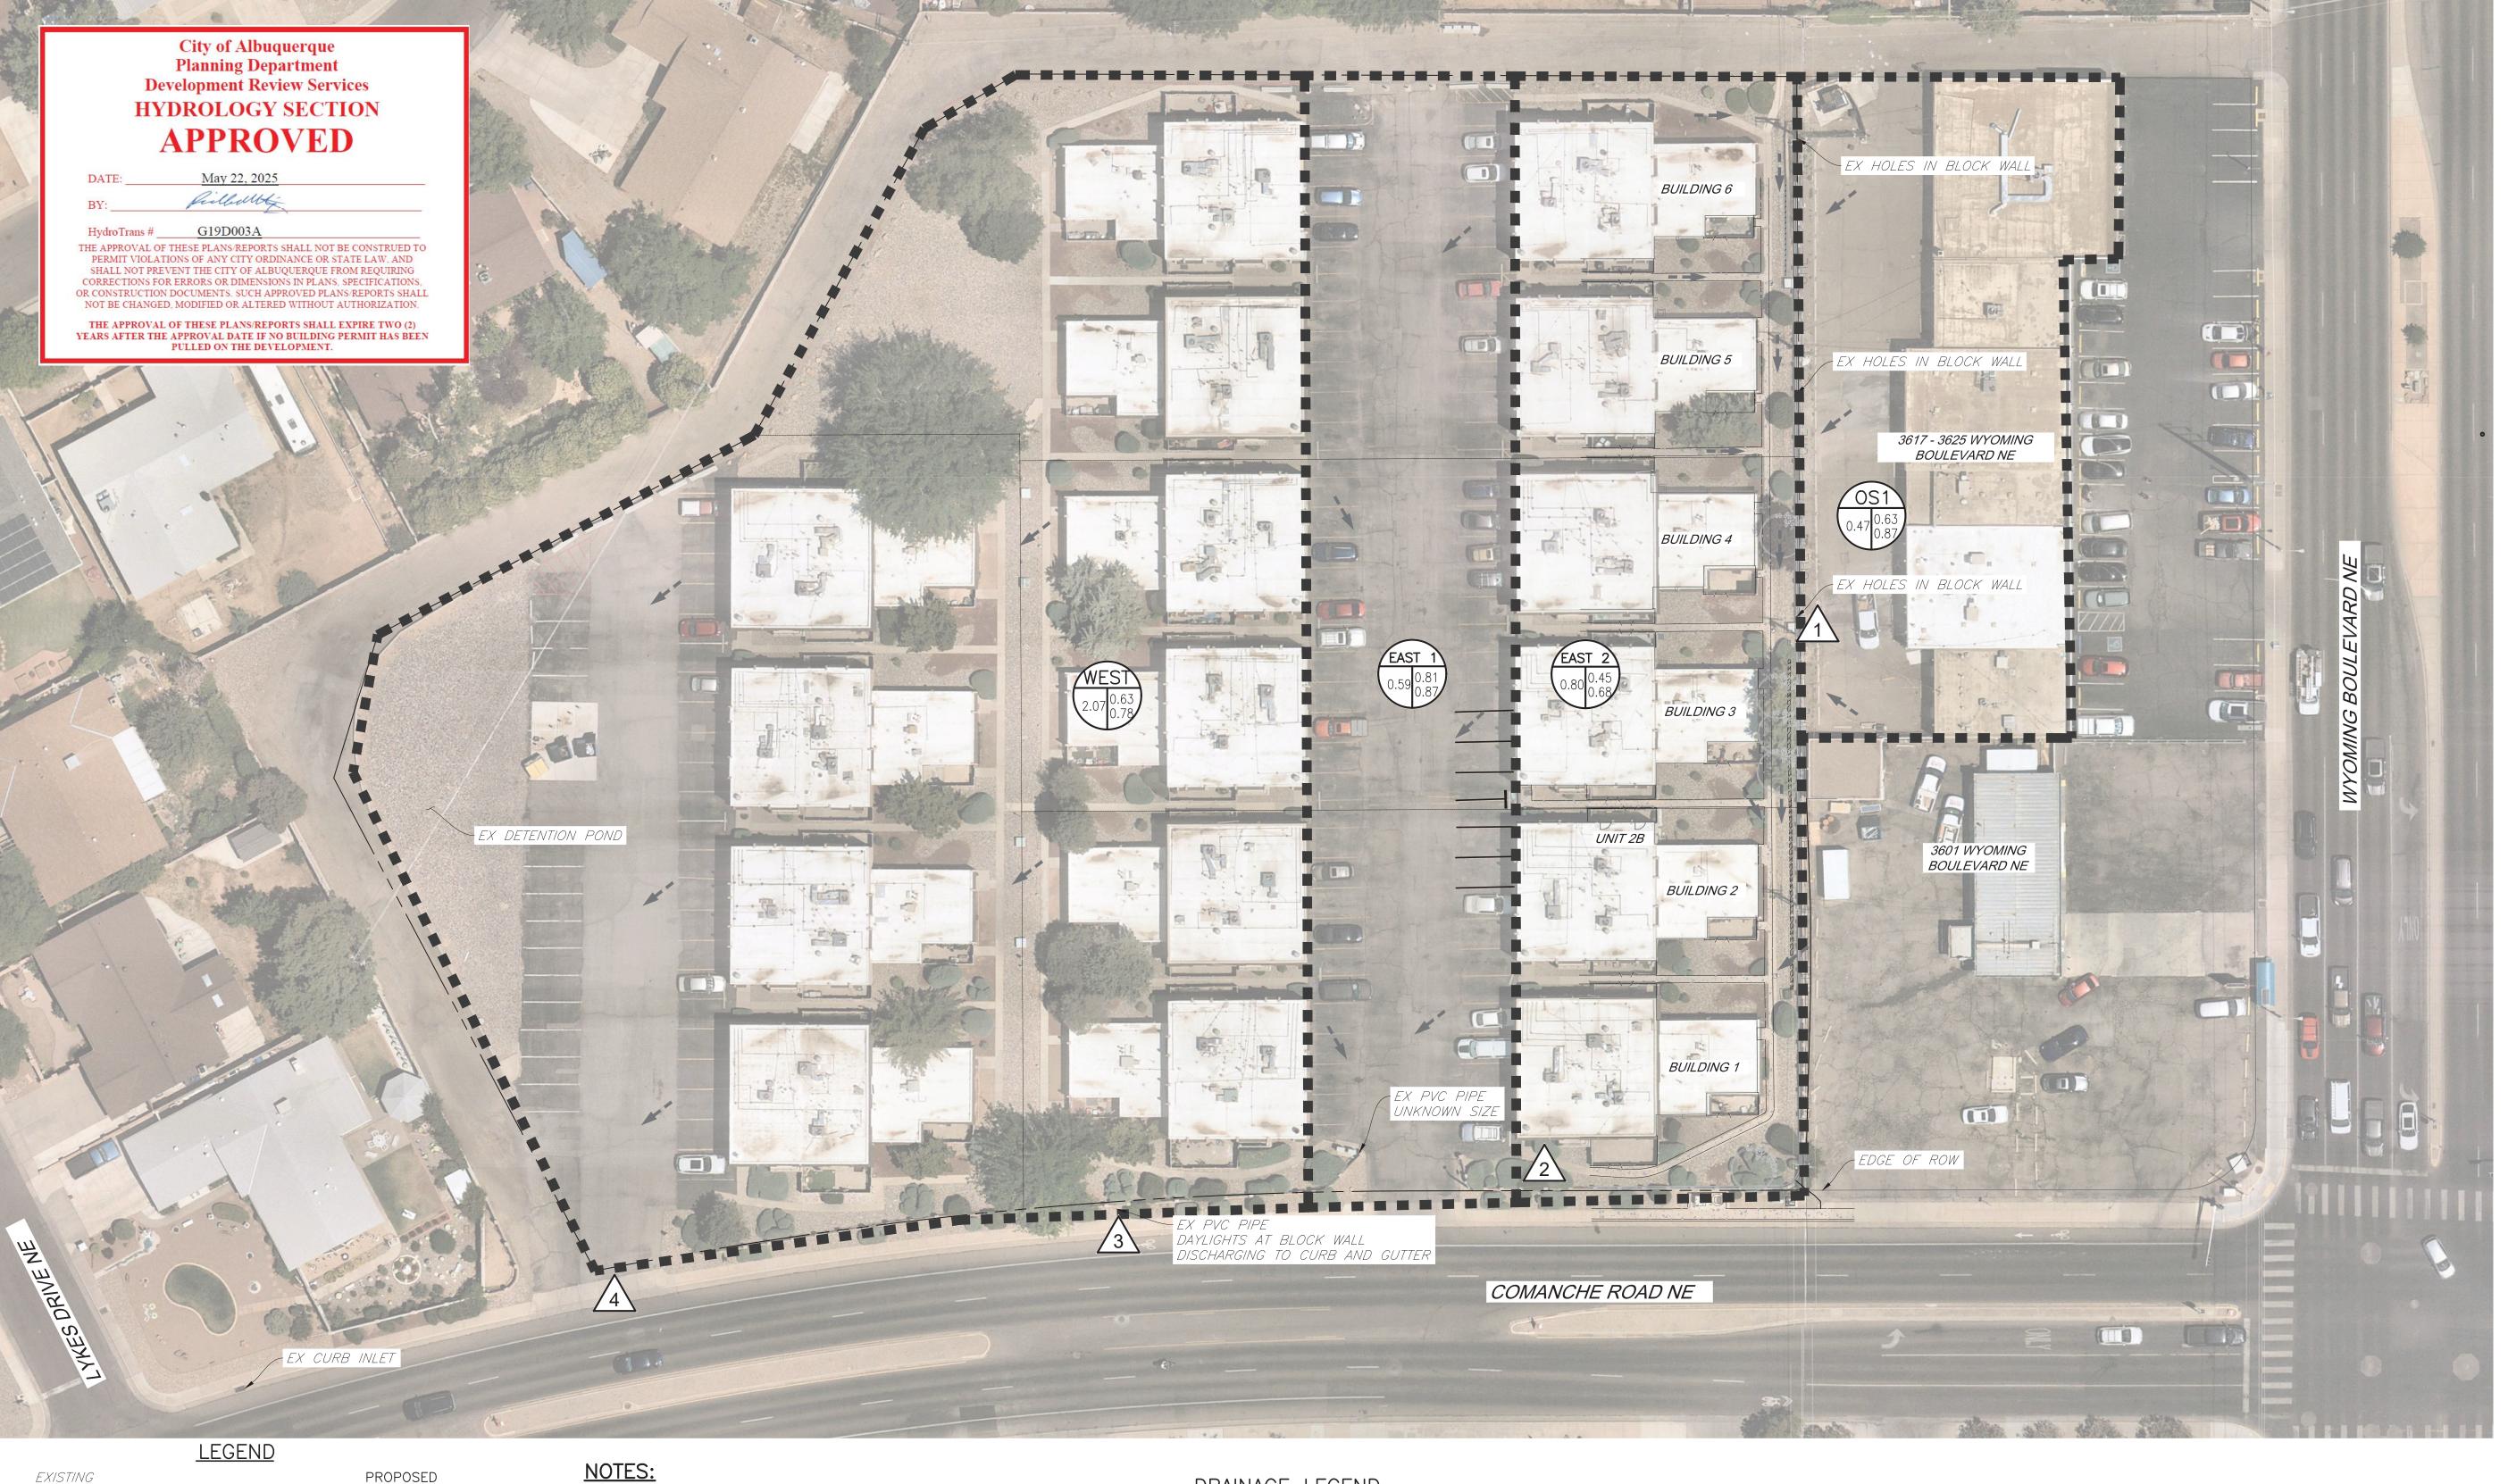

PROPOSED EXISTING RIGHT-OF-WAY LINE RETAINING WALL CURB & GUTTER STORM SEWER STORM INLET OVERHEAD ELECTRIC POWER POLE TELEPHONE LINE T TELEPHONE PEDESTAL CABLE TV GAS LINE

SIGN

DESCRIPTIONS

DRIVE

DRIVE

SEE SHEET C1.00 FOR LEGEND, BASIS OF BEARING, ADDITIONAL NOTES, AND ABBREVIATIONS LIST.


#### **BENCHMARK:**

DESIGNATION = ALBUQUERQUE CONTROL STATION "4\_G2OR", ALBUQUERQUE, NM. = 5426.439 US FEET FOUND 3 INCH BRASS TABLET SET IN THE EAST MOST MEDIAN CURB ON THE NORTH MEDIAN NOSE OF THE INTERSECTION OF COMANCHE ROAD NE AND WYOMING BOULEVARD TBM = 5,426.02 US FEET FOUND MAG NAIL SET

IN TOP OF BLOCK WALL AT NORTHEAST PROPERTY CORNER OF SUBJECT PROPERTY.

## DRAINAGE LEGEND

SUB-BASIN BOUNDARY **III II II III III** DIRECTION OF FLOW

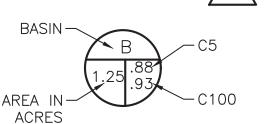

DESIGN POINT

RUNOFF SUMMARY- PROPOSED CONDITION										
BASIN	DESIGN POINT	AREA (ACRES)	% IMP.	C <sub>5</sub>	C <sub>100</sub>	Q <sub>5</sub> (CFS)	Q <sub>100</sub> (CFS)			
EAST 1	3	0.59	95.0%	0.81	0.87	1.48	3.01			
EAST 2	2	2.07	55.6%	0.45	0.68	1.04	3.00			
WEST	4	2.07	87.9%	0.74	0.83	3.86	8.21			
OS1	1	0.47	95.0%	0.81	0.87	1.25	2.55			
SITE CO	MPOSITE	4.25	75.3%	0.63	0.78	7.63	16.77			

SCALE: 1"=30'
ALL LINEAL DIMENSIONS ARE IN U.S. SURVEY FEET







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Name	N	N	Ä				
Date	12/20/2024	02/28/2025	05/08/2025				
Issue / Revision	FIRST CITY SUBMITTAL	SECOND CITY SUBMITTAL	THIRD CITY SUBMITTAL				
O Z	-	2	3				
					آن ا	、	

Sheet Number:





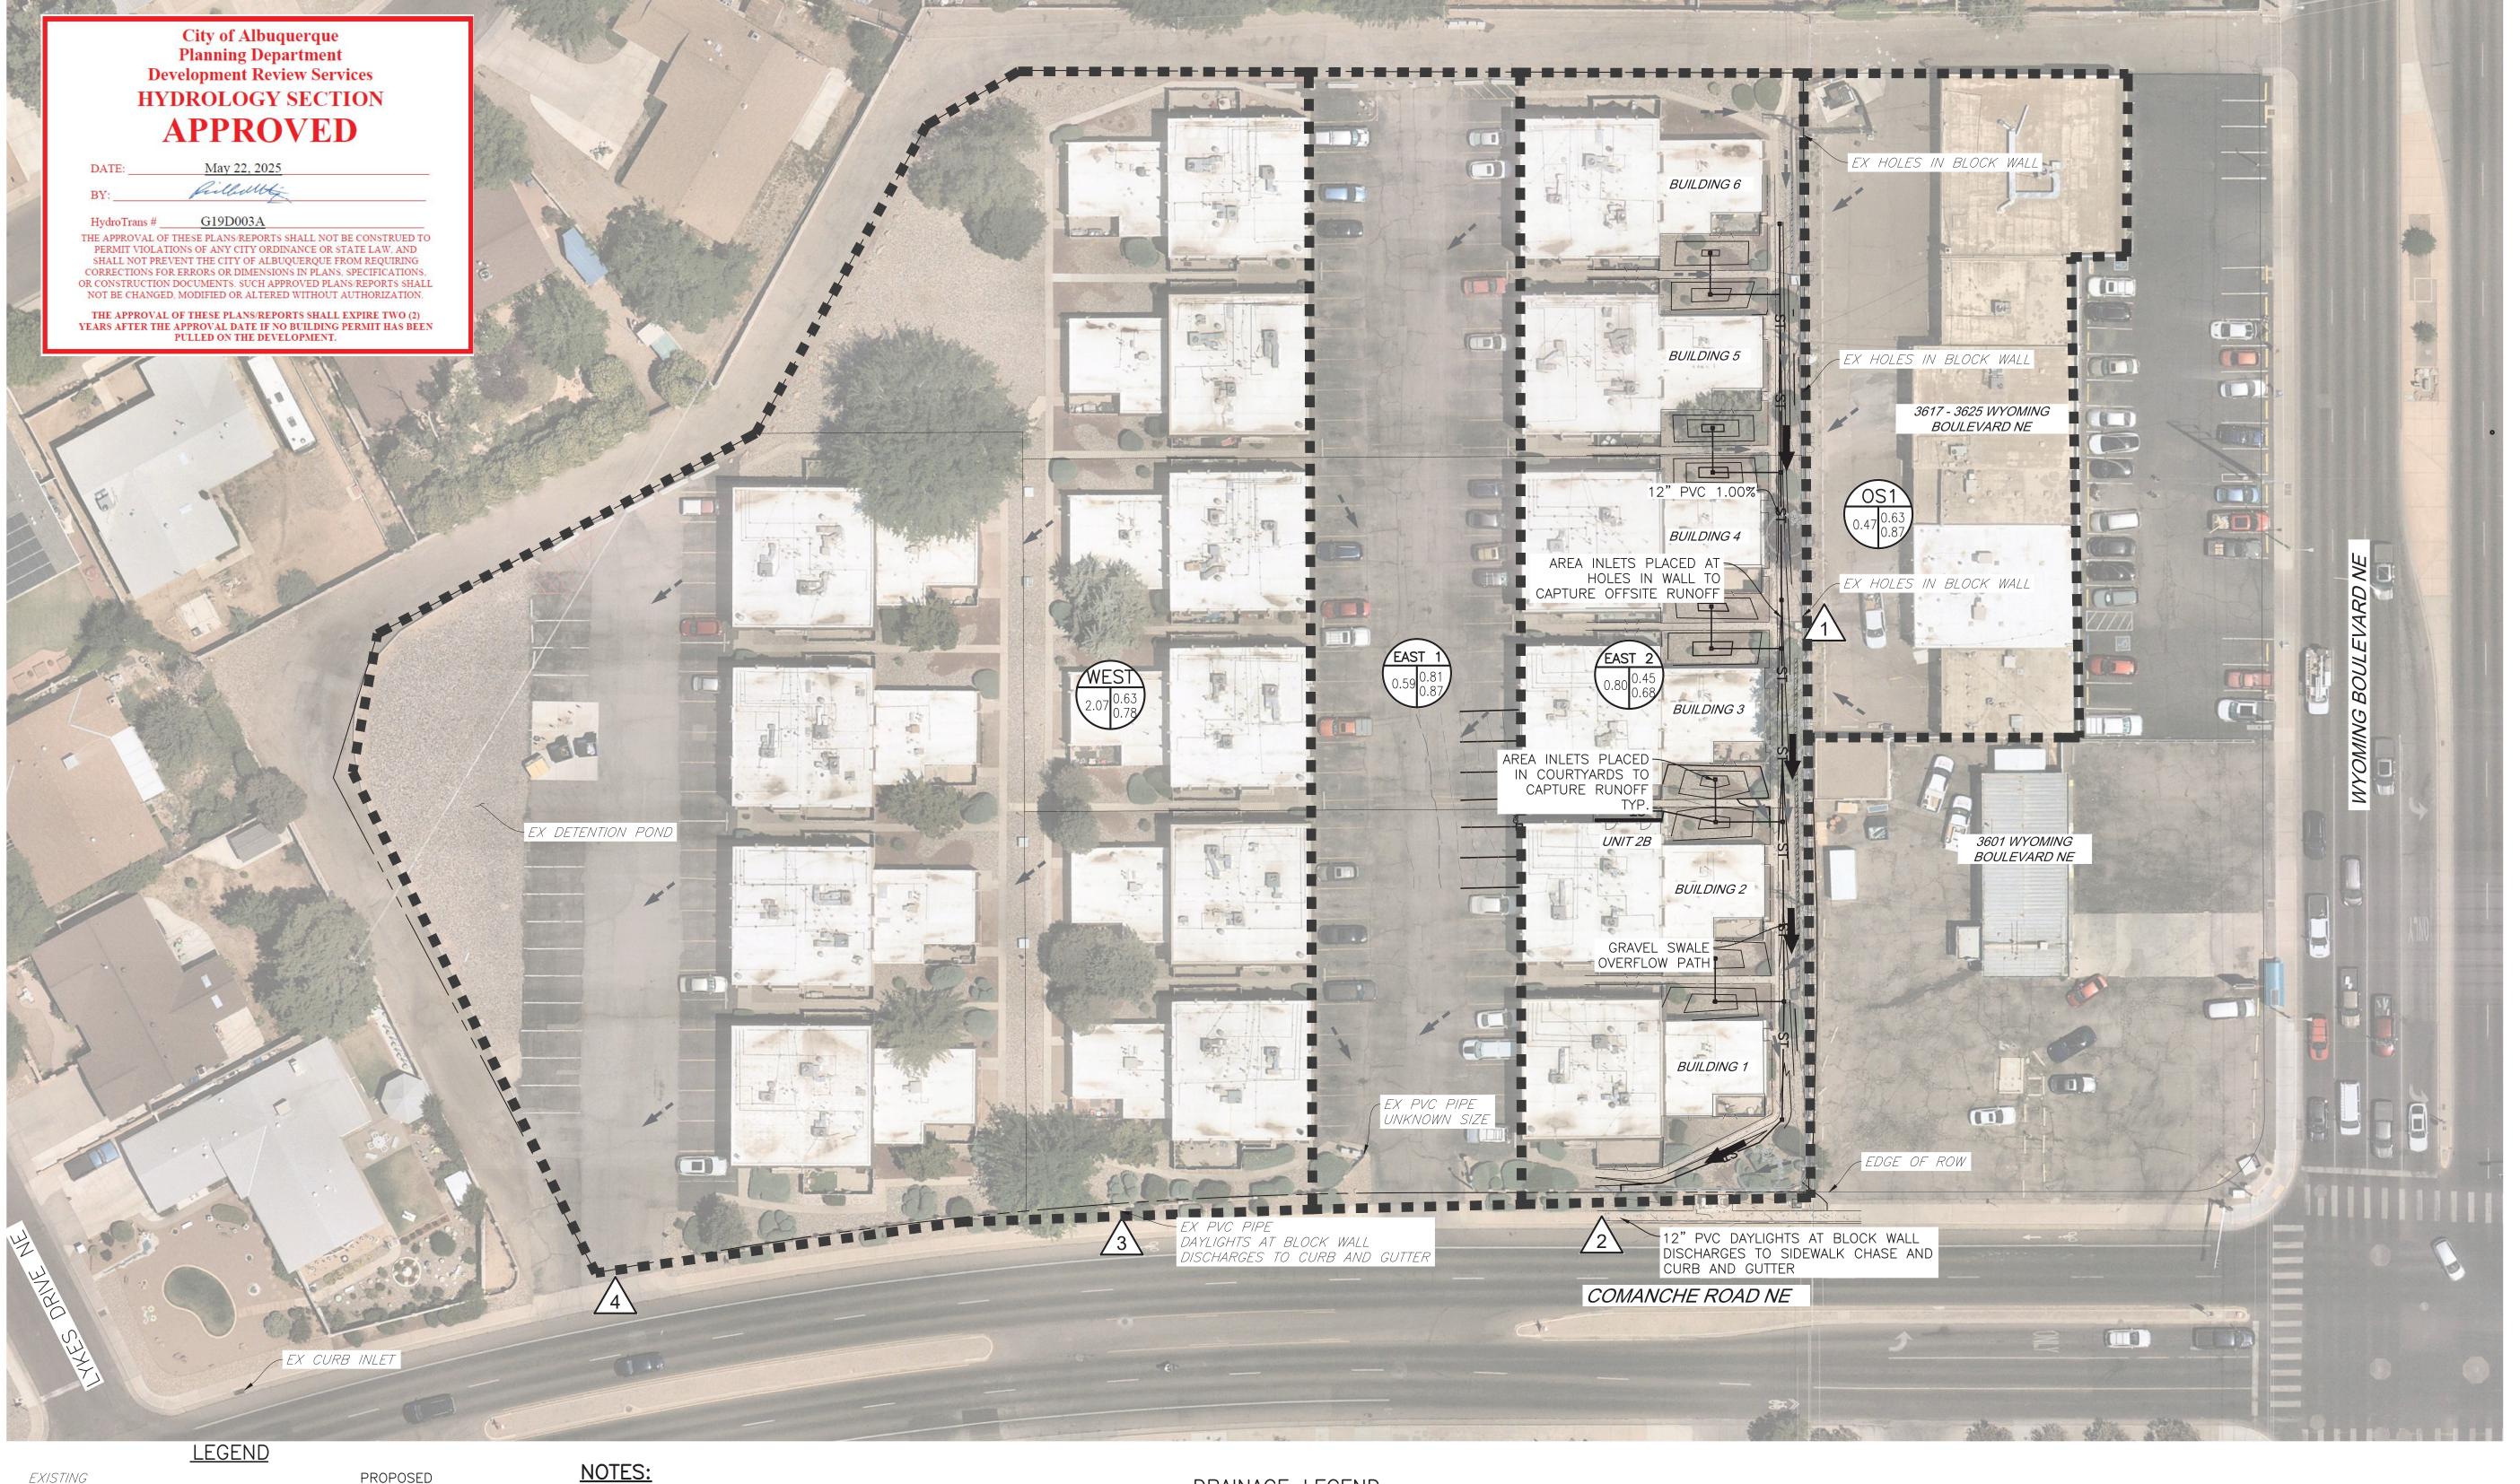

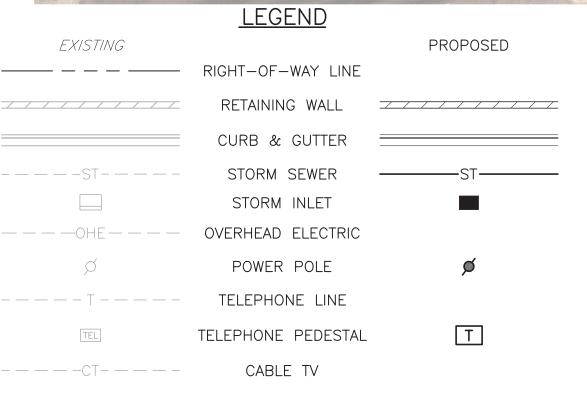GAS LINE

SIGN

DESCRIPTIONS

DRIVE

DRIVE

1. SEE SHEET C1.00 FOR LEGEND, BASIS OF BEARING, ADDITIONAL NOTES, AND ABBREVIATIONS LIST.

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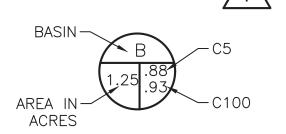
TBM = 5,426.02 US FEET FOUND MAG NAIL SET IN TOP OF BLOCK WALL AT NORTHEAST PROPERTY CORNER OF SUBJECT PROPERTY.

#### DRAINAGE LEGEND

SUB-BASIN BOUNDARY **III II II III III** DIRECTION OF FLOW - EX

DIRECTION OF FLOW - PR

DESIGN POINT




BASIN	DESIGN POINT	AREA (ACRES)	% IMP.	C <sub>5</sub>	C <sub>100</sub>	Q₅ (CFS)	Q <sub>100</sub> (CFS)
EAST 1	3	0.59	95.0%	0.81	0.87	1.48	3.01
EAST 2	2	2.07	55.6%	0.45	0.68	1.04	3.00
WEST	4	2.07	87.9%	0.74	0.83	3.86	8.21
OS1	1	0.47	95.0%	0.81	0.87	1.25	2.55
SITE CO	MPOSITE	4.25	75.3%	0.63	0.78	7.63 *	16.77 *

\* NEGLIGIBLE INCREASE IN RUNOFF DUE TO ROUTING OF RUNOFF THROUGH PROPOSED STORM INFRASTRUCTURE

	RUNOFF SUMMARY- PROPOSED CONDITION									
BASIN	DESIGN POINT	AREA (ACRES)	% IMP.	C <sub>5</sub>	C <sub>100</sub>	Q₅ (CFS)	Q <sub>100</sub> (CFS)			
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SITE CO	MPOSITE	4.25	75.3%	0.63	0.78	7.63 *	16.77*			

SCALE: 1"=30'
ALL LINEAL DIMENSIONS ARE IN U.S. SURVEY FEET

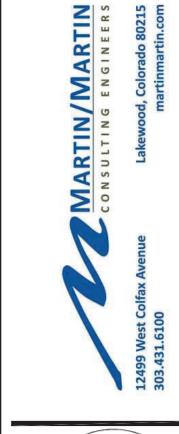



L							
	Name	N	N	N			
	Date	12/20/2024	02/28/2025	05/08/2025			
	/ Revision	CITY SUBMITTAL	ND CITY SUBMITTAL	CITY SUBMITTAL			

Sheet Number:

PR-D