

### GENERAL NOTES:

- A. See sheet CG.0 for complete list of general notes and symbol/linetype legend that apply to all sheets.
- Surface features associated with underground utilities are shown on paving plans for clarity. See applicable utility plans for construction notes and details.
- Contractor shall field verify site for existing conditions (spoils, borrow areas, etc.) prior to bidding earthwork quantities.
- Contractor to reference Architectural specifications and soils report for recommendations on building pad earthwork, concrete and asphalt sections.
- . Contractor to reference C1.1 for site dimensions

#### NOTICE TO CONTRACTORS

**INSPECTOR** 

1. AN EXCAVATION PERMIT WILL BE REQUIRED BEFORE BEGINNING ANY WORK WITHIN CITY RIGHT-OF-WAY 2. ALL WORK DETAILED ON THESE PLANS TO BE PERFORMED, EXCEPT AS OTHERWISE STATED OR PROVIDED HEREON, SHALL BE CONSTRUCTED IN ACCORDANCE WITH CITY OF ALBUQUERQUE INTERIM STANDARD SPECIFICATIONS FOR PUBLIC WORKS CONSTRUCTION, 1985. UPDATE 7 3. TWO WORKING DAYS PRIOR TO ANY EXCAVATION,

CONTRACTOR MUST CONTACT LINE LOCATING SERVICE 765-1234, FOR LOCATION OF EXISTING UTILITIES.

4. PRIOR TO CONSTRUCTION, THE CONTRACTOR SHALL EXCAVATE AND VERIFY THE HORIZONTAL AND VERTICAL LOCATIONS OF ALL CONSTRUCTIONS. SHOULD A CONFLICT EXIST, THE CONTRACTOR SHALL NOTIFY THE ENGINEER SO THAT THE CONFLICT CAN BE RESOLVED WITH A MINIMUM AMOUNT OF DELAY.

5. BACKFILL COMPACTION SHALL BE ACCORDING TO COLLECTOR STREET CLASSIFICATION USE.
6. MAINTENANCE OF THESE FACILITIES SHALL BE THE RESPONSIBILITY OF THE OWNER OF THE PROPERTY SERVED.

7. WORK ON ARTERIAL STREETS SHALL BE PERFORMED ON A 24-HOUR BASIS.

# LEGEND:

TC=25.00 FL=24.50 TOW=24.50 BOW=24.50 TOC=24.50

Top of Curb Elevation
Flowline Elevation
Top of Wall Elevation
Bottom of Wall Elevation
Top of Concrete Elevation
Top of Sidewalk Elevation


MAY 1 6 2007

HYDROLOGY SECTION

NOTE: RETAINING WALLS ARE PART OF THE BUILDING STEM WALLS AND WILL NOT EXCEED 4' IN HEIGHT.

## GRADING PLAN

0 10' 20' 40' 80 SCALE: 1"=20'

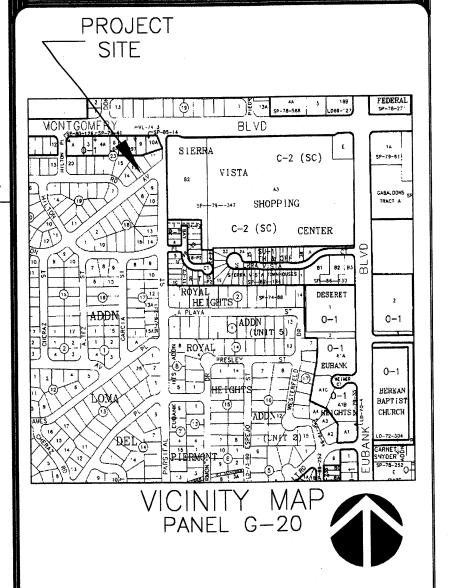

LEGAL DESCRIPTION

Lots numbered Eleven (11), Twelve (12),

Thirteen (13), and Fourteen (14) in Block

Thirteen (13), and Fourteen (14) in Block numbered Twenty—three (23) of the plat of Blocks 13 to 23 Inclusive, of THOMAS ADDITION, an addition to the City of Albquerque, New Mexico, as the same are shown and designated on the plat of said addition, filed in the office of the County Clerk of Bernalillo County, New Mexico on June 12, 1952 in Vol. C2, folio 98.

BENCH MARK


ACS BENCHMARK 12-F20-A, THE PUBLISHED

ELEVATION OF WHICH IS 5524.981 , AND IS

LOCATED IN THE CENTER MEDIAN OF

MONTGOMERY BOULEVARD NE AT THE

INTERSECTION WITH DONA MARGUERET AVENUE

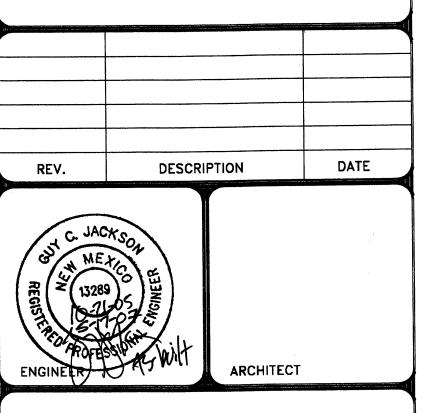

HILTON AVE. LOFTS

<sup>B</sup># 2005.03

9-6-05

GRADING PLAN

DRAWING NO.

C2.0



#### DRAINAGE PLAN

EXECUTIVE SUMMARY

THIS PROJECT, LOCATED AT THE NORTHEAST CORNER OF THE HENDRIX RD. NE & HILTON AVE. NE INTERSECTION, WILL CONSIST OF 9 SINGLE FAMILY UNITS ON APPROXIMATELY .75 ACRES. THE SITE IS CURRENTLY UNDEVELOPED, BUT IS WITHIN A LARGELY DEVELOPED INFILL AREA. THE PURPOSE OF THIS DRAINAGE PLAN IS TO OBTAIN BUILDING PERMIT ANDFINAL PLAT APPROVAL.

PROJECT DESCRIPTION

AS SHOWN ON VICINITY MAP G-20, THE SITE IS LOCATED AT THE THE NORTHEAST CORNER OF THE HENDRIX RD, NE & HILTON AVE. NE INTERSECTION. THE BOUNDARY AND TOPOGRAPHIC SURVEY WAS PREPARED BY SURVEY'S SOUTHWEST, DATEDAPRIL 2005 THE LEGAL DESCRIPTION IS SHOWN ON THIS SHEET, AS SHOWN BY PANEL 35001C 0143E OF THE NATIONAL FLOOD INSURANCE PROGRAM FLOOD INSURANCE RATE MAPS, BERNALILLO COUNTY, NEW MEXICO, AND INCORPORATED AREAS, DATED NOVEMBER 29, 2003, THIS SITE LIES WITHIN DESIGNATED FLOOD HAZARD ZONE X. ZONE X IS CHARACTERIZED BY AREAS WITHIN THE 500-YR FLOOD, AREAS OF 100-YR FLOOD WITH AVERAGE DEPTHS OF LESS THAN 1 FOOT OR WITH DRAINAGE AREAS LESS THAN 1 SQUARE MILE AND AREAS PROTECTED BY LEVEES FROM 100-YR FLOOD.

EXISTING CONDITIONS AND DRAINAGE PATTERNS

THE SITE APPEARS TO MOSTLY DRAIN FROM THE NORTHEAST TO THE SOUTHWEST INTO HILTON AVE/ HENDRIX RD, INTERSECTION WHICH CONTINUES WEST TO THE EXISTING STREET STORM DRAIN SYSTEM IN HENDRIX RD. ACCORDING TO THE USCS -SOIL SURVEY FOR BERNALILLO COUNTY, THE SITE SOILS ARE EtC (EMBUDO) WHICH ARE CLASSIFIED AS SOILS WITH SLIGHT CONSOLIDATION POTENTIAL AND A HYDROLOGIC SOIL GROUP 'B'. MARTIN VINYARD & ASSOCIATES HAS PROVIDED A SOILS REPORT FOR THIS PROJECT. THE CONTRACTOR/OWNER HAS OBTAINED THIS REPORT FOR THE CONSTRUCTION OF

THE SITE CONSISTS OF ONE ONSITE BASIN WITH THE COMBINED AREA OF 0.75 ACRE. DUE TO THE EXISTING TOPOGRAPHIC FEATURES AND EXISTING CURB AND GUTTER LOCATED IN HENDRIX RD, HILTON AVE AND PARSIFAL ST. TO THE NORTHEAST, NO OFFSITE FLOWS APPEAR TO ENTER THE SITE. ALSO, THERE IS AN EXISTING BLOCK WALL ON THE NORTH PROPERTY LINE THAT RESTRICT OFFSITE FLOWS FROM ENTERING THE SITE. THE TOTAL HISTORIC UNDEVELOPED ON-SITE 100YR-6HR RUNOFF FROM THE SITE IS 2.58 CFS.

**DEVELOPED CONDITIONS AND DRAINAGE PATTERNS** 

THE PROPOSED SITE WILL BE SPLIT INTO THREE (3) SUBBASINS. ON MAY 6, 2005, GUY JACKSON & ASSOCIATES MET WITH COA HYDROLOGY OF WHICH IS WAS DETERMINED THAT THE SMALL SITE WAS AN INFILL AREA THAT WAS ALLOWED FREE DISCHARGE INTO THE HENDRIX RD. AND HILTON AVE, RIGHT OF WAY. THE TOTAL EXISTING HISTORIC 100YR-6 HOUR EVENT DISCHARGES APPROXIMATELY

CFS INTO THE RIGHT-OF-WAYS DESCRIBED ABOVE.

PROPOSED BASIN A WILL DRAIN 0.094AC WITH AN ANTICIPATED FLOWRATE OF 0.42 CFS.AT THE REAR (NORTH EAND) OF LOTS 1, 2, 4 & 5. THIS DISCHARGE WILL ENTER THE HENDRIX RD. RIGHT OF WAY VIA TWO 24" COA SIDEWALK CULVERTS. THESE FLOWS WILL THEN CONTINUE TO SURFACE DRAIN WEST IN HILTON TO THE EXISTING STORM DRAIN SYSTEM BETWEEN ERBEE AND MOON NE. PROPOSED BASIN B WILL CONSIST OF 0.373AC WITH A DISCHARGE RATE OF 1.65 CFS, AND DRAIN SOUTH INTO HILTON AVE THESE DEVELOPED FLOWS WILL ALSO DRAIN DIRECTLY SOUTH INTO THE HILTON AVE.. RIGHT-OF-WAY, WHICH THEN COMBINE WITH FLOWS FROM BASIN A AND CONTINUE WEST IN HILTON AVE WHERE IT DRAINS INTO THE EXISTING STORM DRAIN BETWEEN ERBEE AND MOON. PROPOSED BASIN C HAS A CONTRIBUTING AREA OF 0.284ACRE AND A DISCHARGE RATE OF 1.25 CFS WHICH WILL CONTINUE TO FLOW SOUTH INTO HILTON AVE. RIGHT-OF-WAY WHERE IT JOINS BASIN A & B AND DRAINS WEST TO THE STROM DRAIN SYSTEM BETWEEN ERBEE AND MOON.

THE CALCULATIONS, WHICH ARE ATTACHED, ANALYZE BOTH THE EXISTING AND DEVELOPED CONDITIONS FOR THE 100-YEAR, 6-HOUR RAINFALL EVENT. THE PROCEDURE FOR 40-ACRE AND SMALLER BASINS, AS SET FORTH IN THE REVISION OF SECTION 22.2, HYDROLOGY OF THE DEVELOPMENT PROCESS MANUAL, VOLUME 2, DESIGN CRITERIA, DATED JANUARY, 1993, HAS BEEN USED TO QUANTIFY THE PEAK RATE OF DISCHARGE AND VOLUME OF RUNOFF GENERATED.

THE NET DEVELOPED FLOWS FROM THE PROPOSED THREE BASINS (0.42CFS + 1.65CFS +1.25CFS = 3.30 CFS FOR A TOTAL DIFFERENCE FROM HISTORIC FLOWS EQUAL TO 0.72 CFS), WHICH IS CONSIDERED NOMINAL FOR THIS SMALL INFILL DEVELOPMENT.

LEGAL DESCRIPTION


Lots numbered Eleven (11), Twelve (12), Thirteen (13), and Fourteen (14) in Block numbered Twenty—three (23) of the plat of Blocks 13 to 23 Inclusive, of THOMAS ADDITION, an addition to the City of Albquerque, New Mexico, as the same are shown and designated on the plat of said addition, filed in the office of the County Clerk of Bernalillo County, New Mexico on June 12, 1952 in Vol. C2, folio 98.

BENCH MARK

ACS BENCHMARK 12-F20-A, THE PUBLISHED ELEVATION OF WHICH IS 5524.981 , AND IS LOCATED IN THE CENTER MEDIAN OF MONTGOMERY BOULEVARD NE AT THE INTERSECTION WITH DONA MARGUERET AVENUE

DIRECTION OF FLOW PROPOSED BASIN BOUNDARY --- FLOWLINE

Flowline Elevation Top of Wall Elevation Bottom of Wall Elevation BOW = 24.50Top of Concrete Elevation TSW = 24.50Top of Sidewalk Elevation

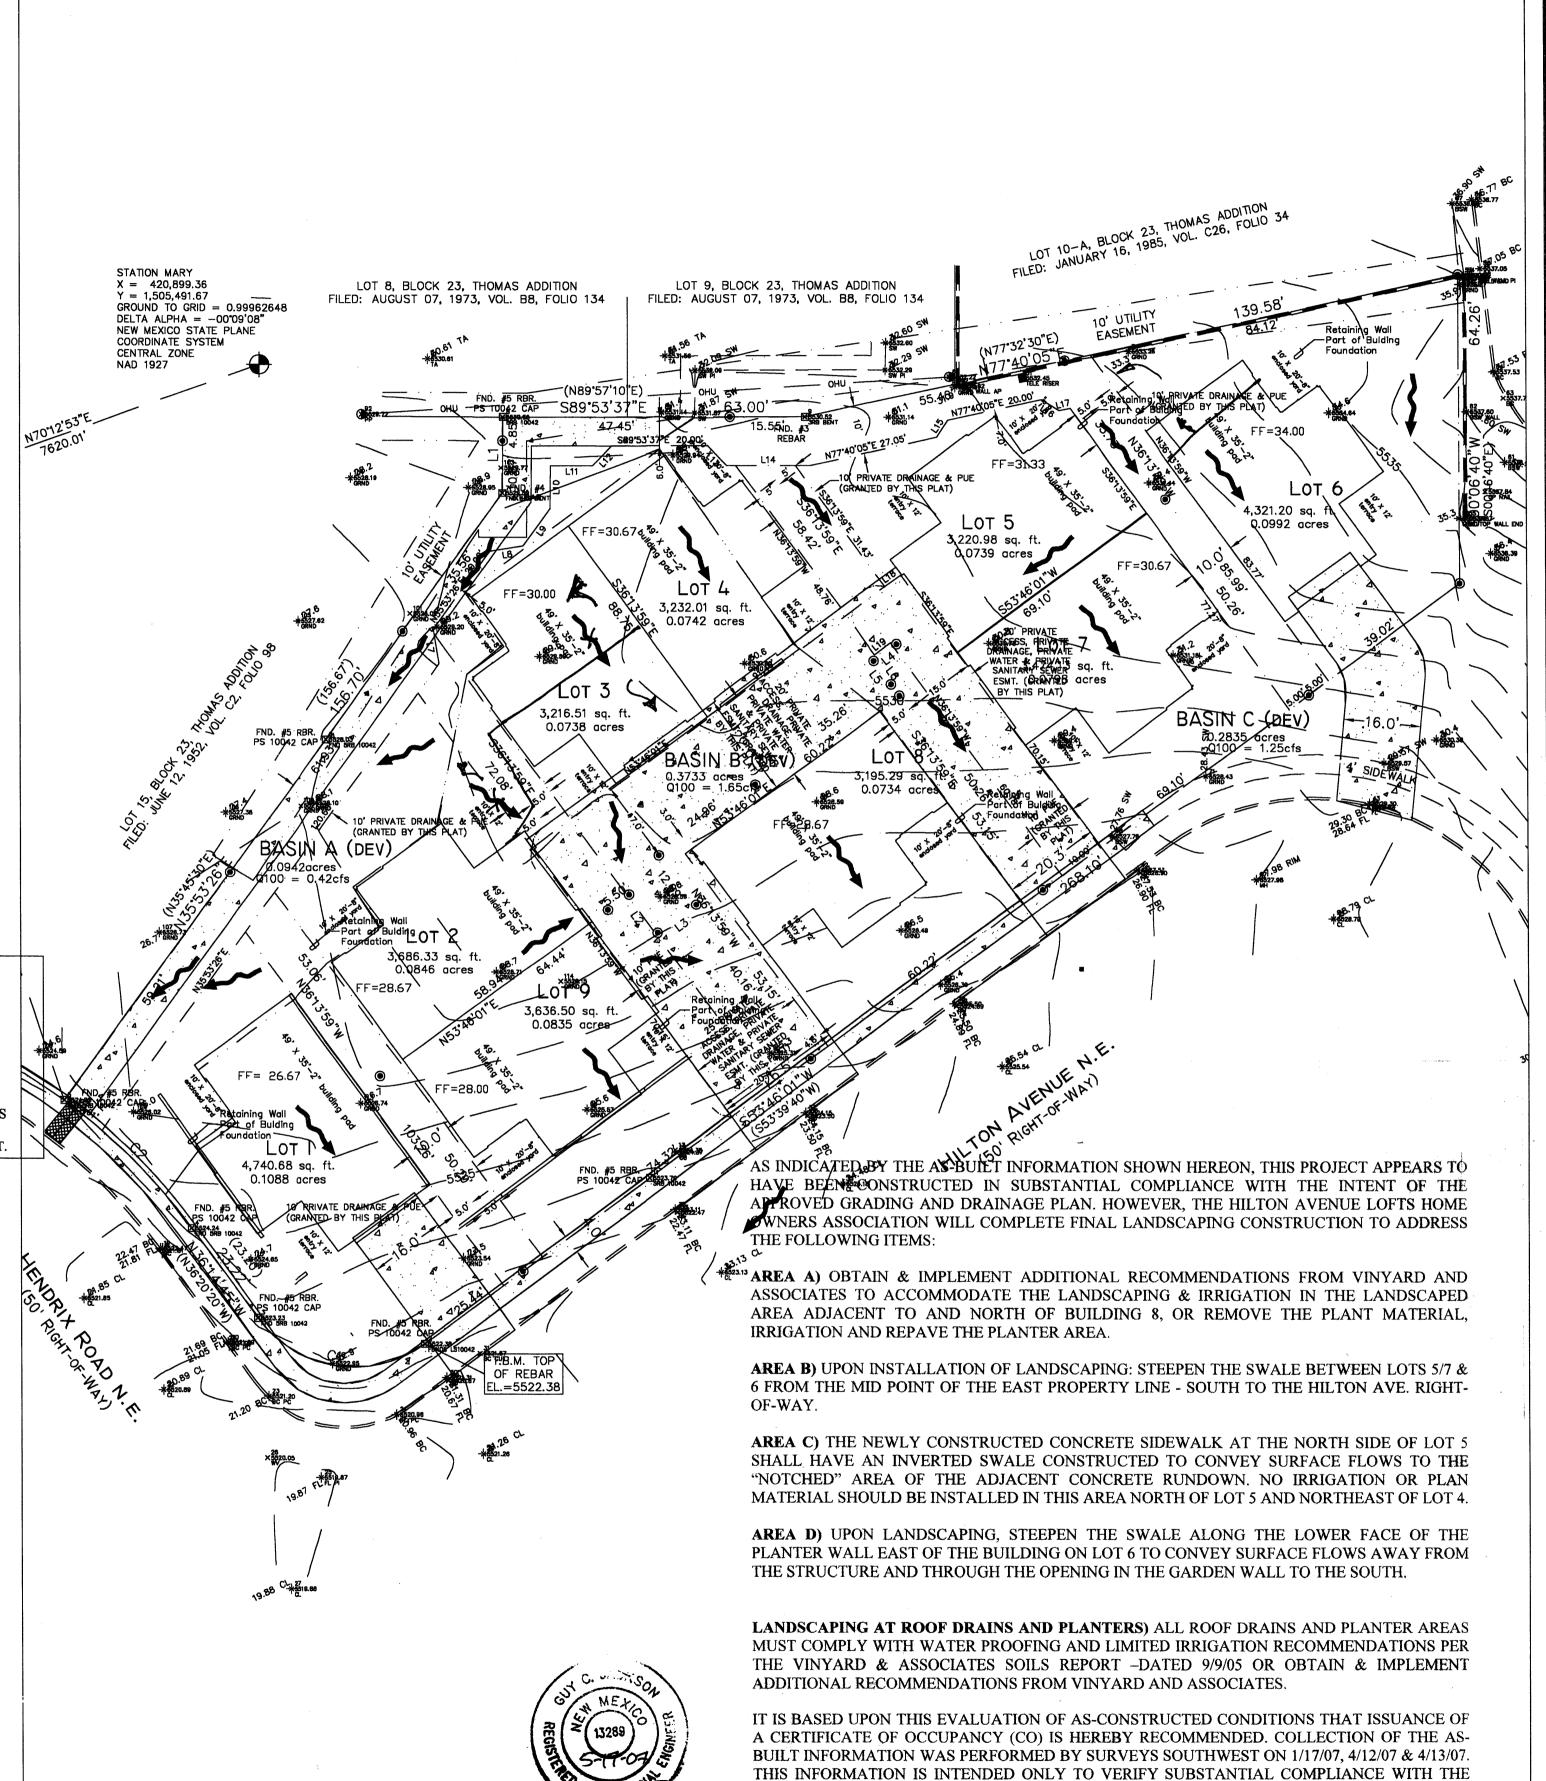

GRADING AND DRAINAGE ASPECTS OF THIS PROJECT. THIS CERTIFICATION DOES NOT

ADDRESS OR EVALUATE ADA ACCESSIBILITY ISSUES OR COMPLIANCE. THOSE RELYING ON

THIS RECORD DOCUMENT ARE ADVISED TO OBTAIN INDEPENDENT VERIFICATION OF ITS

ACCURACY BEFORE USING IT FOR ANY OTHER PURPOSE.

DRAINAGE PLAN

PROJECT

SITE

PANEL 035001C 0143E

DESCRIPTION

**ARCHITECT** 

10-21-05

HILTON AVE.

LOFTS


DRAINAGE PLAN


2005.03

DRAWING NO.

SITE

DATE

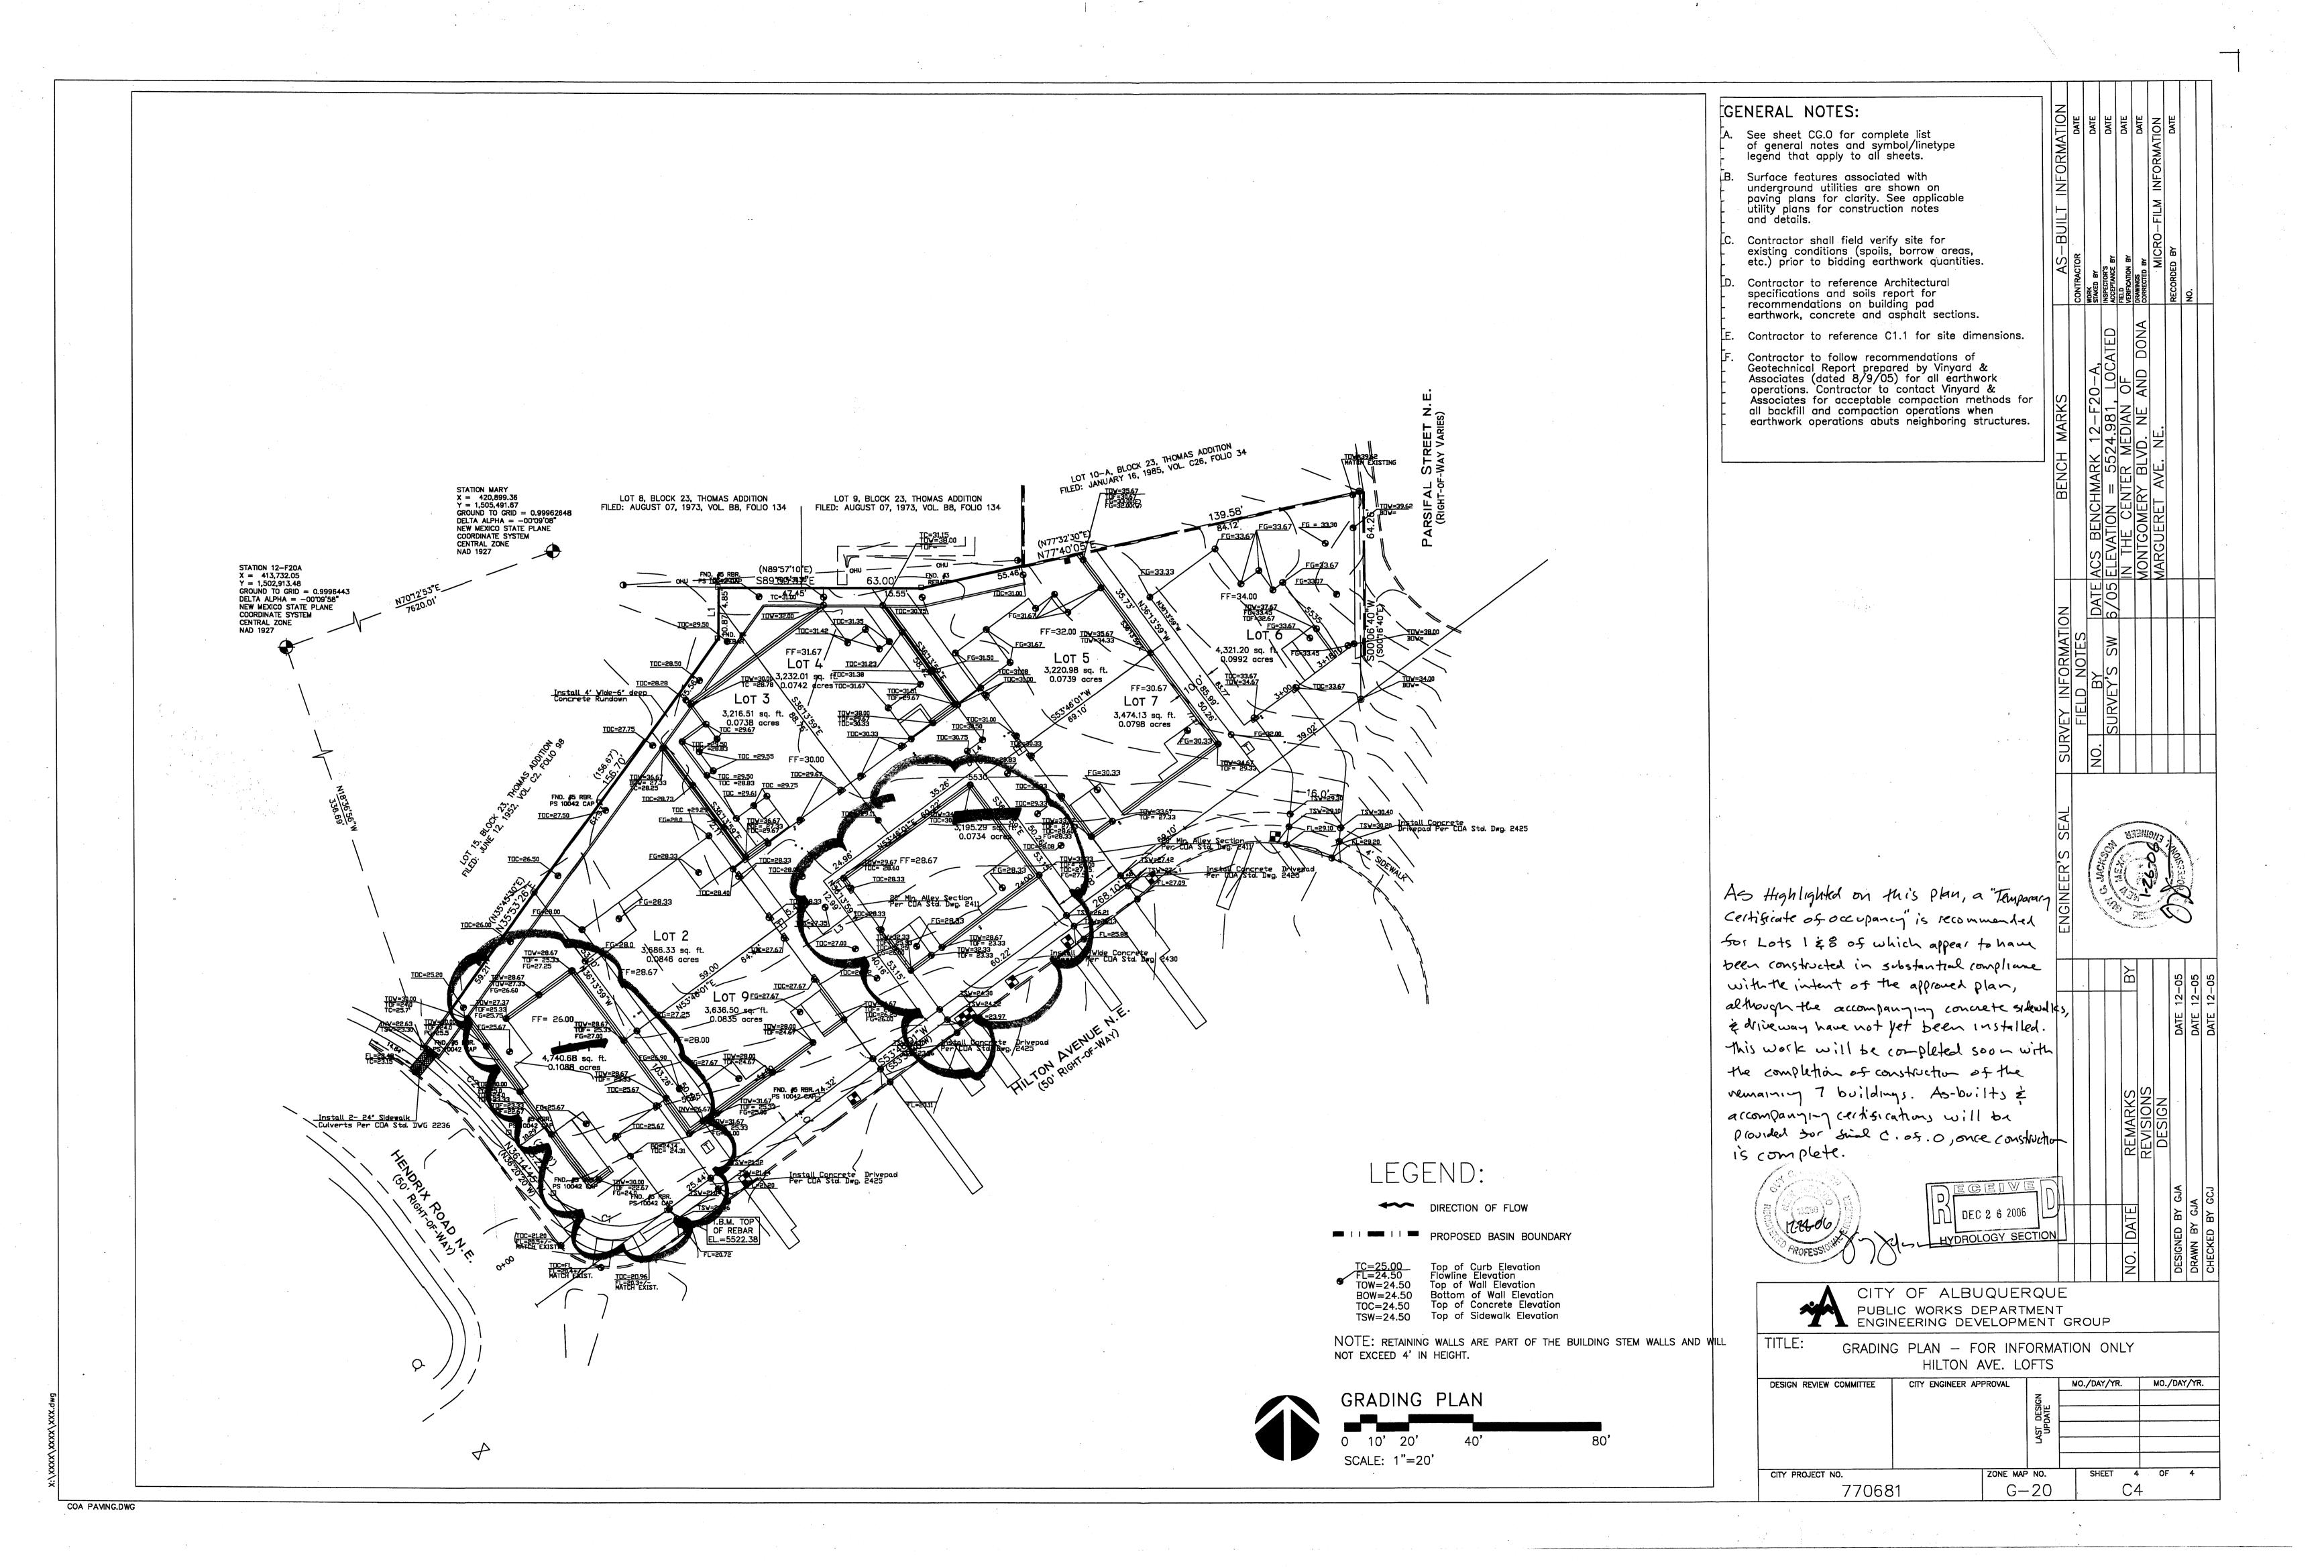


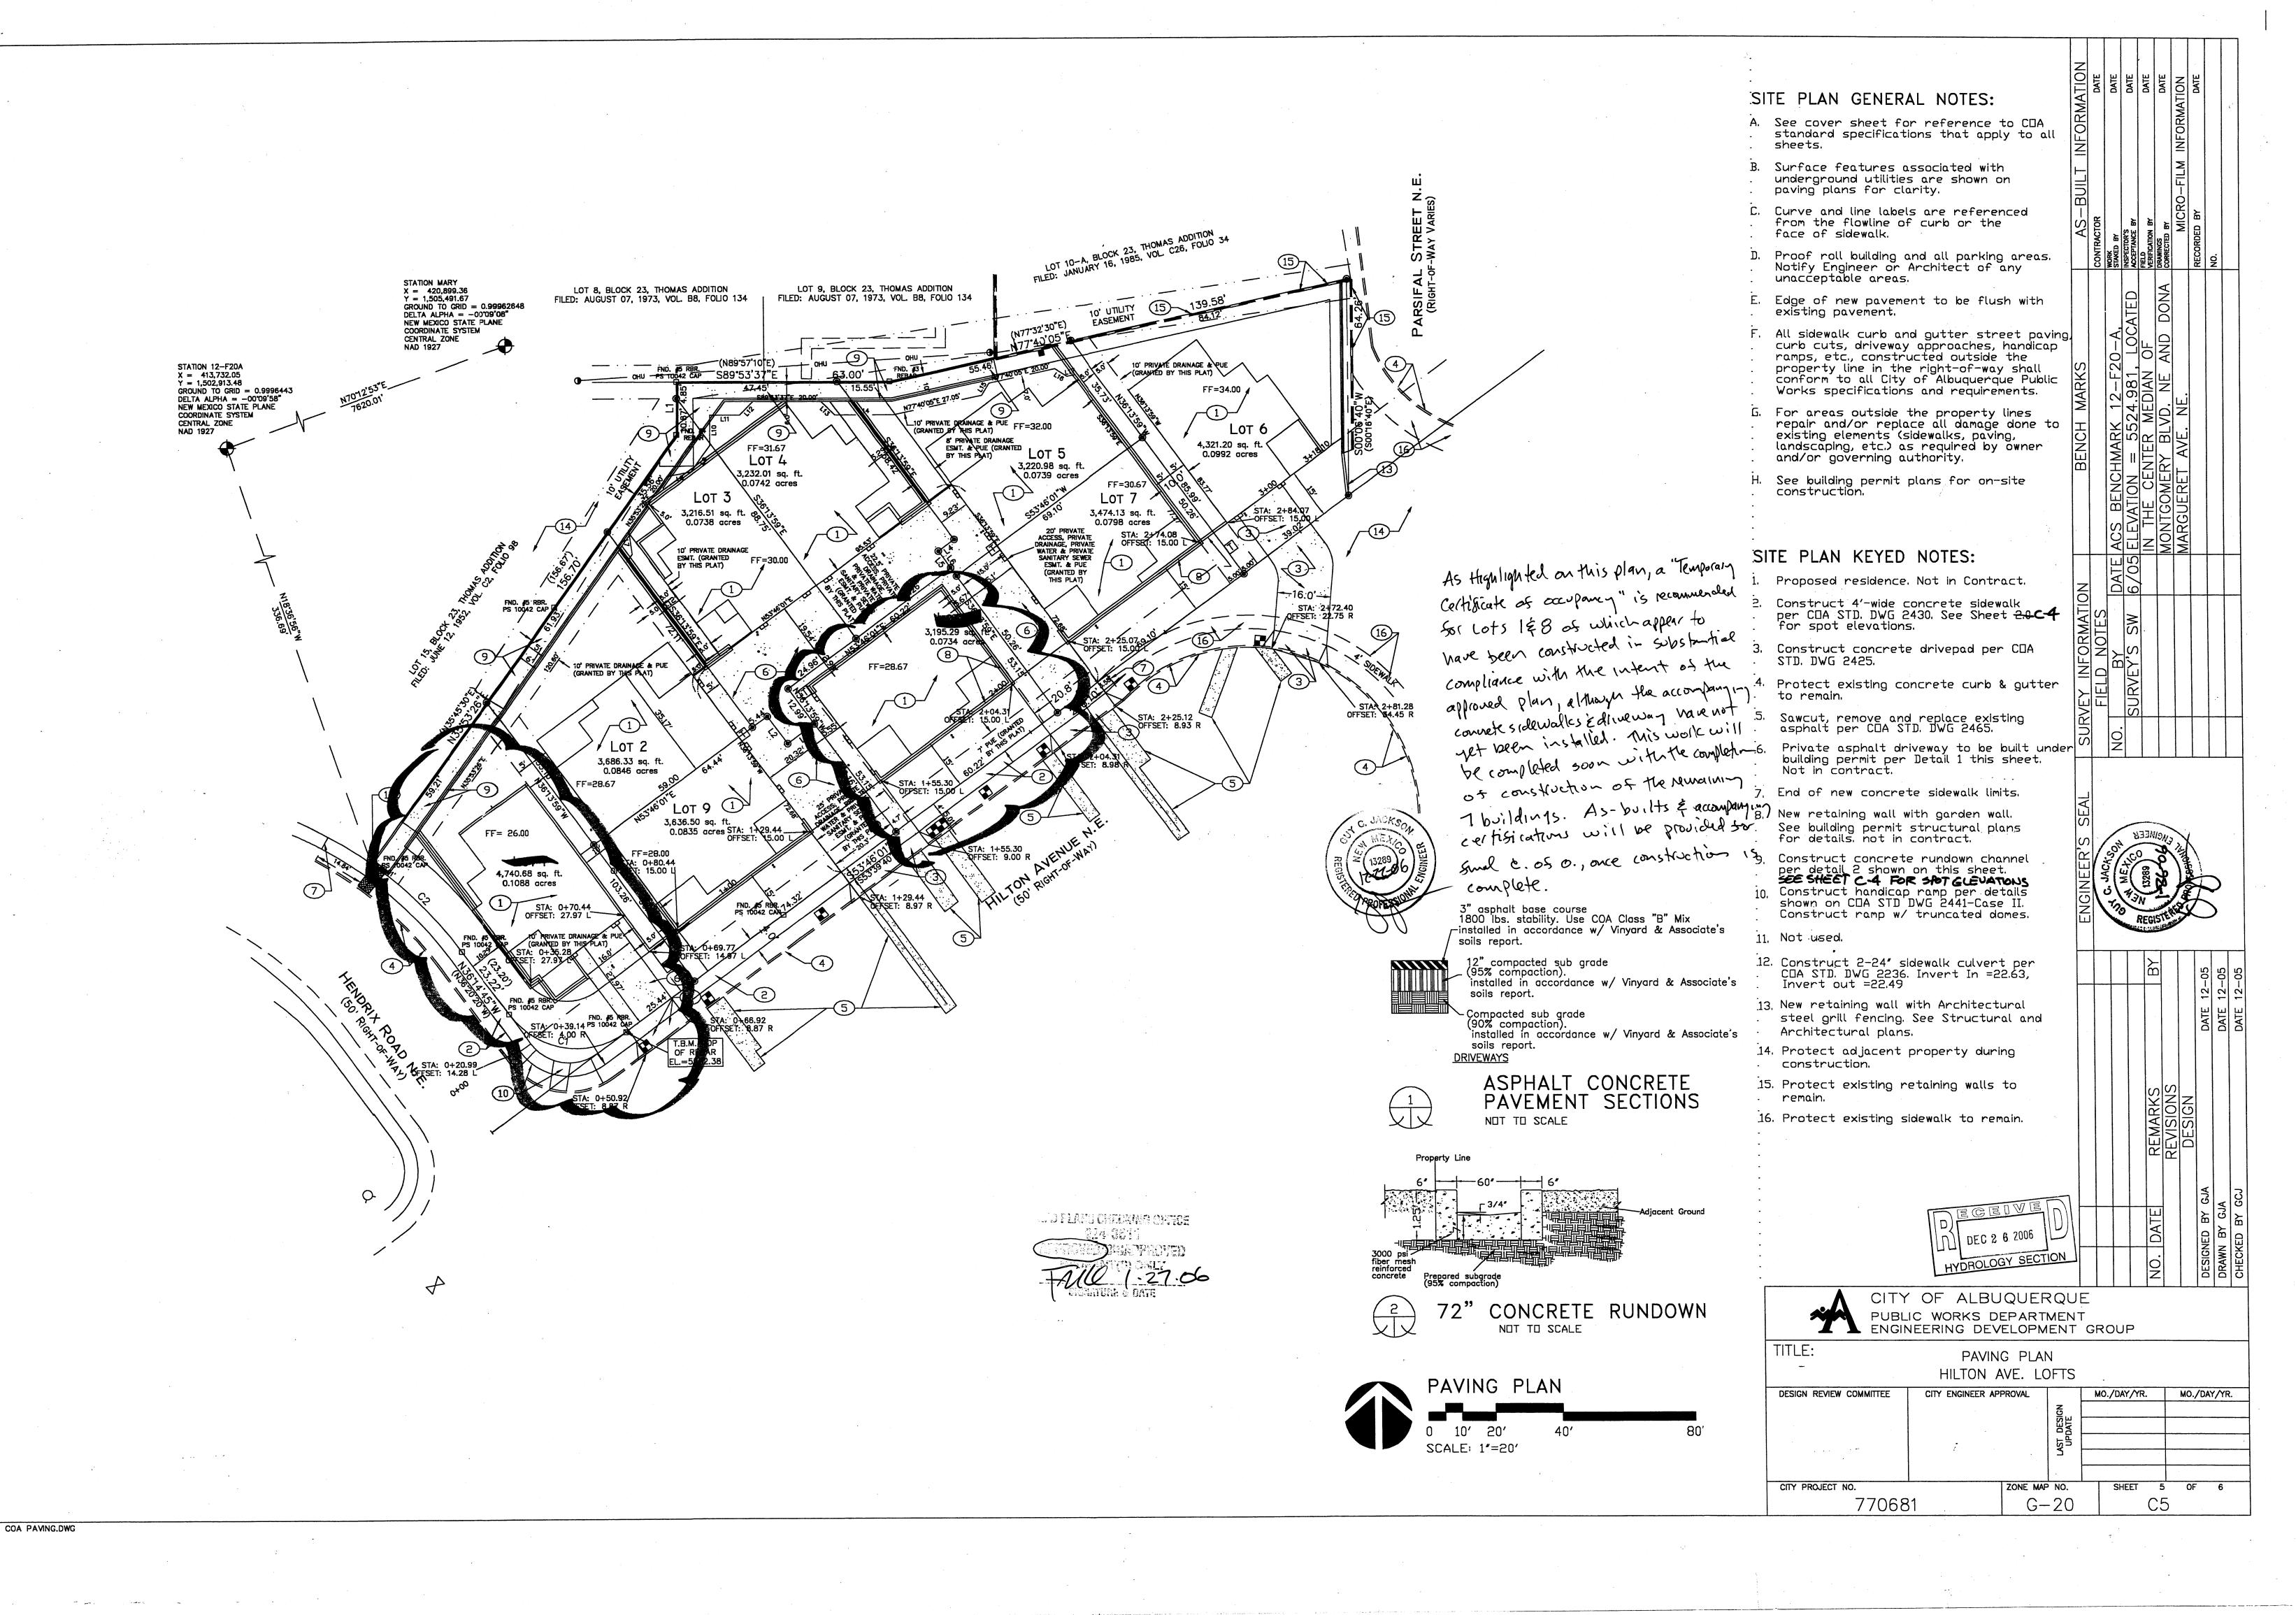



#### GENERAL NOTES:

- See sheet CG.0 for complete list of general notes and symbol/linetype legend that apply to all sheets.
- B. Surface features associated with underground utilities are shown on paving plans for clarity. See applicable utility plans for construction notes and details.
- Contractor shall field verify site for existing conditions (spoils, borrow areas, etc.) prior to bidding earthwork quantities.
- Contractor to reference Architectural specifications and soils report for recommendations on building pad earthwork, concrete and asphalt sections.
- . Contractor to reference C1.1 for site dimensions.

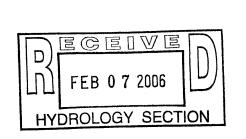

APPROVALS	NAME	DATE
INSPECTOR		

#### NOTICE TO CONTRACTORS

1. AN EXCAVATION PERMIT WILL BE REQUIRED BEFORE BEGINNING ANY WORK WITHIN CITY RIGHT-OF-WAY 2. ALL WORK DETAILED ON THESE PLANS TO BE PERFORMED, EXCEPT AS OTHERWISE STATED OR PROVIDED HEREON, SHALL BE CONSTRUCTED IN ACCORDANCE WITH CITY OF ALBUQUERQUE INTERIM STANDARD SPECIFICATIONS FOR PUBLIC WORKS CONSTRUCTION, 1985. UPDATE 7 3. TWO WORKING DAYS PRIOR TO ANY EXCAVATION, CONTRACTOR MUST CONTACT LINE LOCATING SERVICE 765-1234, FOR LOCATION OF EXISTING UTILITIES. 4. PRIOR TO CONSTRUCTION, THE CONTRACTOR SHALL EXCAVATE AND VERIFY THE HORIZONTAL AND VERTICAL LOCATIONS OF ALL CONSTRUCTIONS. SHOULD A CONFLICT EXIST, THE CONTRACTOR SHALL NOTIFY THE ENGINEER SO THAT THE CONFLICT CAN BE RESOLVED WITH A MINIMUM AMOUNT OF DELAY. 5. BACKFILL COMPACTION SHALL BE ACCORDING TO COLLECTOR STREET CLASSIFICATION USE. 6. MAINTENANCE OF THESE FACILITIES SHALL BE THE

RESPONSIBILITY OF THE OWNER OF THE PROPERTY SERVED.

7. WORK ON ARTERIAL STREETS SHALL BE PERFORMED ON A 24-HOUR BASIS.

# LEGEND:


TC=25.00
FL=24.50
TOW=24.50
BOW=24.50
TOC=24.50
TSW=24.50
Top of Curb Elevation
Flowline Elevation
Top of Wall Elevation
Top of Concrete Elevation
Top of Sidewalk Elevation

NOTE: RETAINING WALLS ARE PART OF THE BUILDING STEM WALLS AND WILL NOT EXCEED 4' IN HEIGHT.



## GRADING PLAN

0 10' 20' 40' 80 SCALE: 1"=20'

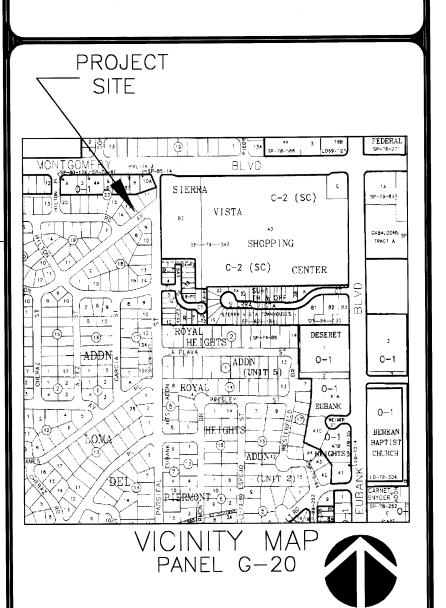


LEGAL DESCRIPTION

Lots numbered Eleven (11), Twelve (12),
Thirteen (13), and Fourteen (14) in Block
numbered Twenty—three (23) of the plat of
Blocks 13 to 23 Inclusive, of THOMAS
ADDITION, an addition to the City of
Albquerque, New Mexico, as the same are
shown and designated on the plat of said
addition, filed in the office of the County Clerk
of Bernalillo County, New Mexico on June 12,
1952 in Vol. C2, folio 98.

BENCH MARK

ACS BENCHMARK 12-F20-A, THE PUBLISHED ELEVATION OF WHICH IS 5524.981, AND IS LOCATED IN THE CENTER MEDIAN OF MONTGOMERY BOULEVARD NE AT THE INTERSECTION WITH DONA MARGUERET AVENUE NE.

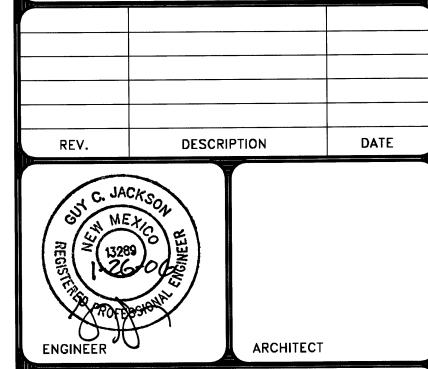

HILTON AVE.


RFB# 2005.03

9-6-05

GRADING PLAN

DRAWING NO.

C2.0

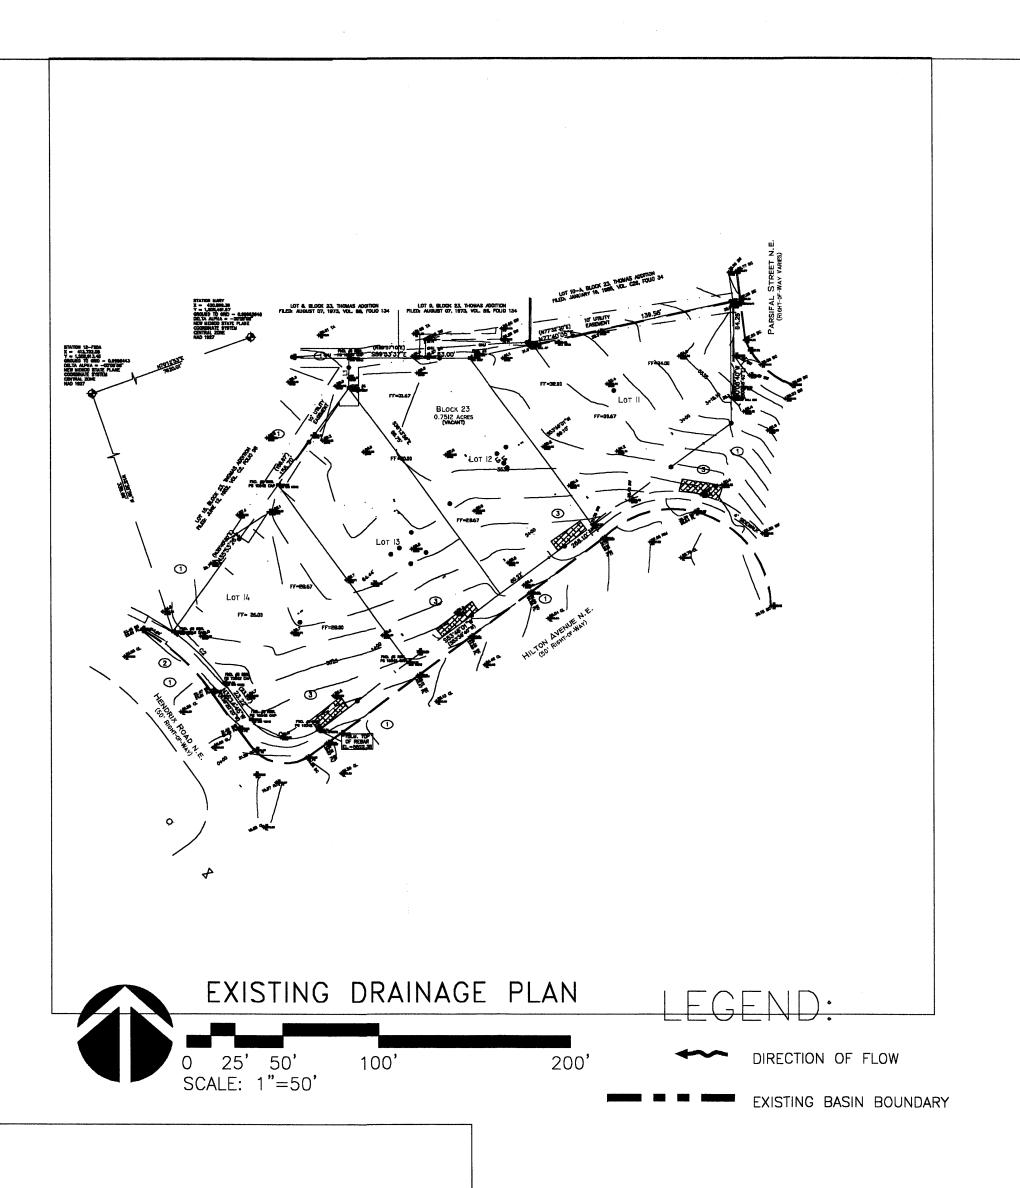

#### DRAINAGE PLAN

**EXECUTIVE SUMMARY** THIS PROJECT, LOCATED AT THE NORTHEAST CORNER OF THE HENDRIX RD. NE &

HILTON AVE. NE INTERSECTION, WILL CONSIST OF 9 SINGLE FAMILY UNITS ON APPROXIMATELY .75 ACRES. THE SITE IS CURRENTLY UNDEVELOPED, BUT IS WITHIN A LARGELY DEVELOPED INFILL AREA. THE PURPOSE OF THIS DRAINAGE PLAN IS TO OBTAIN BUILDING PERMIT ANDFINAL PLAT APPROVAL.

#### PROJECT DESCRIPTION

AS SHOWN ON VICINITY MAP G-20, THE SITE IS LOCATED AT THE THE NORTHEAST CORNER OF THE HENDRIX RD. NE & HILTON AVE. NE INTERSECTION. THE BOUNDARY AND TOPOGRAPHIC SURVEY WAS PREPARED BY SURVEY'S SOUTHWEST. DATEDAPRIL 2005 THE LEGAL DESCRIPTION IS SHOWN ON THIS SHEET. AS SHOWN BY PANEL 35001C 0143E OF THE NATIONAL FLOOD INSURANCE PROGRAM FLOOD INSURANCE RATE MAPS, BERNALILLO COUNTY, NEW MEXICO, AND INCORPORATED AREAS, DATED NOVEMBER 29, 2003, THIS SITE LIES WITHIN DESIGNATED FLOOD HAZARD ZONE X. ZONE X IS CHARACTERIZED BY AREAS WITHIN THE 500-YR FLOOD, AREAS OF 100-YR FLOOD WITH AVERAGE DEPTHS OF LESS THAN 1 FOOT OR WITH DRAINAGE AREAS LESS THAN 1 SQUARE MILE AND AREAS PROTECTED BY LEVEES FROM 100-YR FLOOD.

#### EXISTING CONDITIONS AND DRAINAGE PATTERNS THE SITE APPEARS TO MOSTLY DRAIN FROM THE NORTHEAST TO THE SOUTHWEST

INTO HILTON AVE/ HENDRIX RD. INTERSECTION WHICH CONTINUES WEST TO THE EXISTING STREET STORM DRAIN SYSTEM IN HENDRIX RD. ACCORDING TO THE USCS -SOIL SURVEY FOR BERNALILLO COUNTY, THE SITE SOILS ARE EtC (EMBUDO) WHICH ARE CLASSIFIED AS SOILS WITH SLIGHT CONSOLIDATION POTENTIAL AND A HYDROLOGIC SOIL GROUP 'B'. MARTIN VINYARD & ASSOCIATES HAS PROVIDED A SOILS REPORT FOR THIS PROJECT. THE CONTRACTOR/OWNER HAS OBTAINED THIS REPORT FOR THE CONSTRUCTION OF

THE SITE CONSISTS OF ONE ONSITE BASIN WITH THE COMBINED AREA OF 0.75 ACRE. DUE TO THE EXISTING TOPOGRAPHIC FEATURES AND EXISTING CURB AND GUTTER LOCATED IN HENDRIX RD, HILTON AVE AND PARSIFAL ST. TO THE NORTHEAST, NO OFFSITE FLOWS APPEAR TO ENTER THE SITE. ALSO, THERE IS AN EXISTING BLOCK WALL ON THE NORTH PROPERTY LINE THAT RESTRICT OFFSITE FLOWS FROM ENTERING THE SITE. THE TOTAL HISTORIC UNDEVELOPED ON-SITE 100YR-6HR RUNOFF FROM THE SITE IS 2.58 CFS.

#### DEVELOPED CONDITIONS AND DRAINAGE PATTERNS

THE PROPOSED SITE WILL BE SPLIT INTO THREE (3) SUBBASINS. ON MAY 6, 2005, GUY JACKSON & ASSOCIATES MET WITH COA HYDROLOGY OF WHICH IS WAS DETERMINED THAT THE SMALL SITE WAS AN INFILL AREA THAT WAS ALLOWED FREE DISCHARGE INTO THE HENDRIX RD. AND HILTON AVE. RIGHT OF WAY. THE TOTAL EXISTING HISTORIC 100YR-6 HOUR EVENT DISCHARGES APPROXIMATELY

## CFS INTO THE RIGHT-OF-WAYS DESCRIBED ABOVE.

PROPOSED BASIN A WILL DRAIN 0.094AC WITH AN ANTICIPATED FLOWRATE OF 0.42 CFS.AT THE REAR (NORTH EAND) OF LOTS 1, 2, 4 & 5. THIS DISCHARGE WILL ENTER THE HENDRIX RD. RIGHT OF WAY VIA TWO 24" COA SIDEWALK CULVERTS. THESE FLOWS WILL THEN CONTINUE TO SURFACE DRAIN WEST IN HILTON TO THE EXISTING STORM DRAIN SYSTEM BETWEEN ERBEE AND MOON NE. PROPOSED BASIN B WILL CONSIST OF 0.373AC WITH A DISCHARGE RATE OF 1.65 CFS. AND DRAIN SOUTH INTO HILTON AVE THESE DEVELOPED FLOWS WILL ALSO DRAIN DIRECTLY SOUTH INTO THE HILTON AVE.. RIGHT-OF-WAY, WHICH THEN COMBINE WITH FLOWS FROM BASIN A AND CONTINUE WEST IN HILTON AVE WHERE IT DRAINS INTO THE EXISTING STORM DRAIN BETWEEN ERBEE AND MOON. PROPOSED BASIN C HAS A CONTRIBUTING AREA OF 0.284ACRE AND A DISCHARGE RATE OF 1.25 CFS WHICH WILL CONTINUE TO FLOW SOUTH INTO HILTON AVE. RIGHT-OF-WAY WHERE IT JOINS BASIN A & B AND DRAINS WEST TO THE STROM DRAIN SYSTEM BETWEEN ERBEE AND MOON.

#### **CALCULATIONS**

THE CALCULATIONS, WHICH ARE ATTACHED, ANALYZE BOTH THE EXISTING AND DEVELOPED CONDITIONS FOR THE 100-YEAR, 6-HOUR RAINFALL EVENT. THE PROCEDURE FOR 40-ACRE AND SMALLER BASINS, AS SET FORTH IN THE REVISION OF SECTION 22.2, HYDROLOGY OF THE DEVELOPMENT PROCESS MANUAL, VOLUME 2, DESIGN CRITERIA, DATED JANUARY, 1993, HAS BEEN USED TO QUANTIFY THE PEAK RATE OF DISCHARGE AND VOLUME OF RUNOFF GENERATED.

#### CONCLUSION

THE NET DEVELOPED FLOWS FROM THE PROPOSED THREE BASINS (0.42CFS + 1.65CFS +1.25CFS = 3.30 CFS FOR A TOTAL DIFFERENCE FROM HISTORIC FLOWS EQUAL TO 0.72 CFS), WHICH IS CONSIDERED NOMINAL FOR THIS SMALL INFILL DEVELOPMENT.

#### LEGAL DESCRIPTION

Lots numbered Eleven (11), Twelve (12), Thirteen (13), and Fourteen (14) in Block numbered Twenty—three (23) of the plat of Blocks 13 to 23 Inclusive, of THOMAS ADDITION, an addition to the City of Albquerque, New Mexico, as the same are shown and designated on the plat of said addition, filed in the office of the County Clerk of Bernalillo County, New Mexico on June 12, 1952 in Vol. C2, folio 98.

BENCH MARK ACS BENCHMARK 12-F20-A, THE PUBLISHED ELEVATION OF WHICH IS 5524.981 , AND IS LOCATED IN THE CENTER MEDIAN OF MONTGOMERY BOULEVARD NE AT THE INTERSECTION WITH DONA MARGUERET AVENUE

DIRECTION OF FLOW

PROPOSED BASIN BOUNDARY

---- FLOWLINE

BOW = 24.50TOC = 24.50

Top of Curb Elevation Flowline Elevation Top of Wall Elevation Bottom of Wall Elevation Top of Concrete Elevation TSW=24.50 Top of Sidewalk Elevation



PROJECT

REV.

PANEL G-20

DESCRIPTION

ARCHITECT

10-21-05

HILTON AVE.

LOFTS

DRAINAGE PLAN

2005.03

DRAWING NO.

DATE

SITE -






A. See sheet CG.0 for complete list of general notes and symbol/linetype legend that apply to all sheets.

Surface features associated with underground utilities are shown on paving plans for clarity. See applicable utility plans for construction notes and details.

Contractor shall field verify site for existing conditions (spoils, borrow areas, etc.) prior to bidding earthwork quantities.

Contractor to reference Architectural specifications and soils report for recommendations on building pad earthwork, concrete and asphalt sections.

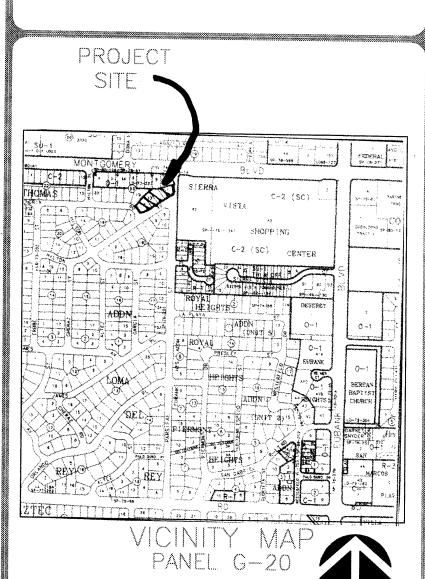

#### LEGAL DESCRIPTION

Lots numbered Eleven (11), Twelve (12), Thirteen (13), and Fourteen (14) in Block numbered Twenty-three (23) of the plat of Blocks 13 to 23 Inclusive, of THOMAS ADDITION, an addition to the City of Albquerque, New Mexico, as the same are shown and designated on the plat of said addition, filed in the office of the County Clerk of Bernalillo County, New Mexico on June 12, 1952 in Vol. C2, folio 98.

### BENCH MARK

ACS BENCHMARK 12-F20-A, THE PUBLISHED ELEVATION OF WHICH IS 5524.981 , AND IS LOCATED IN THE CENTER MEDIAN OF MONTGOMERY BOULEVARE NE AT THE INTERSECTION WITH DONA MARGUERIT AVENUE

REV.	DESCRI		
			DATE
REGISTER APPOINTS	SON BENNOW.	ARCHITECT	

HILTON AVE. LOFTS

2005.03

SEP - 7 2005

HYDROLOGY SECTION

DATE 9-6-05

GRADING PLAN

DRAWING NO.

**APPROVALS** NAME INSPECTOR

### NOTICE TO CONTRACTORS

1. AN EXCAVATION PERMIT WILL BE REQUIRED BEFORE BEGINNING ANY WORK WITHIN CITY RIGHT-OF-WAY 2. ALL WORK DETAILED ON THESE PLANS TO BE PERFORMED, EXCEPT AS OTHERWISE STATED OR PROVIDED HEREON, SHALL BE CONSTRUCTED IN ACCORDANCE WITH CITY OF ALBUQUERQUE INTERIM STANDARD SPECIFICATIONS FOR PUBLIC WORKS CONSTRUCTION, 1985. UPDATE 7 3. TWO WORKING DAYS PRIOR TO ANY EXCAVATION, CONTRACTOR MUST CONTACT LINE LOCATING SERVICE 765-1234, FOR LOCATION OF EXISTING UTILITIES. 4. PRIOR TO CONSTRUCTION, THE CONTRACTOR SHALL EXCAVATE AND VERIFY THE HORIZONTAL AND VERTICAL LOCATIONS OF ALL CONSTRUCTIONS. SHOULD A CONFLICT EXIST, THE CONTRACTOR SHALL NOTIFY THE ENGINEER SO THAT THE CONFLICT CAN BE RESOLVED WITH A MINIMUM AMOUNT OF DELAY. 5. BACKFILL COMPACTION SHALL BE ACCORDING TO COLLECTOR STREET CLASSIFICATION USE. 6. MAINTENANCE OF THESE FACILITIES SHALL BE THE RESPONSIBILITY OF THE OWNER OF THE PROPERTY 7. WORK ON ARTERIAL STREETS SHALL BE PERFORMED


DIRECTION OF FLOW

ON A 24-HOUR BASIS.


PROPOSED BASIN BOUNDARY

TC=25.00
FL=24.50
TOW=24.50
Top of Curb Elevation
Flowline Elevation
Top of Wall Elevation BOW=24.50 Bottom of Wall Elevation TOC=24.50 Top of Concrete Elevation TSW=24.50 Top of Sidewalk Elevation

NOTE: RETAINING WALLS ARE PART OF THE BUILDING STEM WALLS AND WILL NOT EXCEED 4' IN HEIGHT.

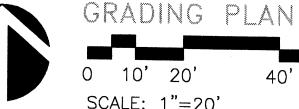

SCALE: 1"=20'

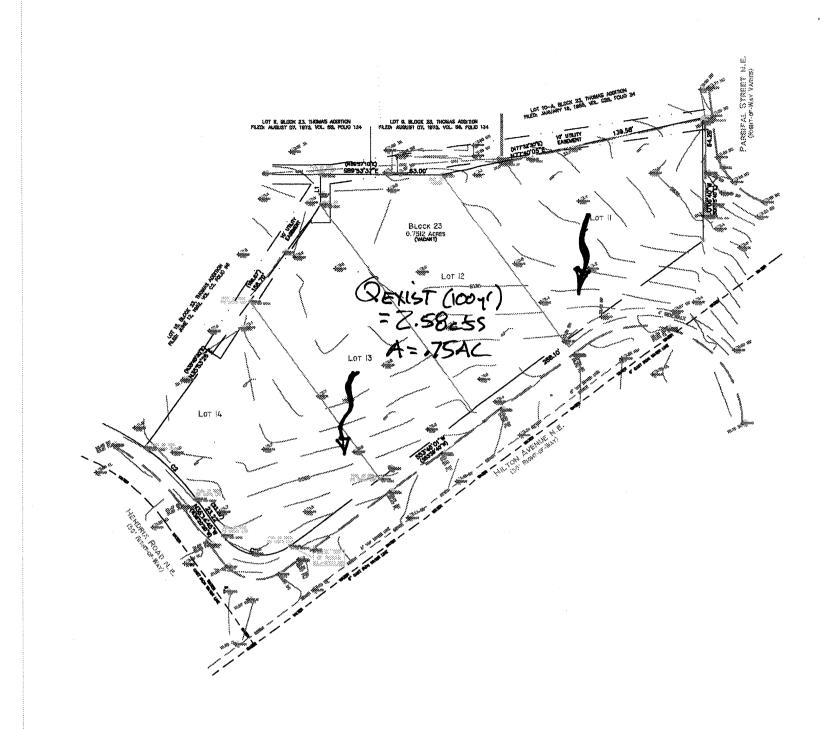



#### DRAINAGE PLAN

#### **EXECUTIVE SUMMARY**

THIS PROJECT, LOCATED AT THE NORTHEAST CORNER OF THE HENDRIX RD. NE & HILTON AVE. NE INTERSECTION, WILL CONSIST OF 9 SINGLE FAMILY UNITS ON APPROXIMATELY .75 ACRES. THE SITE IS CURRENTLY UNDEVELOPED, BUT IS WITHIN A LARGELY DEVELOPED INFILL AREA. THE PURPOSE OF THIS DRAINAGE PLAN IS TO OBTAIN PRELIMINARY AND FINAL PLAT APPROVAL.

#### PROJECT DESCRIPTION

AS SHOWN ON VICINITY MAP G-20, THE SITE IS LOCATED AT THE THE NORTHEAST CORNER OF THE HENDRIX RD. NE & HILTON AVE. NE INTERSECTION. THE BOUNDARY AND TOPOGRAPHIC SURVEY WAS PREPARED BY SURVEY'S SOUTHWEST, DATEDAPRIL 2005 THE LEGAL DESCRIPTION IS SHOWN ON THIS SHEET, AS SHOWN BY PANEL 35001C 0143E OF THE NATIONAL FLOOD INSURANCE PROGRAM FLOOD INSURANCE RATE MAPS, BERNALILLO COUNTY, NEW MEXICO, AND INCORPORATED AREAS, DATED NOVEMBER 29, 2003, THIS SITE LIES WITHIN DESIGNATED FLOOD HAZARD ZONE X. ZONE X IS CHARACTERIZED BY AREAS WITHIN THE 500-YR FLOOD, AREAS OF 100-YR FLOOD WITH AVERAGE DEPTHS OF LESS THAN 1 FOOT OR WITH DRAINAGE AREAS LESS THAN 1 SQUARE MILE AND AREAS PROTECTED BY LEVEES FROM 100-YR FLOOD.

#### EXISTING CONDITIONS AND DRAINAGE PATTERNS

THE SITE APPEARS TO MOSTLY DRAIN FROM THE NORTHEAST TO THE SOUTHWEST INTO HILTON AVE/HENDRIX RD. INTERSECTION WHICH CONTINUES WEST TO THE EXISTING STREET STORM DRAIN SYSTEM IN HENDRIX RD. ACCORDING TO THE USCS -SOIL SURVEY FOR BERNALILLO COUNTY, THE SITE SOILS ARE EtC (EMBUDO) WHICH ARE CLASSIFIED AS SOILS WITH SLIGHT CONSOLIDATION POTENTIAL AND A HYDROLOGIC SOIL GROUP 'B'. MARTIN VINYARD & ASSOCIATES HAS PROVIDED A SOILS REPORT FOR THIS PROJECT. THE CONTRACTOR/OWNER HAS OBTAINED THIS REPORT FOR THE CONSTRUCTION OF

THE SITE CONSISTS OF ONE ONSITE BASIN WITH THE COMBINED AREA OF 0.75 ACRE. DUE TO THE EXISTING TOPOGRAPHIC FEATURES AND EXISTING CURB AND GUTTER LOCATED IN HENDRIX RD, HILTON AVE AND PARSIFAL ST. TO THE NORTHEAST, NO OFFSITE FLOWS APPEAR TO ENTER THE SITE. ALSO, THERE IS AN EXISTING BLOCK WALL ON THE NORTH PROPERTY LINE THAT RESTRICT OFFSITE FLOWS FROM ENTERING THE SITE. THE TOTAL HISTORIC UNDEVELOPED ON-SITE 100YR-6HR RUNOFF FROM THE SITE IS 2.58 CFS.

#### DEVELOPED CONDITIONS AND DRAINAGE PATTERNS

THE PROPOSED SITE WILL BE SPLIT INTO THREE (3) SUBBASINS. ON MAY 6, 2005, GUY JACKSON & ASSOCIATES MET WITH COA HYDROLOGY OF WHICH IS WAS DETERMINED THAT THE SMALL SITE WAS AN INFILL AREA THAT WAS ALLOWED FREE DISCHARGE INTO THE HENDRIX RD. AND HILTON AVE. RIGHT OF WAY. THE TOTAL EXISTING HISTORIC 100YR-6 HOUR EVENT DISCHARGES APPROXIMATELY

### CFS INTO THE RIGHT-OF-WAYS DESCRIBED ABOVE.

PROPOSED BASIN A WILL DRAIN 0.094AC WITH AN ANTICIPATED FLOWRATE OF 0.42 CFS.AT THE REAR (NORTH EAND) OF LOTS 1, 2, 4 & 5. THIS DISCHARGE WILL ENTER THE HENDRIX RD. RIGHT OF WAY VIA TWO 24" COA SIDEWALK CULVERTS. THESE FLOWS WILL THEN CONTINUE TO SURFACE DRAIN WEST IN HILTON TO THE EXISTING STORM DRAIN SYSTEM BETWEEN ERBEE AND MOON NE. PROPOSED BASIN B WILL CONSIST OF 0.4.37AC WITH A DISCHARGE RATE OF 1.65 CFS. AND DRAIN SOUTH INTO HILTON AVE THESE DEVELOPED FLOWS WILL ALSO DRAIN DIRECTLY SOUTH INTO THE HILTON AVE.. RIGHT-OF-WAY, WHICH THEN COMBINE WITH FLOWS FROM BASIN A AND CONTINUE WEST IN HILTON AVE WHERE IT DRAINS INTO THE EXISTING STORM DRAIN BETWEEN ERBEE AND MOON. PROPOSED BASIN C HAS A CONTRIBUTING AREA OF 0.284ACRE AND A DISCHARGE RATE OF 1.25 CFS WHICH WILL CONTINUE TO FLOW SOUTH INTO HILTON AVE. RIGHT-OF-WAY WHERE IT JOINS BASIN A & B AND DRAINS WEST TO THE STROM DRAIN SYSTEM BETWEEN ERBEE AND MOON.

#### CALCULATIONS

THE CALCULATIONS, WHICH ARE ATTACHED, ANALYZE BOTH THE EXISTING AND DEVELOPED CONDITIONS FOR THE 100-YEAR, 6-HOUR RAINFALL EVENT. THE PROCEDURE FOR 40-ACRE AND SMALLER BASINS, AS SET FORTH IN THE REVISION OF SECTION 22.2, HYDROLOGY OF THE DEVELOPMENT PROCESS MANUAL, VOLUME 2, DESIGN CRITERIA, DATED JANUARY, 1993, HAS BEEN USED TO QUANTIFY THE PEAK RATE OF DISCHARGE AND VOLUME OF RUNOFF GENERATED.

#### CONCLUSION

THE NET DEVELOPED FLOWS FROM THE PROPOSED THREE BASINS (0.42CFS + 1.65CFS +1.25CFS = 3.30 CFS FOR A TOTAL DIFFERENCE FROM HISTORIC FLOWS EQUAL TO 0.72 CFS), WHICH IS CONSIDERED NOMINAL FOR THIS SMALL INFILL DEVELOPMENT.

#### LEGAL DESCRIPTION

Lots numbered Eleven (11), Twelve (12), Thirteen (13), and Fourteen (14) in Block numbered Twenty—three (23) of the plat of Blocks 13 to 23 Inclusive, of THOMAS ADDITION, an addition to the City of Albquerque, New Mexico, as the same are shown and designated on the plat of said addition, filed in the office of the County Clerk of Bernalillo County, New Mexico on June 12, 1952 in Vol. C2, folio 98.

# BENCH MARK ACS BENCHMARK 12-F20-A, THE PUBLISHED

ELEVATION OF WHICH IS 5524.981 , AND IS LOCATED IN THE CENTER MEDIAN OF MONTGOMERY BOULEVARE NE AT THE INTERSECTION WITH DONA MARGUERIT AVENUE

DIRECTION OF FLOW PROPOSED BASIN BOUNDARY --- FLOWLINE

TOC = 24.50

TSW = 24.50

Top of Curb Elevation Flowline Elevation Top of Wall Elevation Bottom of Wall Elevation Top of Concrete Elevation Top of Sidewalk Elevation



PROJEC"

PANEL 035001C 0143E

REV.

2005.03

DRAWING NO.

N.T.S.

DESCRIPTION

ARCHITECT

9/5/05

HILTON AVE.

DRAINAGE PLAN

DATE