# CITY OF ALBUQUERQUE

Planning Department Alan Varela, Director



May 30, 2023

Jay G. Miller, P.E. Tierra West, LLC 5571 Midway Park Place NE Albuquerque, NM, 87109

RE: Juan Tabo Business Park Subdivision Conceptual Grading & Drainage Plans Engineer's Stamp Date: 04/26/23

**Hydrology File: G21D021** 

Dear Mr. Miller:

Based upon the information provided in your submittal received 04/27/2023, the Conceptual Grading & Drainage Plans are preliminary approved for action by the Development Hearing

Officer (DHO) on Preliminary/Final Plat.

If the project total area of disturbance (including the staging area and any work within the adjacent Right-of-Way) is 1 acre or more, then an Erosion and Sediment Control (ESC) Plan and

Owner's certified Notice of Intent (NOI) is required to be submitted to the Stormwater Quality

Engineer (Doug Hughes, PE, jhughes@cabq.gov, 924-3420) 14 days prior to any earth

NM 87103 disturbance.

If you have any questions, please contact me at 924-3995 or rbrissette@cabq.gov.

www.cabq.gov

PO Box 1293

Albuquerque

Sincerely,

Renée C. Brissette, P.E. CFM Senior Engineer, Hydrology

Renée C. Brissette

Planning Department




# **City of Albuquerque**

#### Planning Department

Development & Building Services Division

#### DRAINAGE AND TRANSPORTATION INFORMATION SHEET

Project Title: Juan Tabo Business Park Br	uilding Permit #	Hydrology File #
DRB#	EPC#	
Legal Description: 5 SUB'D PLAT MAP FOR JUBUSINESS PARK CONT 0.73	AN TABO City Address O	R Parcel 102106048638710395
Applicant/Agent: TIERRA WEST LLC	Contact: JAY [	MILLER
Address: 5571 Midway Park Place NE Albuquerque, NM	87109 <b>Phone:</b> (505	5) 858-3100
Email: JMILLER@TIERRAWESTLLC.COM		
Applicant/Owner	Contact	
Applicant/Owner:		
Address:		
Email:		
The second of th	) DEGIDENICE DDE	, GITE <b>X</b> , D) (D) GITE
TYPE OF DEVELOPMENT: PLAT (#of lots	)RESIDENCEDRB	SSITE 🔼 ADMIN SITE:
RE-SUBMITTAL:YES X NO		
	V	
<b>DEPARTMENT:</b> TRANSPORTATION	HYDROLOGY/D	RAINAGE
Check all that apply:		
TYPE OF SUBMITTAL:	TYPE OF APPROVAL	/ACCEPTANCE SOUGHT:
ENGINEER/ARCHITECT CERTIFICATION	BUILDING PI	ERMIT APPROVAL
PAD CERTIFICATION	CERTIFICAT	E OF OCCUPANCY
XCONCEPTUAL G&D PLAN	CONCEPTUA	L TCL DRB APPROVAL
GRADING PLAN	<b>X</b> PRELIMINAR	Y PLAT APPROVAL
DRAINAGE REPORT	SITE PLAN F	OR SUB'D APPROVAL
DRAINAGE MASTER PLAN	SITE PLAN F	OR BLDG PERMIT APPROVAL
FLOOD PLAN DEVELOPMENT PERMIT APP	FINAL PLAT	APPROVAL
ELEVATION CERTIFICATE	SIA/RELEASI	E OF FINANCIAL GUARANTEE
CLOMR/LOMR	FOUNDATIO	N PERMIT APPROVAL
TRAFFIC CIRCULATION LAYOUT (TCL)	GRADING PE	RMIT APPROVAL
ADMINISTRATIVE	SO-19 APPRO	OVAL
TRAFFIC CIRCULATION LAYOUT FOR DRE	PAVING PER	MIT APPROVAL
APPROVAL	GRADING PA	D CERTIFICATION
TRAFFIC IMPACT STUDY (TIS)	WORK ORDE	R APPROVAL
STREET LIGHT LAYOUT	CLOMR/LOM	R
OTHER (SPECIFY)	FLOOD PLAN	DEVELOPMENT PERMIT
PRE-DESIGN MEETING?	OTHER (SPEC	CIFY)
DATE SUBMITTED: 04.27.2023		

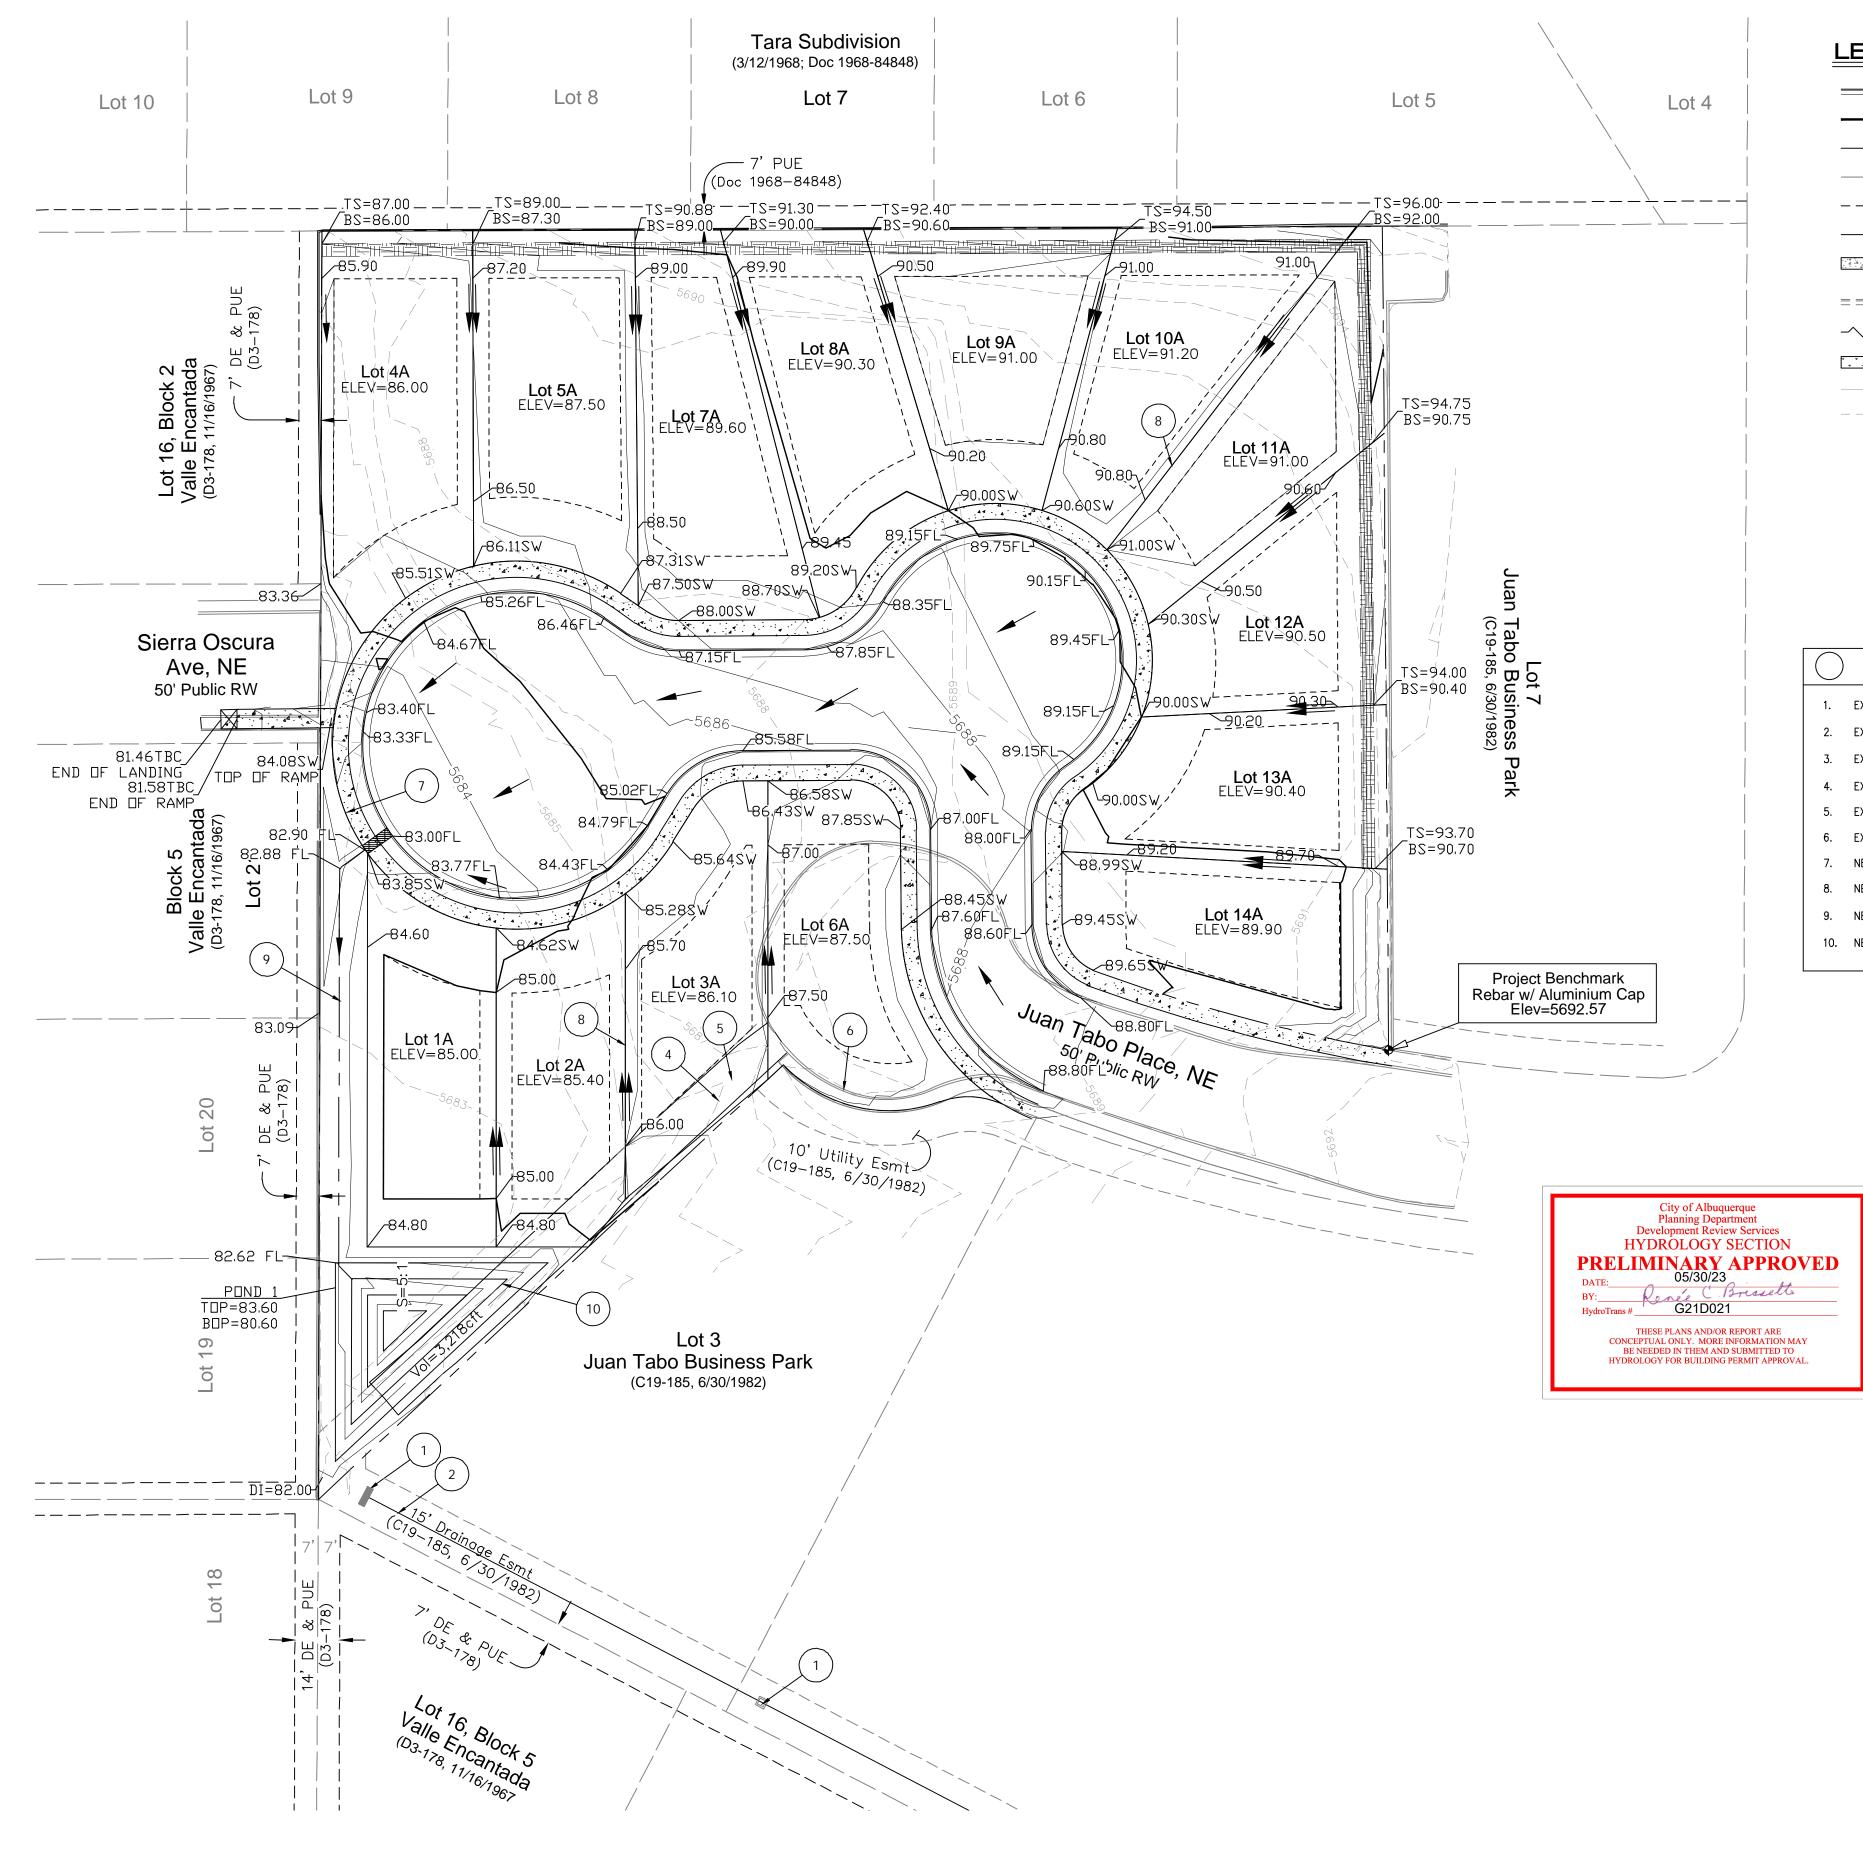


## LEGEND

CURB & GUTTER BOUNDARY LINE ---- RIGHT-OF-WAY PROPOSED SIDEWALK ======= EXISTING CURB & GUTTER LANDSCAPING EXISTING INDEX CONTOUR ---- EXISTING CONTOUR **→** FLOW



# **KEYED NOTES**

- EXISTING CONCRETE DROP INLET.
- 2. EXISTING 24" dia. CMP STORM DRAIN CULVERT.
- 3. EXISTING OUTFALL INTO EMBUDITO ARROYO (CONCRETE LINED CHANNEL).
- 4. EXISTING 15' WIDE DRAINAGE EASEMENT TO BE ABANDONED.
- 5. EXISTING ASPHALT SWALE TO BE OBLITERATED.
- 6. EXISTING CUL-DE-SAC ROW TO BE REPLATTED.
- 7. NEW ROW TO BE DEDICATED AS PUBLIC ROW.
- 8. NEW LOT LINES TO BE CREATED BY PRELIMINARY PLAT.
- 9. NEW 15' WIDE DRAINAGE EASEMENT & ASPHALT LINED SWALE.
- 10. NEW STORM WATER QUALITY RETENTION POND (VOLUME=3,218cft).

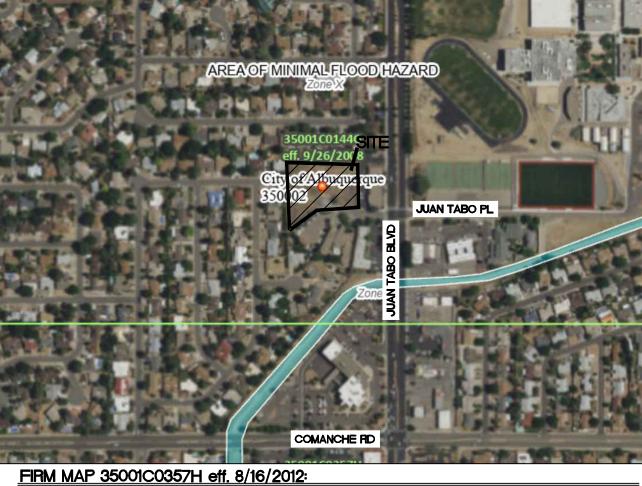

# NOTICE TO CONTRACTORS

- 1. AN EXCAVATION/CONSTRUCTION PERMIT WILL BE REQUIRED BEFORE BEGINNING ANY WORK WITHIN CITY RIGHT-OF-WAY.
- 2. ALL WORK DETAILED ON THESE PLANS TO BE PERFORMED, EXCEPT AS OTHERWISE STATED OR PROVIDED HERON, SHALL BE CONSTRUCTED IN ACCORDANCE WITH CITY OF ALBUQUERQUE STANDARD SPECIFICATIONS FOR PUBLIC WORKS CONSTRUCTION.
- 3. TWO WORKING DAYS PRIOR TO ANY EXCAVATION, CONTRACTOR MUST CONTACT LINE LOCATING SERVICE. 765-1234, FOR LOCATION OF EXISTING UTILITIES.
- 4. PRIOR TO CONSTRUCTION, THE CONTRACTOR SHALL EXCAVATE AND VERIFY THE HORIZONTAL AND VERTICAL LOCATIONS OF ALL CONNECTIONS. SHOULD A CONFLICT EXIST, THE CONTRACTOR SHALL NOTIFY THE ENGINEER SO THAT THE CONFLICT CAN BE RESOLVED WITH A MINIMUM AMOUNT OF DELAY.
- 5. BACKFILL COMPACTION SHALL BE ACCORDING TO TRAFFIC/STREET USE.
- 6. MAINTENANCE OF THESE FACILITIES SHALL BE THE RESPONSIBILITY OF THE OWNER OF THE PROPERTY
- 7. WORK ON ARTERIAL STREETS SHALL BE PERFORMED ON A 24-HOUR BASIS.


# NOTE

ADD 5600 TO ALL SPOT ELEVATIONS

ELEVATIONS ARE TO FLOWLINE UNLESS OTHERWISE NOTED

## EROSION CONTROL NOTES:

- CONTRACTOR IS RESPONSIBLE FOR OBTAINING A TOPSOIL DISTURBANCE PERMIT PRIOR TO BEGINNING WORK.
- 2. CONTRACTOR IS RESPONSIBLE FOR MAINTAINING RUN-OFF ON SITE DURING CONSTRUCTION.
- 3. CONTRACTOR IS RESPONSIBLE FOR CLEANING ALL SEDIMENT THAT GETS INTO EXISTING RIGHT-OF-WAY.
- 4. REPAIR OF DAMAGED FACILITIES AND CLEANUP OF SEDIMENT ACCUMULATIONS ON ADJACENT PROPERTIES AND IN PUBLIC FACILITIES IS THE RESPONSIBILITY OF THE
- 5. ALL EXPOSED EARTH SURFACES MUST BE PROTECTED FROM WIND AND WATER EROSION PRIOR TO FINAL (CITY) ACCEPTANCE OF ANY PROJECT.
- 6. ALL SLOPES NOT STABILIZED AT THE END OF THE PROJECT SHALL BE STABILIZED IN ACCORDANCE WITH THE CITY OF ALBUQUERQUE SPECS OR 3" GRAVEL

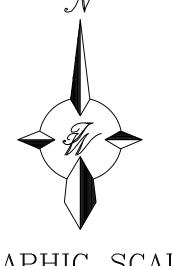

SCALE: 1"=30'

GRAPHIC SCALE

ENGINEER'S SEAL ( <del>~</del> (14505) ~ JAY G. MILLER www.tiérrawestllc.com P.E. #14505

DRAWN BY JUAN TABO BUSINESS PARK ALBUQUERQUE, NM DATE 04-26-2023 CONCEPTUAL GRADING AND DRAINAGE DRAWING SHEET # GR-1 TIERRA WEST, LLC 5571 MIDWAY PARK PL NE ALBUQUERQUE, NEW MEXICO 87109 (505) 858-3100


JOB #

2022122

### 1. ADD 5600 TO ALL SPOT ELEVATIONS 2. ELEVATIONS ARE TO FLOWLINE UNLESS OTHERWISE NOTED CAUTION

NOTES

ALL EXISTING UTILITIES SHOWN WERE OBTAINED FROM RESEARCH, AS-BUILTS, SURVEYS OR INFORMATION PROVIDED BY OTHERS. IT SHALL BE THE SOLE RESPONSIBILITY OF THE CONTRACTOR TO CONDUCT ALL NECESSARY FIELD INVESTIGATIONS PRIOR TO AND INCLUDING ANY EXCAVATION, TO DETERMINE THE ACTUAL LOCATION OF UTILITIES AND OTHER IMPROVEMENTS, PRIOR TO STARTING THE WORK. ANY CHANGES FROM THIS PLAN SHALL BE COORDINATED WITH AND APPROVED BY THE ENGINEER.

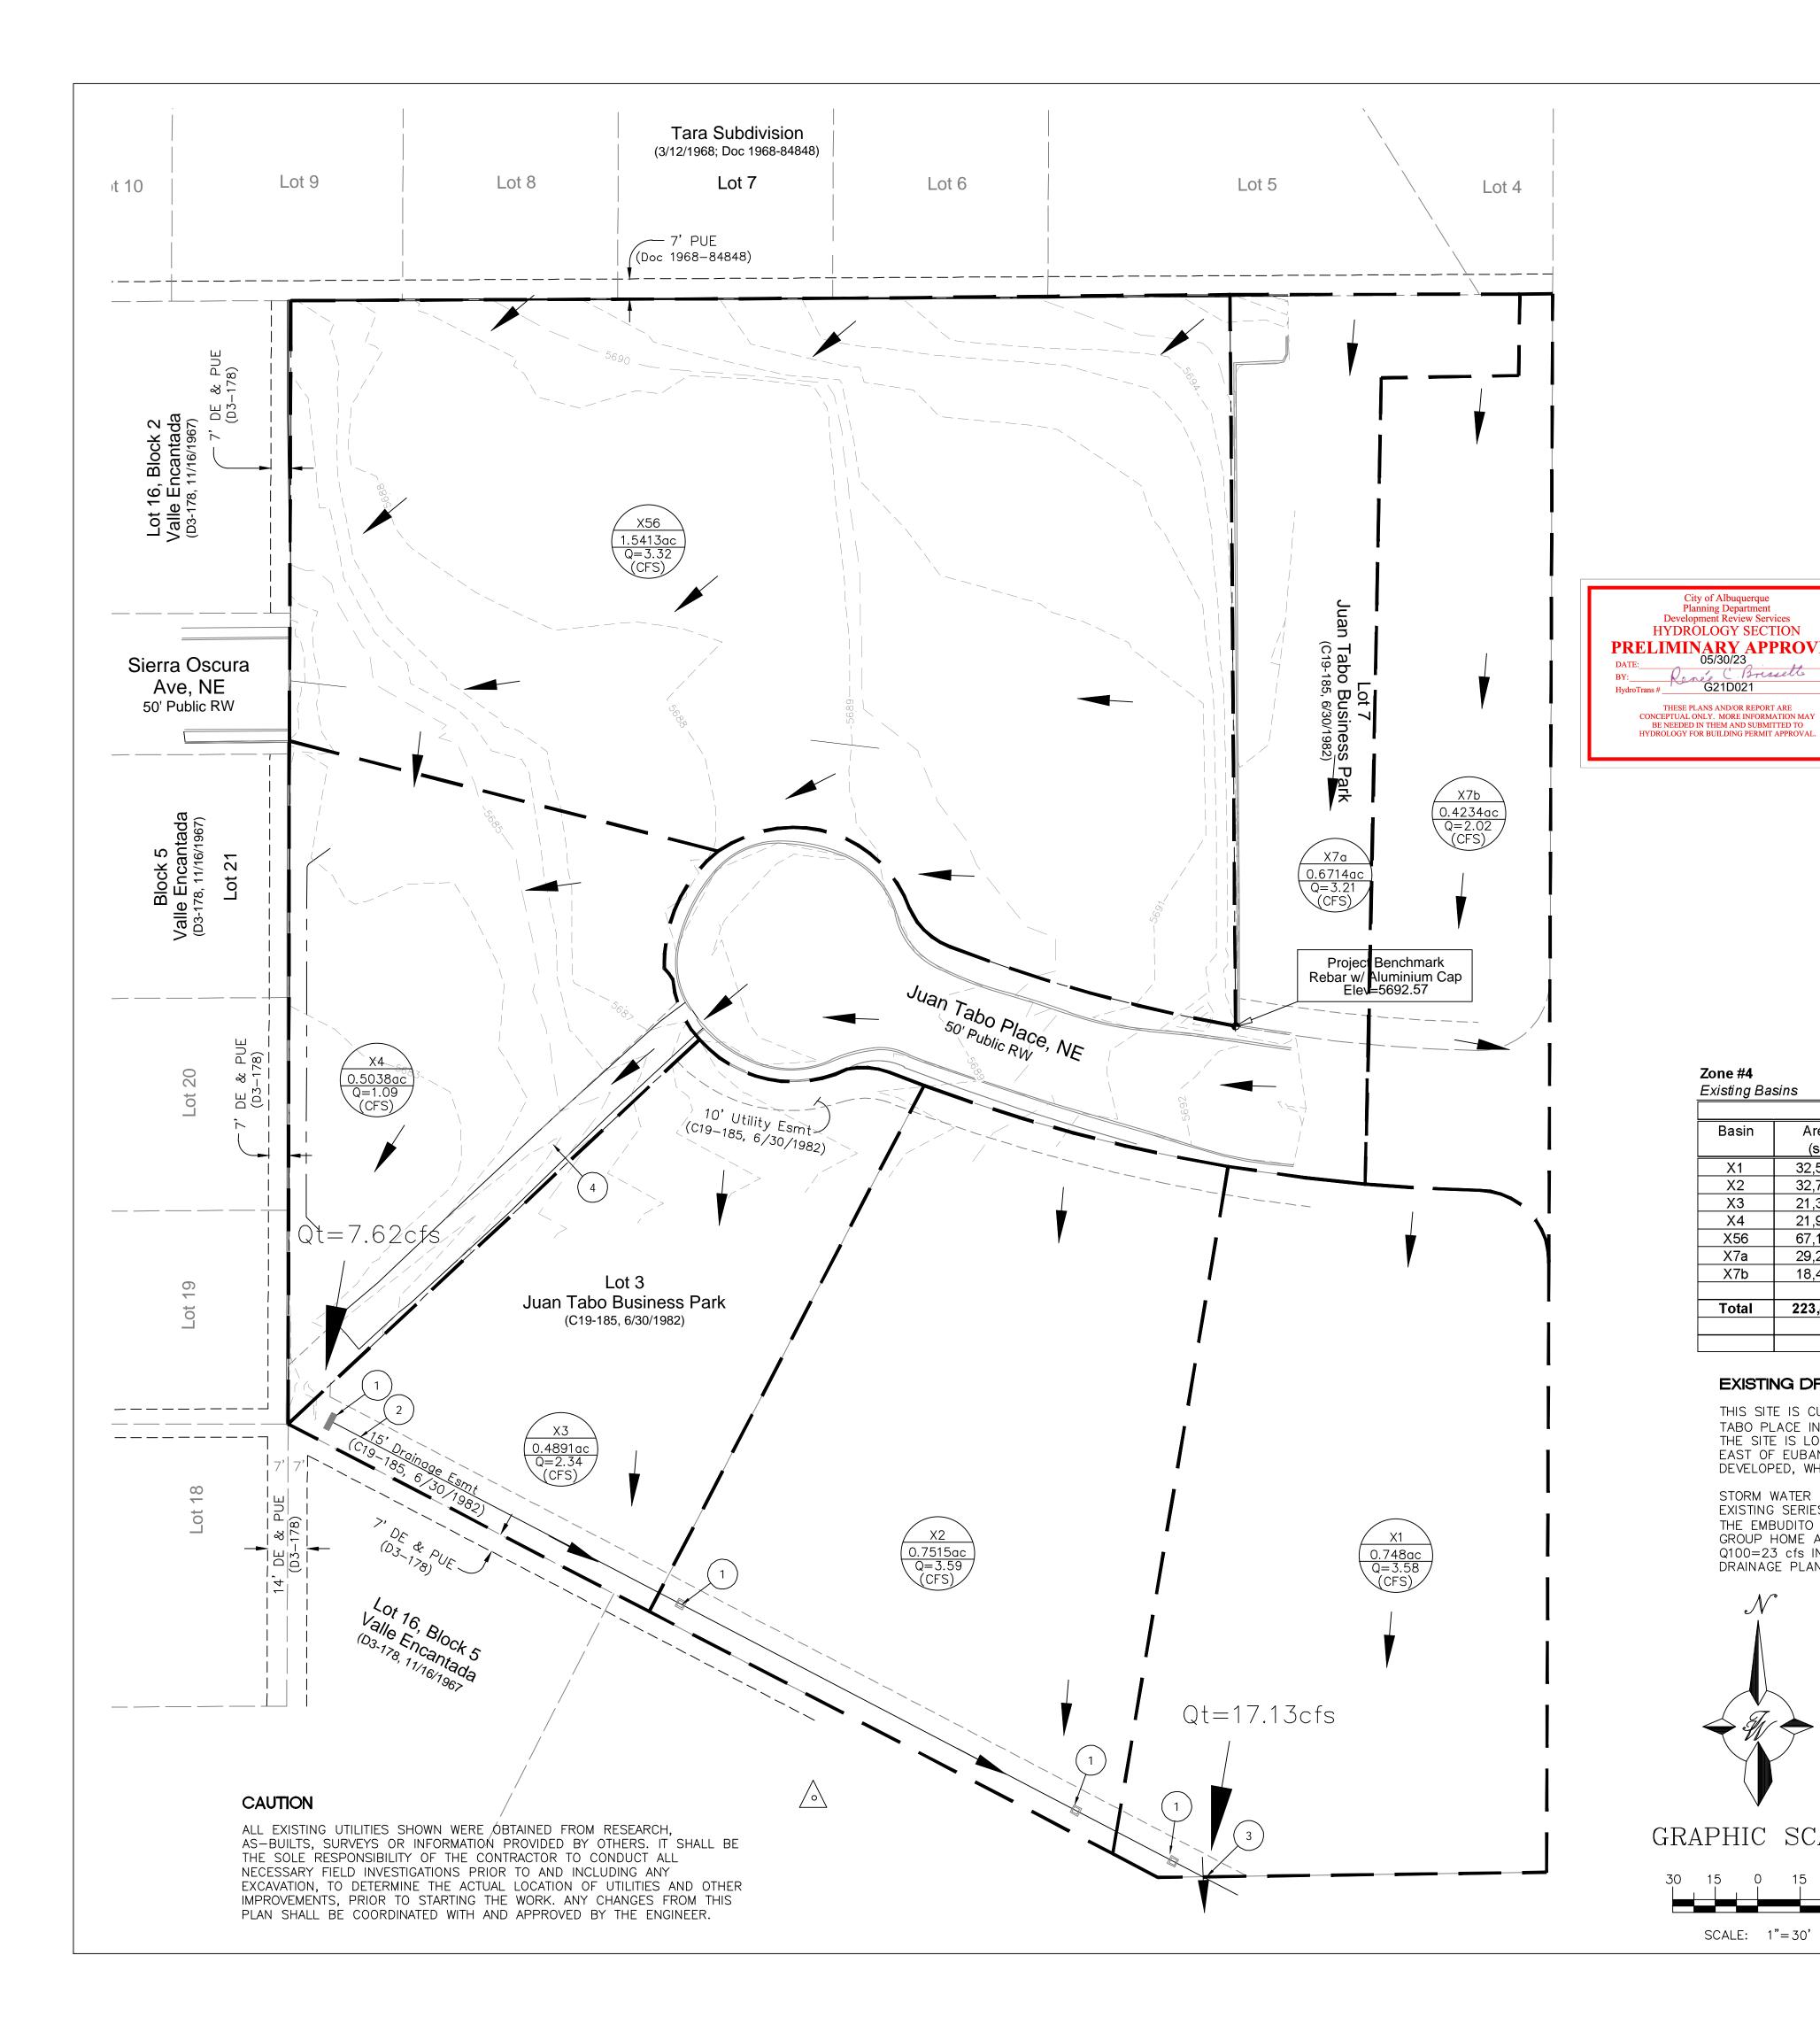

# LEGEND

CURB & GUTTER BOUNDARY LINE ---- RIGHT-OF-WAY PROPOSED SIDEWALK ======== EXISTING CURB & GUTTER

->>>> WATER BLOCK LANDSCAPING LANDSCAPING

> EXISTING INDEX CONTOUR EXISTING CONTOUR

# **KEYED NOTES**

- EXISTING CONCRETE DROP INLET.
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- 3. EXISTING OUTFALL INTO EMBUDITO ARROYO (CONCRETE LINED CHANNEL).
- 4. EXISTING ASPHALT LINED CHANNEL.

# JUAN TABO BUSINESS PARK

# Weighted E Method

FIRM MAP 35001C0357H eff. 8/16/2012:

#### Zone #4 Existing Basins


a Area ) (acres 84 0.7480 34 0.7515 07 0.489	0.00117 0.00117	Trea % 0% 0%		Treat % 0%	ment B (acres) 0.000	Treatm % 0%	nent C (acres)	%	ment D (acres)	Weighted E (ac-ft)	Volume (ac-ft)	Flow cfs
84 0.7480 34 0.7515	0.00117 0.00117	0%	0				(acres)		(acres)	(ac-ft)	(ac-ft)	cfs
34 0.7515	0.00117	<del>-  </del>		0%	0.000	00/	_					
		0%			0.000	U 70	U	100%	0.748	3.340	0.208	3.58
07 0.4804		0,0	0	0%	0.000	0%	0	100%	0.751	3.340	0.209	3.59
01   0.409	0.00076	0%	0	0%	0.000	0%	0	100%	0.489	3.340	0.136	2.34
44 0.5038	0.00079	90%	0.453388	10%	0.050	0%	0	0%	0.000	0.779	0.033	1.09
41 1.5413	0.00241	90%	1.387211	10%	0.154	0%	0	0%	0.000	0.779	0.100	3.32
47 0.6714	0.00105	0%	0	0%	0.000	0%	0	100%	0.671	3.340	0.187	3.21
43 0.4234	0.00066	0%	0	0%	0.000	0%	0	100%	0.423	3.340	0.118	2.02
100 5.129	0.00801				0.000				3.083		0.991	19.144
	41 1.5413 47 0.6714 43 0.4234	41     1.5413     0.00241       47     0.6714     0.00105       43     0.4234     0.00066	41     1.5413     0.00241     90%       47     0.6714     0.00105     0%       43     0.4234     0.00066     0%	41     1.5413     0.00241     90%     1.387211       47     0.6714     0.00105     0%     0       43     0.4234     0.00066     0%     0	41     1.5413     0.00241     90%     1.387211     10%       47     0.6714     0.00105     0%     0     0%       43     0.4234     0.00066     0%     0     0%	41     1.5413     0.00241     90%     1.387211     10%     0.154       47     0.6714     0.00105     0%     0     0%     0.000       43     0.4234     0.00066     0%     0     0%     0.000	41         1.5413         0.00241         90%         1.387211         10%         0.154         0%           47         0.6714         0.00105         0%         0         0%         0.000         0%           43         0.4234         0.00066         0%         0         0%         0.000         0%	41         1.5413         0.00241         90%         1.387211         10%         0.154         0%         0           47         0.6714         0.00105         0%         0         0%         0.000         0%         0           43         0.4234         0.00066         0%         0         0%         0.000         0%         0	41         1.5413         0.00241         90%         1.387211         10%         0.154         0%         0         0%           47         0.6714         0.00105         0%         0         0%         0.000         0%         0         100%           43         0.4234         0.00066         0%         0         0%         0.000         0%         0         100%	41         1.5413         0.00241         90%         1.387211         10%         0.154         0%         0         0%         0.000           47         0.6714         0.00105         0%         0         0%         0.000         0%         0         100%         0.671           43         0.4234         0.00066         0%         0         0%         0.000         0%         0         100%         0.423	41         1.5413         0.00241         90%         1.387211         10%         0.154         0%         0         0%         0.000         0.779           47         0.6714         0.00105         0%         0         0%         0.000         0%         0         100%         0.671         3.340           43         0.4234         0.00066         0%         0         0%         0.000         0%         0         100%         0.423         3.340	41         1.5413         0.00241         90%         1.387211         10%         0.154         0%         0         0%         0.000         0.779         0.100           47         0.6714         0.00105         0%         0         0%         0.000         0%         0         100%         0.671         3.340         0.187           43         0.4234         0.00066         0%         0         0%         0.000         0%         0         100%         0.423         3.340         0.118


## EXISTING DRAINAGE:

THIS SITE IS CURRENTLY VACANT AND IS FORMALLY PART OF THE JUAN TABO BUSINESS PARK DEVELOPMENT. THE SITE IS LOCATED AT THE WEST END OF JUAN TABO PLACE IN ALBUQUERQUE, NM. THE SITE IS ALSO LOCATED WITHIN THE LIMITS OF FEMA FIRM MAP NO. 35001C0357H (EFF. 8/16/2012) AS SHOWN ABOVE. THE SITE IS LOCATED WITHIN AN AREA OF MINIMAL FLOOD HAZARD ZONE X. THE SITE IS ALSO LOCATED WITHIN THE ALBUQUERQUE PRECIPITATION ZONE 4—BEING EAST OF EUBANK AND NORTH OF I—40. THE CURRENT PLAT FOR JUAN TABO BUSINESS PARK INCLUDES 7 LOTS. LOTS 1, 2, 3, & 7 ARE CURRENTLY FULLY DEVELOPED, WHILE LOTS 4, 5, & 6 REMAIN IN A NATURALLY VEGETATED STATE.


STORM WATER RUN-OFF GENERATED ACROSS THIS SITE IS INTENDED TO OUTFALL INTO A CONCRETE LINED CHANNEL KNOWN AS THE EMBUDITO ARROYO. AN EXISTING SERIES OF DROP INLETS AND 24IN STORM DRAIN COLLECT RUN-OFF ALONG THE SOUTHERN LIMITS OF LOTS 1, 2, & 3 AND CONVEY FLOWS DIRECTLY INTO THE EMBUDITO ARROYO. THIS DRAINAGE CONCEPT WAS EMPLOYED AND APPROVED FOR THE CONSTRUCTION PROJECT KNOWN AS THE CARE FREE INC SENIOR'S GROUP HOME ADDITION. ACCORDING TO THE SITE GRADING AND DRAINAGE PLAN FOR THIS PROJECT THE DEVELOPMENT IS ANTICIPATED TO DISCHARGE A TOTAL Q100=23 cfs INTO THE EMBUITO ARROYO. THIS DRAINAGE CONCEPT WILL BE MAINTAINED AND PROPOSED RUN-OFF ANALYSIS IS PRESENTED ON THE PROPOSED DRAINAGE PLAN.




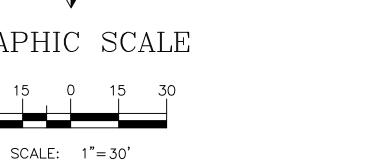

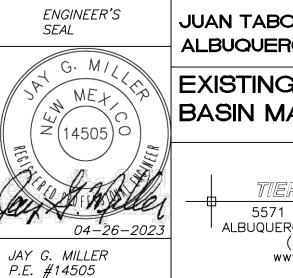

UAN TABO BUSINESS PARK LBUQUERQUE, NM	<i>DRAWN BY</i> JL
EXISTING DRAINAGE	<i>DATE</i> 04–26–2023
BASIN MAP	DRAWING
	SHEET #
TIERRA WEST, LLC  5571 MIDWAY PARK PL NE ALBUQUERQUE, NEW MEXICO 87109	DR-1
(505) 858-3100 www.tierrawestllc.com	JOB #

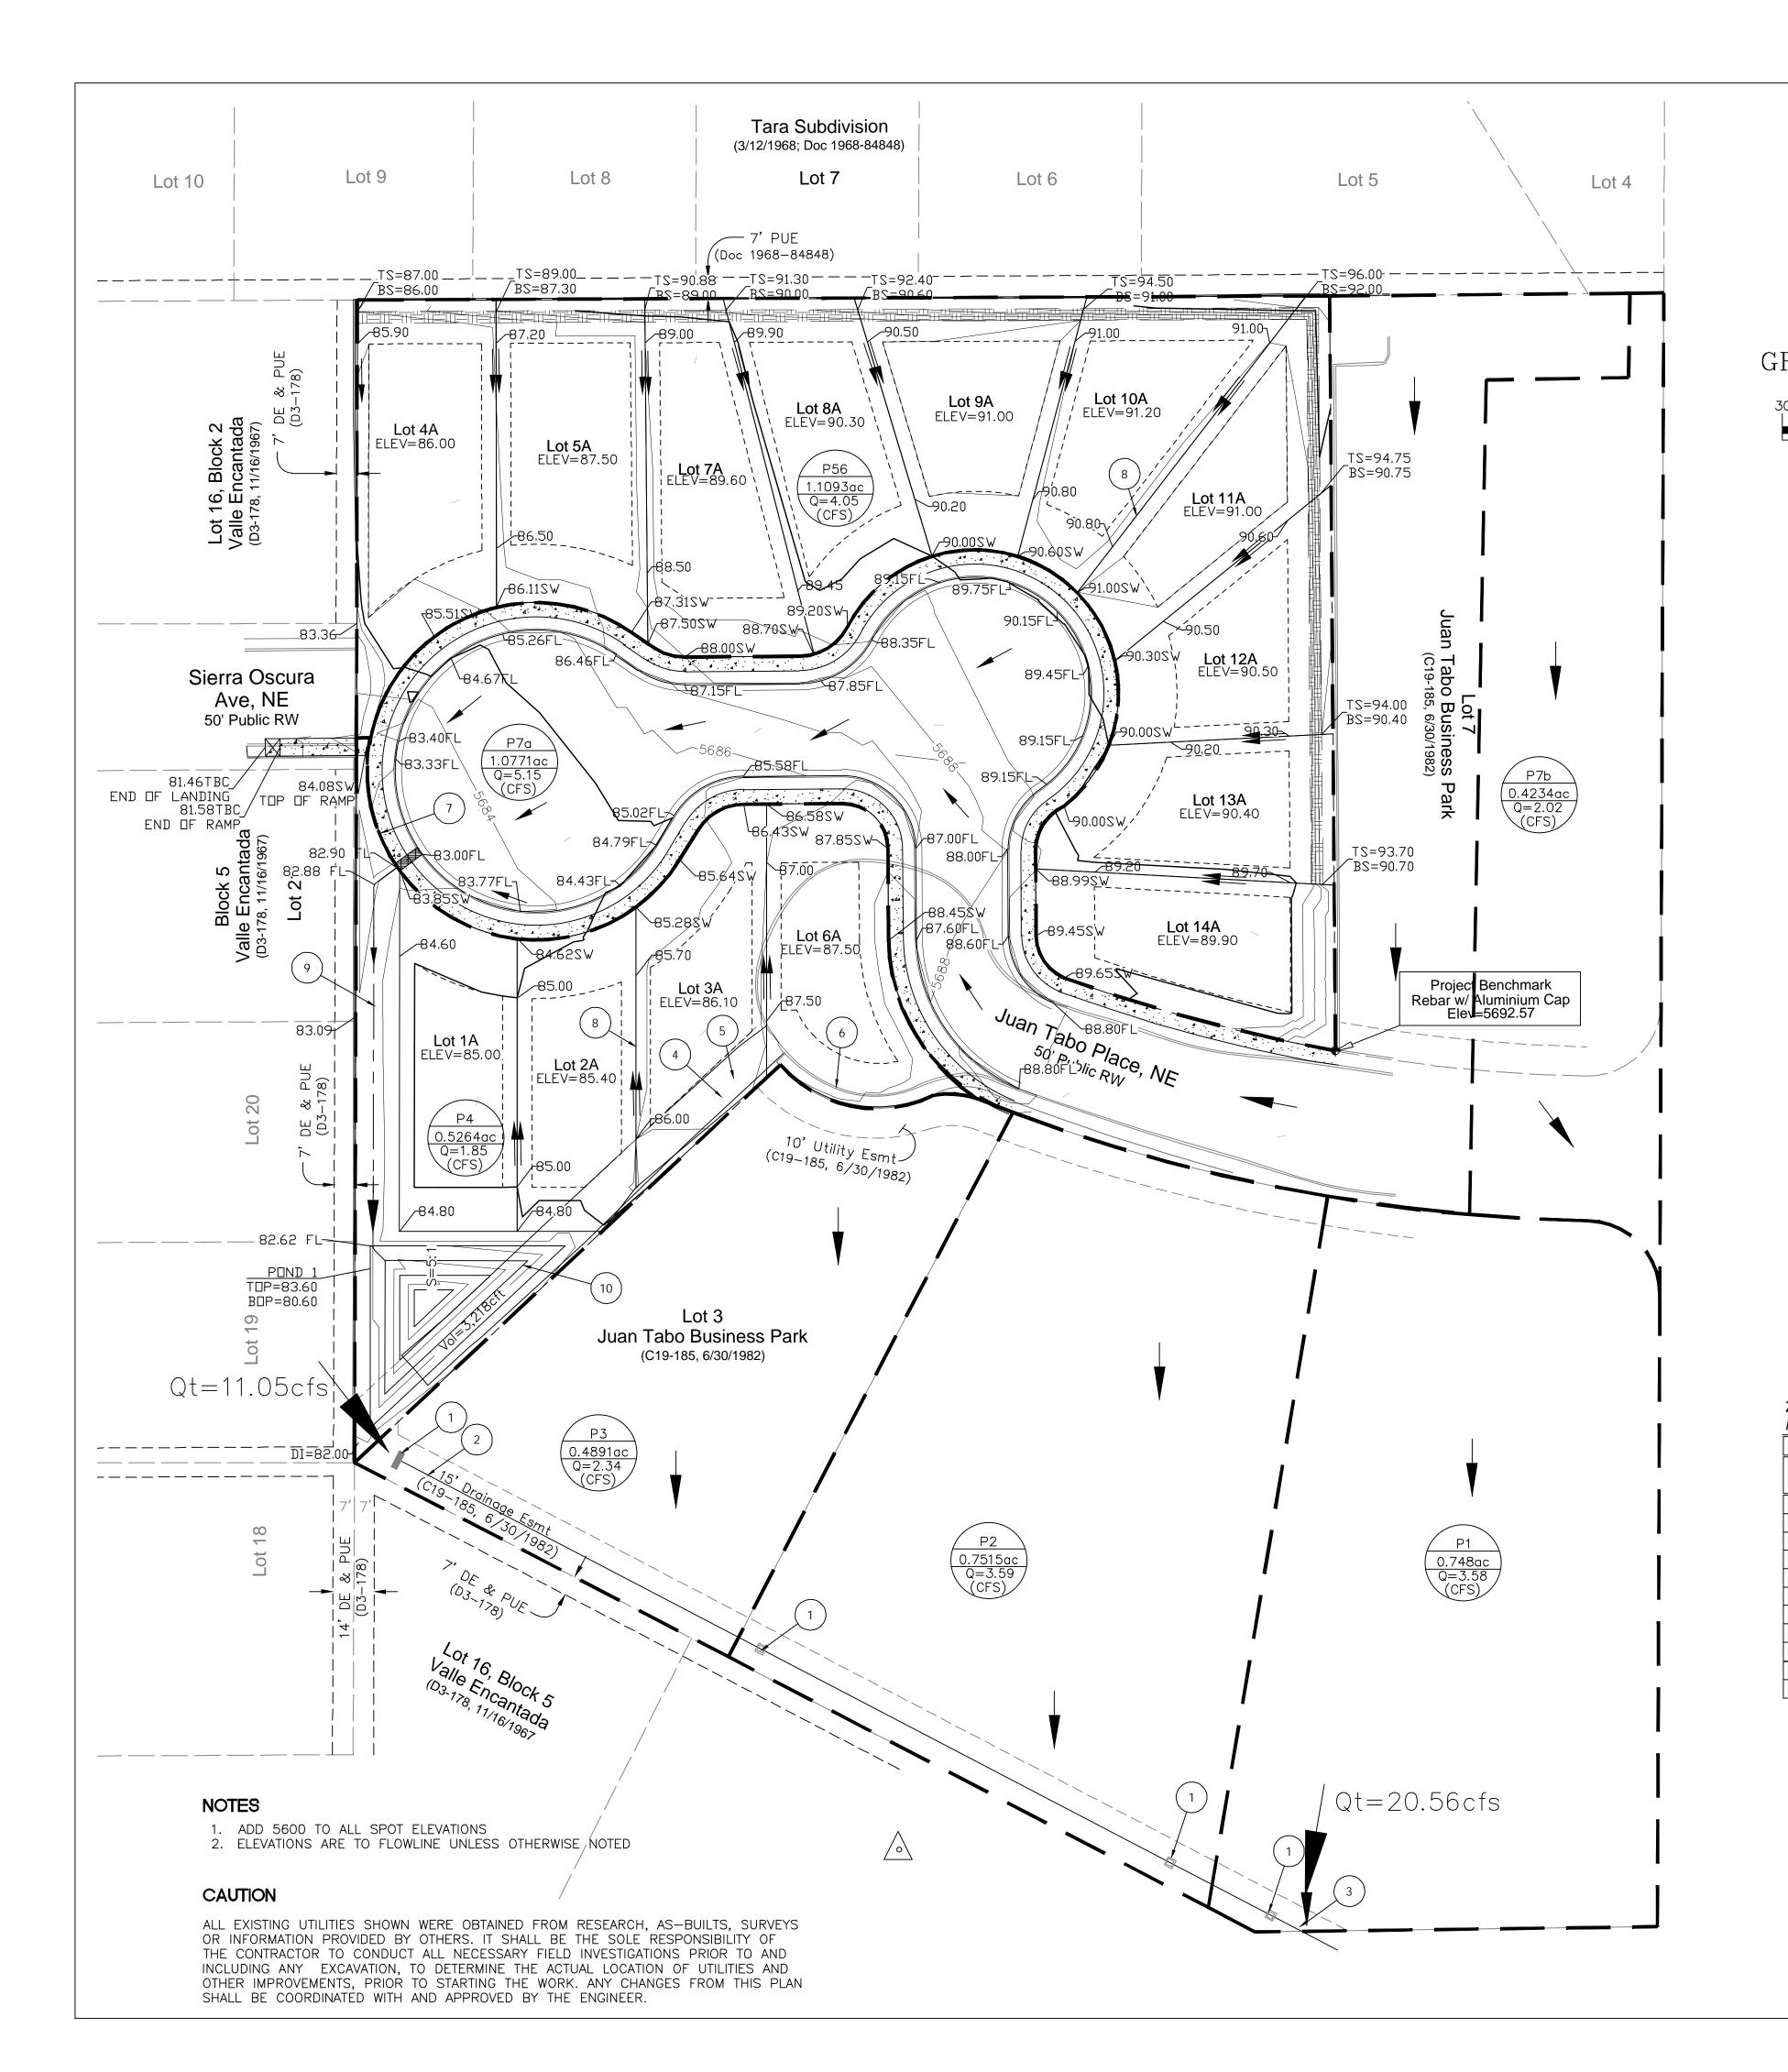

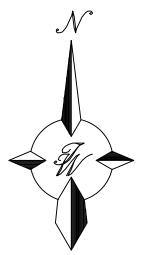


SCALE: 1"=30'

# **LEGEND**

CURB & GUTTER BOUNDARY LINE

PROPOSED SIDEWALK

≡≡≡≡≡≡≡≡ EXISTING CURB & GUTTER

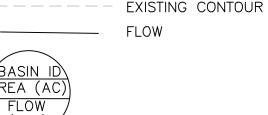

# **KEYED NOTES**

- 1. EXISTING CONCRETE DROP INLET.
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## PROPOSED DRAINAGE:

EXISTING INFRASTRUCTURE & DRAINAGE PATTERNS ACROSS THE FULLY DEVELOPED LOTS 1, 2, 3, & 7 WILL REMAIN IN PLACE AND CONTINUE TO FUNCTION IN THEIR CURRENT STATE. THE PROPOSED IMPROVEMENTS WILL HAVE LITTLE TO NO IMPACT ON THE TOTAL RUN—OFF THAT WILL DISCHARGE AT THE HISTORIC OUTFALL INTO THE EMBUDITO ARROYO. THE TOTAL FLOW FOR THE 100YR-6HR DESIGN STORM WILL BE 20.56CFS ACCORDING TO THE ANALYSIS AS PRESENTED HEREIN. ACCORDING TO THE ANALYSIS PRESENTED WITH THE CARE FREE INC SENIOR'S GROUP HOME ADDITION AS PREPARED BY AKT ARCHITECTS AND APPROVED BY THE CITY (G-21/D21C), THE TOTAL OUTFALL INTO THE EMBUDITO ARROYO WAS ESTIMATED TO BE 23CFS.

AS PART OF THE PROPOSED IMPROVEMENTS FOR THIS 14 SINGLE FAMILY DWELLING LOT SUBDIVISION - A NEW ASPHALT LINED CHANNEL WILL CONVEY RUN-OFF FROM THE SITE AND DELIVER FLOWS INTO A NEW PERMANENT STORM WATER QUALITY RETENTION POND THAT WILL PROVIDE A TOTAL RETENTION CAPACITY OF 3,218CFT. THE NEW RETENTION POND WILL BE SITUATED ADJACENT TO THE EXISTING OUTFALL LOCATION WHICH PROVIDES AN EXISTING CONCRETE DROP INLET TO INTRODUCE THE SURFACE RUN-OFF INTO A 24IN DIAMETER STORM DRAIN PIPE FOR CONVEYANCE INTO THE EXISTING CONCRETE LINED EMBUDITO ARROYO.



DRAWN BY

JL

DATE

04-26-2023

DRAWING

SHEET #

DR-2

JOB #

2022122

## JUAN TABO BUSINESS PARK Weighted E Method

#### Zone #4 Proposed Basins

													100-Year	
Basin	Area	Area	Area	Treat	ment A	Treat	ment B	Treatn	nent C	Treat	ment D	Weighted E	Volume	Flow
	(sf)	(acres)	(sq miles)	%	(acres)	%	(acres)	%	(acres)	%	(acres)	(ac-ft)	(ac-ft)	cfs
P1	32,584	0.7480	0.00117	0%	0	0%	0.000	0%	0	100%	0.748	3.340	0.208	3.58
P2	32,734	0.7515	0.00117	0%	0	0%	0.000	0%	0	100%	0.751	3.340	0.209	3.59
P3	21,307	0.4891	0.00076	0%	0	0%	0.000	0%	0	100%	0.489	3.340	0.136	2.34
P4	22,931	0.5264	0.00082	0%	0	62%	0.326	0%	0	38%	0.200	1.858	0.082	1.85
P56	48,323	1.1093	0.00173	0%	0	55%	0.610	0%	0	45%	0.499	2.026	0.187	4.05
P7a	46,919	1.0771	0.00168	0%	0	0%	0.000	0%	0	100%	1.077	3.340	0.300	5.15
P7b	18,443	0.4234	0.00066	0%	0	0%	0.000	0%	0	100%	0.423	3.340	0.118	2.02
Total	223,241	5.125	0.00801				0.000				4.188		1.240	22.577

				Eq 6.62
Basin	# SFD units	Area (ac)	N (DU's/ac)	lmp %
P4	4	0.5264	7.60	38.0
P56	10	1.1093	9.01	45.1

# STORM WATER QUALITY VOLUME

PROPOSED DEVELOPMENT IMPERVIOUS AREA = P4+P56+P7a = (0.200+0.499+1.077)\*43,560 = 77,362 sft

STORM WATER QUALITY VOLUME REQUIRED = 77,362sft\*(0.42in)/12 = 2,708 cft STORM WATER QUALITY VOLUME PROVIDED = ((84+2061)/2)\*3 = 3,218 cft

ENGINEER'S	JUAN TABO BUSINESS PARK
SEAL	ALBUQUERQUE, NM
G. M/// NE+ C	PROPOSED DRAINAGE
2 (14505)0	PLAN
and maller	TIERRA WEST, LLC
04-26-2023 JAY G. MILLER P.E. #14505	T 5571 MIDWAY PARK PL NE ALBUQUERQUE, NEW MEXICO 87109 (505) 858-3100 www.tierrawestllc.com