# CITY OF ALBUQUERQUE

Planning Department Alan Varela, Director



September 28, 2023

Jay G. Miller, P.E. Tierra West, LLC 5571 Midway Park Place NE Albuquerque, NM, 87109

RE: Juan Tabo Business Park Subdivision

**Revised Conceptual Grading & Drainage Plans** 

Engineer's Stamp Date: 09/26/23

Hydrology File: G21D021

Dear Mr. Miller:

Based upon the information provided in your submittal received 08/10/2023, the Revised Conceptual Grading & Drainage Plans are preliminary approved for action by the Development

Hearing Officer (DHO) on Preliminary/Final Plat.

If the project total area of disturbance (including the staging area and any work within the

adjacent Right-of-Way) is 1 acre or more, then an Erosion and Sediment Control (ESC) Plan and Owner's certified Notice of Intent (NOI) is required to be submitted to the Stormwater Quality

Engineer (Doug Hughes, PE, jhughes@cabq.gov, 924-3420) 14 days prior to any earth

NM 87103 disturbance.

If you have any questions, please contact me at 924-3995 or rbrissette@cabq.gov.

www.cabq.gov

PO Box 1293

Albuquerque

Sincerely,

Renée C. Brissette, P.E. CFM Senior Engineer, Hydrology

Renée C. Brissette

Planning Department




# **City of Albuquerque**

#### Planning Department


Development & Building Services Division

#### DRAINAGE AND TRANSPORTATION INFORMATION SHEET

Project Title: Juan Tabo Business Park	Building Permit #	Hydrology File #
DRB#	EPC#	
Legal Description: 5 SUB'D PLAT MAP FOR J BUSINESS PARK CONT 0.	UAN TABO City Address OR I	Parcel 102106048638710395
Applicant/Agent: TIERRA WEST LLC	Contact: JAY MIL	
Address: 5571 Midway Park Place NE Albuquerque, N	M 87109 <b>Phone:</b> (505) 8	58-3100
Email: JMILLER@TIERRAWESTLLC.COM		
Applicant/Owner:	Contact:	
Address:		
Email:		
Eman.	<del></del>	
TANDE OF DEVICE ORMENT. DI AT (#-£1.	A-) DECIDENCE DDD CI	TEX ADMINISTE.
TYPE OF DEVELOPMENT:PLAT (#of lo	os)RESIDENCEDRB SI	TE / ADMIN SITE:
RE-SUBMITTAL: YES NO		
	🗸	77.07
<b>DEPARTMENT:</b> TRANSPORTATION	N _ A HYDROLOGY/DRA	AINAGE
Check all that apply:		
TYPE OF SUBMITTAL:	TYPE OF APPROVAL/A	CCEPTANCE SOUGHT:
ENGINEER/ARCHITECT CERTIFICATION	BUILDING PERM	MIT APPROVAL
PAD CERTIFICATION	CERTIFICATE O	F OCCUPANCY
XCONCEPTUAL G&D PLAN	CONCEPTUAL T	CCL DRB APPROVAL
GRADING PLAN	<b>X</b> PRELIMINARY I	PLAT APPROVAL
DRAINAGE REPORT	SITE PLAN FOR	SUB'D APPROVAL
DRAINAGE MASTER PLAN	SITE PLAN FOR	BLDG PERMIT APPROVAL
FLOOD PLAN DEVELOPMENT PERMIT A	PPFINAL PLAT AP	PROVAL
ELEVATION CERTIFICATE	SIA/RELEASE O	F FINANCIAL GUARANTEE
CLOMR/LOMR	FOUNDATION P	ERMIT APPROVAL
TRAFFIC CIRCULATION LAYOUT (TCL)	GRADING PERM	IIT APPROVAL
ADMINISTRATIVE	SO-19 APPROVA	AL .
TRAFFIC CIRCULATION LAYOUT FOR DI	RBPAVING PERMIT	ΓAPPROVAL
APPROVAL	GRADING PAD G	CERTIFICATION
TRAFFIC IMPACT STUDY (TIS)	WORK ORDER A	APPROVAL
STREET LIGHT LAYOUT	CLOMR/LOMR	
OTHER (SPECIFY)	FLOOD PLAN D	EVELOPMENT PERMIT
PRE-DESIGN MEETING?	OTHER (SPECIF	Y)
DATE SUBMITTED: 08.10.2023		

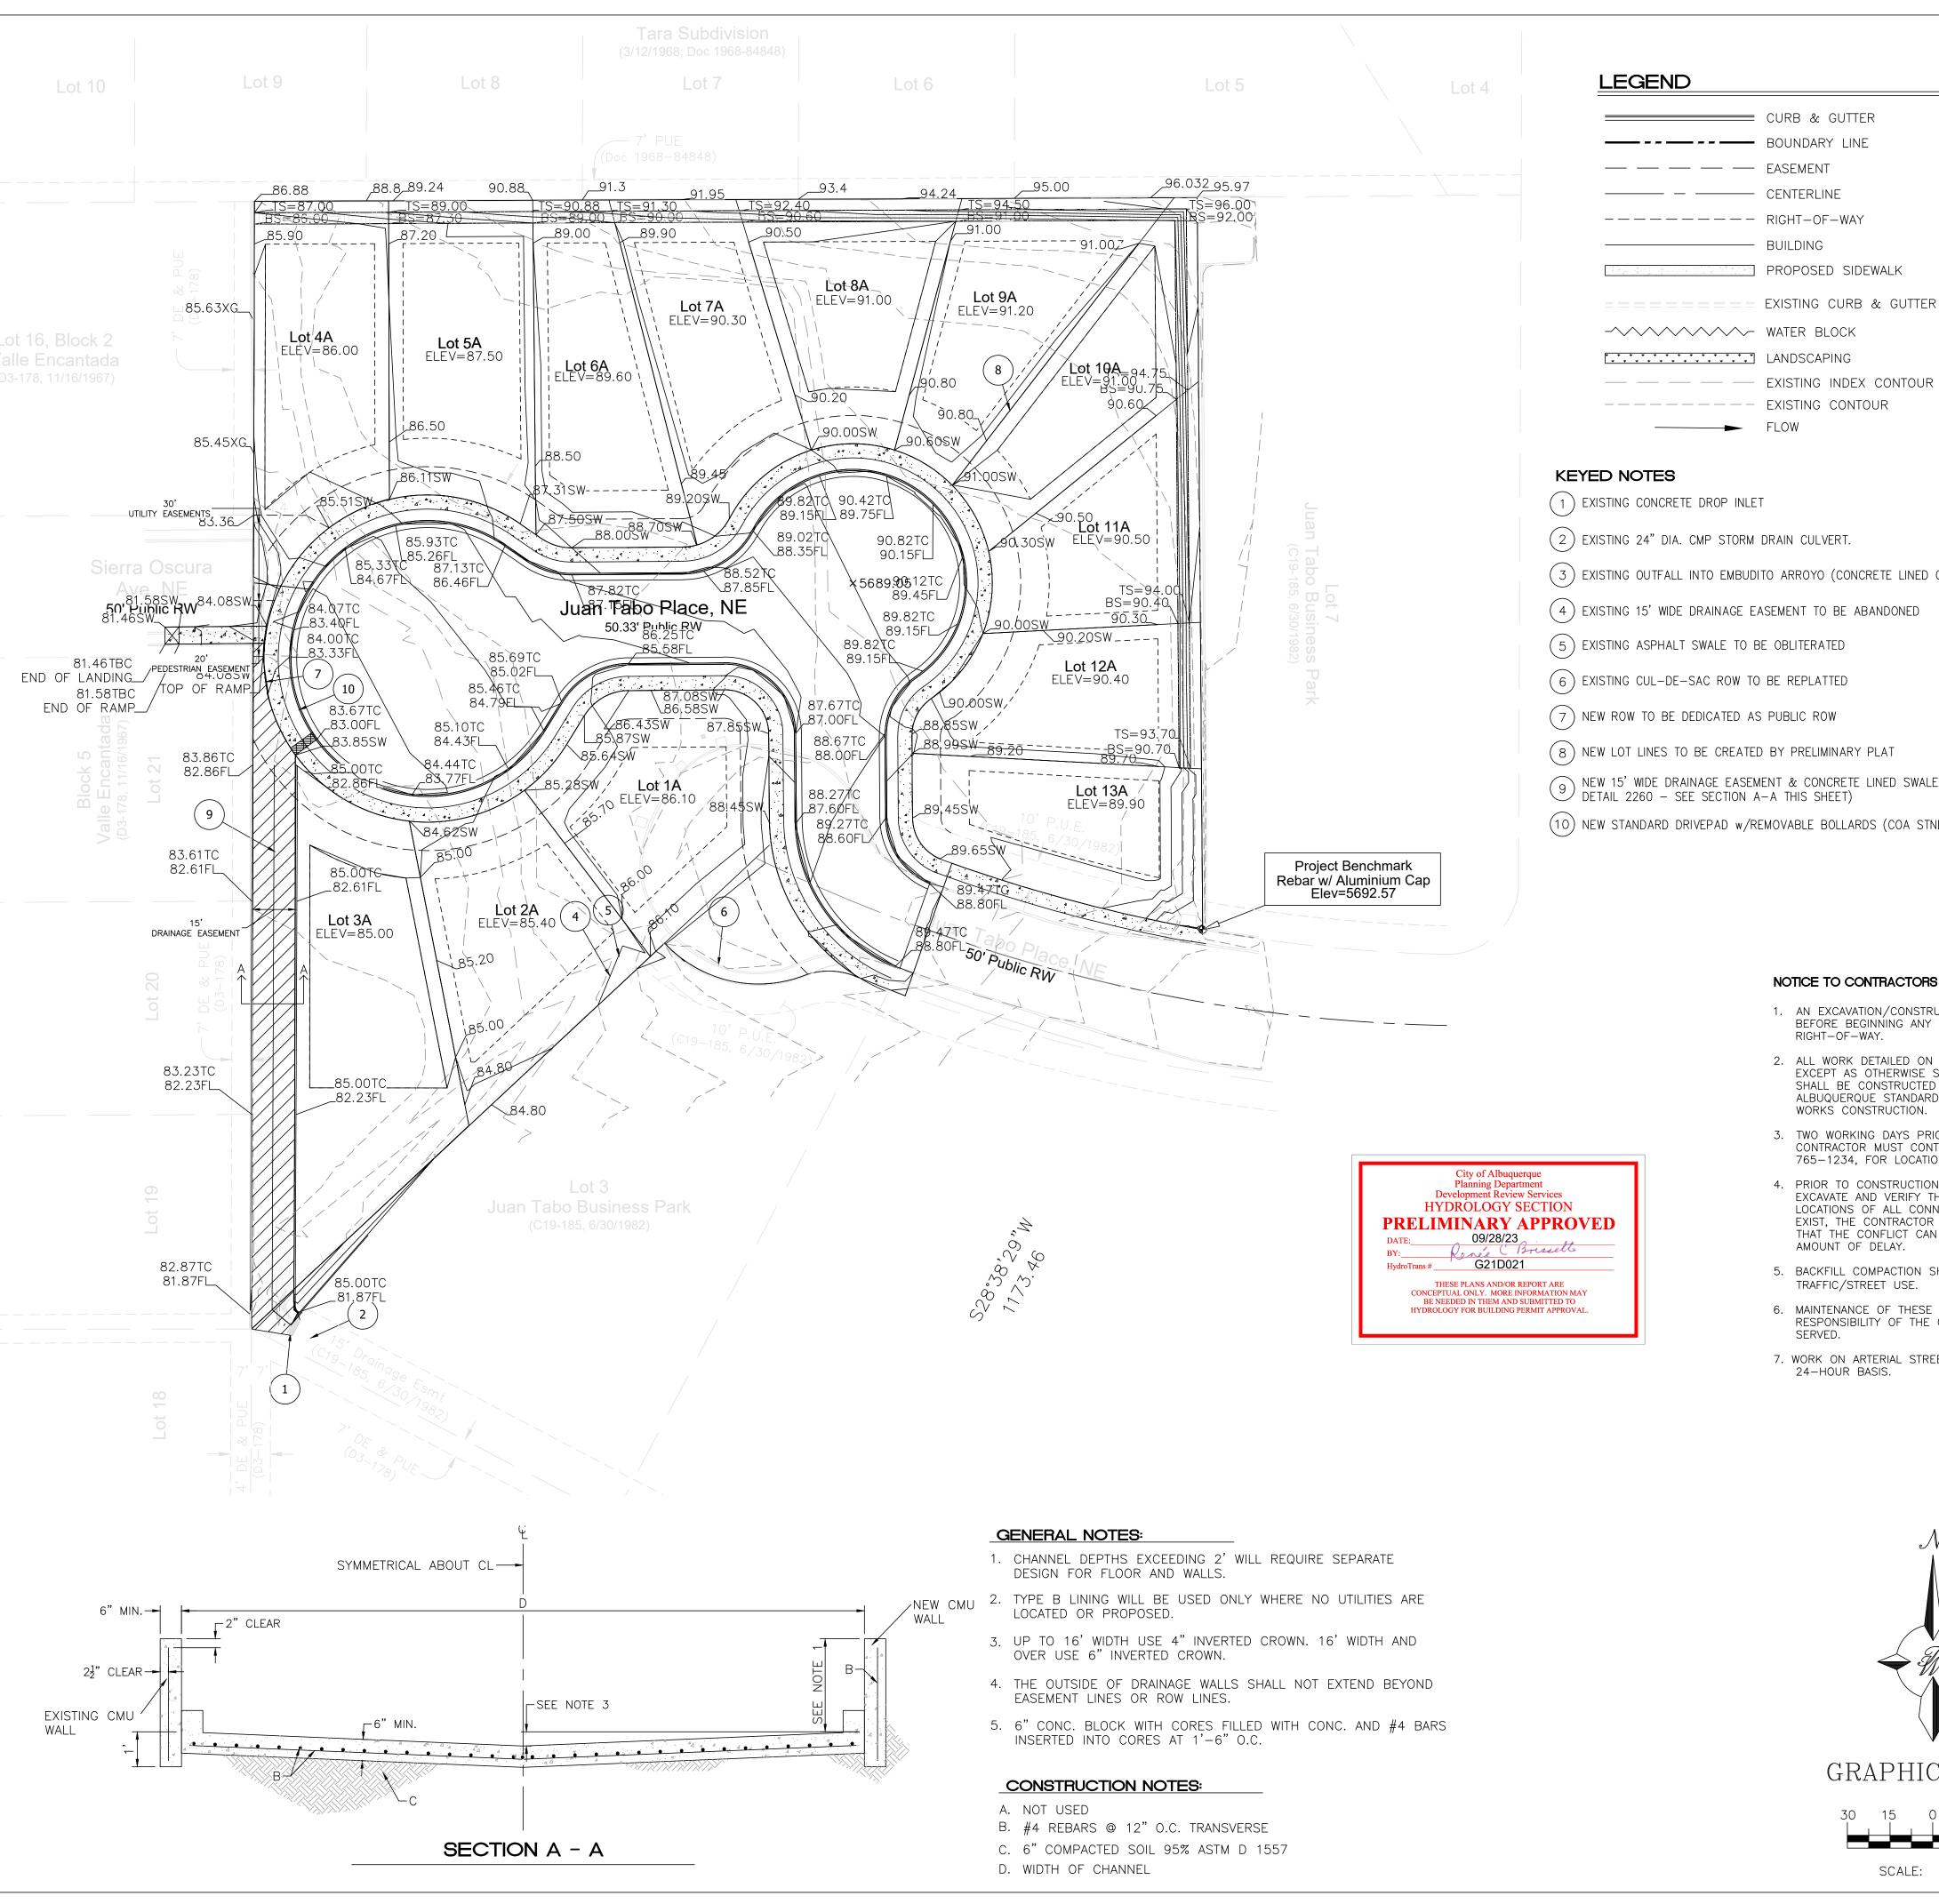

# CURB & GUTTER

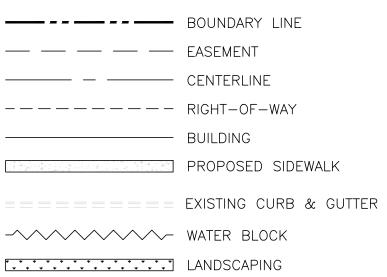

- (2) EXISTING 24" DIA. CMP STORM DRAIN CULVERT.
- (3) EXISTING OUTFALL INTO EMBUDITO ARROYO (CONCRETE LINED CHANNEL)
- (4) EXISTING 15' WIDE DRAINAGE EASEMENT TO BE ABANDONED
- (5) EXISTING ASPHALT SWALE TO BE OBLITERATED
- (6) EXISTING CUL-DE-SAC ROW TO BE REPLATTED
- (8) NEW LOT LINES TO BE CREATED BY PRELIMINARY PLAT
- 9 NEW 15' WIDE DRAINAGE EASEMENT & CONCRETE LINED SWALE (COA STND DETAIL 2260 SEE SECTION A-A THIS SHEET)
- (10) NEW STANDARD DRIVEPAD w/REMOVABLE BOLLARDS (COA STND DETAIL 2425A)





## NOTICE TO CONTRACTORS

- 1. AN EXCAVATION/CONSTRUCTION PERMIT WILL BE REQUIRED BEFORE BEGINNING ANY WORK WITHIN CITY RIGHT-OF-WAY.
- 2. ALL WORK DETAILED ON THESE PLANS TO BE PERFORMED, EXCEPT AS OTHERWISE STATED OR PROVIDED HERON, SHALL BE CONSTRUCTED IN ACCORDANCE WITH CITY OF ALBUQUERQUE STANDARD SPECIFICATIONS FOR PUBLIC WORKS CONSTRUCTION.
- 3. TWO WORKING DAYS PRIOR TO ANY EXCAVATION, CONTRACTOR MUST CONTACT LINE LOCATING SERVICE, 765-1234, FOR LOCATION OF EXISTING UTILITIES.
- 4. PRIOR TO CONSTRUCTION, THE CONTRACTOR SHALL EXCAVATE AND VERIFY THE HORIZONTAL AND VERTICAL LOCATIONS OF ALL CONNECTIONS. SHOULD A CONFLICT EXIST, THE CONTRACTOR SHALL NOTIFY THE ENGINEER SO THAT THE CONFLICT CAN BE RESOLVED WITH A MINIMUM AMOUNT OF DELAY.
- 5. BACKFILL COMPACTION SHALL BE ACCORDING TO TRAFFIC/STREET USE.
- 6. MAINTENANCE OF THESE FACILITIES SHALL BE THE RESPONSIBILITY OF THE OWNER OF THE PROPERTY
- 7. WORK ON ARTERIAL STREETS SHALL BE PERFORMED ON A 24-HOUR BASIS.

#### EROSION CONTROL NOTES:


- 1. CONTRACTOR IS RESPONSIBLE FOR OBTAINING A TOPSOIL DISTURBANCE PERMIT PRIOR TO BEGINNING WORK.
- 2. CONTRACTOR IS RESPONSIBLE FOR MAINTAINING RUN-OFF ON SITE DURING CONSTRUCTION.
- 3. CONTRACTOR IS RESPONSIBLE FOR CLEANING ALL SEDIMENT THAT GETS INTO EXISTING RIGHT-OF-WAY.
- 4. REPAIR OF DAMAGED FACILITIES AND CLEANUP OF SEDIMENT ACCUMULATIONS ON ADJACENT PROPERTIES AND IN PUBLIC FACILITIES IS THE RESPONSIBILITY OF THE
- 5. ALL EXPOSED EARTH SURFACES MUST BE PROTECTED FROM WIND AND WATER EROSION PRIOR TO FINAL (CITY) ACCEPTANCE OF ANY PROJECT.
- 6. ALL SLOPES NOT STABILIZED AT THE END OF THE PROJECT SHALL BE STABILIZED IN ACCORDANCE WITH THE CITY OF ALBUQUERQUE SPECS OR 3" GRAVEL


## NOTES

1. ADD 5600 TO ALL SPOT ELEVATIONS 2. ELEVATIONS ARE TO FLOWLINE UNLESS OTHERWISE NOTED


# CAUTION

ALL EXISTING UTILITIES SHOWN WERE OBTAINED FROM RESEARCH, AS-BUILTS, SURVEYS OR INFORMATION PROVIDED BY OTHERS. IT SHALL BE THE SOLE RESPONSIBILITY OF THE CONTRACTOR TO CONDUCT ALL NECESSARY FIELD INVESTIGATIONS PRIOR TO AND INCLUDING ANY EXCAVATION, TO DETERMINE THE ACTUAL LOCATION OF UTILITIES AND OTHER IMPROVEMENTS, PRIOR TO STARTING THE WORK. ANY CHANGES FROM THIS PLAN SHALL BE COORDINATED WITH AND APPROVED BY THE ENGINEER.

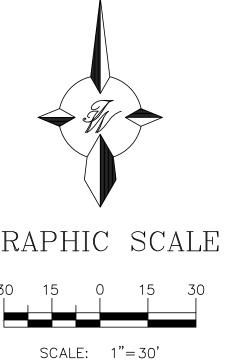

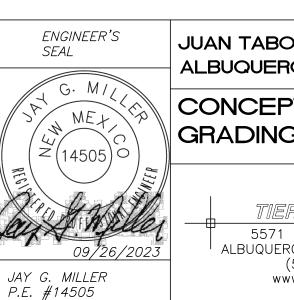

	JUAN TABO BUSINESS PARK ALBUQUERQUE, NM	<i>DRAWN BY</i> RG
	CONCEPTUAL	<i>DATE</i> 09/26/2023
	GRADING AND DRAINAGE	DRAWING
WEER.		SHEET #
023	TIERRA WEST, LLC  5571 MIDWAY PARK PL NE ALBUQUERQUE, NEW MEXICO 87109	C2.0
	(505) 858-3100 www.tierrawestllc.com	JOB #

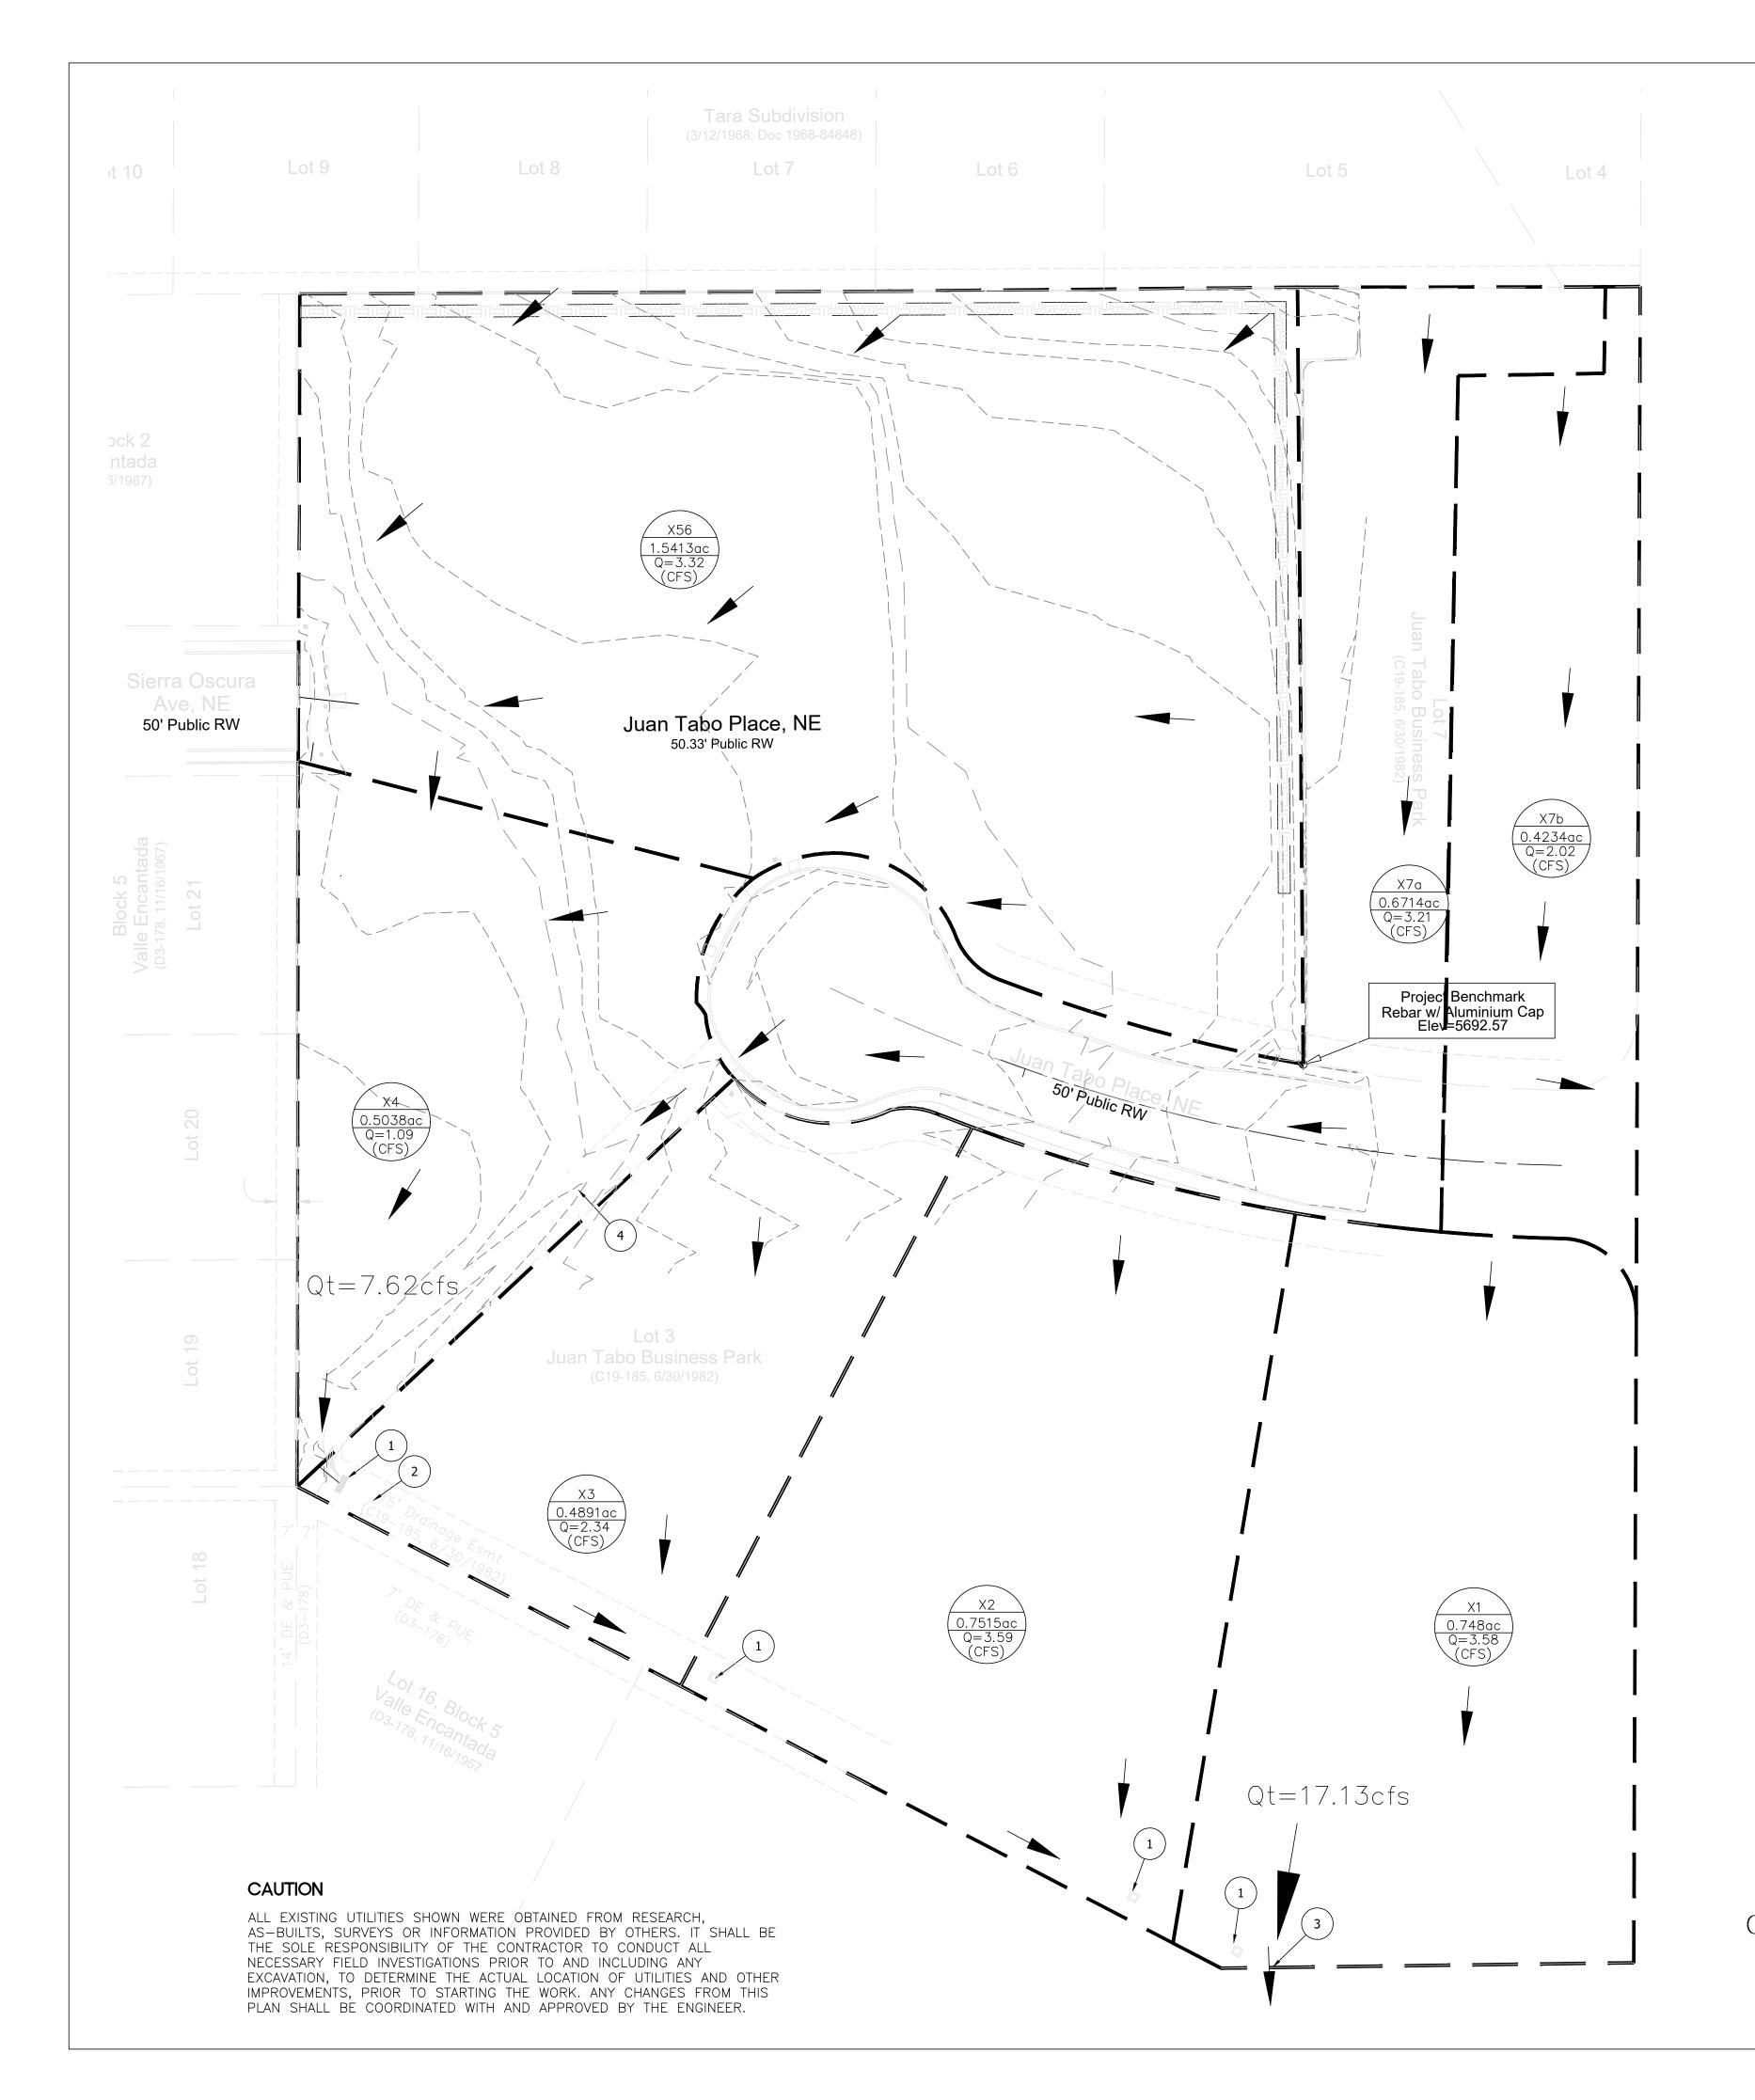

## LEGEND

CURB & GUTTER BOUNDARY LINE --- --- EASEMENT ----- CENTERLINE ---- RIGHT-OF-WAY PROPOSED SIDEWALK 

->>>> WATER BLOCK LANDSCAPING

--- --- EXISTING INDEX CONTOUR ---- EXISTING CONTOUR



# **KEYED NOTES**

- 1. EXISTING CONCRETE DROP INLET.
- 2. EXISTING 24" dia. CMP STORM DRAIN CULVERT.
- 3. EXISTING OUTFALL INTO EMBUDITO ARROYO (CONCRETE LINED CHANNEL). 4. EXISTING ASPHALT LINED CHANNEL.







JUAN TABO BUSINESS PARK

## Weighted E Method


#### Zone #4 Existing Basins

													100-Year	
Basin	Area	Area	Area	Treat	tment A	Treat	ment B	Treatn	nent C	Treat	ment D	Weighted E	Volume	Flow
	(sf)	(acres)	(sq miles)	%	(acres)	%	(acres)	%	(acres)	%	(acres)	(ac-ft)	(ac-ft)	cfs
X1	32,584	0.7480	0.00117	0%	0	0%	0.000	0%	0	100%	0.748	3.340	0.208	3.5
X2	32,734	0.7515	0.00117	0%	0	0%	0.000	0%	0	100%	0.751	3.340	0.209	3.5
Х3	21,307	0.4891	0.00076	0%	0	0%	0.000	0%	0	100%	0.489	3.340	0.136	2.3
X4	21,944	0.5038	0.00079	90%	0.453388	10%	0.050	0%	0	0%	0.000	0.779	0.033	1.0
X56	67,141	1.5413	0.00241	90%	1.387211	10%	0.154	0%	0	0%	0.000	0.779	0.100	3.3
X7a	29,247	0.6714	0.00105	0%	0	0%	0.000	0%	0	100%	0.671	3.340	0.187	3.2
X7b	18,443	0.4234	0.00066	0%	0	0%	0.000	0%	0	100%	0.423	3.340	0.118	2.0
Total	223,400	5.129	0.00801				0.000				3.083		0.991	19.14

## EXISTING DRAINAGE:

THIS SITE IS CURRENTLY VACANT AND IS FORMALLY PART OF THE JUAN TABO BUSINESS PARK DEVELOPMENT. THE SITE IS LOCATED AT THE WEST END OF JUAN TABO PLACE IN ALBUQUERQUE, NM. THE SITE IS ALSO LOCATED WITHIN THE LIMITS OF FEMA FIRM MAP NO. 35001C0357H (EFF. 8/16/2012) AS SHOWN ABOVE. THE SITE IS LOCATED WITHIN AN AREA OF MINIMAL FLOOD HAZARD ZONE X. THE SITE IS ALSO LOCATED WITHIN THE ALBUQUERQUE PRECIPITATION ZONE 4 —BEING EAST OF EUBANK AND NORTH OF I—40. THE CURRENT PLAT FOR JUAN TABO BUSINESS PARK INCLUDES 7 LOTS. LOTS 1, 2, 3, & 7 ARE CURRENTLY FULLY DEVELOPED, WHILE LOTS 4, 5, & 6 REMAIN IN A NATURALLY VEGETATED STATE.

STORM WATER RUN-OFF GENERATED ACROSS THIS SITE IS INTENDED TO OUTFALL INTO A CONCRETE LINED CHANNEL KNOWN AS THE EMBUDITO ARROYO. AN EXISTING SERIES OF DROP INLETS AND 24IN STORM DRAIN COLLECT RUN-OFF ALONG THE SOUTHERN LIMITS OF LOTS 1, 2, & 3 AND CONVEY FLOWS DIRECTLY INTO THE EMBUDITO ARROYO. THIS DRAINAGE CONCEPT WAS EMPLOYED AND APPROVED FOR THE CONSTRUCTION PROJECT KNOWN AS THE CARE FREE INC SENIOR'S GROUP HOME ADDITION. ACCORDING TO THE SITE GRADING AND DRAINAGE PLAN FOR THIS PROJECT THE DEVELOPMENT WAS ANTICIPATED TO DISCHARGE A TOTAL Q100=19 cfs INTO THE EMBUDITO ARROYO. THIS DRAINAGE CONCEPT WILL BE MAINTAINED AND PROPOSED RUN-OFF ANALYSIS IS PRESENTED ON SHEET C2.2 PROPOSED DRAINAGE PLAN.

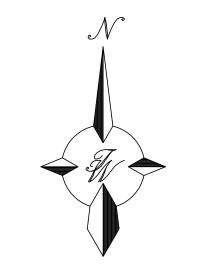



City of Albuquerque Planning Department Development Review Services HYDROLOGY SECTION PRELIMINARY APPROVED THESE PLANS AND/OR REPORT ARE CONCEPTUAL ONLY. MORE INFORMATION MAY BE NEEDED IN THEM AND SUBMITTED TO HYDROLOGY FOR BUILDING PERMIT APPROVAL.

GRAPHIC SCALE


SCALE: 1"=30'

ENGINEER'S SEAL	JUAN TABO BUSINESS PARK ALBUQUERQUE, NM	<i>DRAWN BY</i> RG
	EXISTING DRAINAGE	<i>DATE</i> 09/26/2023
	BASIN MAP	DRAWING
		SHEET #
09/26/2023	TIERRA WEST, LLC  5571 MIDWAY PARK PL NE ALBUQUERQUE, NEW MEXICO 87109	C2.1
JAY G. MILLER P.E. #14505	(505) 858-3100 www.tierrawestllc.com	<i>JOB #</i> 2022122

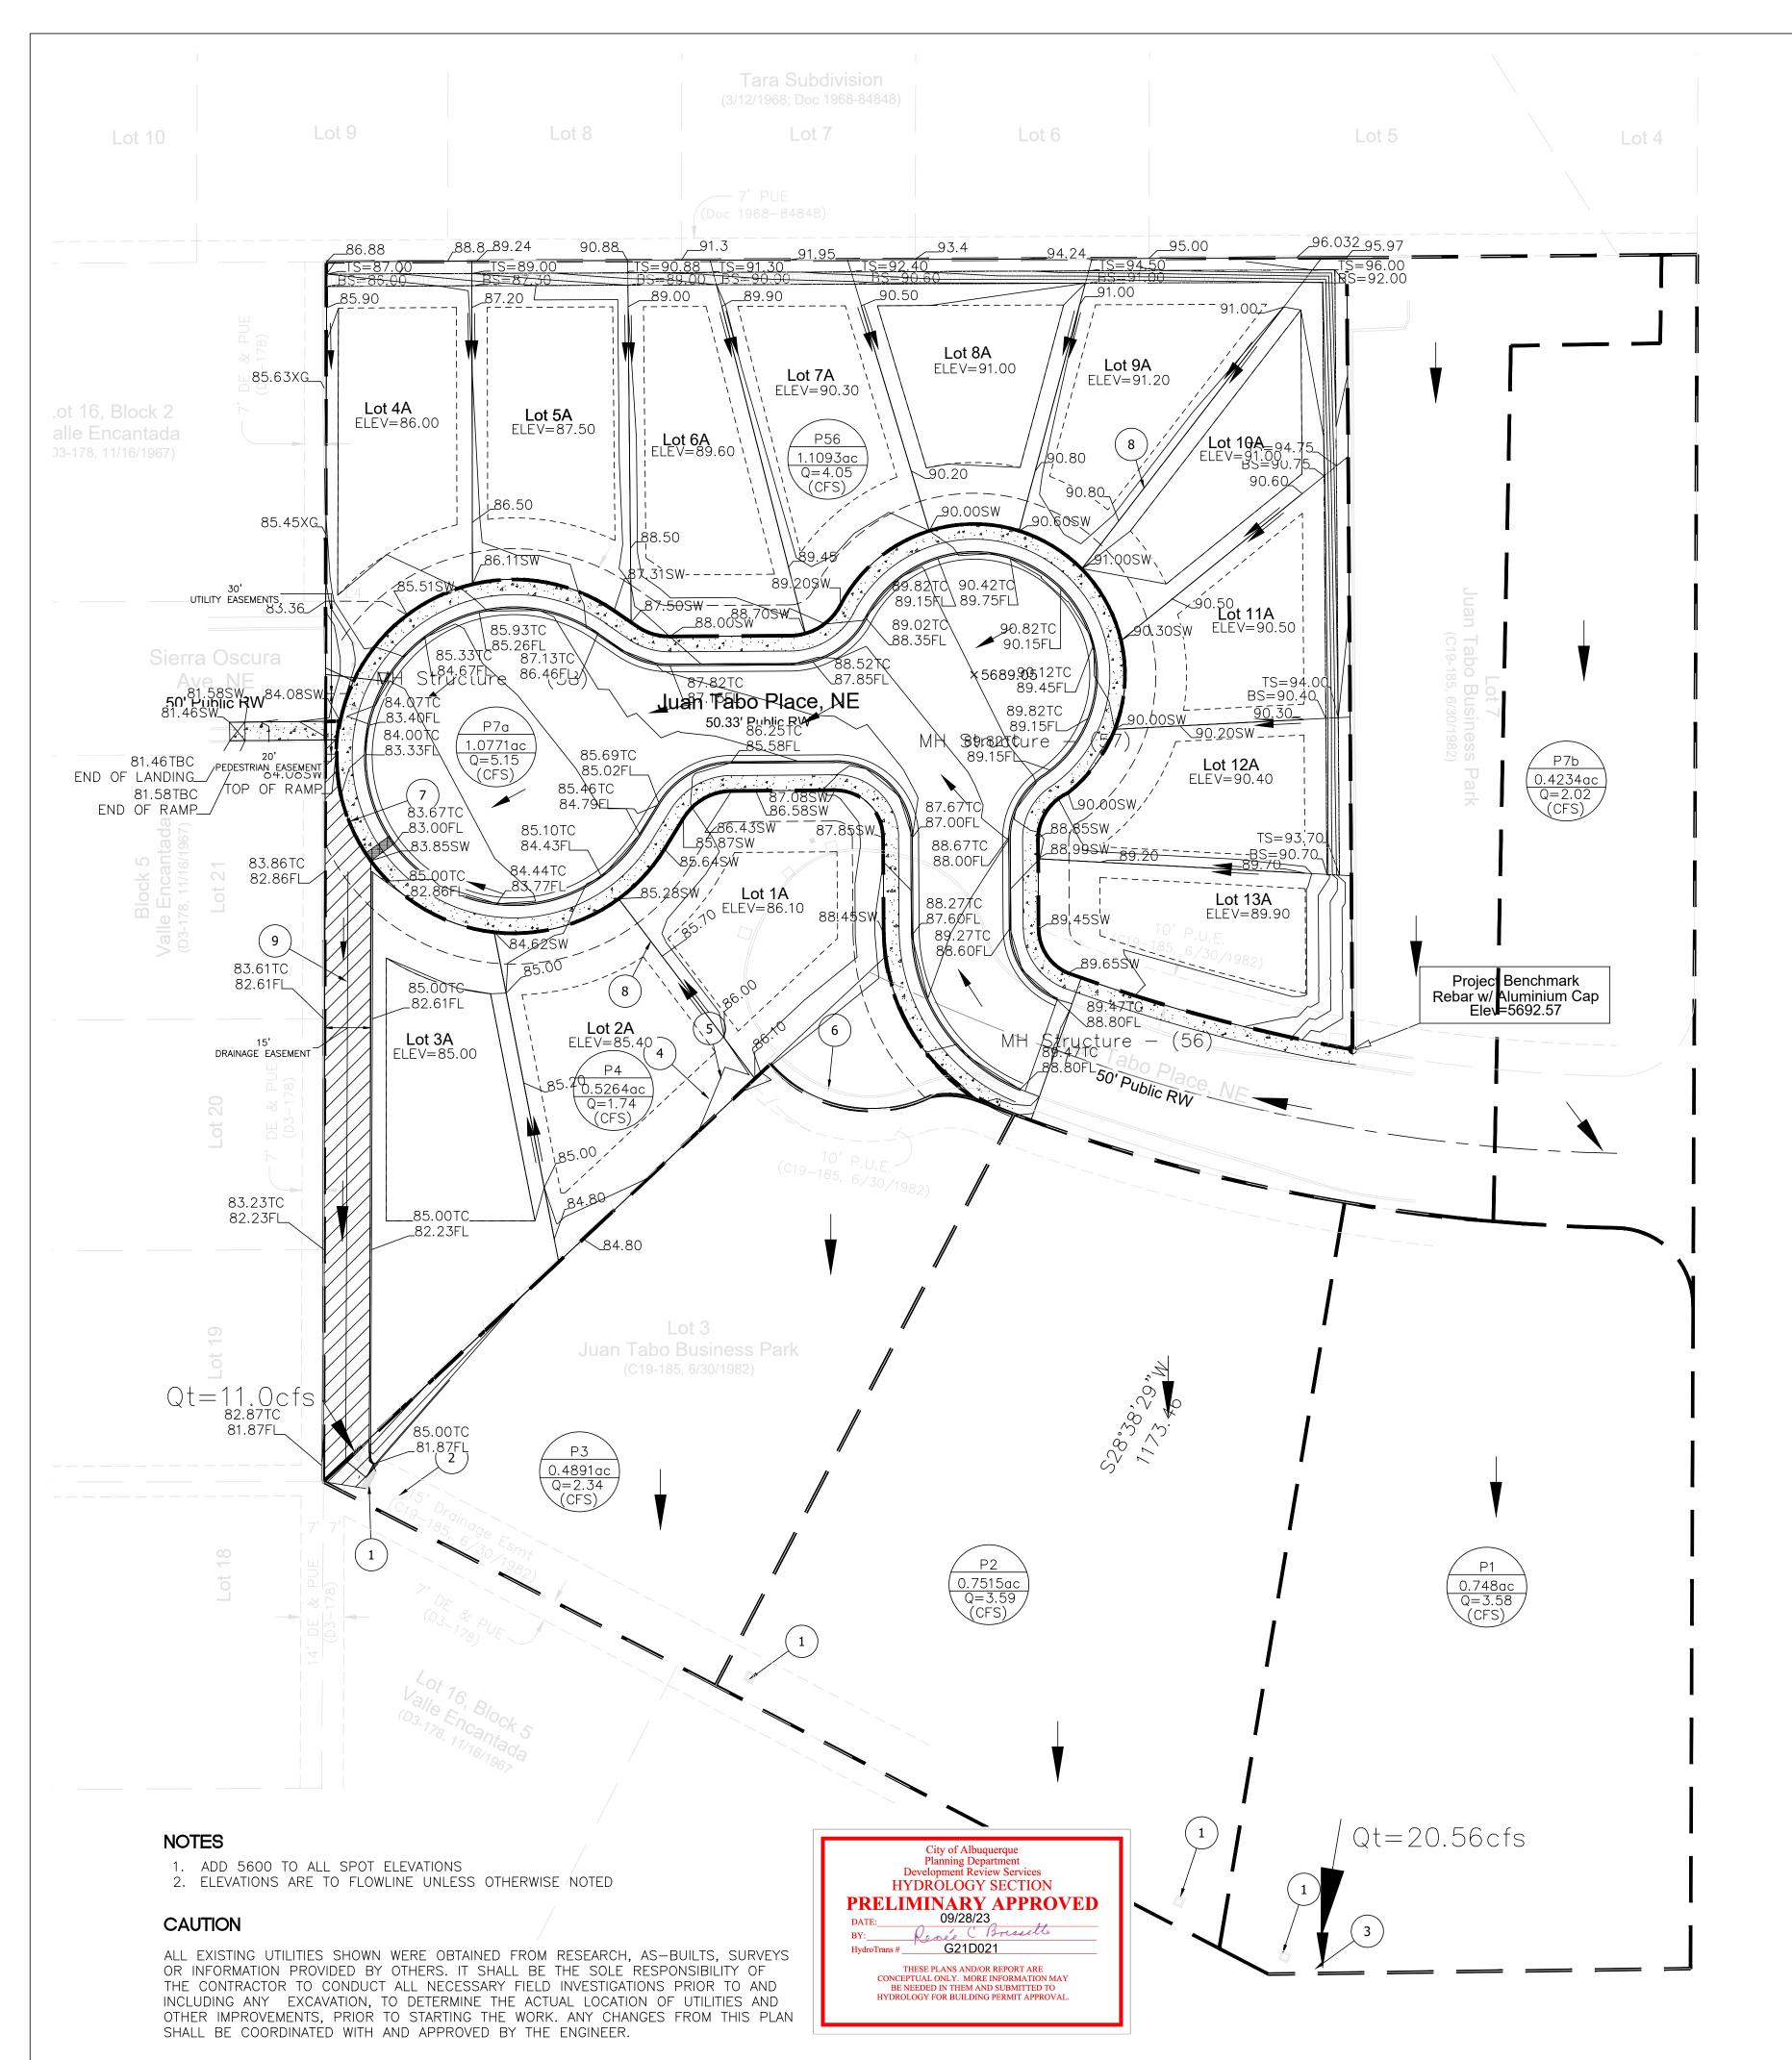


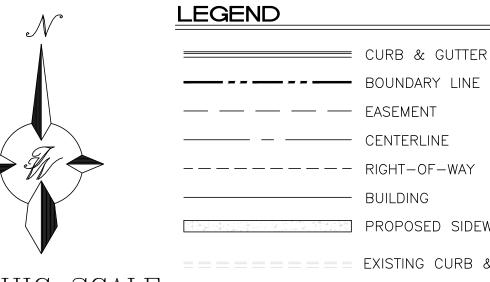

SCALE: 1"=30'

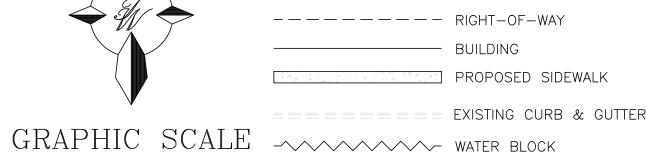

--- -- EXISTING INDEX CONTOUR

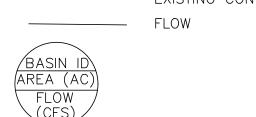

## **KEYED NOTES**

- 1. EXISTING CONCRETE DROP INLET.
- 2. EXISTING 24" dia. CMP STORM DRAIN CULVERT.
- 3. EXISTING OUTFALL INTO EMBUDITO ARROYO (CONCRETE LINED CHANNEL).
- 4. EXISTING 15' WIDE DRAINAGE EASEMENT TO BE ABANDONED.
- 5. EXISTING ASPHALT SWALE TO BE OBLITERATED.
- 6. EXISTING CUL-DE-SAC ROW TO BE REPLATTED.
- 7. NEW ROW TO BE DEDICATED AS PUBLIC ROW.
- 8. NEW LOT LINES TO BE CREATED BY PRELIMINARY PLAT.
- 9. NEW 15' WIDE DRAINAGE EASEMENT & ASPHALT LINED SWALE.





#### PROPOSED DRAINAGE:

EXISTING INFRASTRUCTURE & DRAINAGE PATTERNS ACROSS THE FULLY DEVELOPED LOTS 1, 2, 3, & 7 WILL REMAIN IN PLACE AND CONTINUE TO FUNCTION IN THEIR CURRENT STATE. THE PROPOSED IMPROVEMENTS WILL HAVE LITTLE TO NO IMPACT ON THE TOTAL RUN-OFF THAT WILL DISCHARGE AT THE HISTORIC OUTFALL INTO THE EMBUDITO ARROYO. THE TOTAL FLOW FOR THE 100YR-6HR DESIGN STORM WILL BE 20.56CFS ACCORDING TO THE ANALYSIS AS PRESENTED HEREIN. ACCORDING TO THE ANALYSIS PRESENTED WITH THE CARE FREE INC SENIOR'S GROUP HOME ADDITION AS PREPARED BY AKT ARCHITECTS AND APPROVED BY THE CITY (G-21/D21C), THE TOTAL OUTFALL INTO THE EMBUDITO ARROYO WAS ESTIMATED TO BE 23CFS.

AS PART OF THE PROPOSED IMPROVEMENTS FOR THIS 13 SINGLE FAMILY DWELLING LOT SUBDIVISION - A NEW CONCRETE LINED CHANNEL WILL CONVEY RUN-OFF FROM THE SITE AND DELIVER FLOWS INTO THE EXISTING DROP INLET GRATE LOCATED AT THE SOUTHWEST CORNER OF LOT 3, WHICH IS THE CURRENT OUTFALL FOR THE PROPOSED DEVELOPMENT. THE EXISTING CONCRETE DROP INLET SERVES TO INTRODUCE SURFACE RUN-OFF INTO A 24IN DIAMETER STORM DRAIN PIPE FOR CONVEYANCE INTO THE EXISTING CONCRETE LINED EMBUDITO ARROYO.

## JUAN TABO BUSINESS PARK

## Weighted E Method

#### Zone #4 Proposed Rasins

													100-Year	
Basin	Area	Area	Area	Treat	ment A	Treat	ment B	Treatn	nent C	Treat	ment D	Weighted E	Volume	Flow
	(sf)	(acres)	(sq miles)	%	(acres)	%	(acres)	%	(acres)	%	(acres)	(ac-ft)	(ac-ft)	cfs
P1	32,584	0.7480	0.00117	0%	0	0%	0.000	0%	0	100%	0.748	3.340	0.208	3.58
P2	32,734	0.7515	0.00117	0%	0	0%	0.000	0%	0	100%	0.751	3.340	0.209	3.59
P3	21,307	0.4891	0.00076	0%	0	0%	0.000	0%	0	100%	0.489	3.340	0.136	2.34
P4	22,931	0.5264	0.00082	0%	0	72%	0.379	0%	0	28%	0.147	1.619	0.071	1.74
P56	48,323	1.1093	0.00173	0%	0	55%	0.610	0%	0	45%	0.499	2.026	0.187	4.05
P7a	46,919	1.0771	0.00168	0%	0	0%	0.000	0%	0	100%	1.077	3.340	0.300	5.15
P7b	18,443	0.4234	0.00066	0%	0	0%	0.000	0%	0	100%	0.423	3.340	0.118	2.02
Total	223,241	5.125	0.00801				0.000				4.136		1.229	22.469

				Eq 6.62
Basin	# SFD units	Area (ac)	N (DU's/ac)	lmp %
P4	3	0.5264	5.70	28.5
P56	10	1.1093	9.01	45.1

# STORM WATER QUALITY VOLUME

PROPOSED DEVELOPMENT IMPERVIOUS AREA = P4+P56+P7a = (0.150+0.499+1.077)\*43,560 = 75,184 sft

STORM WATER QUALITY VOLUME REQUIRED = 75,184sft\*(0.42in)/12 = 2,632 cftPAYMENT IN LIEU (SINGLE FAMILY RESIDENTIAL) = (\$6.00/cft)\*2,632 = \$15,792

ENGINEER'S SEAL	JUAN TABO BUSINESS PARK ALBUQUERQUE, NM	<i>DRAWN BY</i> RG
	PROPOSED DRAINAGE	<i>DATE</i> 09/26/2023
	PLAN	DRAWING
		SHEET #
	TIERRA WEST, LLC	C2.2
09/26/2023	T 5571 MIDWAY PARK PL NE ALBUQUERQUE, NEW MEXICO 87109	
JAY G. MILLER P.E. #14505	(505) 858-3100 www.tierrawestllc.com	<i>JOB #</i> 2022122