CITY OF ALBUQUERQUE



October 16, 2018

Asa Nilsson-Weber, P.E. Isaacson & Arfman, PA 128 Monroe St NE Albuquerque, NM 87108

Re: Stormcloud Lots 44-53, 56-57, 59, 62-63, 65, 67, 70-74, 76-78

Request for Engineer Pad Certification – Accepted Engineer's Stamp dated: 1-22-18 (H09D022A)

Certification dated: 10-15-18

Dear Ms. Nilsson-Weber,

Based upon the information provided in your submittal received 10/15/2018, the above referenced Certification is acceptable for building permit.

If you have any questions, you can contact me at 924-3995 or Totten Elliott at 924-3982.

PO Box 1293

Sincerely,

Albuquerque

NM 87103

Renée C. Brissette, P.E. CFM Senior Engineer, Hydrology

Renée Brissette

Planning Department

www.cabq.gov

TE/RB C: email

	B	ROUNDA	RY CUR	VE TAE	OLE CHORD	
CURVE	LENGTH	RADIUS	TANGENT	CHORD	BEARING	DELTA
C5	208.45	762.00°	104.88	207.80°	S35°45'41"W	15°40'25"
C5	197.52'	920.00	99.14'	197.14'	S21°46'26"W	12'18'05"
C7	84.44'	1032.00'	42.24	84.41'	S1376'45"W	4*41'16"

103 PG= 5302.10 102 PG= 5301.00 DW SH 101 PG= 5300,00 DW SH 102 PG= 5300,00 DW SH 103 PG= 5300,00 DW SH 104 PG= 5289.50 DW SH 105 PG= 5289.50 DW SH 106 PG= 5289.50 DW SH 107 PG= 5289.50 DW SH 108 PG= 5289.50 DW SH 109 PG= 5289.50 DW SH 100 P	95 96 97 98 98 98 98 98 98 98 98 98	REVISION NOTES: A. EXISTING TOPO SHOWN ON THIS PLAN REFLECTS PARTIAL GRADING OF UNIT 4B PER GRADING PLAN DATED 11/7/16. B. EXISTING PERMETER/RETAINING WALLS ALONG TIERRA PINITADA ADJACENT TO LOTS 1-10, UNIT 4B AND LOTS 101-103, UNIT 4A SHALL BE DEMOUSHED AND NEW WALLS SHALL BE CONSTRUCTED PER THIS PLAN. C. PAD LIMITS FOR LOTS 1-10, UNIT 4B AND LOTS 101-103, UNIT 4A WERE EXTENDED.
9	35	89 88 87 86 72.6 72.6 72.6 72.6 72.6 72.6 72.6 72.



PROJECT NOTES:

EXST LEGAL: TRACT C, BULK PLAT FOR STORMCLOUD SUBDIVISION

ENOUMABLE ACCAMONIMENT A LIC

BENCHMARK: ACS MONUMENT 4-H9
ELEVATION: 5209.315 (NAVD 1988)

AREA: 21.5 AC.±

ENGINEER: ÁSA NILSSON-WEBER ISAACSON & ARFMAN, P.A.

SURVEYOR: RUSTY HUGG

SURVTEK, INC.

FLOOD PLAIN: THE SITE LIES WITHIN ZONE "X", ZONE "AO" AND ZONE "AE" PER FIRM MAP 35001C0326G.

NOTES:

- STREET GRADES ARE AT FLOWLINE.
- SEE SHEETS 4&5 FOR RETAINING WALL GRADES AND SECTIONS.

LEGEND

--- 5270 --- EXISTING CONTOUR

--- 52 --- PROPOSED CONTOUR

--- 78.3 PROPOSED ELEVATION

--- PROPOSED ELEV. AT TIERRA PINTADA R/W

PG=5272.1 PAD GRADE ELEVATION


--- STANDARD (STD) CURB & GUTTER

MOUNTABLE (MTBL) CURB & GUTTER
STORM DRAIN W/ MANHOLE

STORM DRAIN INLET


PROPOSED RETAINING WALL

(DESIGN BY OTHERS)

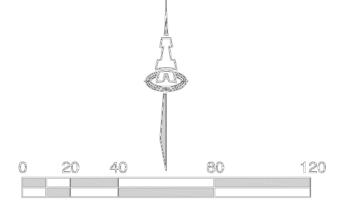

RECOMMENDED DRIVEWAY LOCATION

SCALE 1"=40'

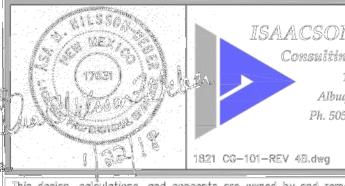

ISAACSON & ARFMAN, P.A.

Consulting Engineering Associates

128 Monroe Street N.E.

Albuquerque, New Mexico 87108

Ph. 505-268-8828 www.iacivil.com

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STORMCLOUD SUBDIVISION
UNIT 4B & LOTS 101-103, UNIT 4A

PULTE HOMES


erading and drainage diani nim


SEE SHEET 1 Albuquerque Control Survey Monument "BH—41" New Mexico State Plane Coordinates (Central Zone — NAD 83) as published North= 1,496,608.828 feet East= 1,491,701.376 feet Delta Alpha= -00°17'09.70" Ground to Grid Factor= 0.999670930 DRAINAGE CERTIFICATION FOR LOTS 44-53, 56-57, 59, 62-63, 65, 67, 70-74 & 76-78 I, Åsa Nilsson—Weber, NMPE 17631 of the firm Isaacson & Arfman, P.A., hereby certify that the referenced lots have been graded and will drain in substantial compliance with and in accordance with the design intent of the approved Grading & Drainage Plan dated January 22, 2018, and retaining walls have been constructed in substantial compliance with and in accordance with the design intent of the grades shown on the approved Retaining Wall Plan dated January 22, 2018, except as noted below. ISAACSON & ARFMAN, P.A Consulting Engineering Associates 128 Monroe Street N.E. Albuquerque, New Mexico 87108 The upper retaining wall shown on plans adjacent to lots 67-74 was not constructed. Instead, the two lower walls were constructed with 1'-2' added retaining height, which is acceptable. Ph. 505-268-8828 www.iacivil.com The record information edited onto the original design document has been obtained by Russ Hugg, NMPS, 9750, of the firm Surv—Tek, Inc. I further certify that I or someone under my direct supervision visited the project site on October 4 and October 10, 2018, and have determined by visual inspection that the survey data provided is representative of actual site conditions and is true and correct to the best of my knowledge and belief. This certification is submitted in support of a request for Building Permit 1821 CG-101-REV 4B.dwg Feb 20,2018 This design, calculations, and concepts are owned by and remain the property of Isaacson & Ariman, P.A. and no part thereof shall be utilized by any person, firm or corporation for any purpose whatspever except with the written permission of Isaacson & Ariman, P.A. @ Approval. STORMCLOUD SUBDIVISION Additional grading for each lot shall be required after home construction and prior to issuance of Permanent Certificate of Occupancy to re—establish the individual lot surface drainage patterns. UNIT 4B & LOTS 101-103, UNIT 4A The record information presented hereon is not necessarily complete and intended only to verify substantial compliance of the grading and drainage aspects of this project. Those relying on this record document are advised to obtain independent verification of its accuracy before using it for any other PULTE HOMES 1. ADDED RETAINING WALL SECTIONS 2/20/18 Åsa Nilsson-Weber, NMPE 17631 ON SHEETS 4 & 5 MONUMENT TIE DETAIL Drawn By: ANW/THOR

Ckd By:

Anw

OF 5

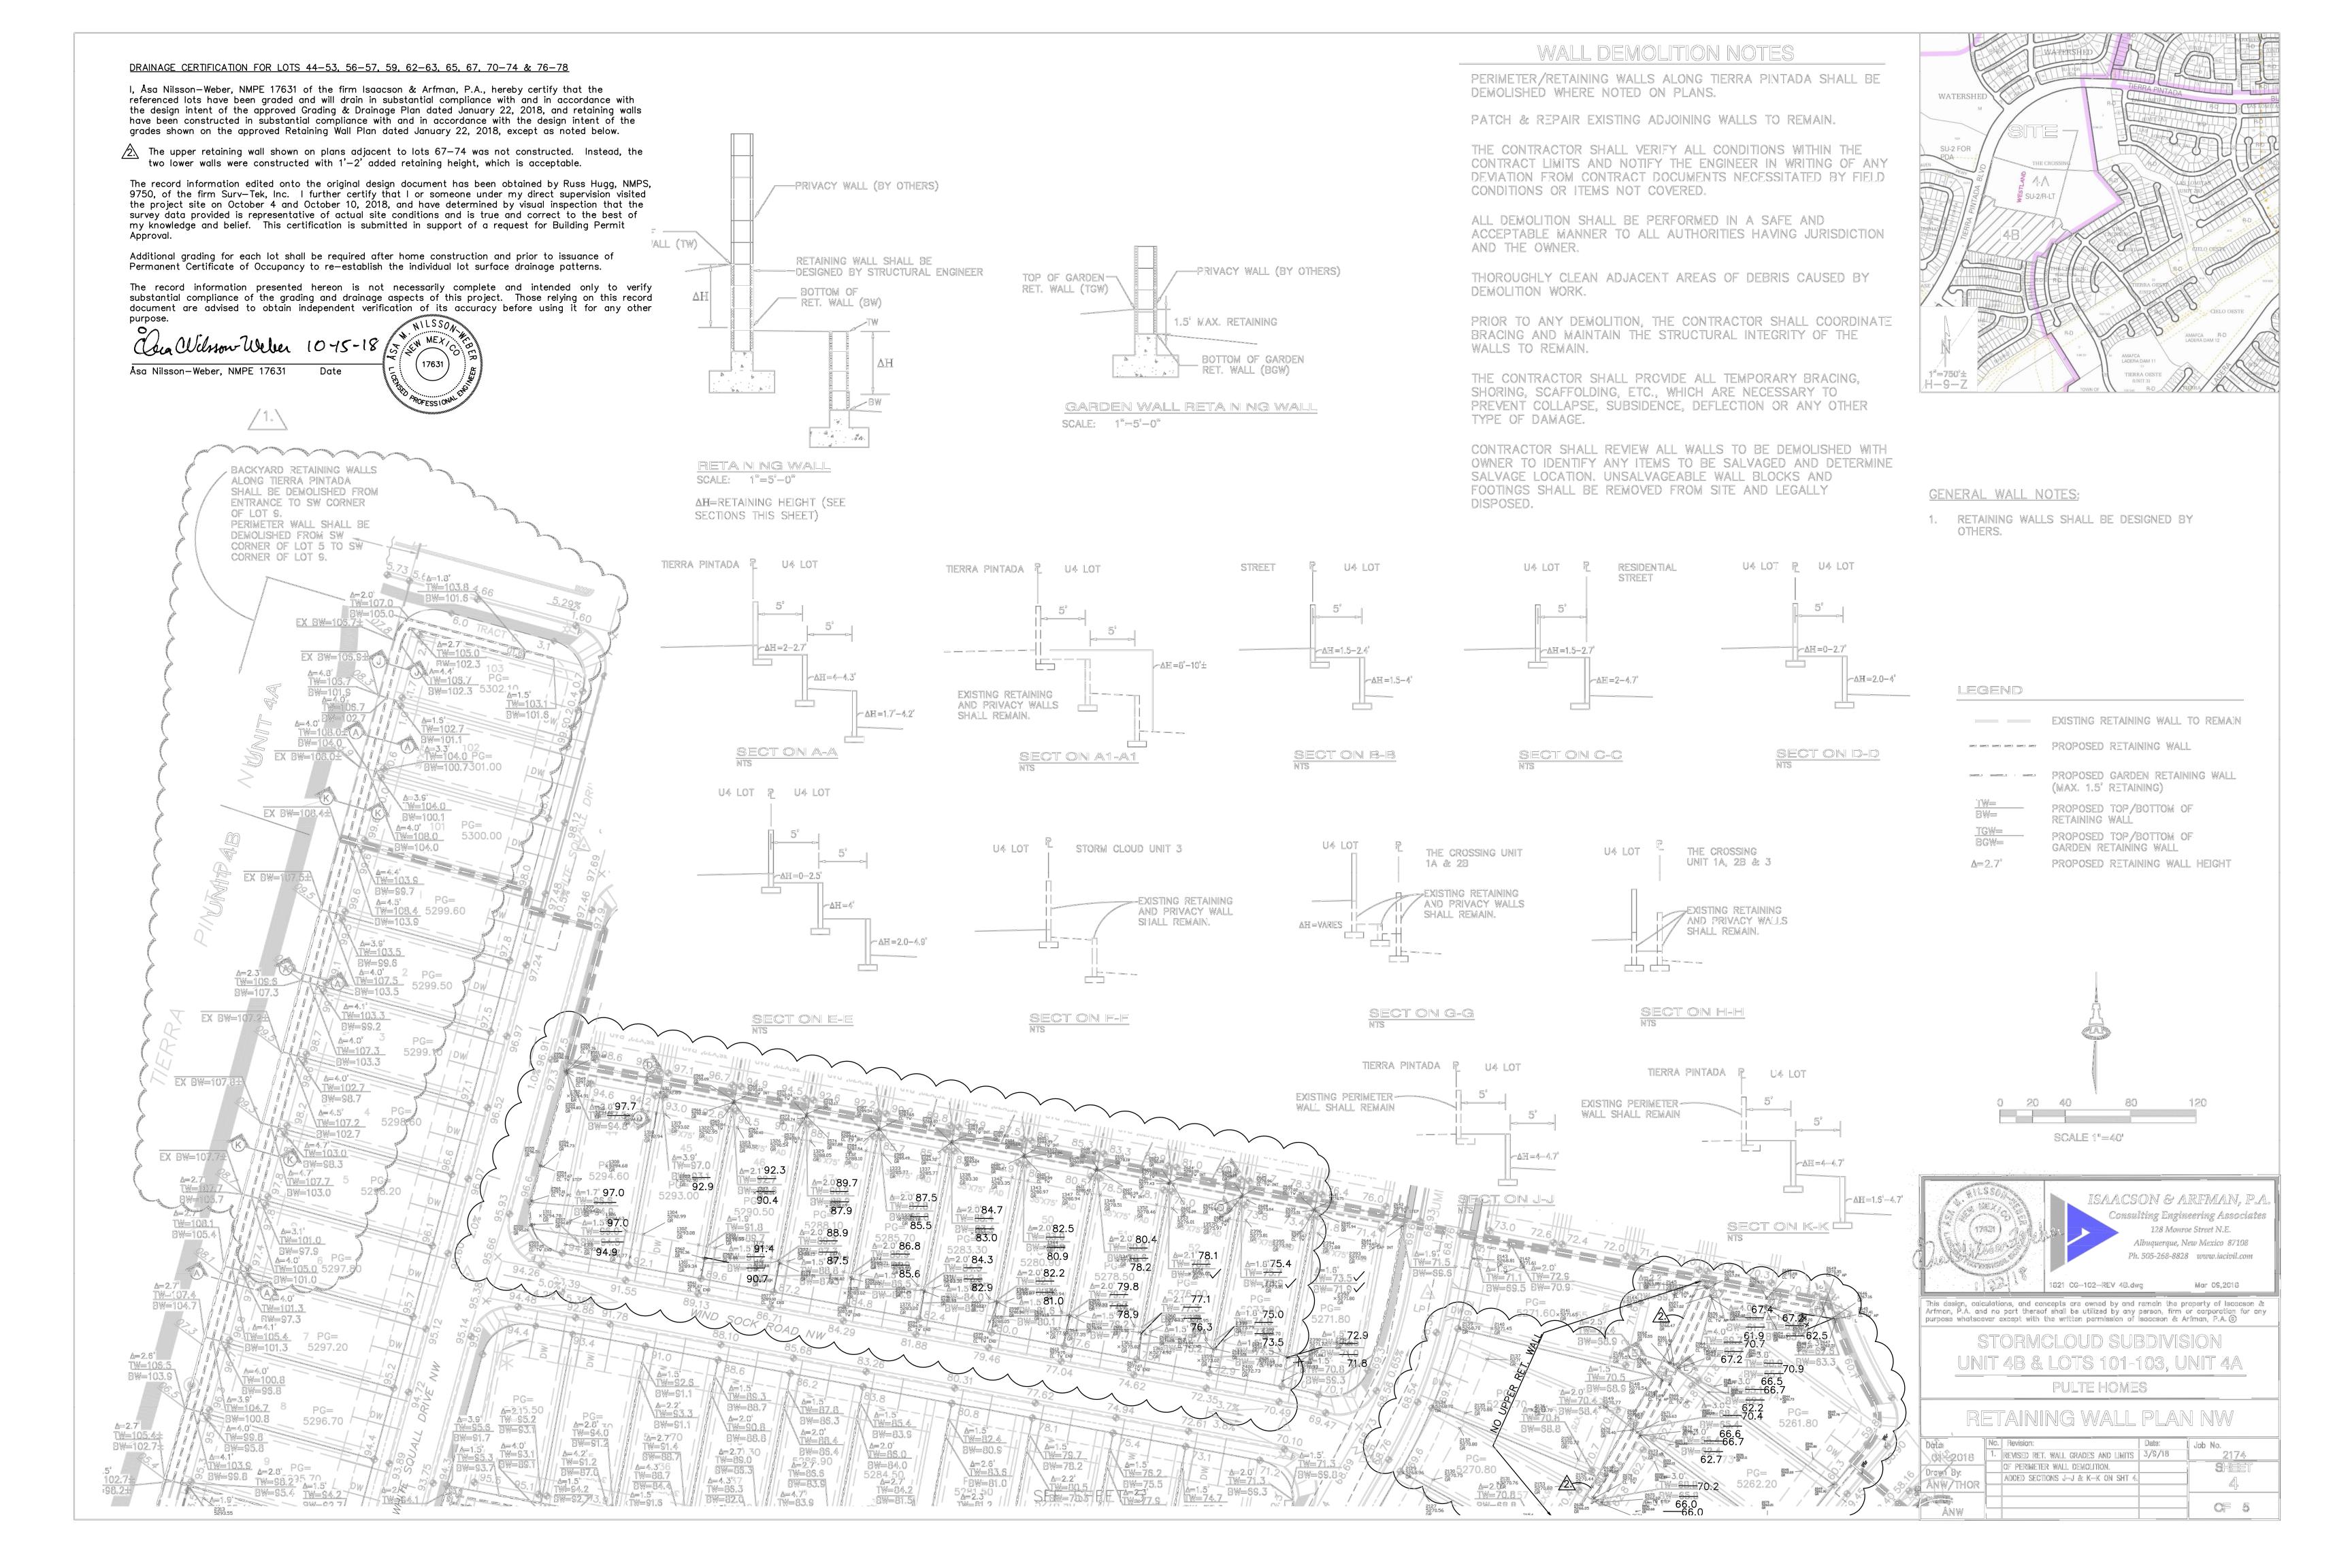

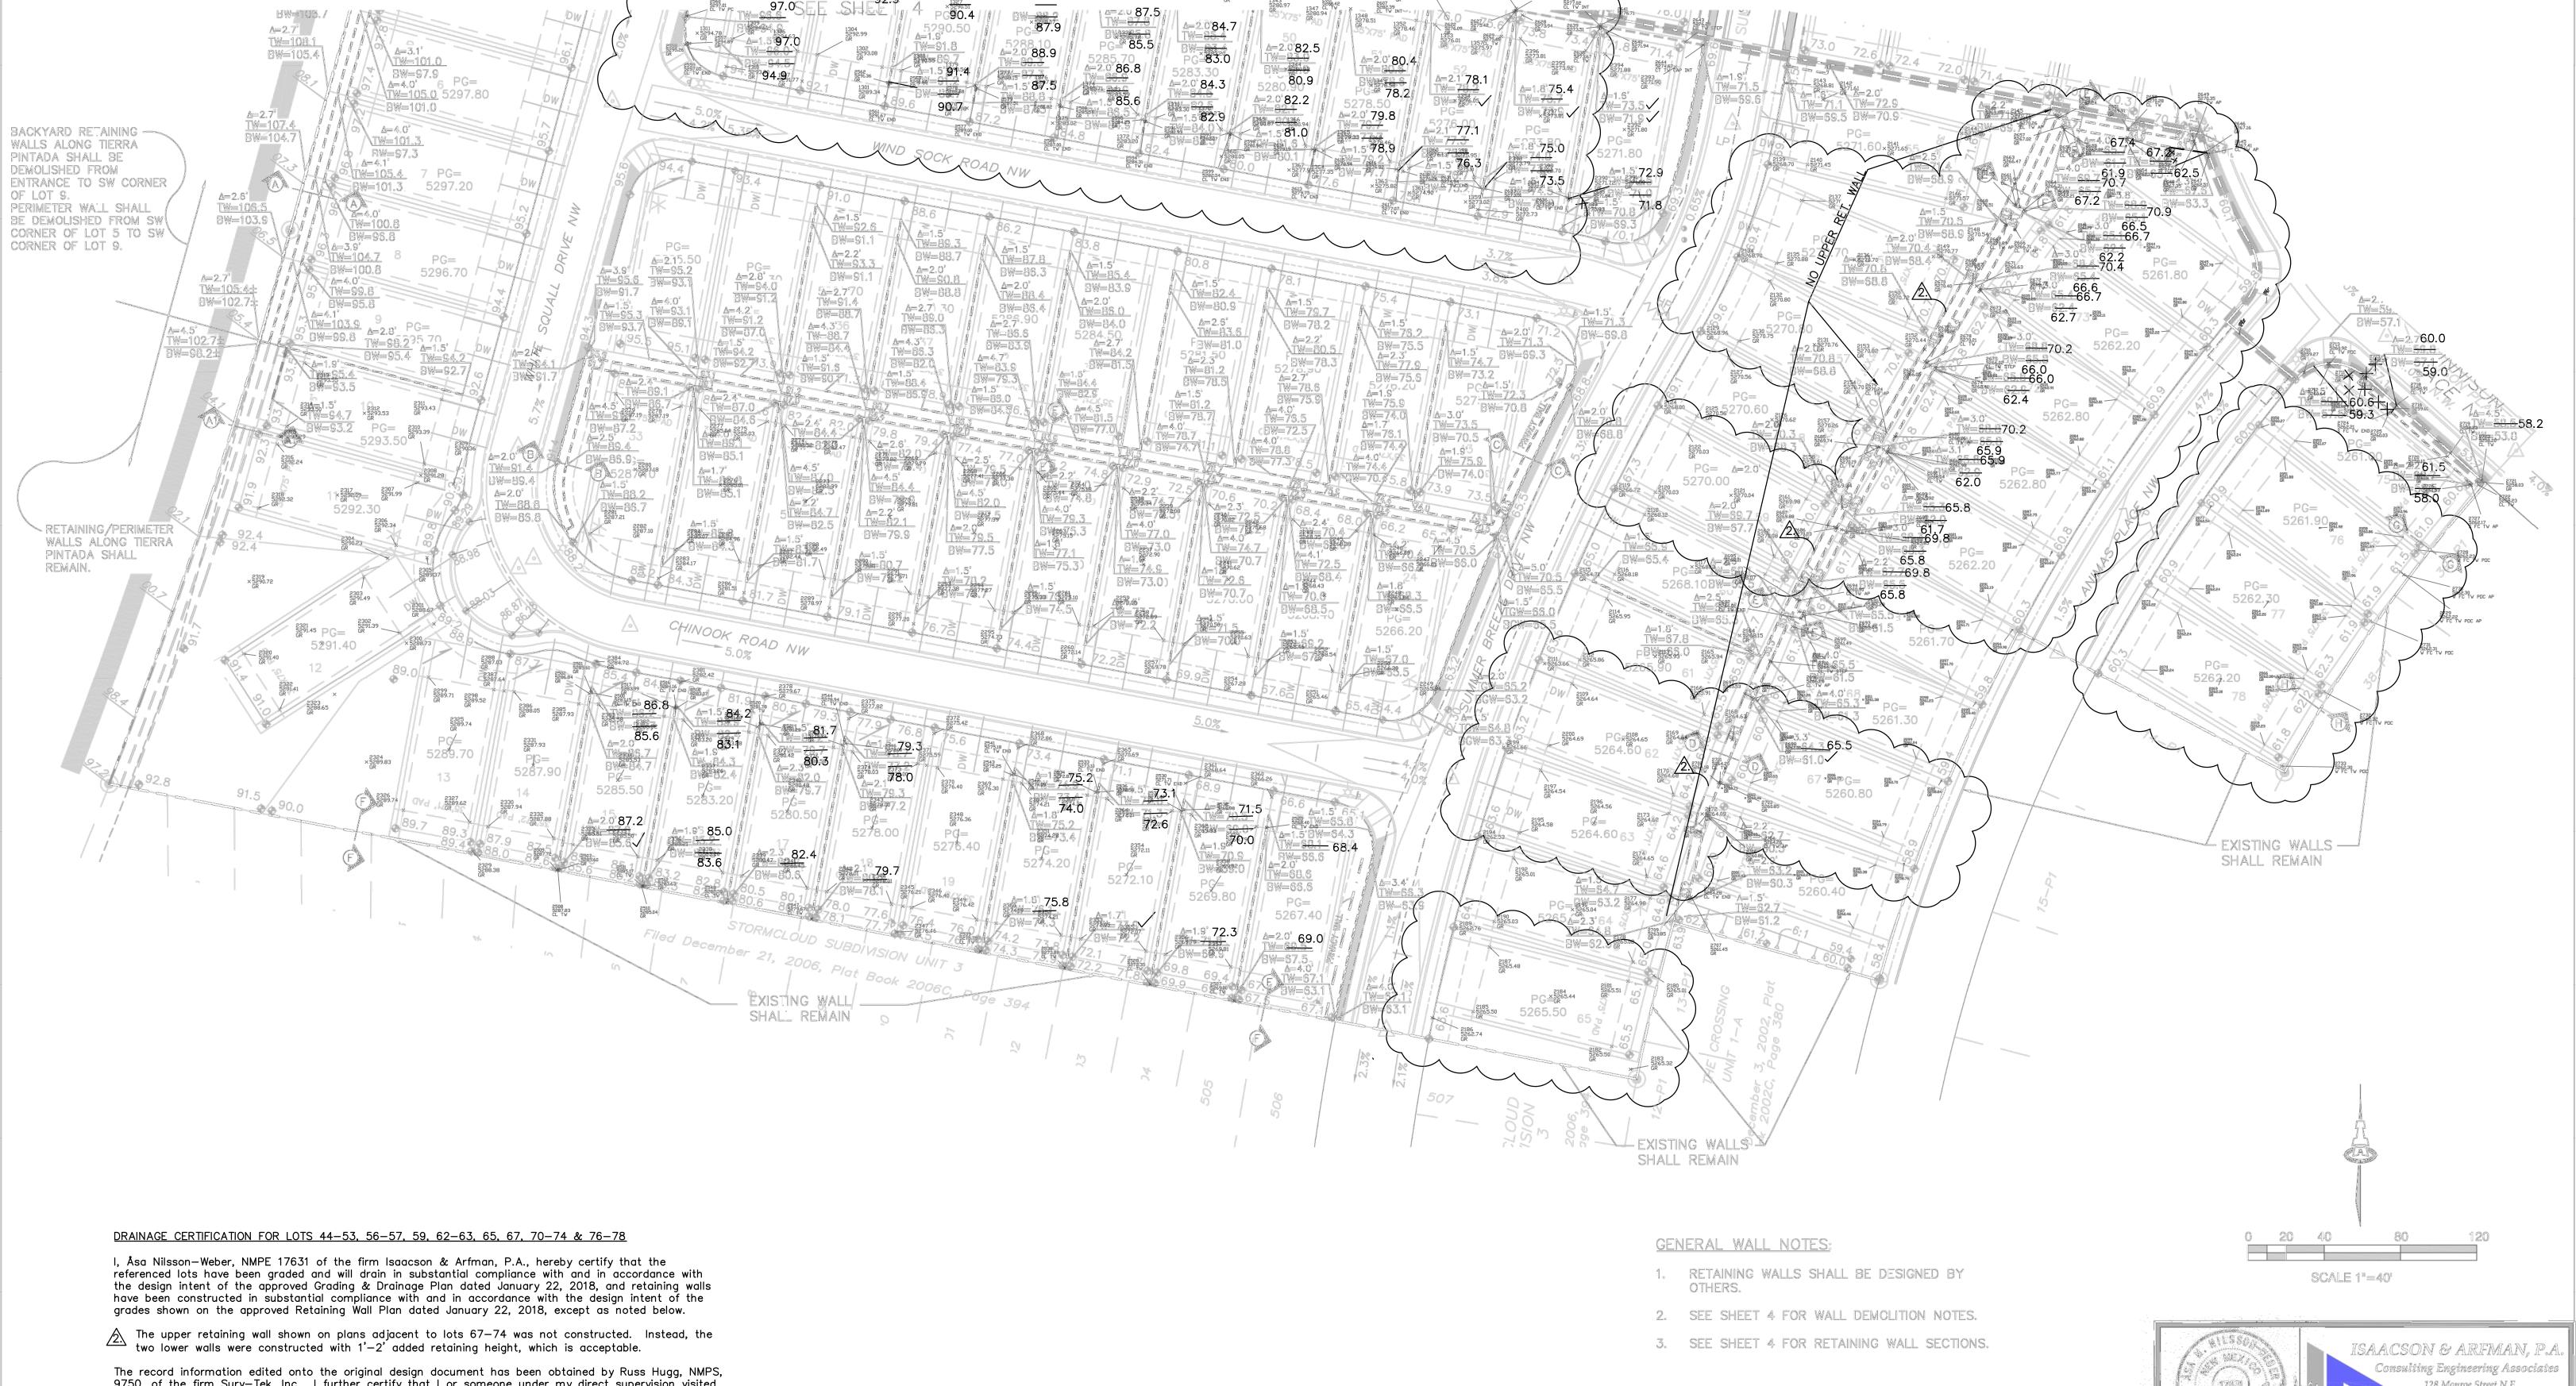

The record information edited onto the original design document has been obtained by Russ Hugg, NMPS, 9750, of the firm Surv—Tek, Inc. I further certify that I or someone under my direct supervision visited the project site on October 4 and October 10, 2018, and have determined by visual inspection that the survey data provided is representative of actual site conditions and is true and correct to the best of my knowledge and belief. This certification is submitted in support of a request for Building Permit Approval.

Additional grading for each lot shall be required after home construction and prior to issuance of Permanent Certificate of Occupancy to re—establish the individual lot surface drainage patterns.

The record information presented hereon is not necessarily complete and intended only to verify substantial compliance of the grading and drainage aspects of this project. Those relying on this record document are advised to obtain independent verification of its accuracy before using it for any other

Åsa Nilsson-Weber, NMPE 17631 Date





LEGEND

BW=

∆=2.7°

---- EXISTING RETAINING WALL TO REMAIN

-- -- PROPOSED GARDEN RETAINING WALL (MAX. 1.5' RETAINING)

PROPOSED TOP/BOTTOM OF RETAINING WALL

PROPOSED TOF/BOTTOM OF GARDEN RETAINING WALL

PROPOSED RETAINING WALL HEIGHT

---- PROPOSED RETAINING WALL

128 Monroe Street N.E. Albuquerque, New Mexico 87108 Ph. 505-268-8828 www.iacivil.com

1821 CG-102-REV 48.dwg Mar 09,2018

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STORMCLOUD SUBDIVISION UNIT 4B & LOTS 101-103, UNIT 4A

PULTE HOMES

RETAINING WALL PLAN SE AND SW

Date:	lo. Revision: Date	Job No.
01-2018	REVISED RET. WALL GRADES AND LIMITS 3/9,	/18 2174
Drawn By:	OF PERIMETER WALL DEMOLITION.	
	ADDED SECTIONS J-J & K-K ON SHT 4.	5
ANW/THOR		2
Ckd By:		
ANW		OF 5



City of Albuquerque

Planning Department

Development & Building Services Division

DRAINAGE AND TRANSPORTATION INFORMATION SHEET (REV 6/2018)

Project Title:Stormcloud Subdivision Unit 4E	3 Building Pern	nit #·	Hydrology File # H09/D022A		
DRB#: 1005029	FPC#:		Work Order#: 691586		
Legal Description: Stormcloud Subdivision	work ordern.				
City Address:					
Applicant: Isaacson & Arfman, PA			Contact: <u>Åsa Nilsson-Weber</u>		
Address: 128 Monroe Street NE - Albuquer			Contact. Aca i incom viose		
Phone#:(505) 268-8828			E-mail: asaw@iacivil.com		
Other Contact: Pulte Homes			Contact: Kevin Patton		
Address: 7601 Jefferson Street NE, Suite 3	20 - Albuque				
-					
Phone#:(505) 341-8591					
TYPE OF DEVELOPMENT: X PLAT	RESID	DENCE	DRB SITE ADMIN SITE		
Check all that Apply:					
DEPARTMENT: X HYDROLOGY/ DRAINAGE TRAFFIC/ TRANSPORTATION		TYPE OF APPI X BUILDING	-57, 62-63, 65, 67, 70-74, 76-78 ROVAL/ACCEPTANCE SOUGHT: G PERMIT APPROVAL UNIT 4B FOR ATE OF OCCUPANCY		
TYPE OF SUBMITTAL:					
ENGINEER/ARCHITECT CERTIFICATION		PRELIMIN	ARY PLAT APPROVAL		
X PAD CERTIFICATION		SITE PLAN FOR SUB'D APPROVAL SITE PLAN FOR BLDG. PERMIT APPROVAL			
CONCEPTUAL G & D PLAN					
GRADING PLAN		FINAL PL	AT APPROVAL		
DRAINAGE REPORT					
DRAINAGE MASTER PLAN		RELEASE OF FINANCIAL GUARANTEE			
FLOODPLAIN DEVELOPMENT PERMIT AF	PPLIC	FOUNDATION PERMIT APPROVAL			
ELEVATION CERTIFICATE		GRADING PERMIT APPROVAL			
CLOMR/LOMR		SO-19 APPROVAL PAVING PERMIT APPROVAL GRADING/ PAD CERTIFICATION			
TRAFFIC CIRCULATION LAYOUT (TCL)					
TRAFFIC IMPACT STUDY (TIS)					
STREET LIGHT LAYOUT		CLOMR/LO	ORDER APPROVAL		
OTHER (SPECIFY) PRE-DESIGN MEETING?			AIN DEVELOPMENT PERMIT		
S THIS A RESUBMITTAL?: Yes _X_ No			PECIFY)		
DATE SUBMITTED: October 15, 2018		lilsson-Weber			
	*				
COA STAFF:	ELECTRONIC SI	JBMITTAL RECEIVED:	: <u> </u>		
	FEE PAID:				