

CITY OF ALBUQUERQUE



June 2, 2017

Asa Nilsson-Weber, P.E.
Isaacson & Arfman, PA
128 Monroe St NE
Albuquerque, NM 87108

**Re: Storm Cloud Unit 4 Lots 25-42
Request for Engineer Pad Certification - Accepted
Engineer's Stamp dated: 11-7-16 (H09D022A)
Certification dated: 5-30-17**

Dear Ms. Nilsson-Weber,

Based upon the information provided in your submittal received 5/30/2017, the above referenced Certification is acceptable for building permit.

If you have any questions, you can contact me at 924-3986 or Totten Elliott at 924-3982.

PO Box 1293

Sincerely,

Albuquerque

New Mexico 87103



James D. Hughes, P.E.
Principal Engineer, Planning Dept.
Development and Review Services

www.cabq.gov


TE/JH
C: email

SEE SHEET 1


SEE SHEET 2

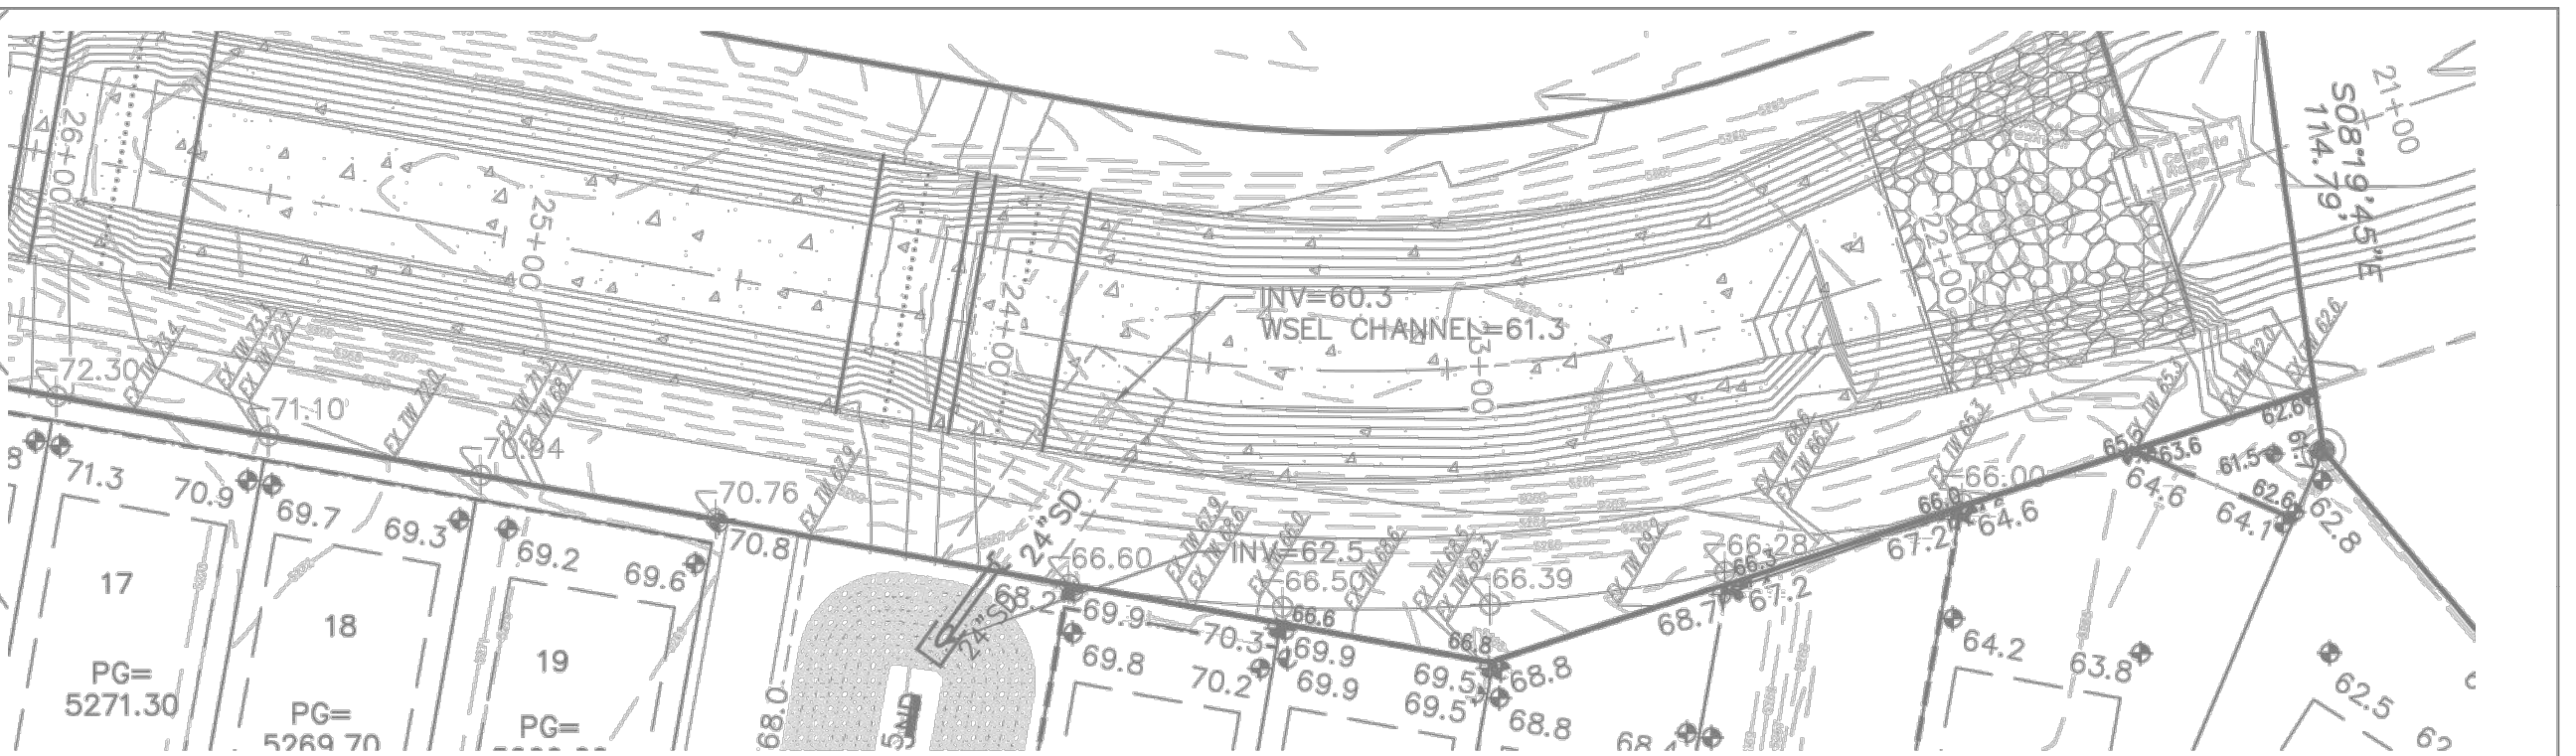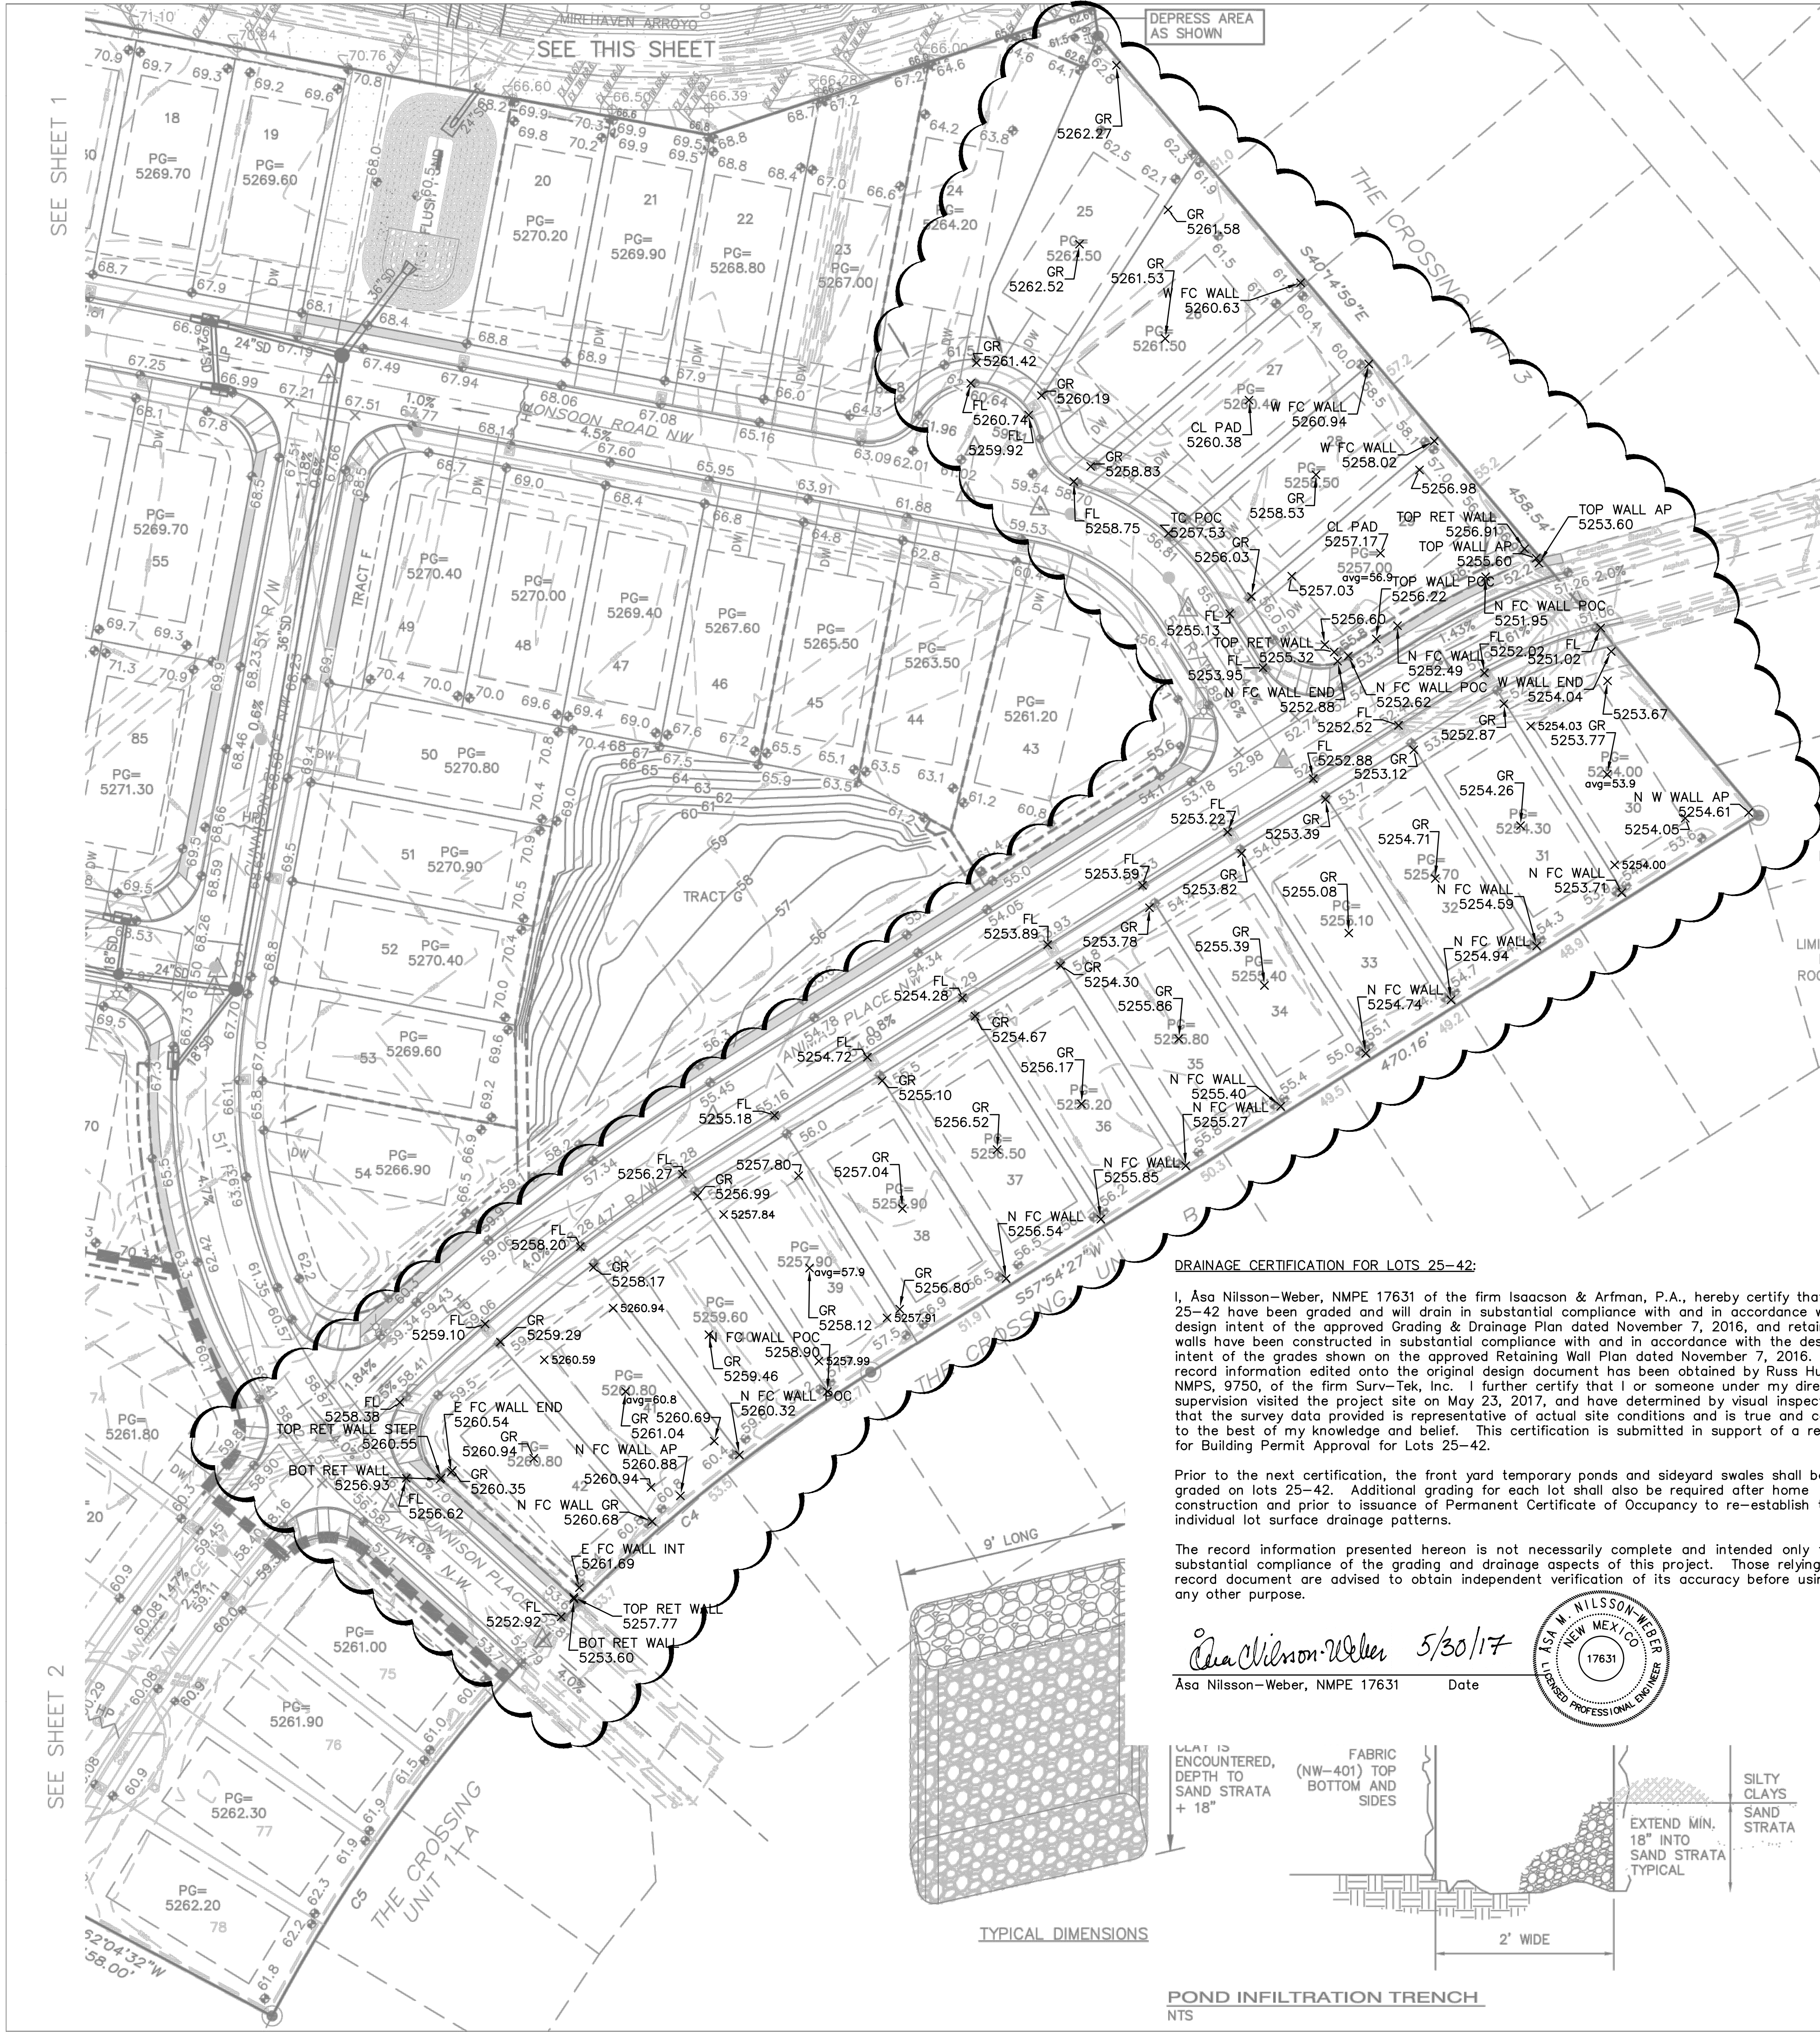


MIREHAVEN ARROYO
SCALE: 1"=40'

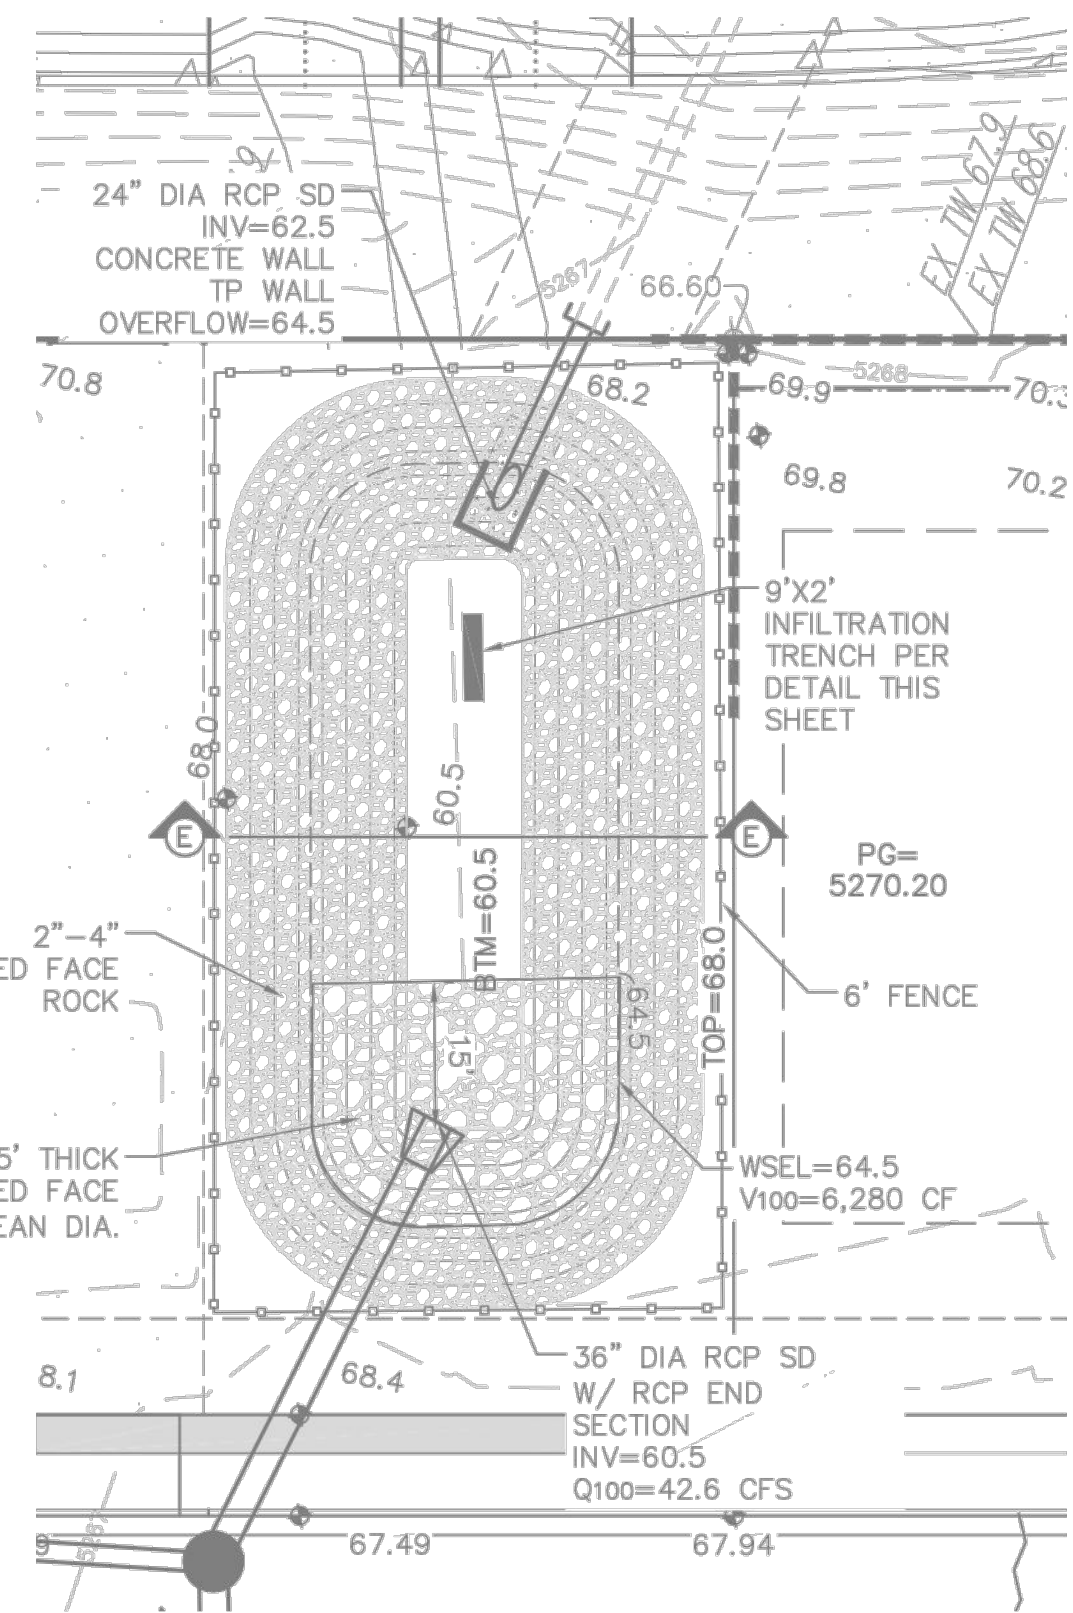

POND SHALL BE CONSTRUCTED WITH WORK ORDER PLANS
FIRST FLUSH POND
SCALE: 1"=20'

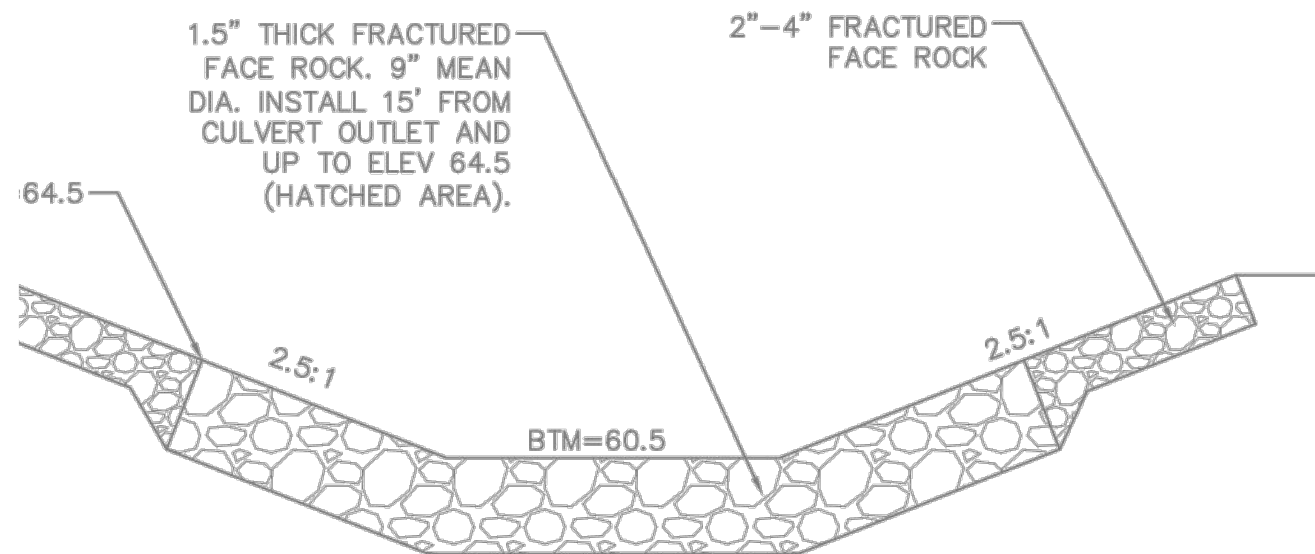

SECTION E1-E1
NTS

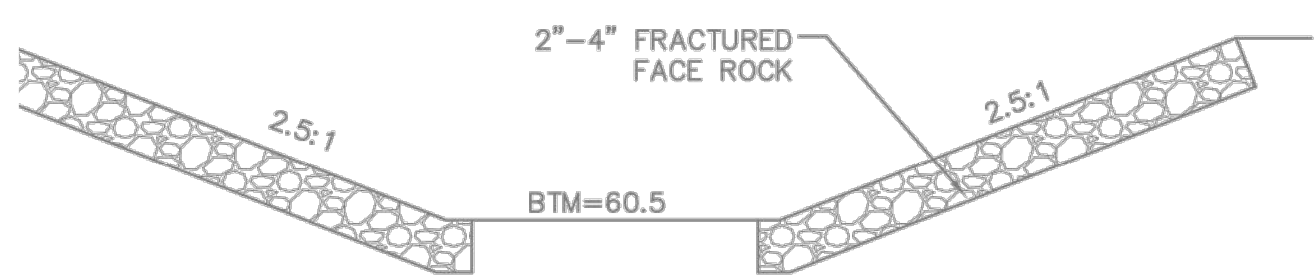


SECTION E2-E2
NTS

NOTES:

- STREET GRADES ARE AT FLOWLINE.
- SEE SHEETS 5-8 FOR RETAINING WALL GRADES AND SECTIONS.
- SEE SHEET 9 FOR EXISTING WALLS TO BE DEMOLISHED AND EXISTING WALLS TO REMAIN

LEGEND

- EXISTING CONTOUR
- PROPOSED CONTOUR
- PROPOSED ELEVATION
- PROPOSED ELEV. AT TIERRA PINTADA R/W
- PAD GRADE ELEVATION
- STANDARD (STD) CURB & GUTTER
- MOUNTABLE (MTBL) CURB & GUTTER
- STORM DRAIN W/ MANHOLE
- STORM DRAIN INLET
- PROPOSED RETAINING WALL (DESIGN BY OTHERS)
- RECOMMENDED DRIVEWAY LOCATION

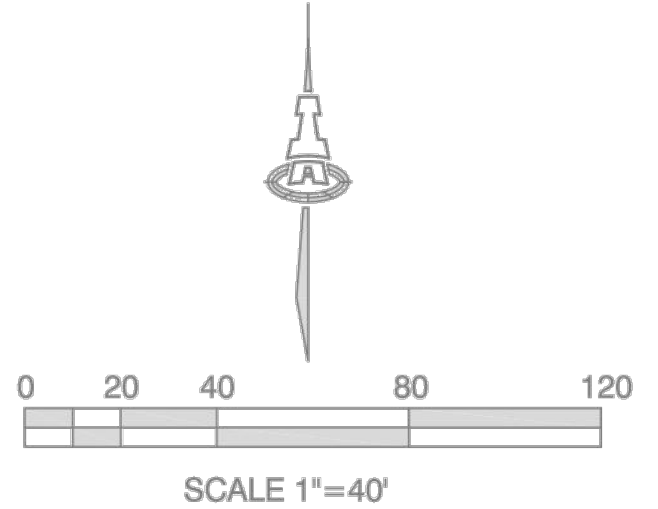


DRAINAGE CERTIFICATION FOR LOTS 25-42:

I, Asa Nilsson-Weber, NMPE 17631 of the firm Isaacson & Arfman, P.A., hereby certify that Lots 25-42 have been graded and will drain in substantial compliance with and in accordance with the design intent of the approved Grading & Drainage Plan dated November 7, 2016, and retaining walls have been constructed in substantial compliance with and in accordance with the design intent of the grades shown on the approved Retaining Wall Plan dated November 7, 2016. The record information edited onto the original design document has been obtained by Russ Hugg, NMPS, 9750, of the firm Surv-Tek, Inc. I further certify that I or someone under my direct supervision visited the project site on May 23, 2017, and have determined by visual inspection that the survey data provided is representative of actual site conditions and is true and correct to the best of my knowledge and belief. This certification is submitted in support of a request for Building Permit Approval for Lots 25-42.

Prior to the next certification, the front yard temporary ponds and sideyard swales shall be graded on lots 25-42. Additional grading for each lot shall also be required after home construction and prior to issuance of Permanent Certificate of Occupancy to re-establish the individual lot surface drainage patterns.

The record information presented hereon is not necessarily complete and intended only to verify substantial compliance of the grading and drainage aspects of this project. Those relying on this record document are advised to obtain independent verification of its accuracy before using it for any other purpose.

Asa Nilsson-Weber 5/30/17
Asa Nilsson-Weber, NMPE 17631 Date

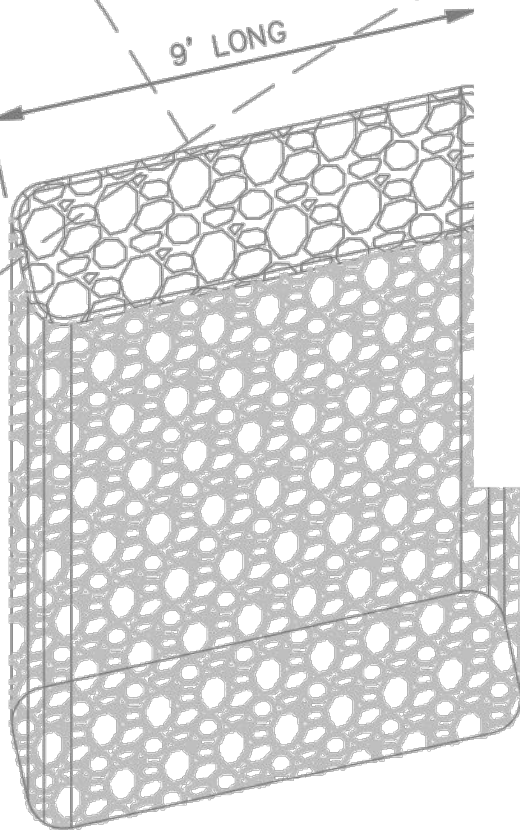

TYPICAL DIMENSIONS

POND INFILTRATION TRENCH
NTS

ISAACSON & ARFMAN, P.A.
Consulting Engineering Associates
128 Monroe Street N.E.
Albuquerque, New Mexico 87108
Ph. 505-268-8828 www.isaactail.com


1821 CG-101.dwg Nov 07,2016

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STORMCLOUD SUBDIVISION
UNITS 4A & 4B
PULTE HOMES

GRADING AND DRAINAGE PLAN NE


Date: 08-2016	No. Revision:	Date:	Job No. 2174
Drawn By: ANW/THOR			SHEET 3
Ckd By: ANW			OF 9

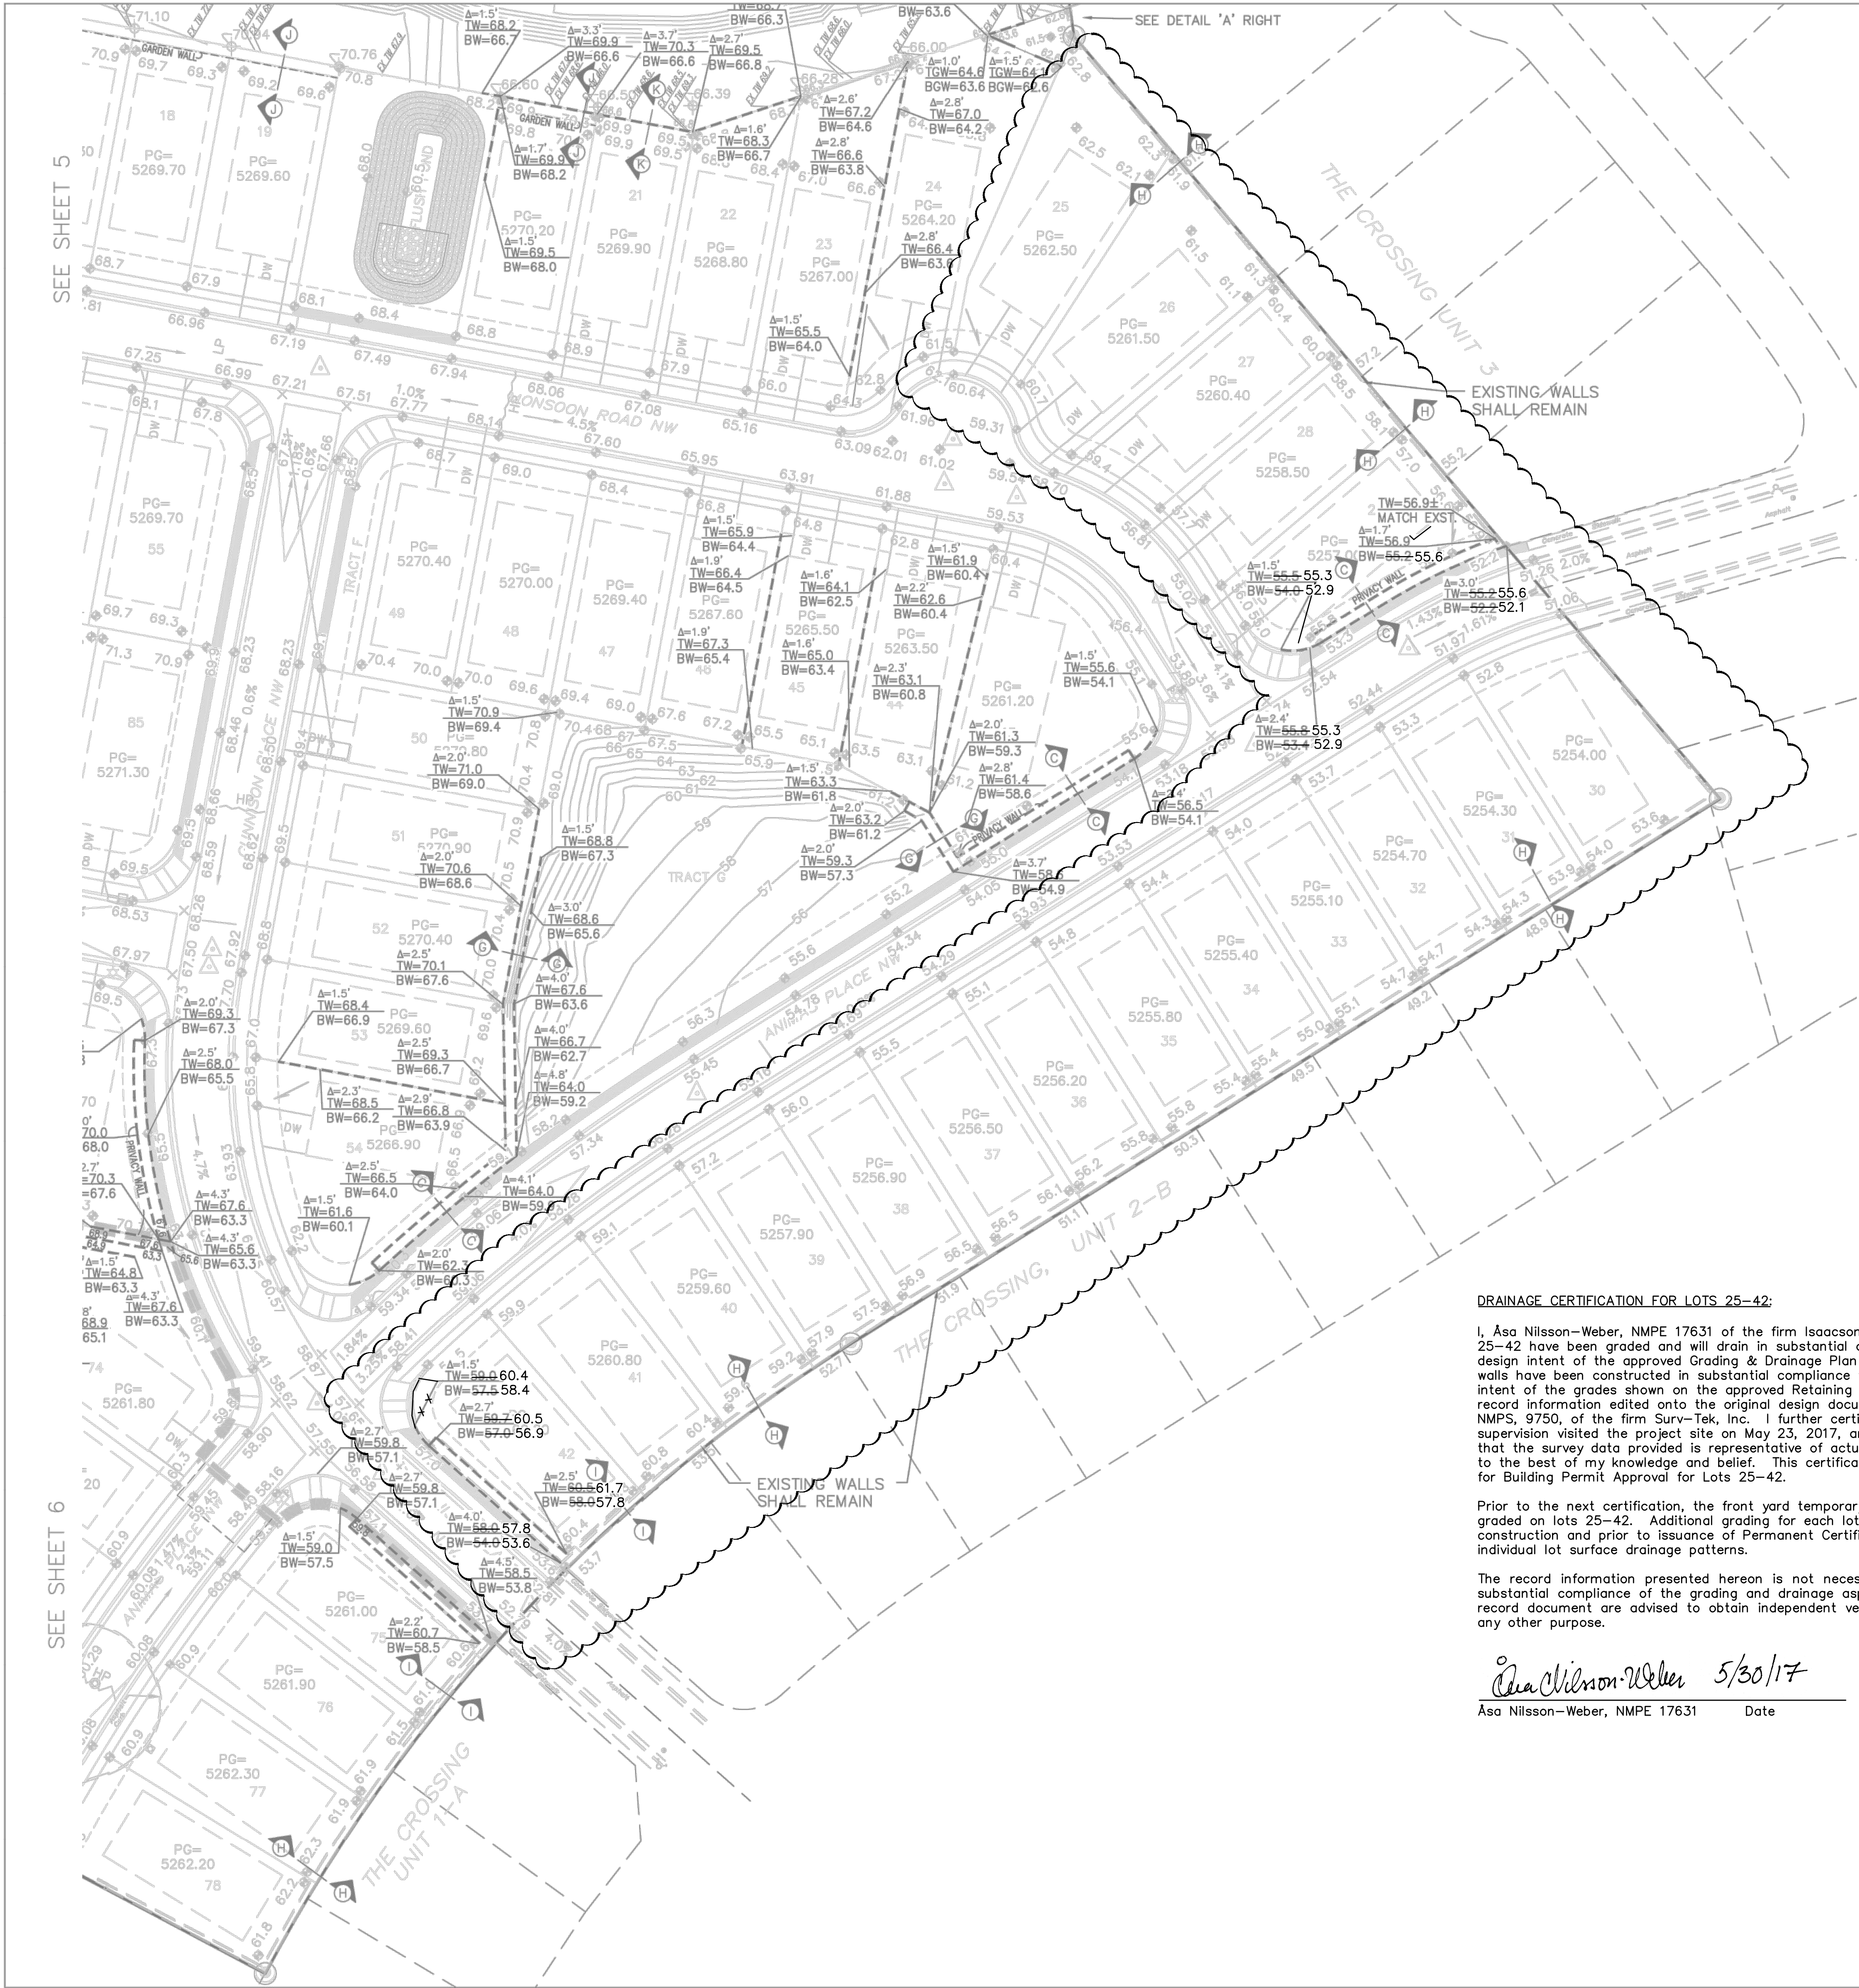

DETAIL 'A'
SCALE: 1"=40'

- GENERAL WALL NOTES:
- RETAINING WALL DESIGN BY OTHERS.
 - ALL EXISTING RETAINING WALLS AND PERIMETER WALLS SHALL BE REMOVED, UNLESS OTHERWISE NOTED.
 - SEE SHEET 8 FOR RETAINING WALL SECTIONS.
 - SEE SHEET 9 FOR EXISTING WALLS TO BE DEMOLISHED AND EXISTING WALLS TO REMAIN.

- LEGEND
- EXISTING RETAINING WALL TO REMAIN
 - PROPOSED RETAINING WALL
 - PROPOSED GARDEN RETAINING WALL (MAX. 1.5' RETAINING)
 - TW= PROPOSED TOP/BOTTOM OF RETAINING WALL
 - BW= PROPOSED TOP/BOTTOM OF GARDEN RETAINING WALL
 - Δ=2.7' PROPOSED RETAINING WALL HEIGHT

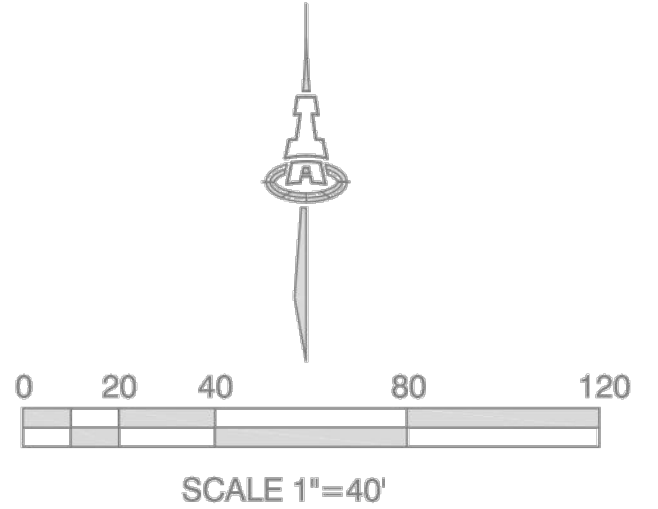


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Asa Nilsson-Weber 5/30/17
Asa Nilsson-Weber, NMPE 17631 Date



ISAACSON & ARFMAN, P.A.
Consulting Engineering Associates
128 Monroe Street N.E.
Albuquerque, New Mexico 87108
Ph. 505-268-8828 www.isacvll.com

1821 CG-102.dwg Nov 07,2016

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**STORMCLOUD SUBDIVISION
UNITS 4A & 4B
PULTE HOMES**

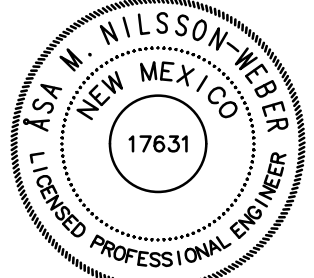RETAINING WALL PLAN NE

Date: 08-2016	No. Revision:	Date:	Job No. 2174
Drawn By: ANW/THOR			SHEET 7
Ckd By: ANW			OF 9

SEE SHEET 5

SEE SHEET 6



City of Albuquerque

Planning Department

Development & Building Services Division

DRAINAGE AND TRANSPORTATION INFORMATION SHEET (REV 09/2015)

Project Title: _____ **Building Permit #:** _____ **City Drainage #:** _____

DRB#: _____ **EPC#:** _____ **Work Order#:** _____

Legal Description: _____

City Address: _____

Engineering Firm: _____ **Contact:** _____

Address: _____

Phone#: _____ **Fax#:** _____ **E-mail:** _____

Owner: _____ **Contact:** _____

Address: _____

Phone#: _____ **Fax#:** _____ **E-mail:** _____

Architect: _____ **Contact:** _____

Address: _____

Phone#: _____ **Fax#:** _____ **E-mail:** _____

Other Contact: _____ **Contact:** _____

Address: _____

Phone#: _____ **Fax#:** _____ **E-mail:** _____

Check all that Apply:

DEPARTMENT:

- ☒ HYDROLOGY/ DRAINAGE
☐ TRAFFIC/ TRANSPORTATION
☐ MS4/ EROSION & SEDIMENT CONTROL

TYPE OF SUBMITTAL:

- ☒ ENGINEER ARCHITECT CERTIFICATION
☐ CONCEPTUAL G & D PLAN
☐ GRADING PLAN
☐ DRAINAGE MASTER PLAN
☐ DRAINAGE REPORT
☐ CLOMR/LOMR
☐ TRAFFIC CIRCULATION LAYOUT (TCL)
☐ TRAFFIC IMPACT STUDY (TIS)
☐ EROSION & SEDIMENT CONTROL PLAN (ESC)
☐ OTHER (SPECIFY) _____

IS THIS A RESUBMITTAL?: ☐ Yes ☒ No

CHECK TYPE OF APPROVAL/ACCEPTANCE SOUGHT:

- ☒ BUILDING PERMIT APPROVAL **LOTS 25 thru 42**
☐ CERTIFICATE OF OCCUPANCY
☐ PRELIMINARY PLAT APPROVAL
☐ SITE PLAN FOR SUB'D APPROVAL
☐ SITE PLAN FOR BLDG. PERMIT APPROVAL
☐ FINAL PLAT APPROVAL
☐ SIA/ RELEASE OF FINANCIAL GUARANTEE
☐ FOUNDATION PERMIT APPROVAL
☐ GRADING PERMIT APPROVAL
☐ SO-19 APPROVAL
☐ PAVING PERMIT APPROVAL
☒ GRADING/ PAD CERTIFICATION
☐ WORK ORDER APPROVAL
☐ CLOMR/LOMR
☐ PRE-DESIGN MEETING
☐ OTHER (SPECIFY) _____

DATE SUBMITTED: May 30, 2017 **By:** Åsa Nilsson-Weber

COA STAFF: _____ ELECTRONIC SUBMITTAL RECEIVED: _____