
CITY OF ALBUQUERQUE

Planning Department Alan Varela, Director

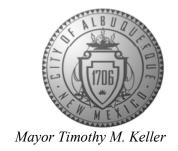

April 29, 2025

Jared Baeza Square Root Services, LLC 6701 Edith Blvd NE Unit: Suite A Albuquerque, NM 87113

RE: La Morada Commercial Development 7501 La Morada NW Grading and Drainage Plans Engineer's Stamp Date: 07/02/2024 Hydrology File: H10D039

Case # HYDR-2025-00035

Dear Mr. Baeza:

Based upon the information provided in your submittal received 02/13/2025, the Grading & Drainage Plans **are approved** for Grading Permit and Building Permit.

PO Box 1293

PRIOR TO CERTIFICATE OF OCCUPANCY:

Albuquerque

1. Engineer's Certification, per the DPM Part 6-14 (F): *Engineer's Certification Checklist For Non-Subdivision* is required.

2. Please provide the executed paper Drainage Covenant (latest revision) printed on one-side only with Exhibit A and a check for \$25.00 made out to "Bernalillo County" for the underground stormwater quality ponds per Article 6-15(C) of the DPM to Hydrology for review at Plaza de Sol. Application for Covenant in ABQ-PLAN is also required

www.cabq.gov

NM 87103

As a reminder, if the project total area of disturbance (including the staging area and any work within the adjacent Right-of-Way) is 1 acre or more, then an Erosion and Sediment Control (ESC) Plan and Owner's certified Notice of Intent (NOI) is required to be submitted to the Stormwater Quality Engineer (Doug Hughes, PE, jhughes@cabq.gov, 924-3420) 14 days prior to any earth disturbance.

If you have any questions, please contact me at 505-924-3314 or <u>amontoya@cabq.gov</u>.

Sincerely,


Anthony Montoya, Jr., P.E. Senior Engineer, Hydrology


anth Mars

Planning Department, Development Review Services

TOPOGRAPHIC SURVEY

TRACT 3, PLAT FOR LADERA BUSINESS PARK, UNIT 1, TOWN OF ATRISCO GRANT, PROJECTED SECTIONS 9 AND 10, TOWNSHIP 10 NORTH, RANGE 2 EAST, N.M.P.M., CITY OF ALBUQUERQUE, BERNALILLO COUNTY, NEW MEXICO

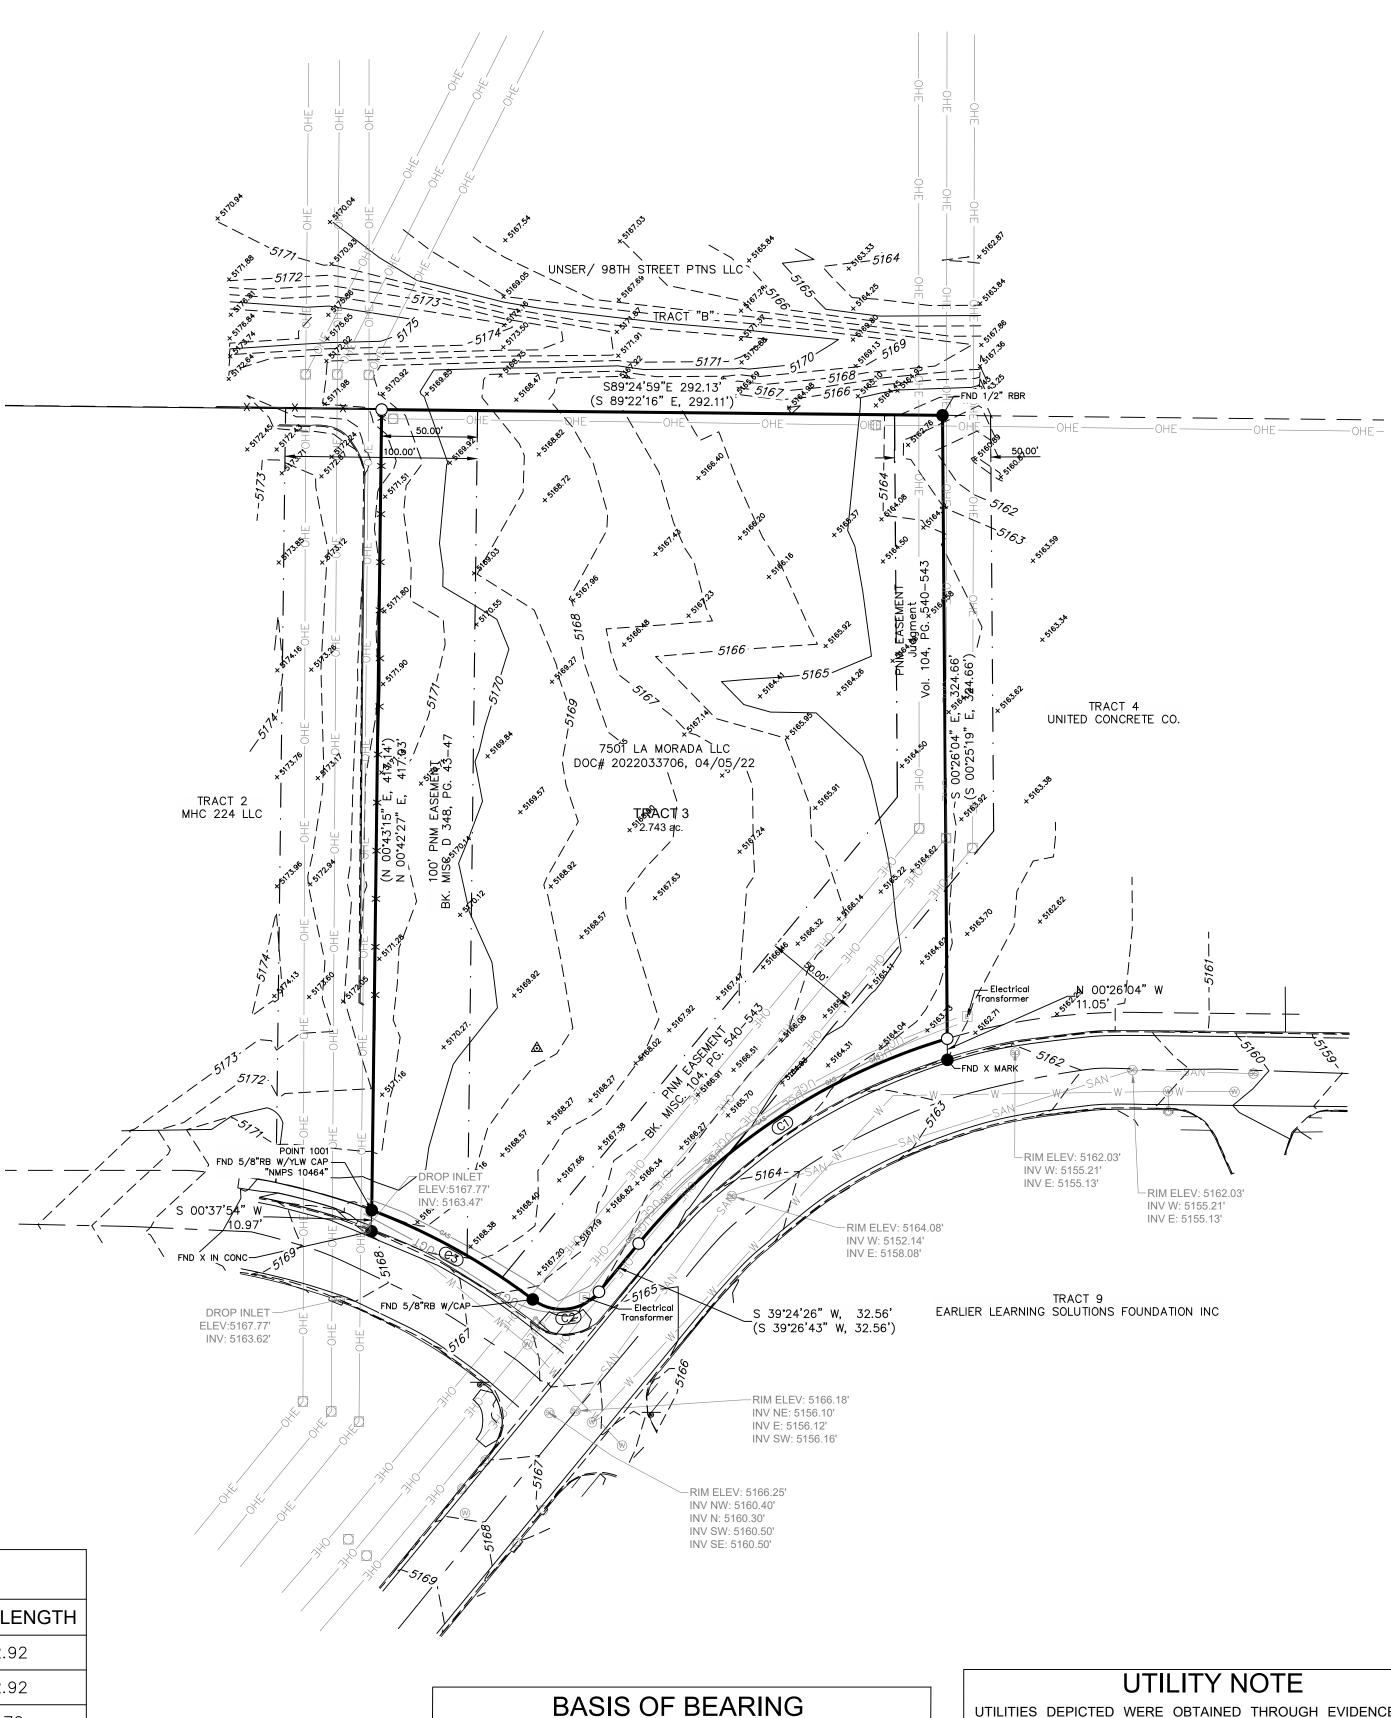

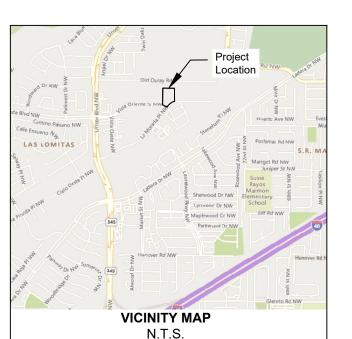

	CURVE TABLE				
CURVE#	ARC LENGTH	RADIUS	DELTA ANGLE	CHORD BEARING	CHORD LENGTH
C1 (MEASURED)	195.78	330.00	33°59'30"	S56°25'28"W	192.92
C1 (RECORDED)	195.78	330.00	33°59'29"	S56°26'27"W	192.92
C2 (MEASURED)	38.40	24.96	88°08'52"	S83°22'44"W	34.72
C2 (RECORDED)	38.37	25.00	87°56'37"	S83°25'01"W	34.72
C3 (MEASURED)	96.22	332.14	16°35'52"	N60°59'56"W	95.88
C3 (RECORDED)	95.84	330.00	16°41'58"	N60°57'39"W	95.84

BEARINGS SHOWN HEREON ARE FROM GPS/GNSS OBSERVATIONS AND CONFORM TO THE NEW MEXICO STATE PLANE COORDINATE SYSTEM "NEW MEXICO CENTRAL ZONE" NORTH AMERICAN DATUM OF 1983. TRUE NORTH CAN BE OBTAINED BY APPLYING A CONVERGENCE ANGLE OF 00°16'24.72" AT POINT NUMBER 1001, A FOUND 5/8 INCH REBAR WITH YELLOW PLASTIC CAP MARKED "NMPS 10464" LOCATED AT N 1495990.02, E 1498188.55. DISTANCES SHOWN HEREON ARE IN GROUND AND WERE OBTAINED BY APPLYING A COMBINED GRID TO GROUND SCALE FACTOR OF 1.0003208444 AT THE PREVIOUSLY NOTED POINT.

UTILITIES DEPICTED WERE OBTAINED THROUGH EVIDENCE: FROM FIELD OBSERVATIONS, PLANS AND/OR REPORTS PROVIDED BY THE CLIENT, AND MARKINGS COORDINATED BY THE NEW MEXICO 811. HOWEVER, LACKING EXCAVATION, THE EXACT LOCATION OF UNDERGROUND FEATURE CANNOT BE ACCURATELY, COMPLETELY, AND RELIABLY DEPICTED. WHERE ADDITIONAL OR MORE DETAILED INFORMATION IS REQUIRED, THE CLIENT IS ADVISED THAT **EXCAVATION MAY BE NECESSARY.**

I, JEREMY BAKER, NEW MEXICO PROFESSIONAL SURVEYOR NO. 25773, DO HEREBY CERTIFY THAT THIS TOPOGRAPHIC SURVEY PLAT AND THE ACTUAL SURVEY ON THE GROUND UPON WHICH IT IS BASED WERE PERFORMED BY ME OR UNDER MY DIRECT SUPERVISION; THAT I AM RESPONSIBLE FOR THIS SURVEY; THAT THIS SURVEY MEETS THE MINIMUM STANDARDS FOR SURVEYING IN NEW MEXICO; AND THAT IT IS TRUE AND CORRECT TO THE BEST OF MY KNOWLEDGE AND BELIEF. I FURTHER CERTIFY THAT THIS SURVEY IS NOT A LAND DIVISION OR SUBDIVISION AS DEFINED IN THE NEW MEXICO SUBDIVISION ACT AND THAT THIS INSTRUMENT IS A TOPOGRAPHIC SURVEY PLAT OF AN EXISTING TRACT OR TRACTS.

05/03/2024

Deremy Baker, N.M. P.S 25773

SURVEYOR NOTE

THIS IS NOT A BOUNDARY SURVEY OR A RIGHT-OF-WAY SURVEY. APPARENT PROPERTY CORNERS, RIGHT-OF-WAY LINES, OR PROPERTY LINES AS SHOWN ARE DERIVED FROM RECORD SURVEY PLATS, RIGHT-OF-WAY MAPS, OR DEEDS REFERENCED HEREON AND ARE NOT GUARANTEED OR TO BE RELIED ON FOR THE ESTABLISHMENT OF PROPERTY LINES.



7921 N World Dr. Hobbs, NM 88242-9032 Squarerootservices.net 575-231-7347

TYPE OF SURVEY:

TOPOGRAPHIC SURVEY

PROJECT NAME:


LA MORADA

THEODORE JARAMILLO

PROJECT NUMBER:

23192

Jeremy Baker, PS DRAWN BY: Vanessa Munoz

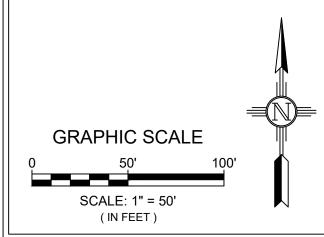



LEGEND

Set 5/8 inch rebar w/blue plastic cap marked "Baker NM PS25773" unless otherwise noted Found Monument as noted Utility Pole Storm Drain Fire Hydrant

REVISIONS		
No.	DATE	DESCRIPTION



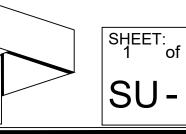

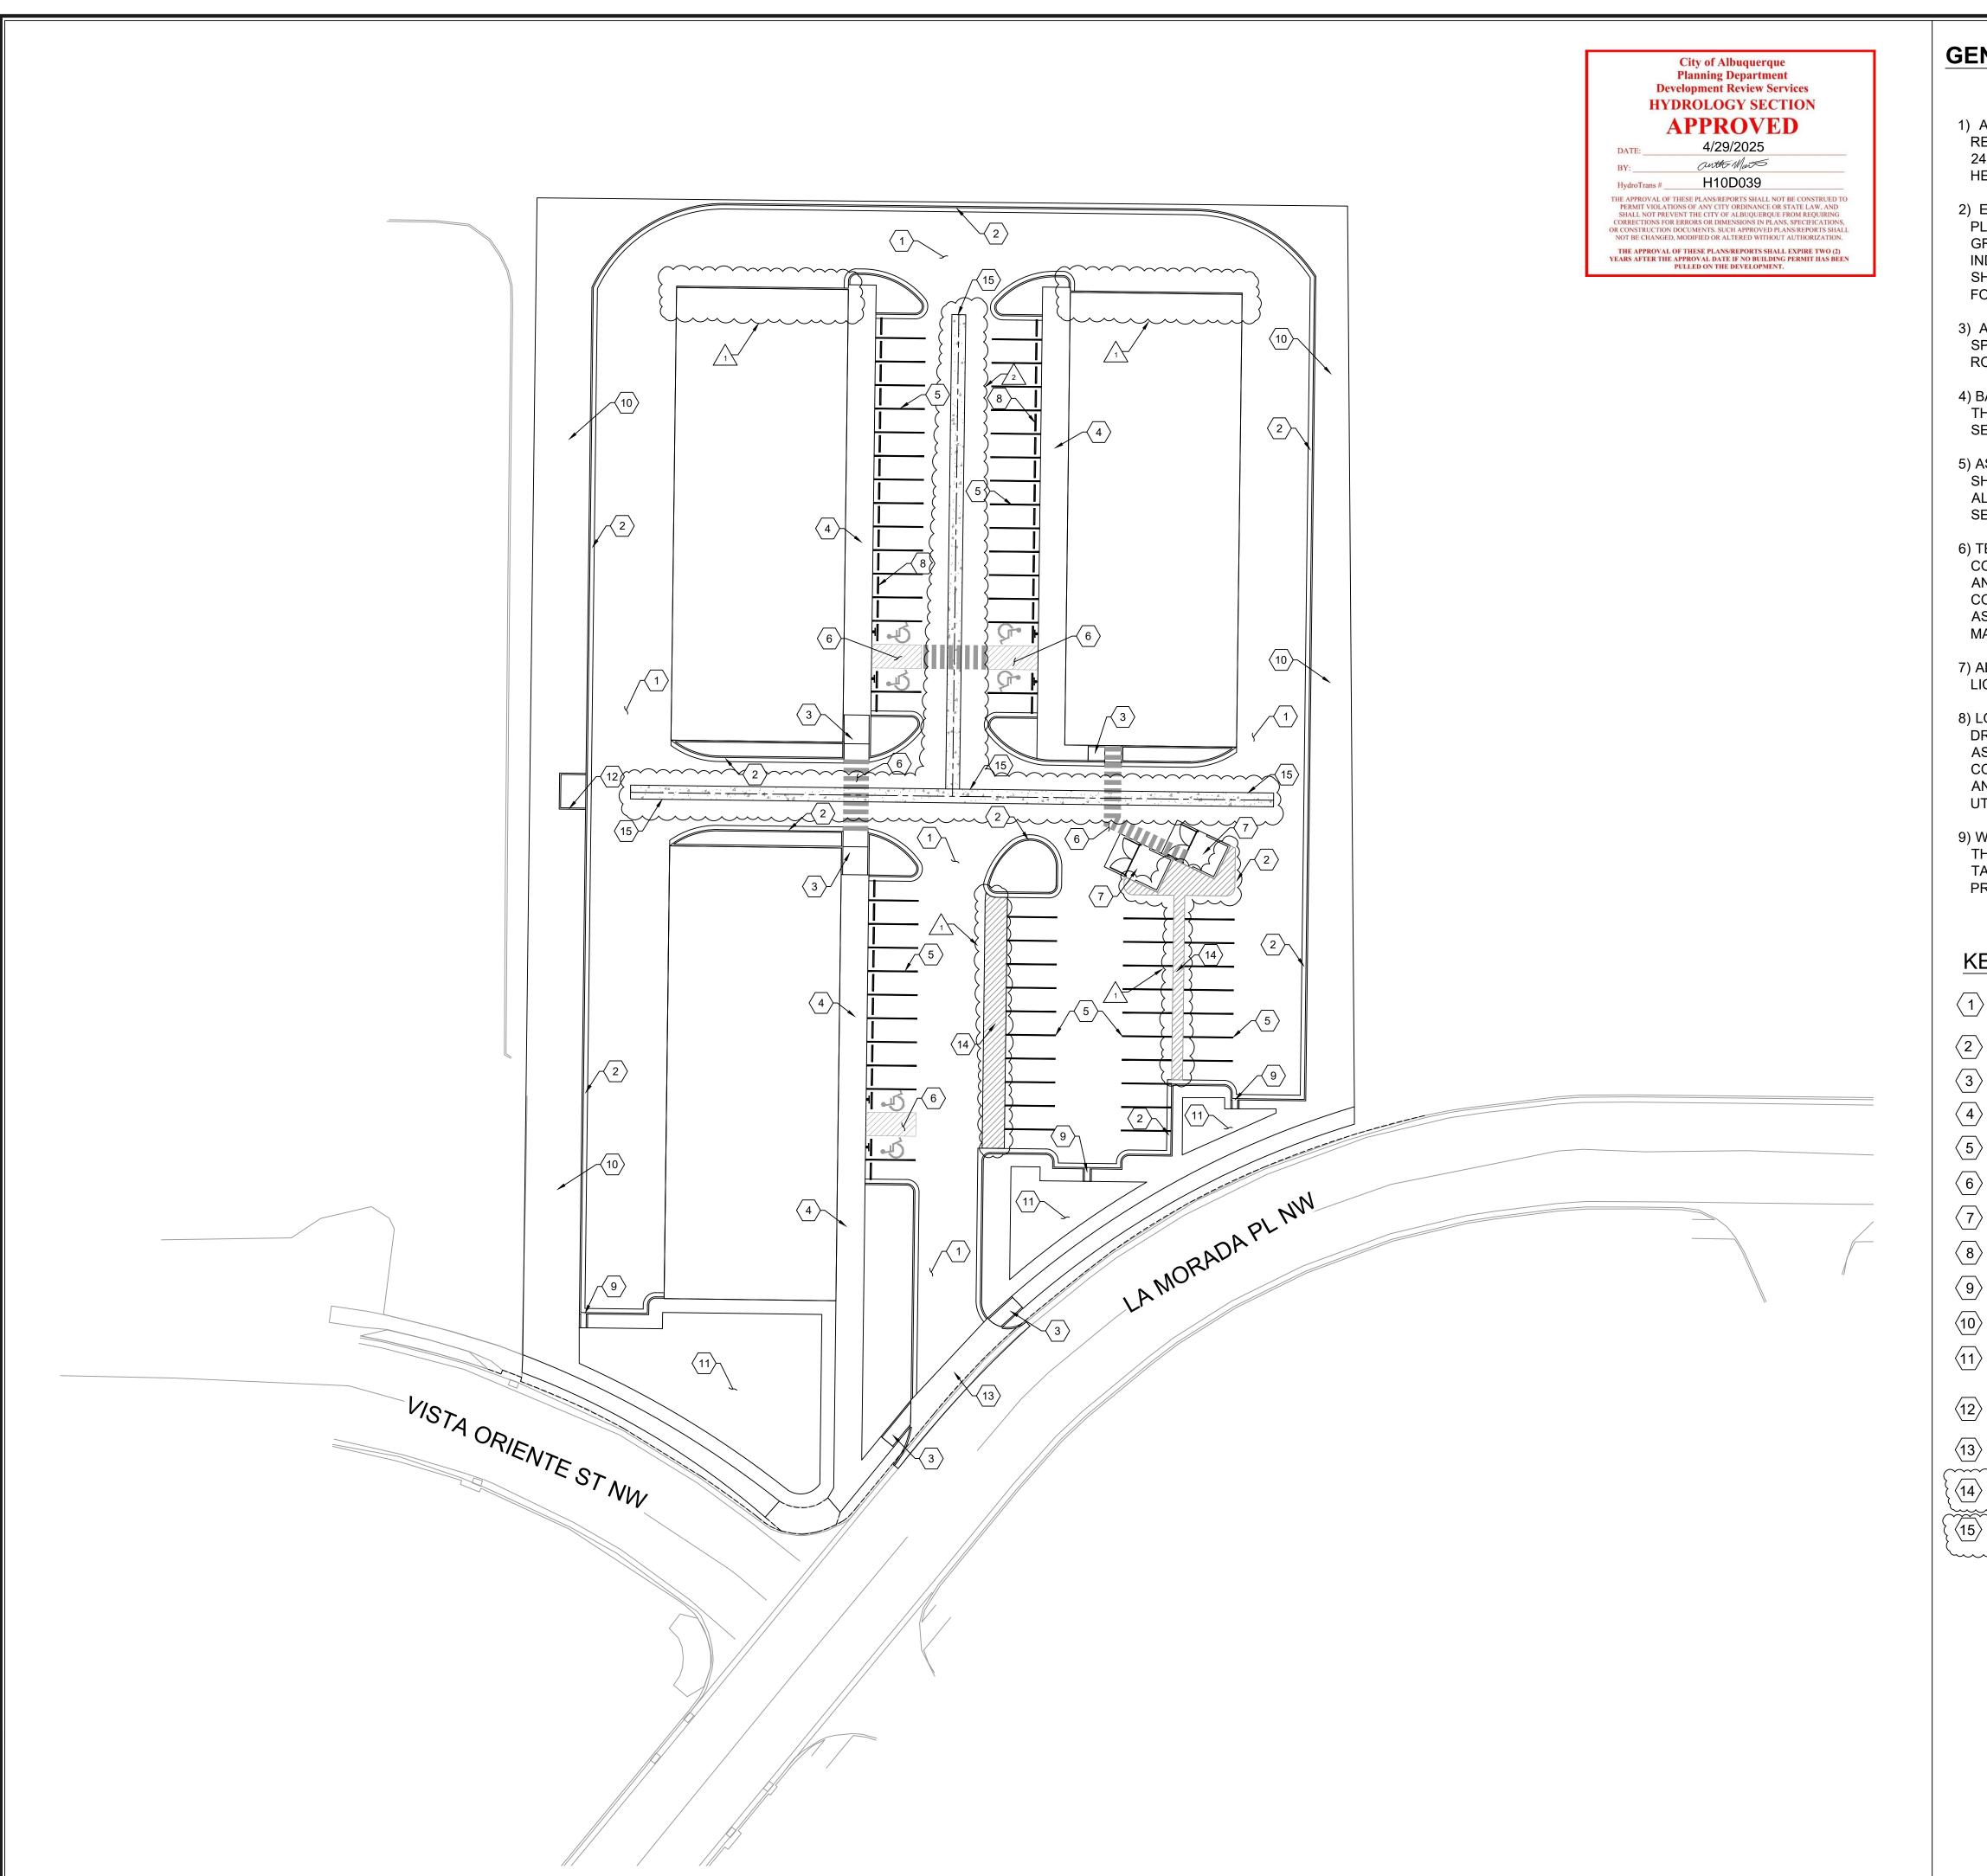

GENERAL NOTES:

- 1) ALL ROADWORK SHALL MEET OR EXCEED THE APPLICABLE REQUIREMENTS OF THE CITY OF ALBUQUERQUE STANDARDS (SECTION 2400) FOR ROAD CONSTRUCTION EXCEPT AS OTHERWISE SPECIFIED HEREIN.
- 2) ENTIRE SITE SHALL BE CLEARED AND GRUBBED PRIOR TO FILL BEING PLACED. THE SUBGRADE SHALL BE ACCURATELY SHAPED TO LINES AND GRADES AS INDICATED ON THE DRAWINGS AND COMPACTED AS INDICATED ON THE DETAILS. ALL SUBGRADE IN ROADWAY SECTION SHALL BE COMPACTED TO CITY OF ALBUQUERQUE STANDARD DETAILS FOR PAVING SECTION 2400
- 3) ALL PORTLAND CEMENT CONCRETE SHALL CONFORM TO ASTM SPECIFICATION SECTION 500, CITY OF ALBUQUERQUE STANDARDS FOR ROAD CONSTRUCTION.
- 4) BASE COURSE MATERIALS SHALL CONFORM TO THE REQUIREMENTS OF THE CITY OF ALBUQUERQUE STANDARDS FOR ROAD CONSTRUCTION, SECTION 2400.
- 5) ASPHALTIC CONCRETE SURFACE COURSE MATERIAL AND PLACEMENT SHALL CONFORM TO THE REQUIREMENTS OF THE CITY OF ALBUQUERQUE STANDARDS FOR ROAD CONSTRUCTION SPECIFICATION, SECTION 2400.
- 6) TESTING OF CONSTRUCTION MATERIALS, INCLUDING SUBGRADE COMPACTION, SHALL BE PERFORMED AS REQUIRED BY THE ENGINEER AND AT THE EXPENSE OF THE CONTRACTOR. THE CONTRACTOR SHALL COORDINATE TESTING AND FURNISHING SAMPLES AND JOB SITE ASSISTANCE AS REQUIRED. THE CONTRACTOR SHALL FURNISH MANUFACTURER'S CERTIFICATES OF QUALITY AS REQUIRED.
- 7) ALL CONSTRUCTION STAKING SHALL BE PERFORMED BY A SURVEYOR LICENSED IN NM.
- 8) LOCATIONS OF ALL EXISTING UTILITIES SHOWN ARE FROM RECORD DRAWINGS OR FIELD SURVEYS AND ARE LOCATED AS ACCURATELY AS POSSIBLE FROM INFORMATION AVAILABLE. IT WILL BE THE CONTRACTOR'S RESPONSIBILITY TO PROTECT, MAINTAIN IN SERVICE, AND AT POINTS REQUIRED, VERIFY EXACT LOCATIONS OF THESE UTILITIES DURING CONSTRUCTION OPERATIONS OF THIS PROJECT.
- 9) WHEN ABUTTING NEW PAVEMENT TO EDGES OF EXISTING PAVEMENT, THE EXISTING PAVEMENT SHALL BE CUT IN A STRAIGHT NEAT EDGE AND TACK COAT SHALL BE APPLIED TO EDGES OF EXISTING PAVEMENT PRIOR TO BEGINNING OF NEW PAVEMENT OPERATIONS.

KEYED NOTES:

- 1 INSTALL 2.5" TYPE C SP IV ASPHALT PAVEMENT W/6" BASE COURSE "LIGHT DUTY" PER DETAIL, SHEET C-107
- 2 INSTALL 6" X 24" CURB AND GUTTER PER DETAIL, SHEET C-107
- (3) INSTALL ADA RAMP PER ARCHITECTURAL PLANS
- (4) INSTALL CONCRETE SIDEWALK PER DETAIL, SHEET C-107
- (5) PAINT 4" WHITE STRIPE FOR PARKING SPACES
- 6 ADA ACCESS PARKING PER DETAIL, SHEET C-107
- 7 INSTALL DUMPSTER ENCLOSURE PER DETAIL, SHEET C-107
- 8 INSTALL CURB STOP PER DETAIL, SHEET C-107
- 9 INSTALL CURB CUT/DRAIN CHANNEL PER DETAILS, SHEET C-107
- (10) INSTALL RIP-RAP PER DETAIL, SHEET C-109
- (11) INSTALL DEPRESSED PARKING ISLAND PER , SEC.6-12(B)(1) C.O.A. DEVELOPMENT PROCESS MANUAL
- (12) INSTALL HEAD WALL FIRE HYDRANT PAD, PER DETAIL, SHEET C-108
- $\langle 13 \rangle$ INSTALL DRIVEWAY PER DETAIL, SHEET C-107
- $\langle \langle 14 \rangle$ PAINT NO PARKING ZONE AREA
- PAINT NO PARKING ZONE AREA
- (15) INSTALL 5' WIDE VALLEY GUTTER PER DETAIL, SHEET C-109

SquareRoot

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ENGINEERING SHEET:

KEYED NOTES

OF

PROJECT NAME:

LA MORADA
COMMERCIAL
DEVELOPMENT

FOR

TED JARAMILLO

PROJECT NUMBER:


CLIENT:

23192

PROJECT ENGINEER:


Jeremy Baker, PE

DRAWN BY: Carlos Jimenez

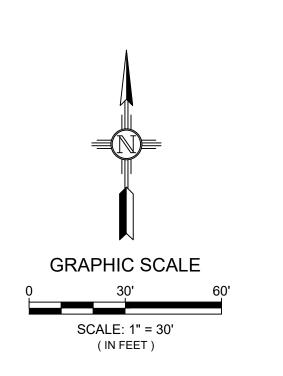

No.	DATE	DESCRIPTION
/1	6-24-24	REMOVED CURB AND GUTTER
2	6-24-24	ADDED 5' WIDE VALLEY GUTTER CENTER DRIVING ISLE



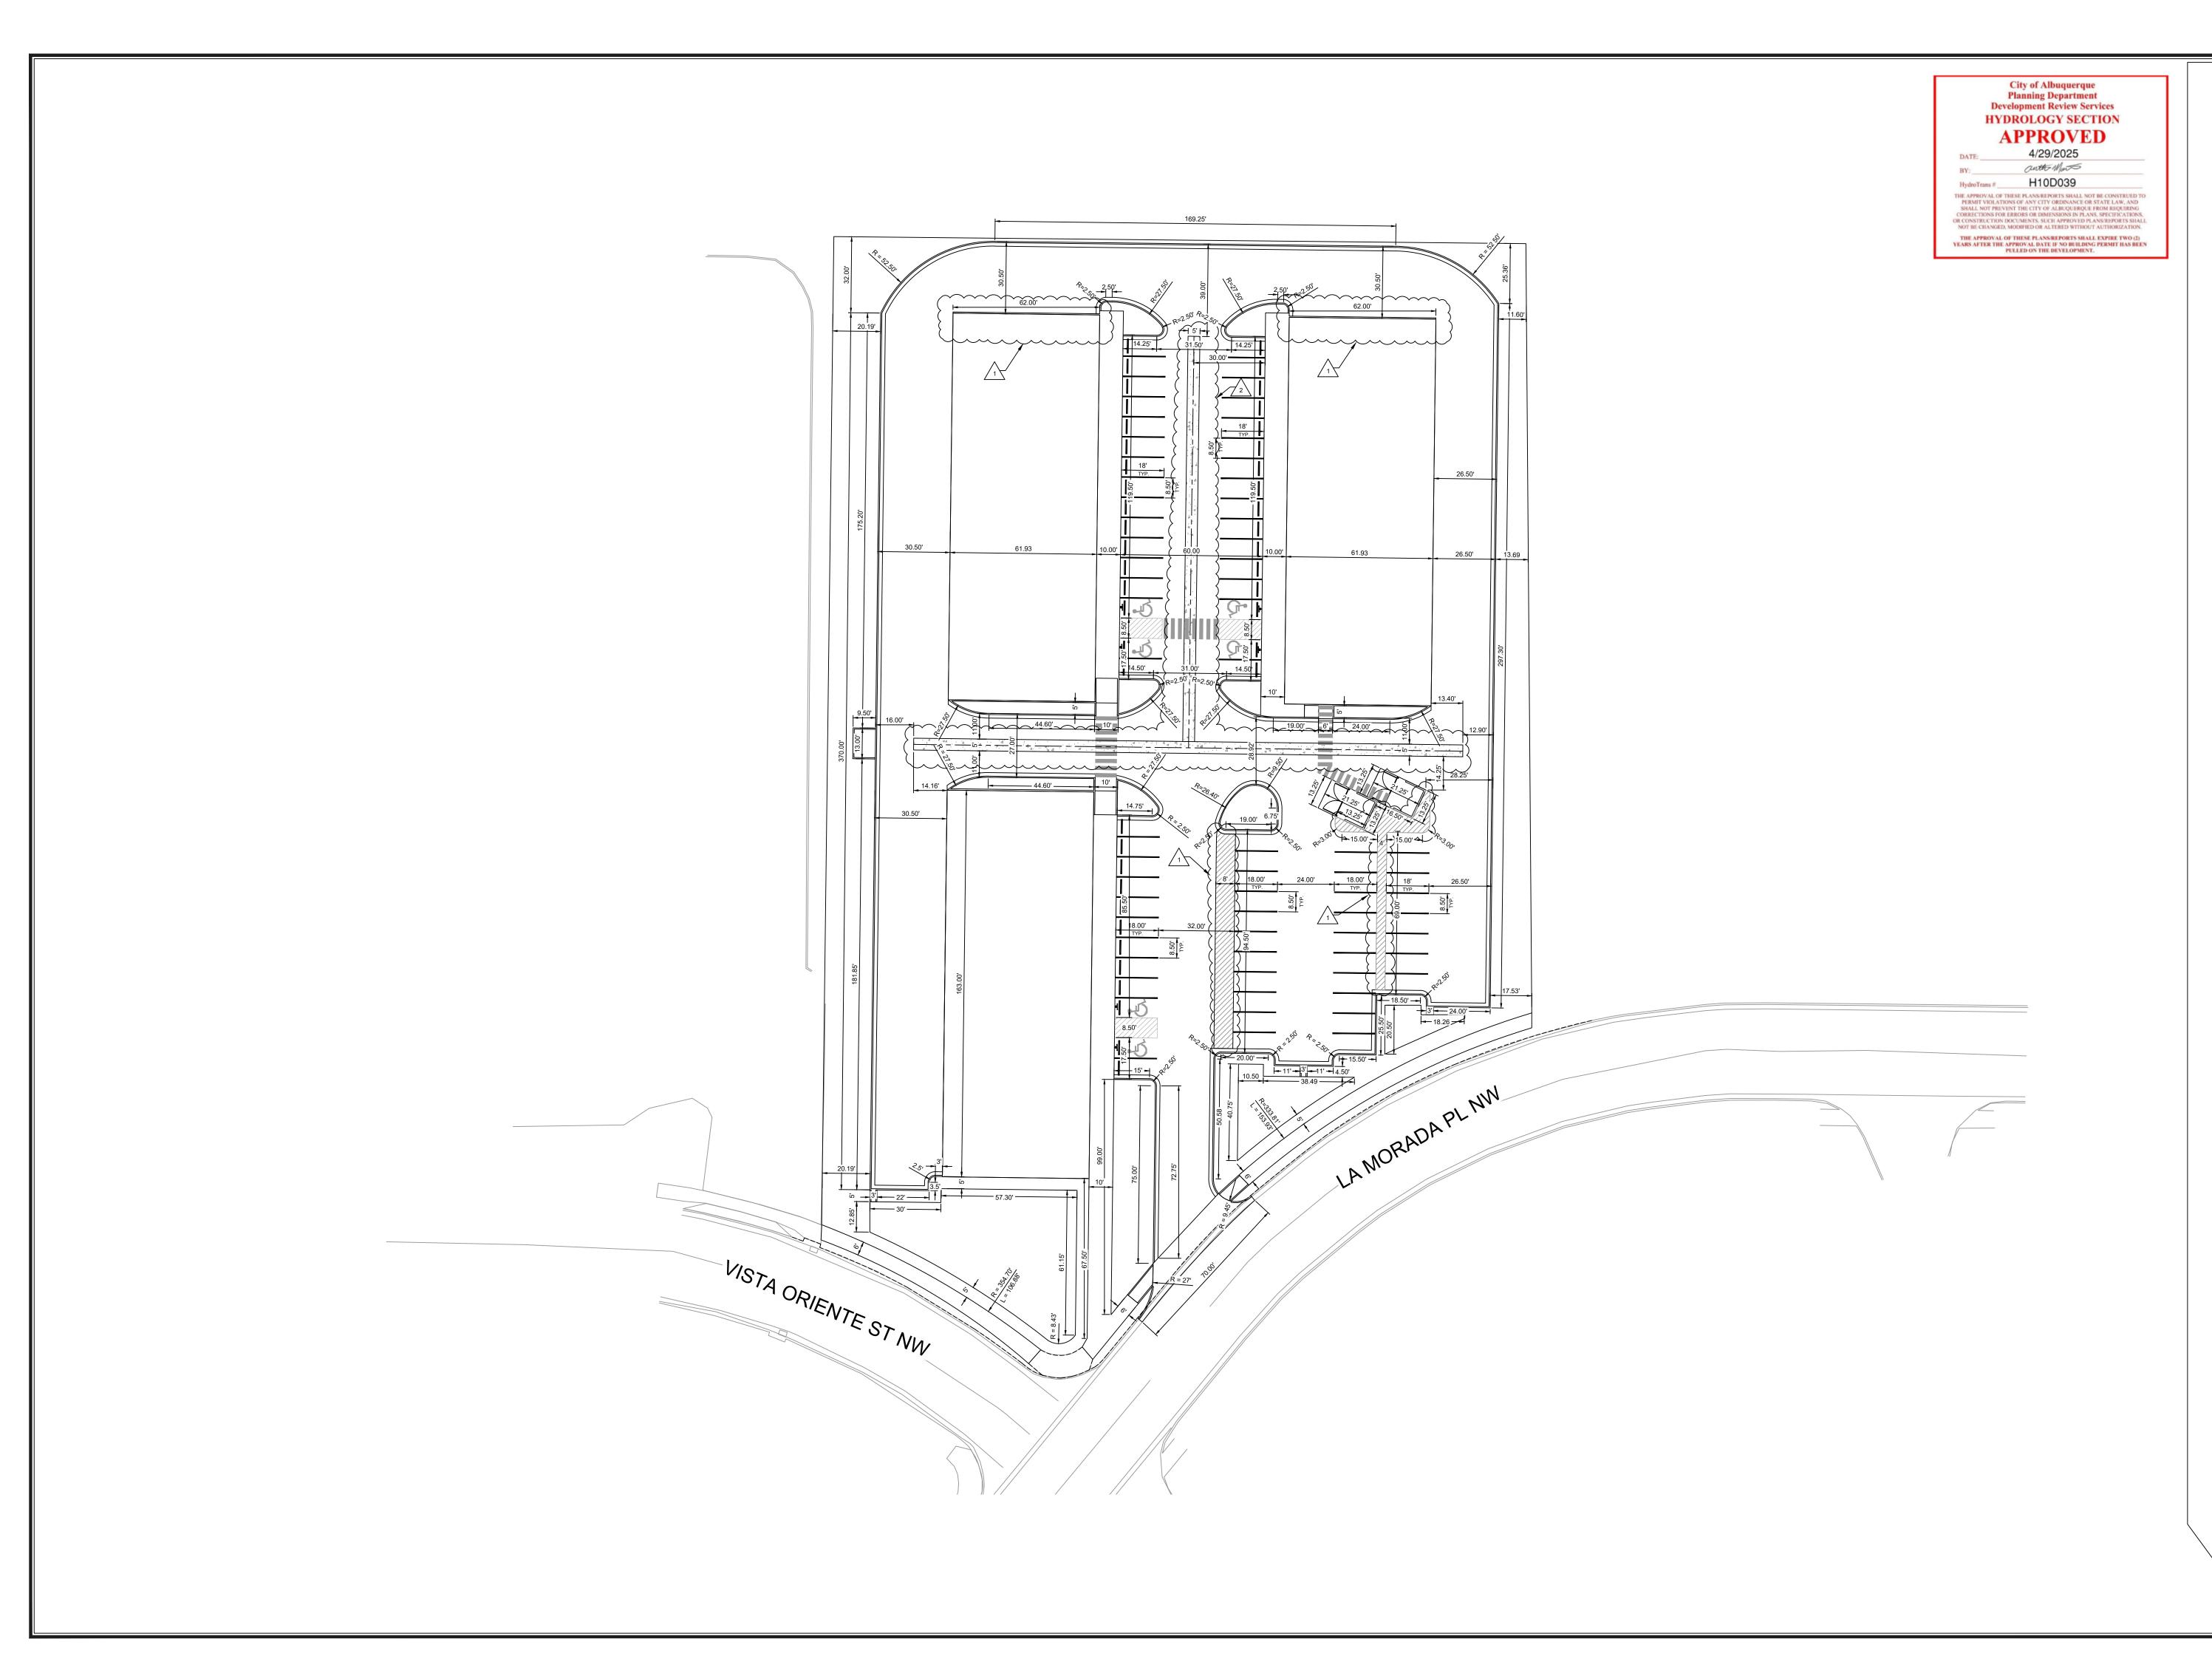



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ENGINEERING SHEET:

SITE PLAN

OF

PROJECT NAME:

LA MORADA COMMERCIAL DEVELOPMENT

FUR

TED JARAMILLO

PROJECT NUMBER:


CLIENT:

23192

PROJECT ENGINEER:

Jeremy Baker, PE


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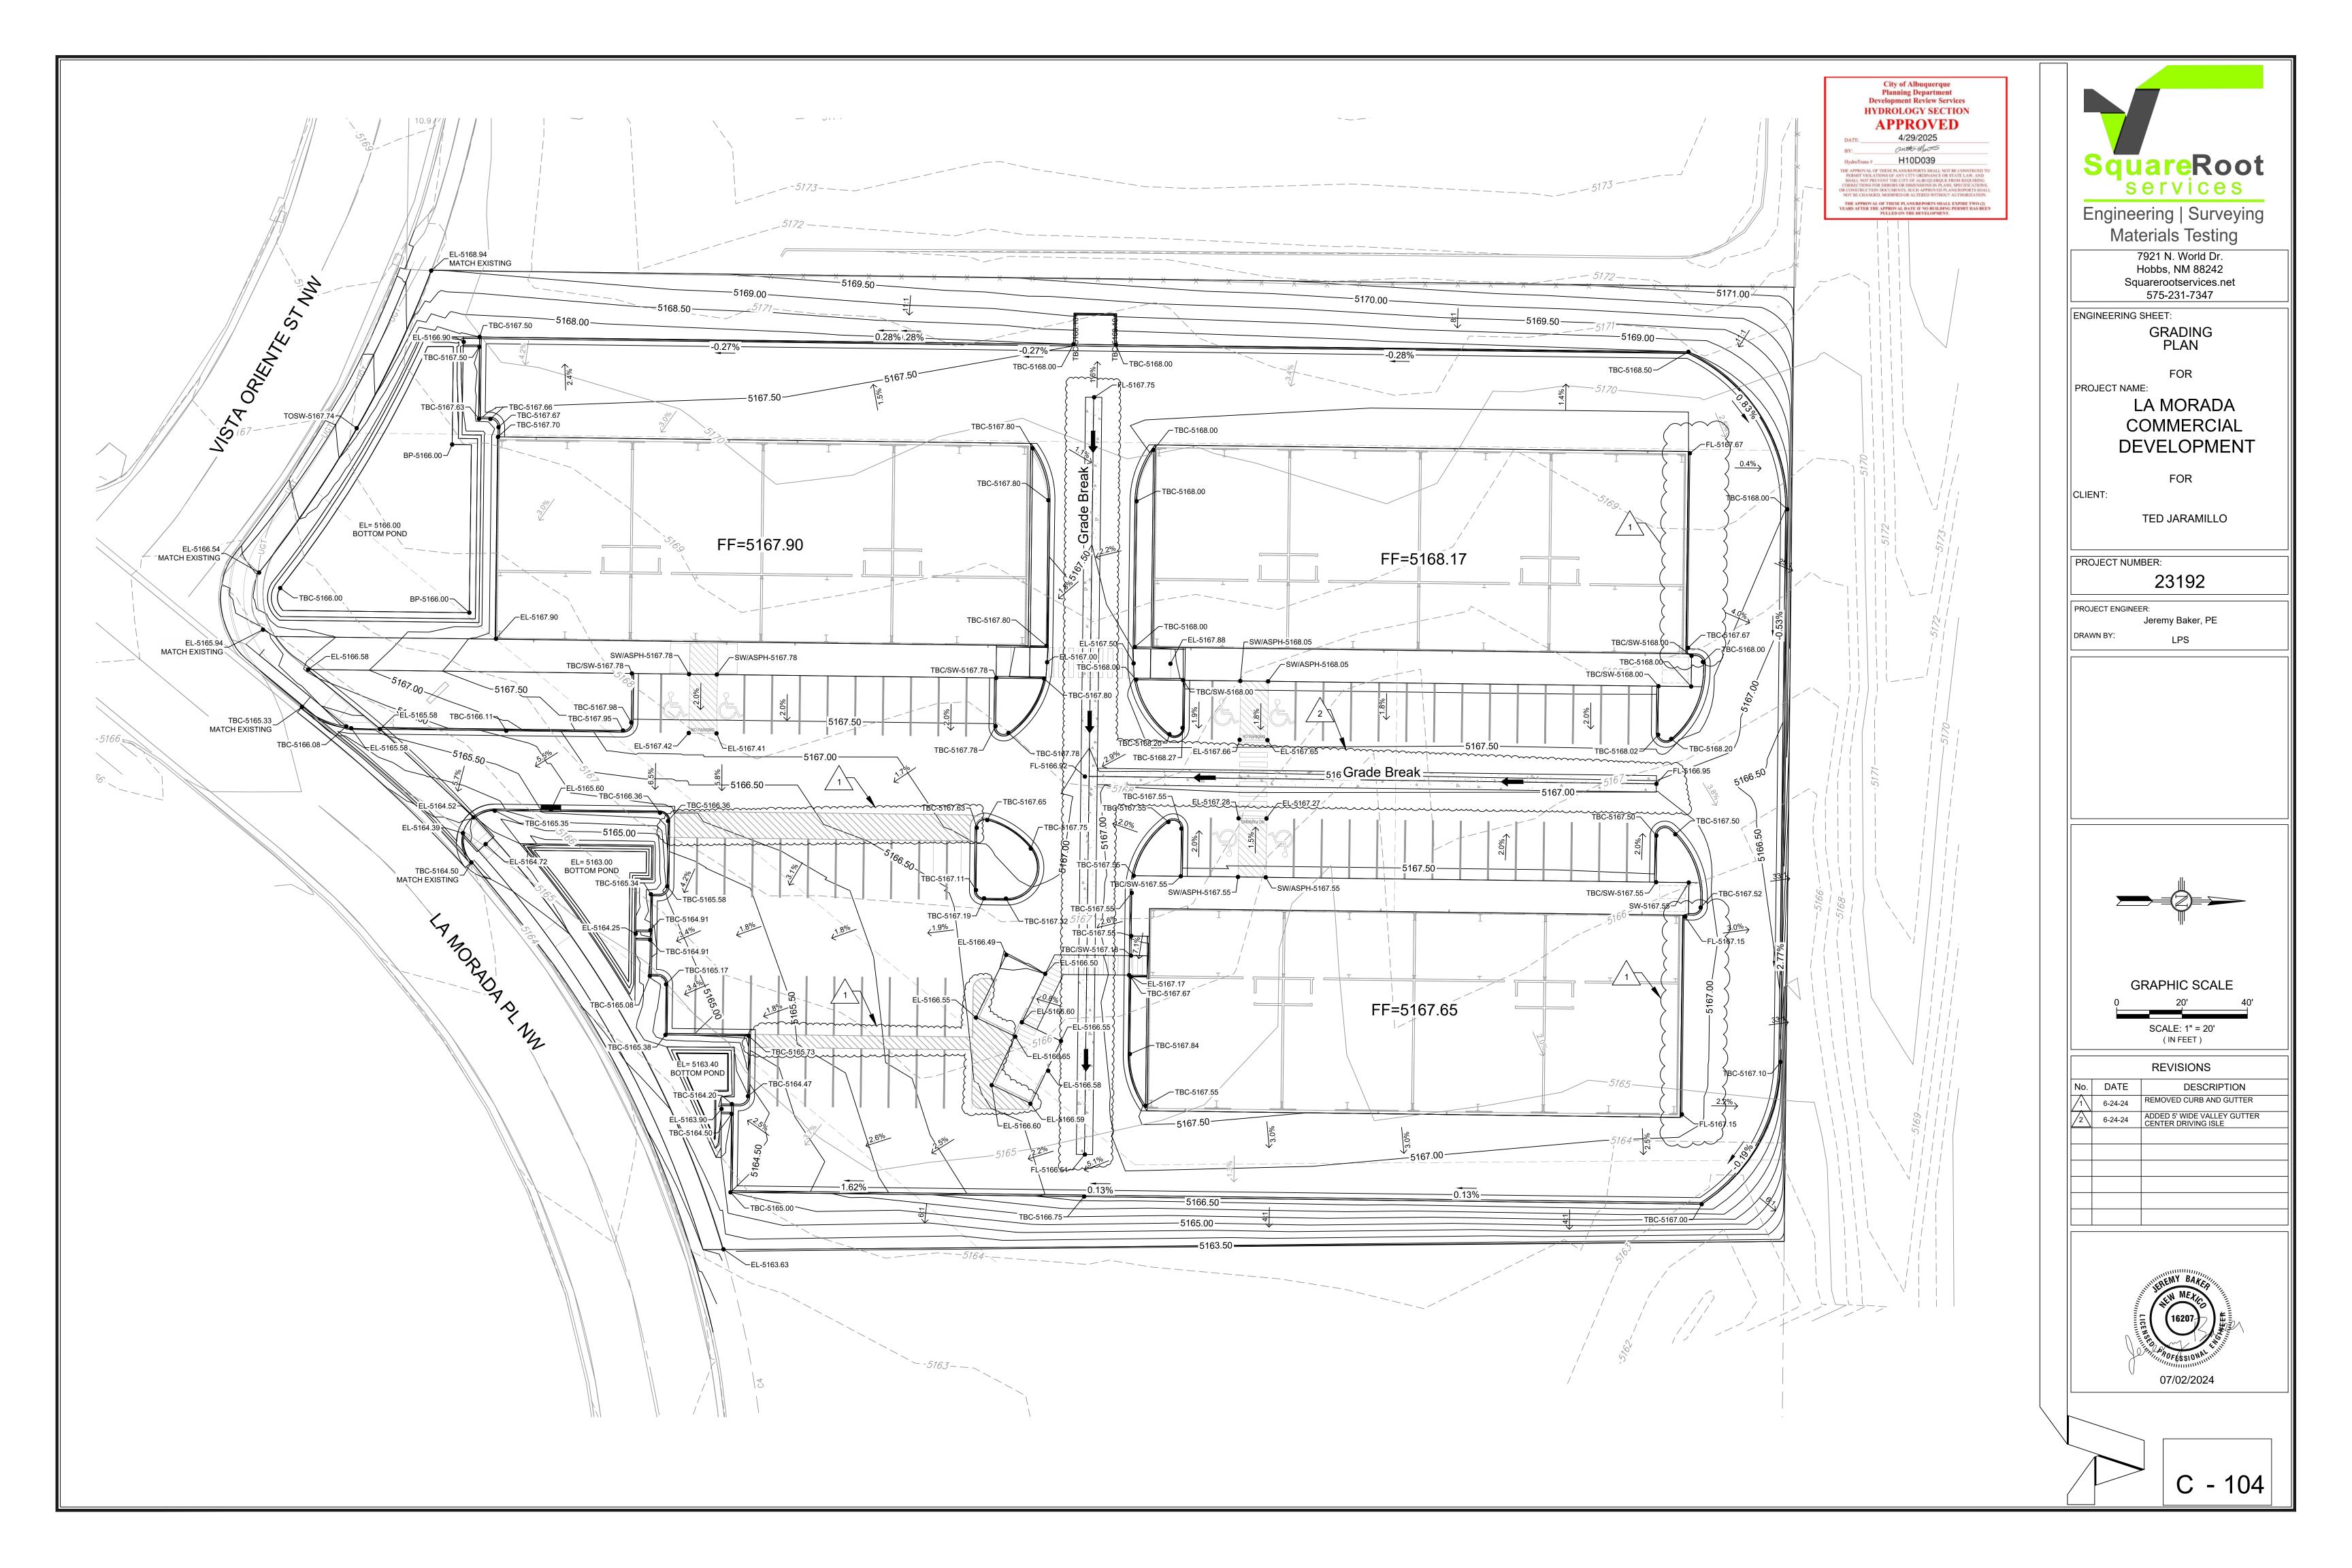


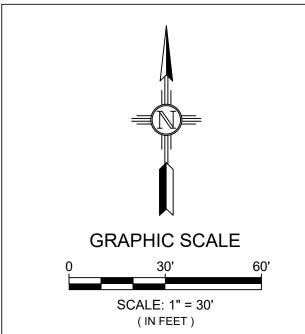
REVISIONS		
No.	DATE	DESCRIPTION
1	6-24-24	REMOVED CURB AND GUTTER
2	6-24-24	ADDED 5' WIDE VALLEY GUTTER CENTER DRIVING ISLE
		•



C - 102



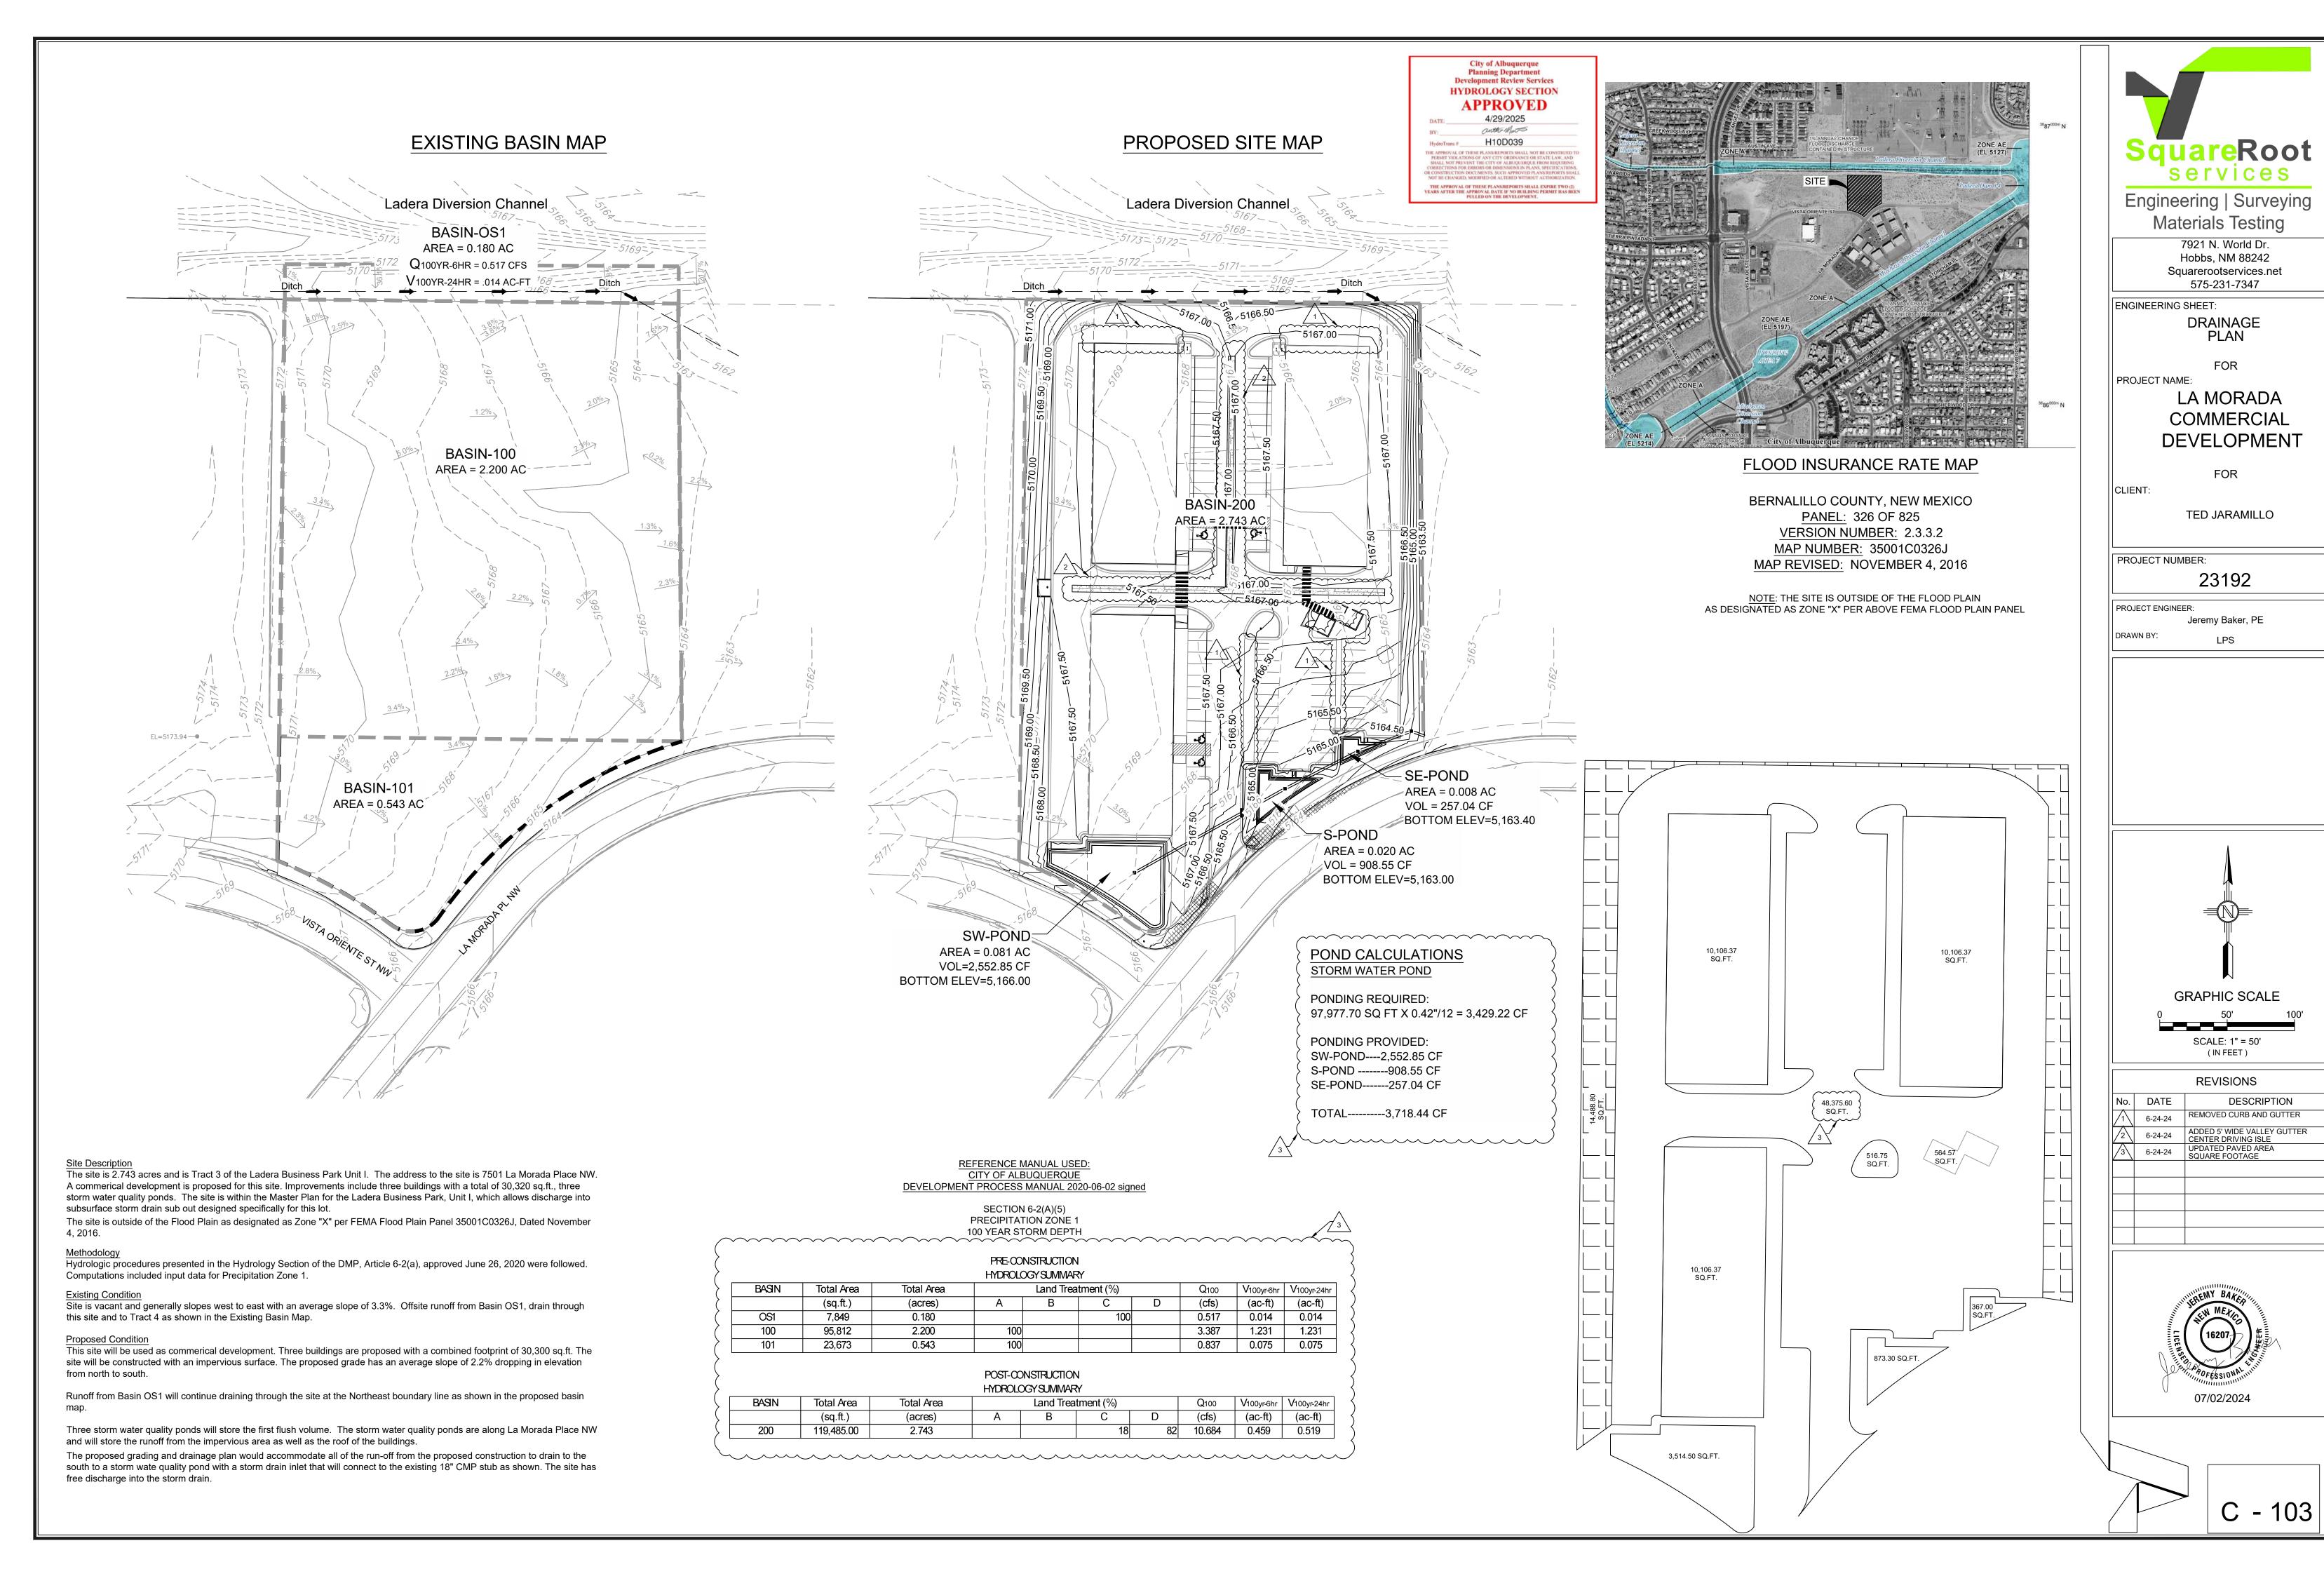

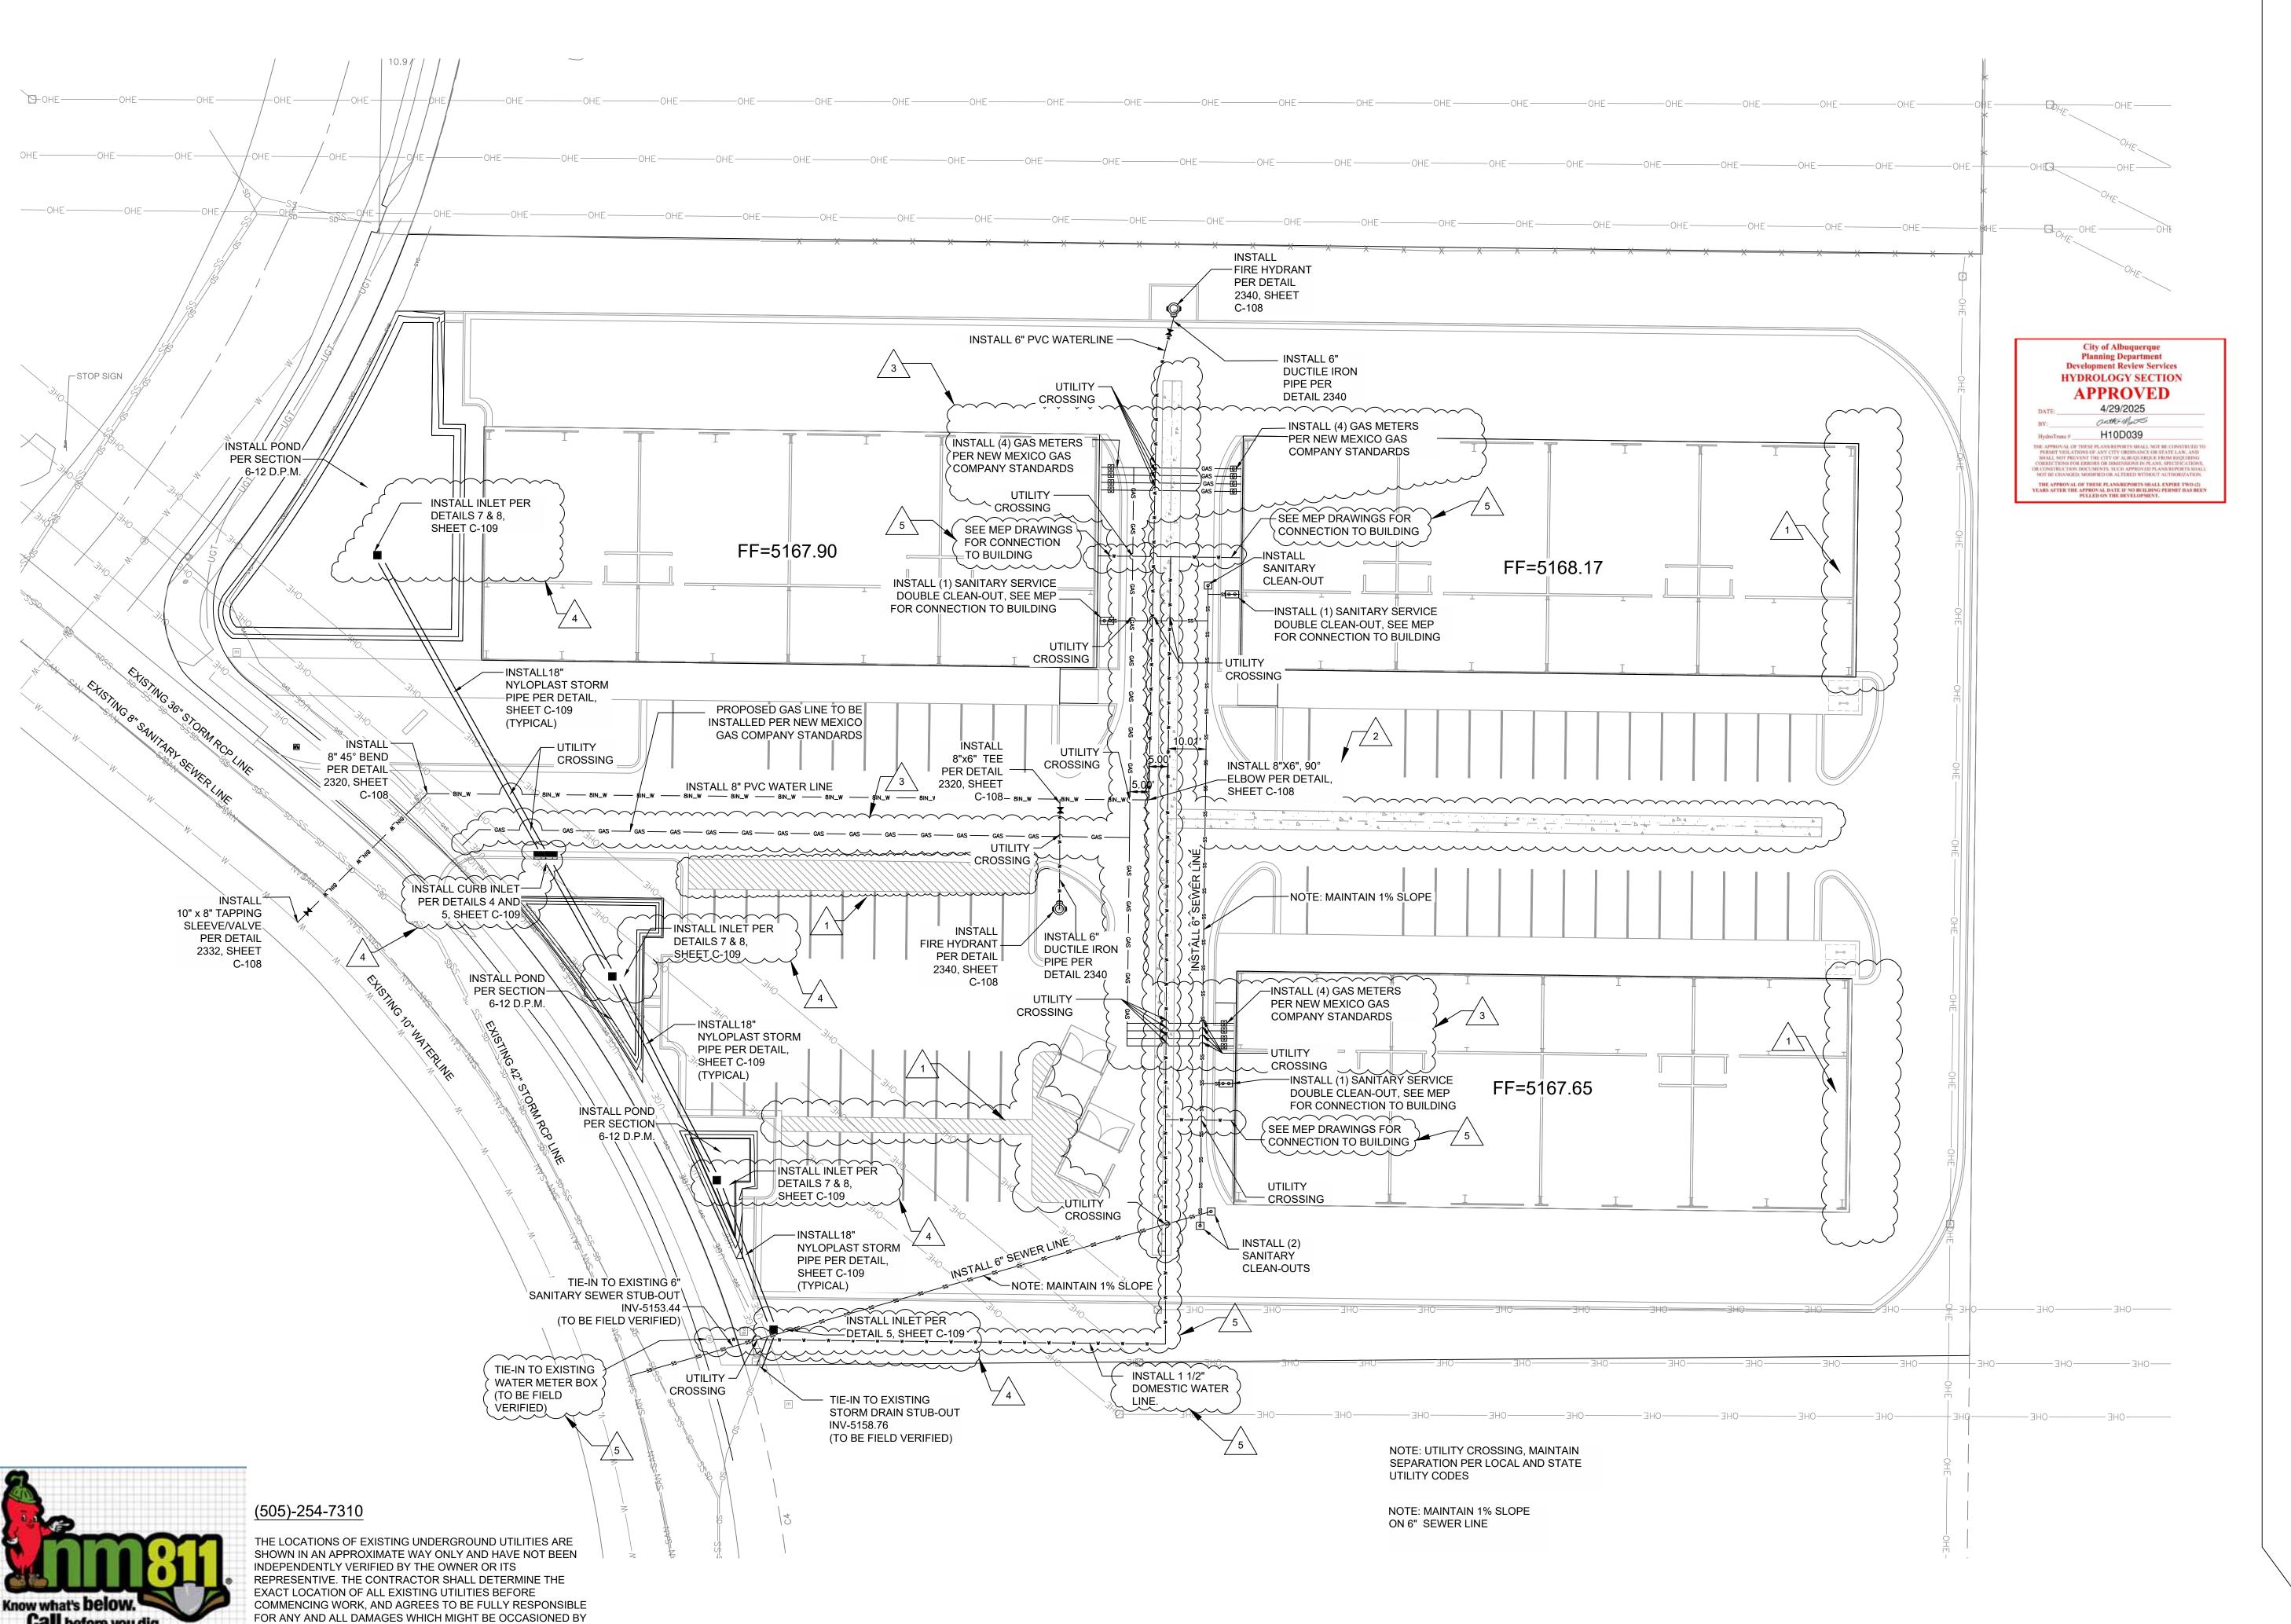

THE CONTRACTOR'S FAILURE TO EXACTLY LOCATE AND

PRESERVE ANY AND ALL UNDERGROUND UTILITIES.



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ENGINEERING SHEET:

CIVIL UTILITY PLAN

OF PROJECT NAME:

LA MORADA COMMERCIAL DEVELOPMENT

FOR

TED JARAMILLO


CLIENT:


PROJECT NUMBER: 23192

PROJECT ENGINEER:

JEREMY BAKER, PE


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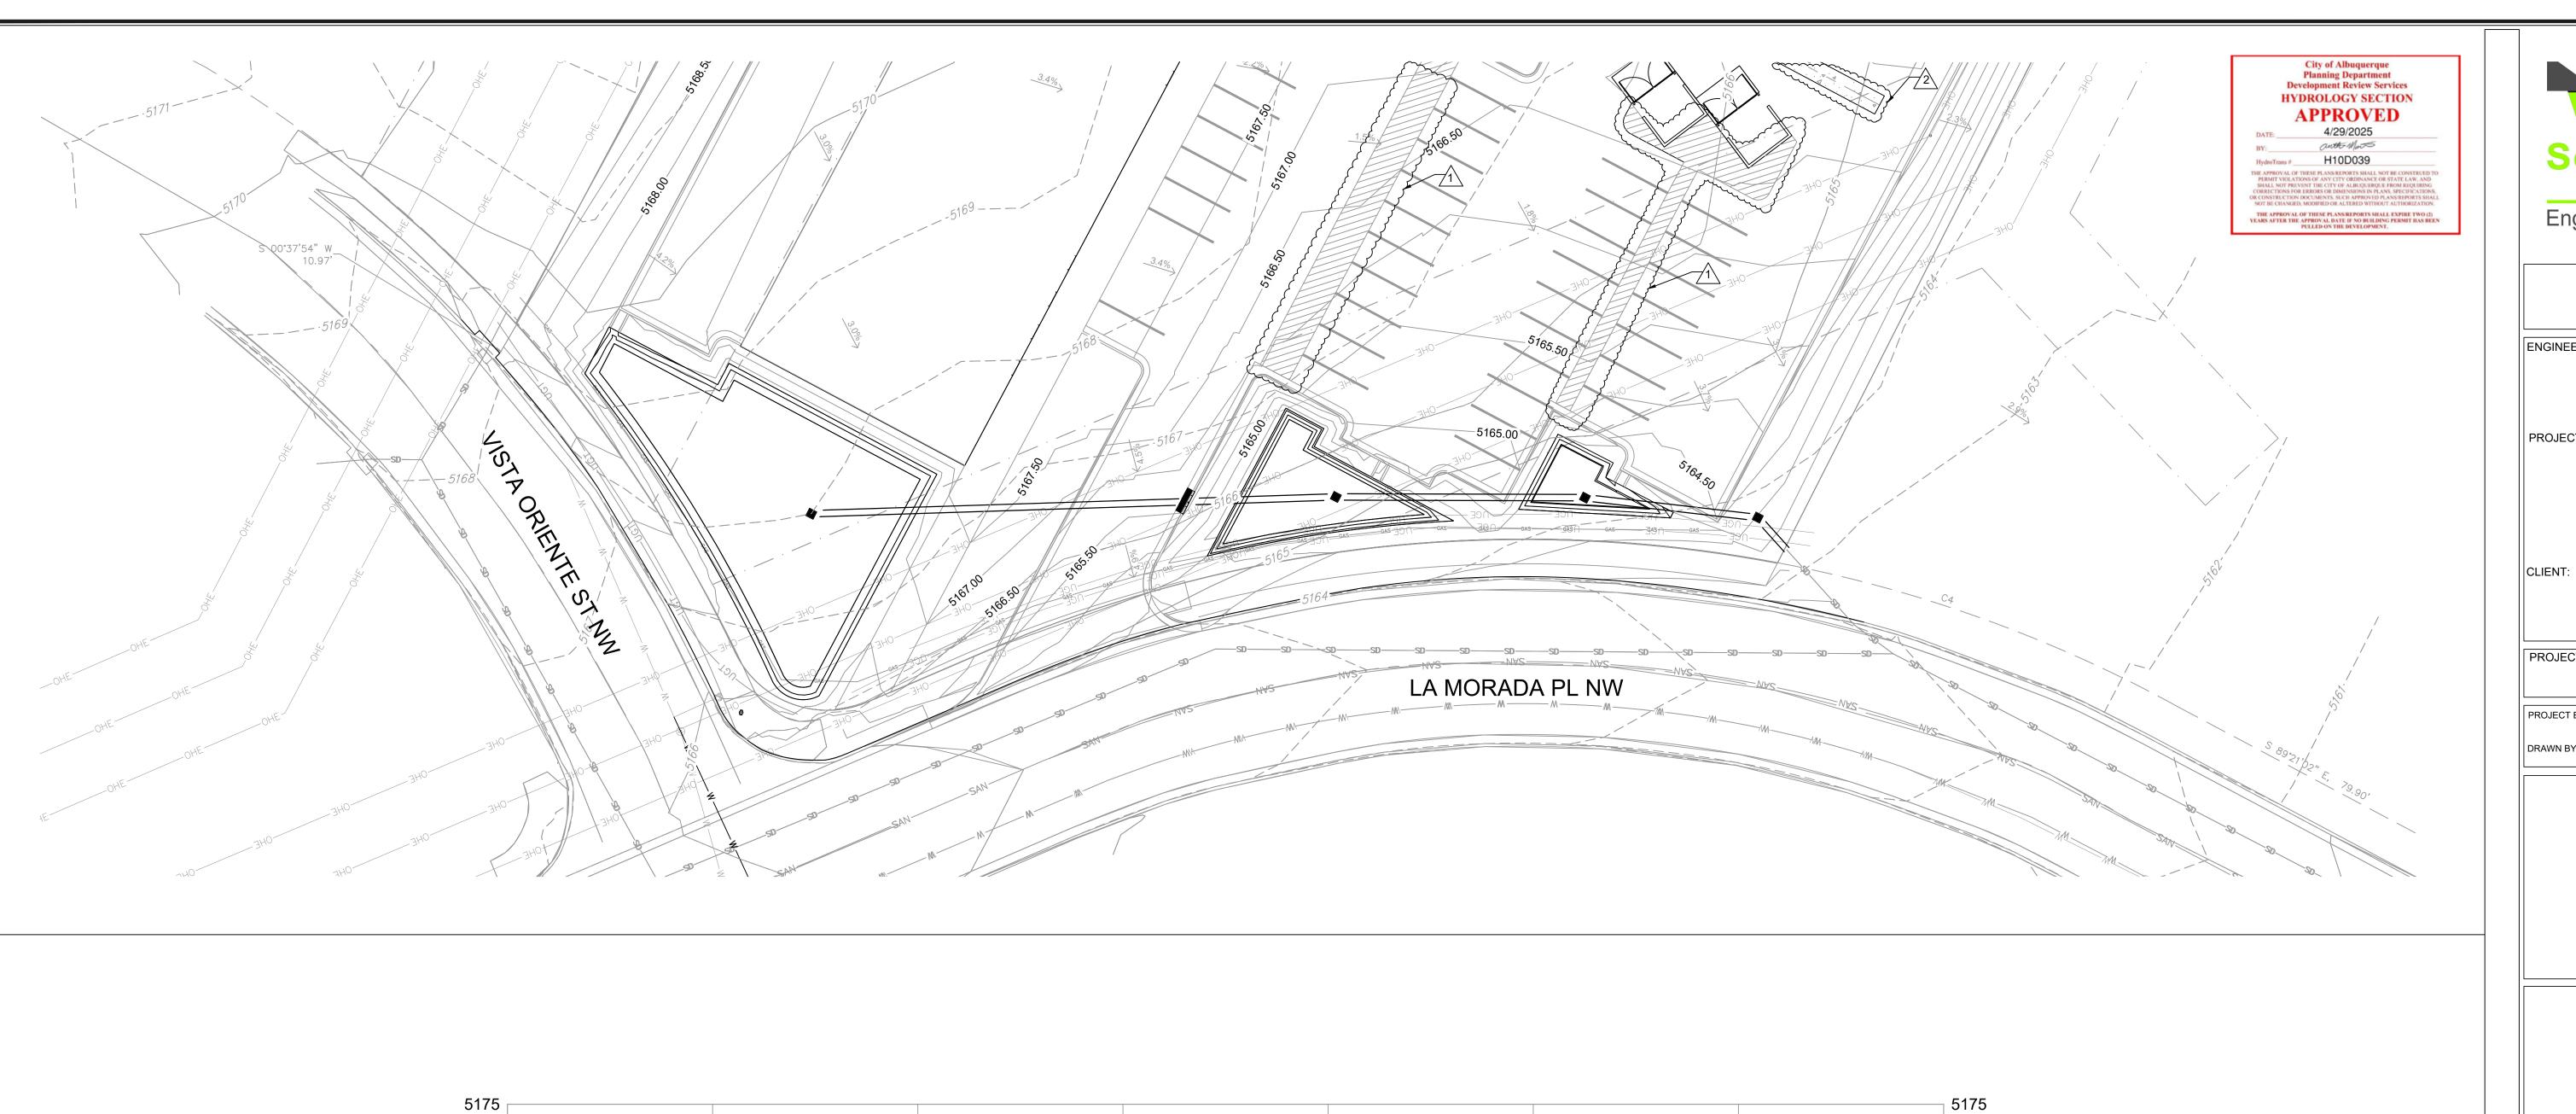


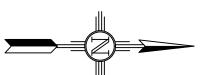		REVISIONS
No.	DATE	DESCRIPTION
5	6-24-24	REMOVED CURB AND GUTTER
2	6-24-24	ADDED 5' WIDE VALLEY GUTTER CENTER DRIVING ISLE
3	9-16-24	WATER LINE UPDATED
4	9-16-24	DETAIL CALLOUTS UPDATED
<u></u>	10-22-24	ADDED 1 1/2 INCH DOMESTIC WATER LINE

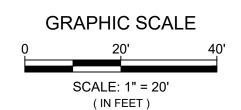



C-105

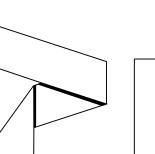

EL=5166.16'

| STA. 0+64.19 |
| STA. 0+91.89 |
| EL=5165.60' |

DRVWY

EL=5160.83' STA. 0+66.92

1+00

__EXISTING GRADE

BOTTOM

POND

EXISTING GRADE

BOTTOM POND

0+00

18" storm pipe

0+50

5170

5165

5160



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ENGINEERING SHEET:

STROM DRAIN PLAN AND PROFILE

PROJECT NAME:

LA MORADA

FOR


TED JARAMILLO

PROJECT NUMBER:

23192

PROJECT ENGINEER:

Jeremy Baker, PS DRAWN BY: LPS

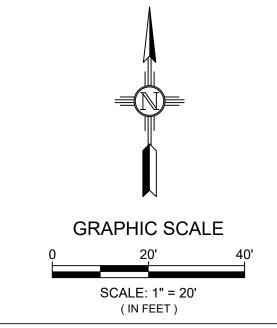

5170

5165

5160

5155

HORIZONTAL: 1" = 20' VERTICAL: 1" = 4'

STA. 2+30.95 EL=5164.47'

TIĖ-IN TO

EXISTING STUB-OUT

2+50

EL=5158.76' STA. 2+41.70

BOTTOM

2+00

,—18" storm pipe−

STA. 1+88.88 EL=5163.40'


-1.18%

1+50

REVISIONS No. DATE DESCRIPTION 1 6-24-24 REMOVED CURB AND GUTTER
2 6-24-24 ADDED 5' WIDE VALLEY GUTTER CENTER DRIVING ISLE



C - 106

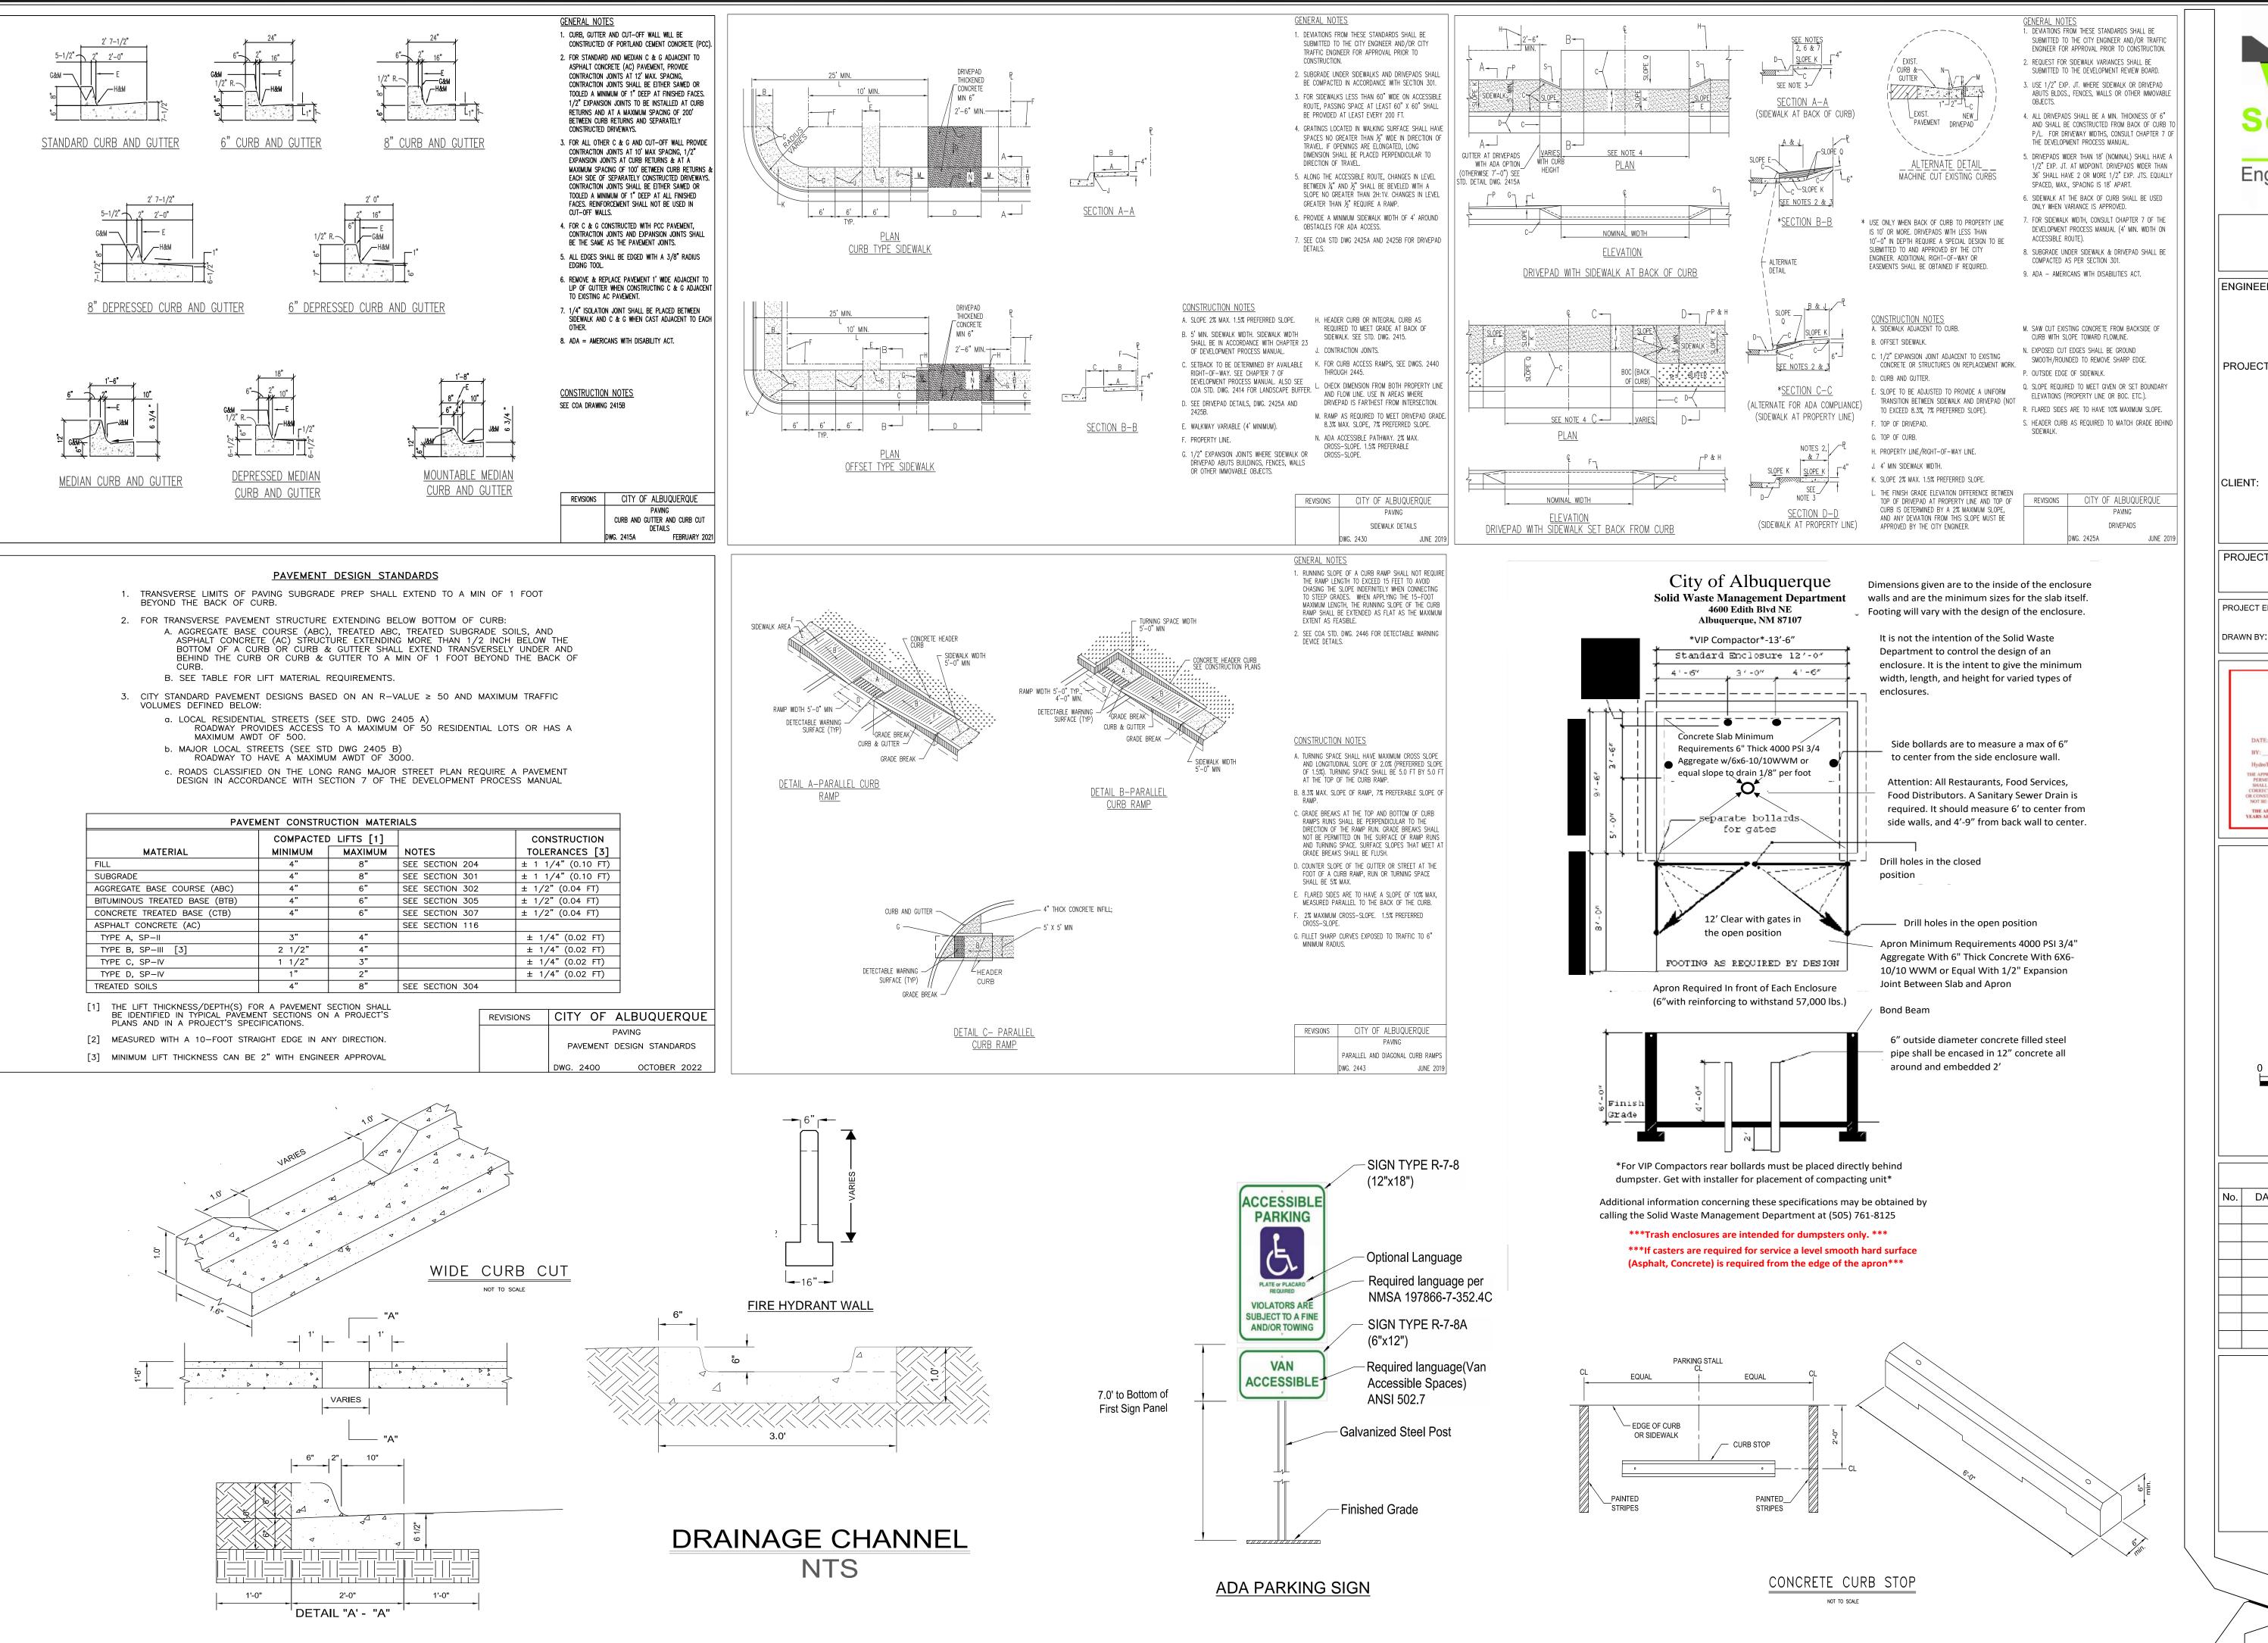

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ENGINEERING SHEET:

CONSTRUCTION DETAILS

PROJECT NAME:

LA MORADA COMMERCIAL DEVELOPMENT

OF

FOR

TED JARAMILLO

PROJECT NUMBER:

2319

PROJECT ENGINEER:

Jeremy Baker, PE

RAWN BY: Carlos Jimenez

City of Albuquerque
Planning Department
Development Review Services
HYDROLOGY SECTION
APPROVED


DATE: 4/29/2025

BY: 4/29/2025

BY: HydroTrans # H10D039

THE APPROVAL OF THESE PLANS/REPORTS SHALL NOT BE CONSTRUED TO PERMIT VIOLATIONS OF ANY CITY ORDINANCE OR STATE LAW, AND SHALL NOT PREVENT THE CITY OF ALBUQUERQUE FROM REQUIRING CORRECTIONS FOR ERRORS OR DIMENSIONS IN PLANS, SPECIFICATIONS, OR CONSTRUCTION DECUMENTS, SUCH APPROVED PLANS/REPORTS SHALL NOT BE CHANGED, MODIFIED OR ALTERED WITHOUT AUTHORIZATION.


THE APPROVAL OF THESE PLANS/REPORTS SHALL EXPIRE TWO (2) YEARS AFTER THE APPROVAL DATE IF NO BUILDING PERMIT HAS BEEN PULLED ON THE DEVELOPMENT.

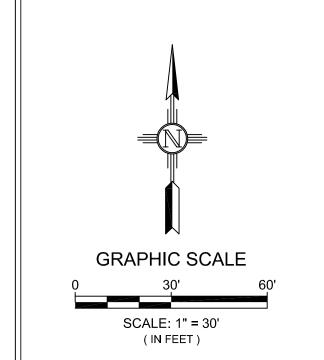



No. DATE DESCRIPTION





C - 107

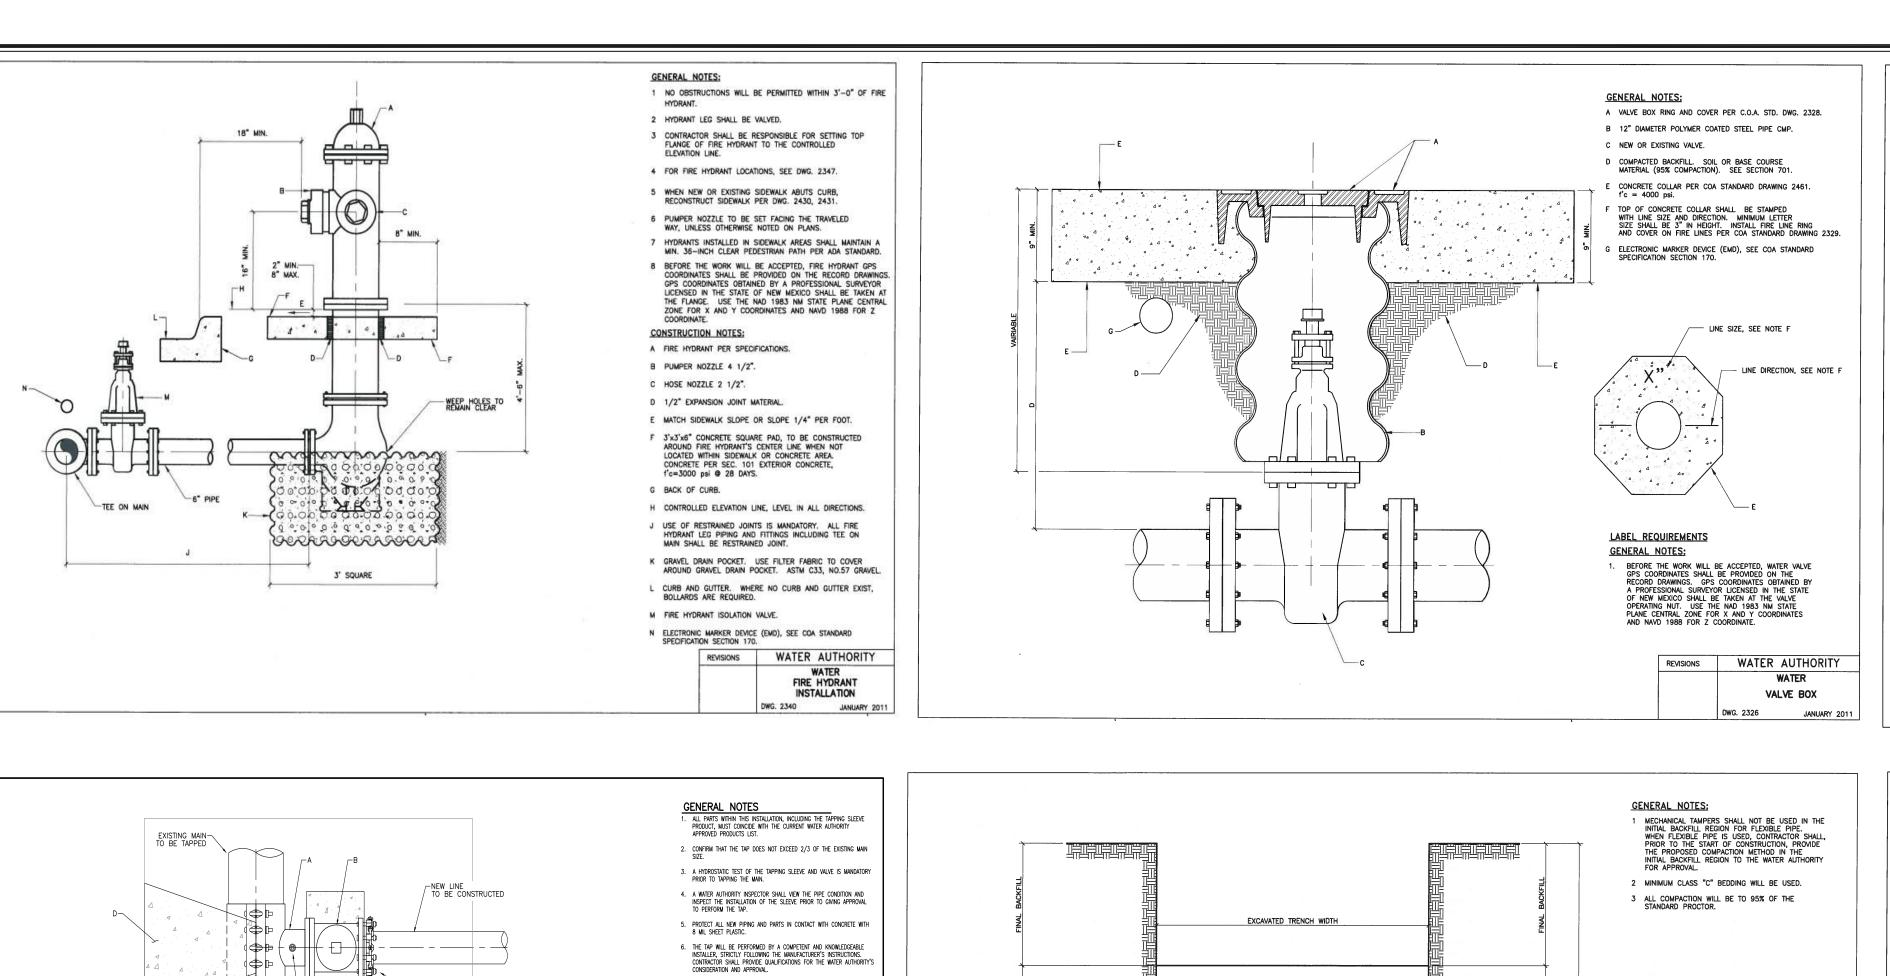


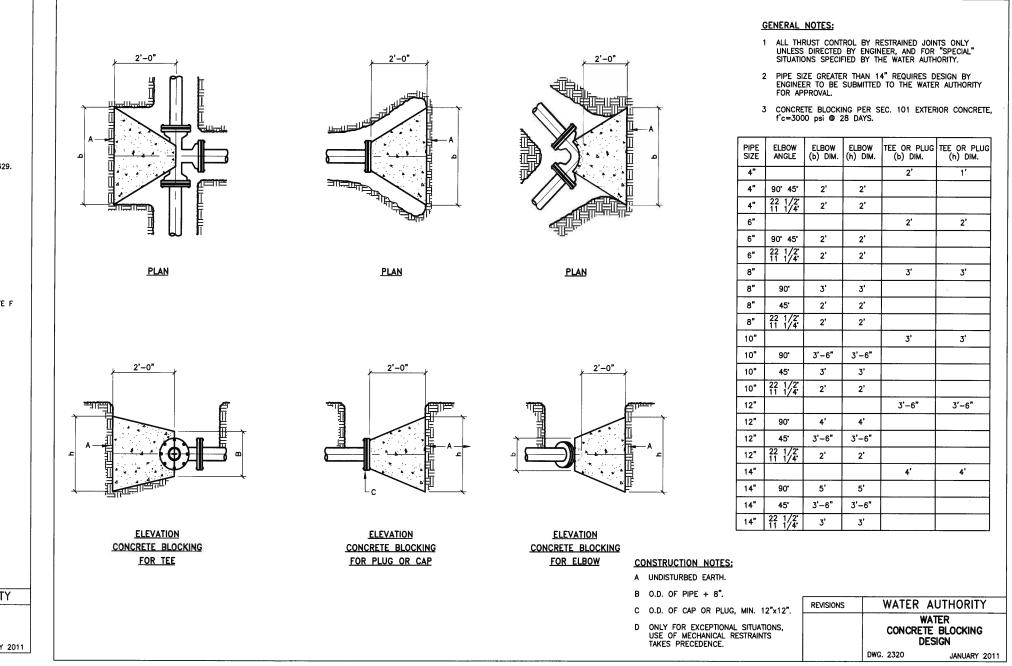


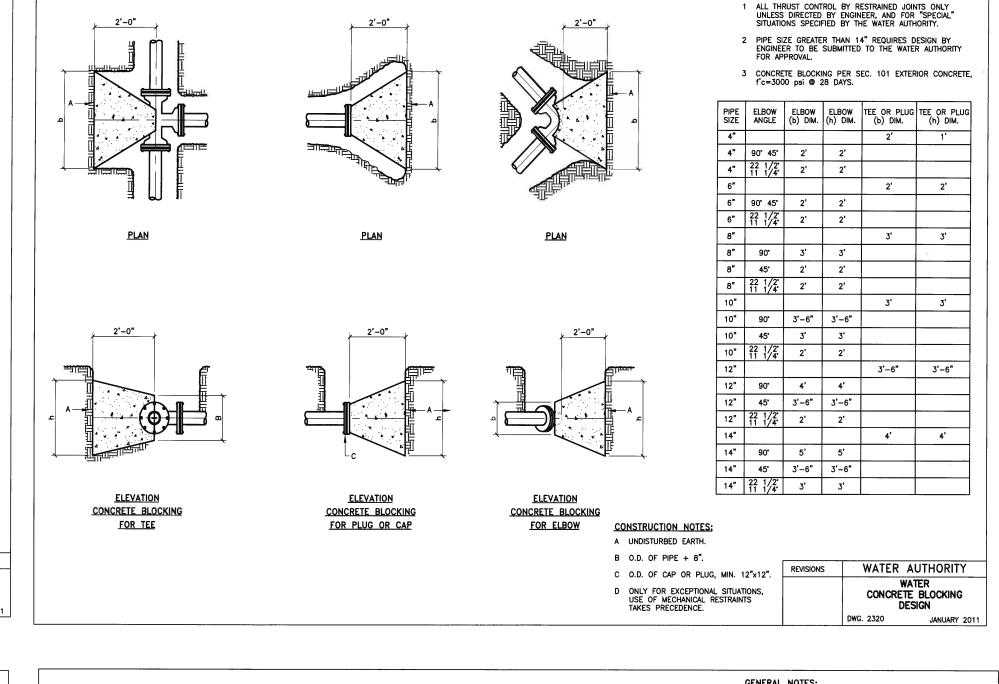


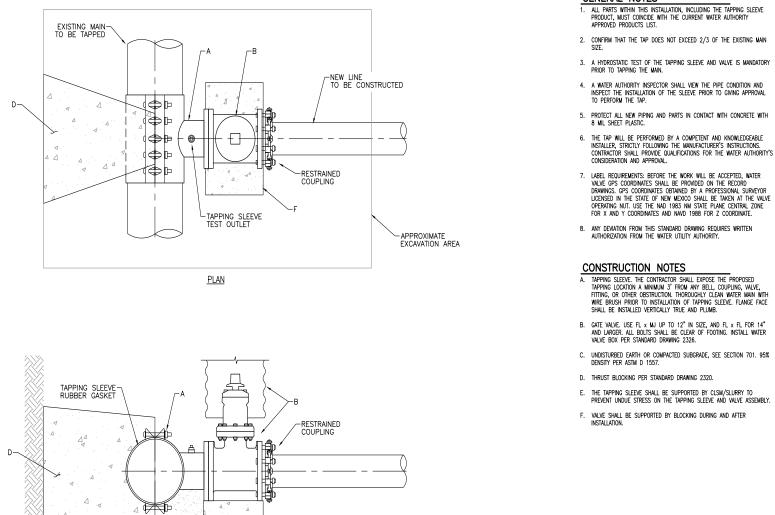


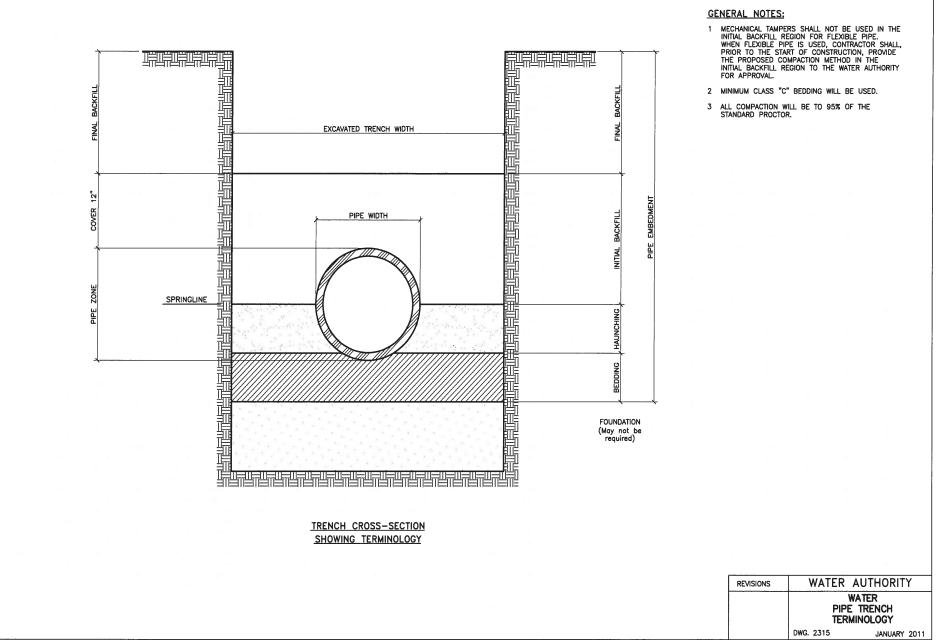

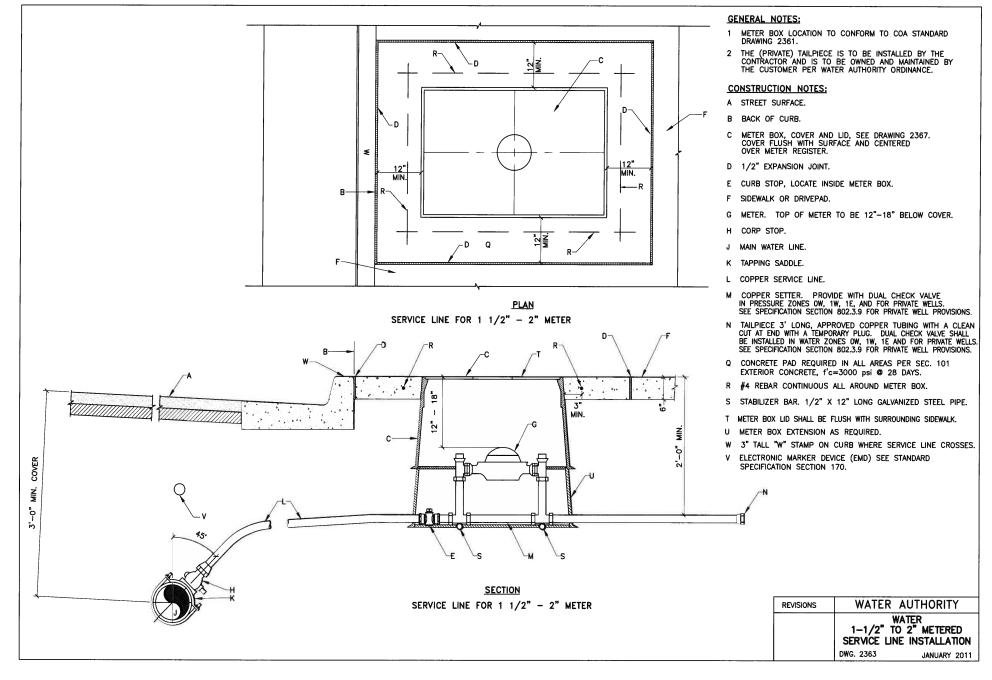

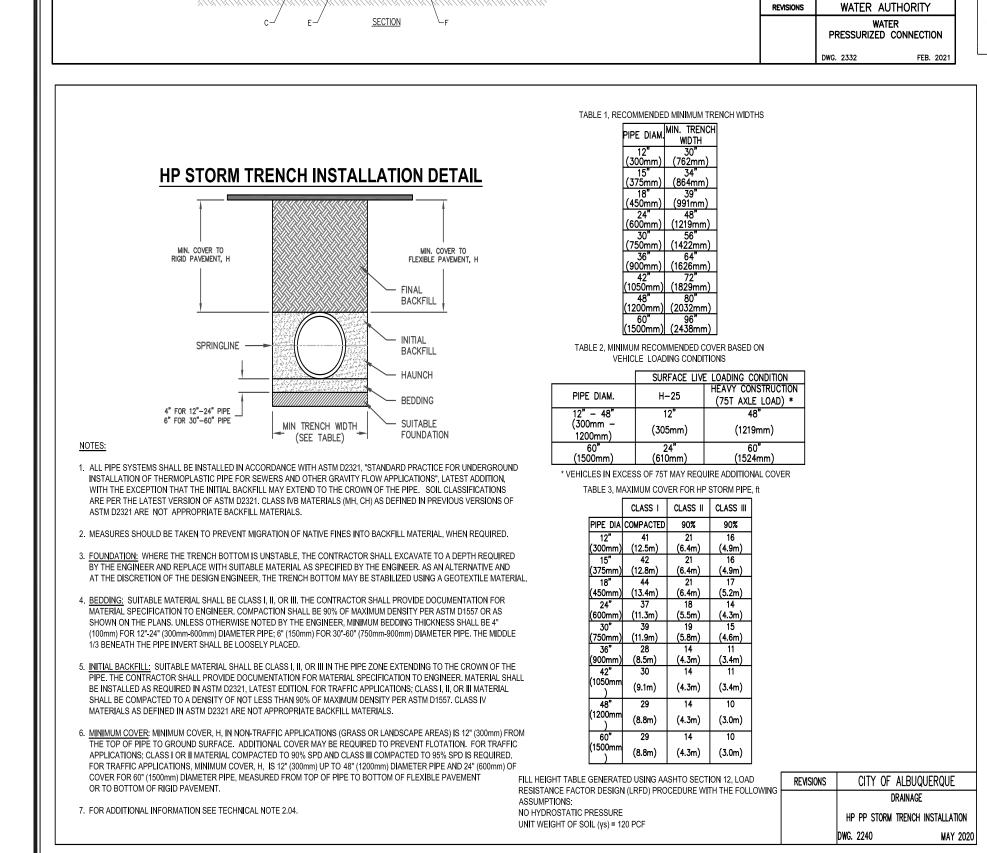

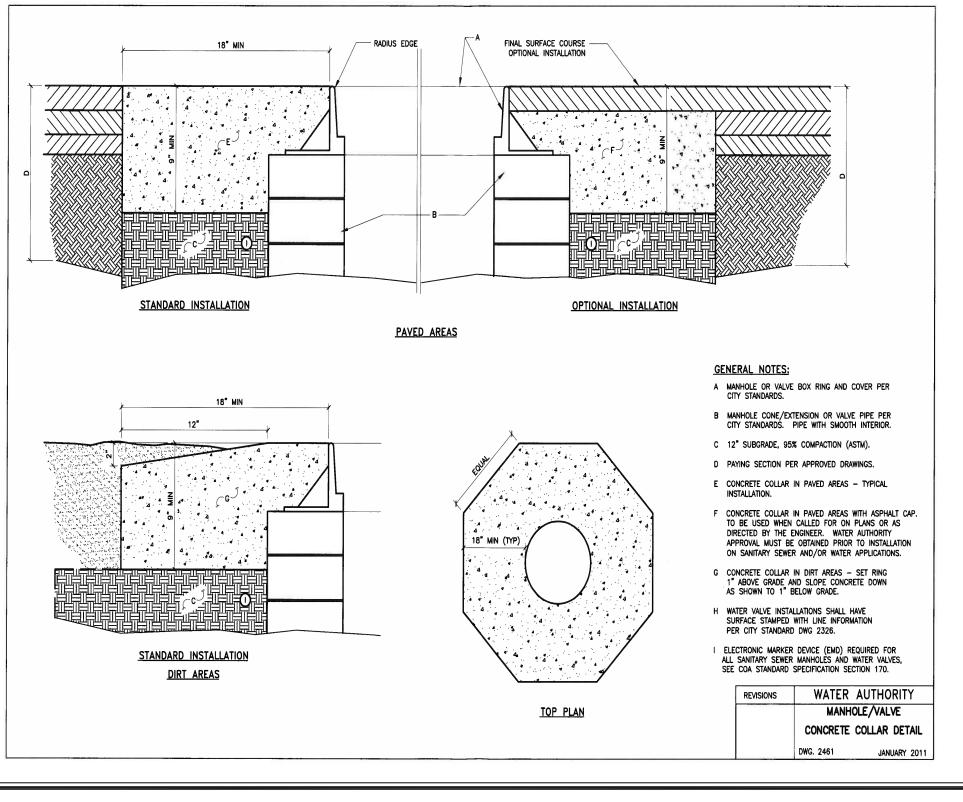

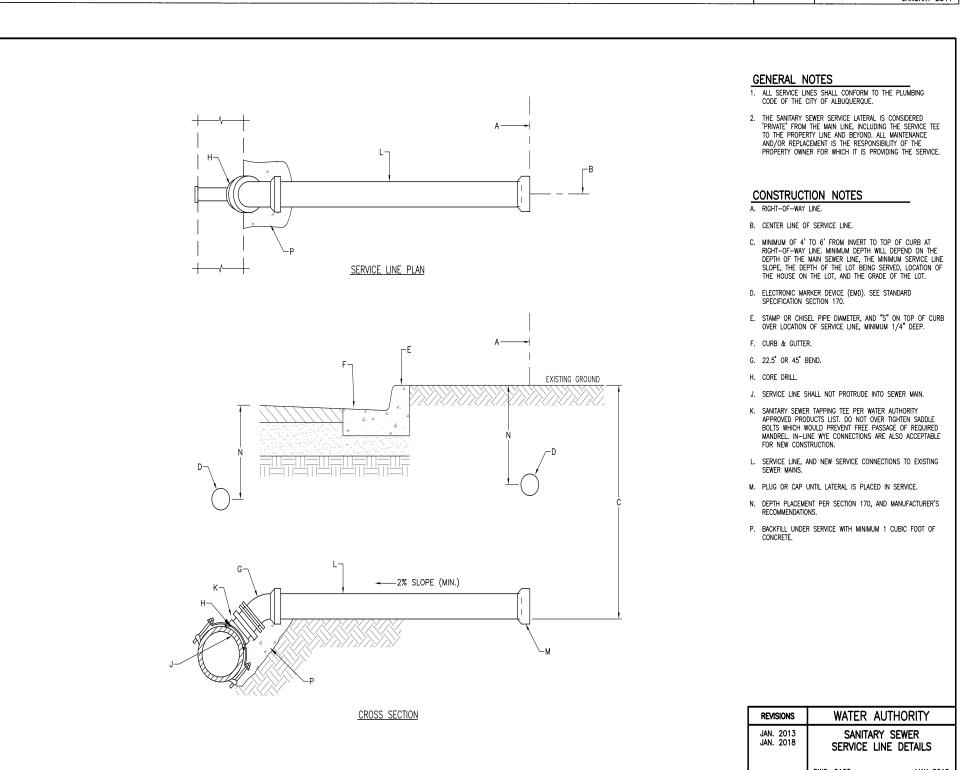



Engineering | Surveying **Materials Testing**

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||ENGINEERING SHEET:

UTILITY DETAILS

OF

PROJECT NAME: LA MORADA COMMERCIAL **DEVELOPMENT**

FOR

TED JARAMILLO


PROJECT NUMBER:

||CLIENT:

PROJECT ENGINEER:

Jeremy Baker, PE DRAWN BY: Carlos Jimenez


City of Albuquerque **Planning Department Development Review Services** HYDROLOGY SECTION **APPROVED** 4/29/2025 anth Mars HydroTrans# H10D039 THE APPROVAL OF THESE PLANS/REPORTS SHALL NOT BE CONSTRUED TO PERMIT VIOLATIONS OF ANY CITY ORDINANCE OR STATE LAW, AND SHALL NOT PREVENT THE CITY OF ALBUQUERQUE FROM REQUIRING

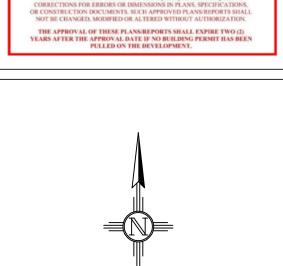

GRAPHIC SCALE SCALE: 1" = 30' (IN FEET)

REVISIONS		
No.	DATE	DESCRIPTION



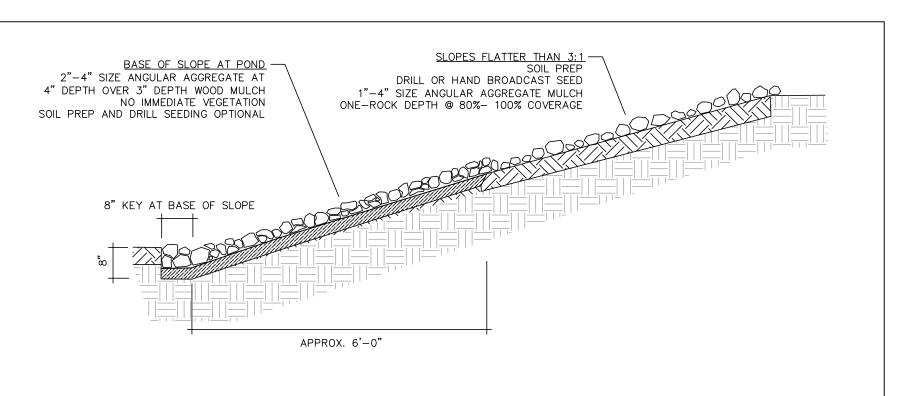

1) 1013-SKL-1: SLOPES FLATTER THAN 3:

30 _ _ AGS _ _ X

30 _ _ AGR _ _ X

** B° ·

3130 VERONA AVE

BUFORD, GA 30518 PHN (770) 932-2443

FAX (770) 932-2490

12 IN - 30 IN ROAD & HIGHWAY & CURB INLET FIELD

ADJUSTMENTS

7001-110-346 REV C

A1 1013-SKL-1: SLOPES FLATTER THAN 3:1

* MAXIMUM DEFLECTION FOR 4" - 30" ADS N-12/HANCOR DUAL WALL CORRUGATED HDPE PIPE IN ANY DIRECTION


THIS PRINT DISCLOSES SUBJECT MATTER IN WHICH NYLOPLAST HAS PROPRIETARY RIGHTS. THE RECEIPT


MATERIAL


ROAD & HIGHWAY

32 _ _ AGR _ _ X


** MAXIMUM FIELD GRADE TRIM ADJUSTMENT

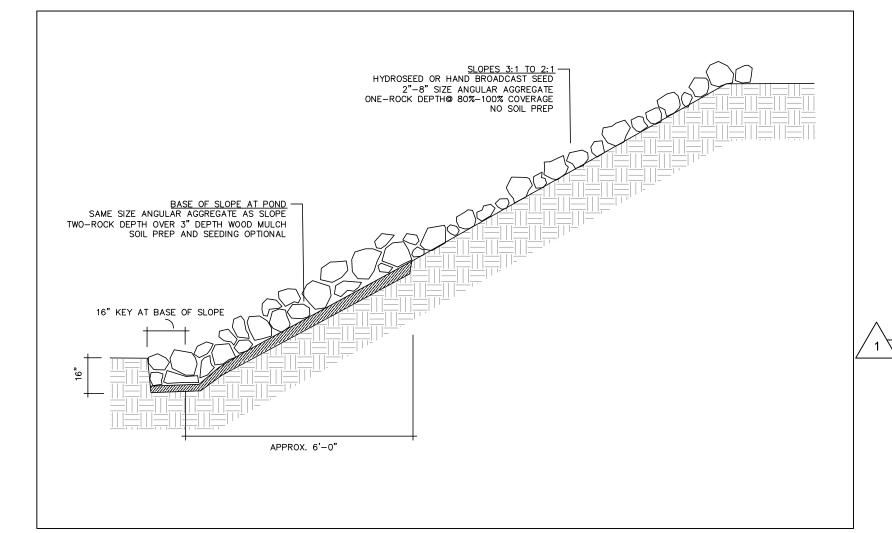

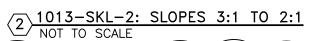

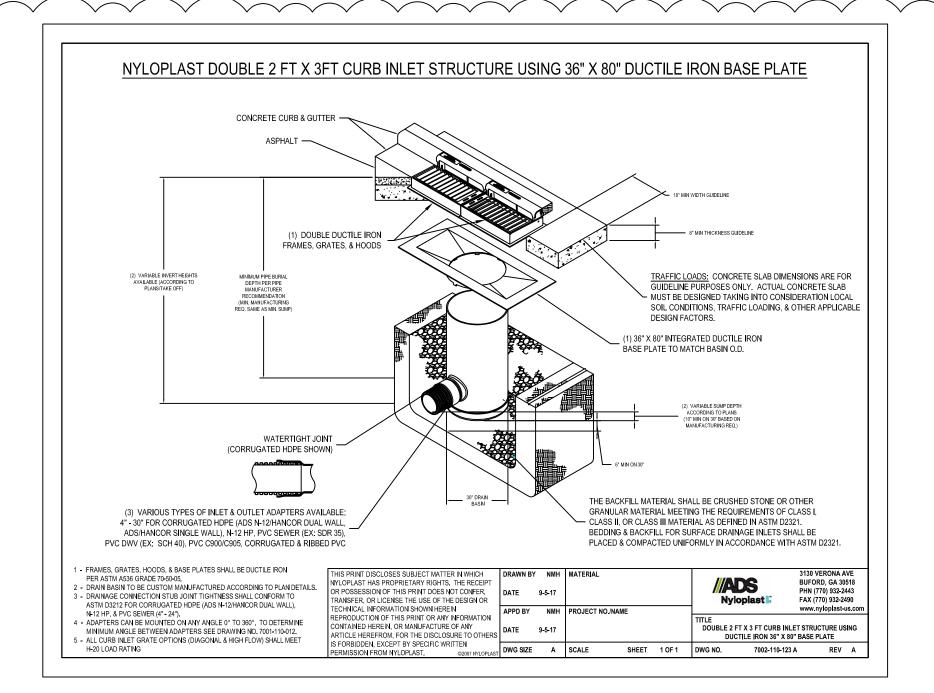

5 CURB INLET STRUCTURE USING DUCTILE IRON BASE PLACE NOT TO SCALE

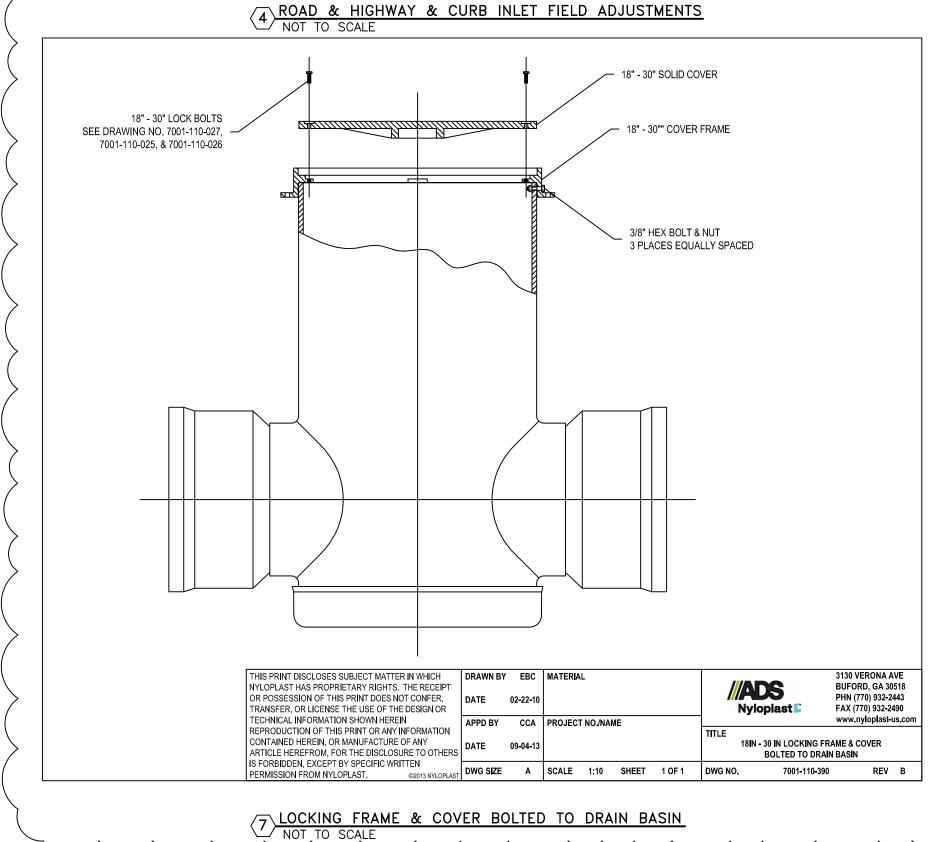


POSSESSION OF THIS PRINT DOES NOT CONFER, DATE 02-05-09


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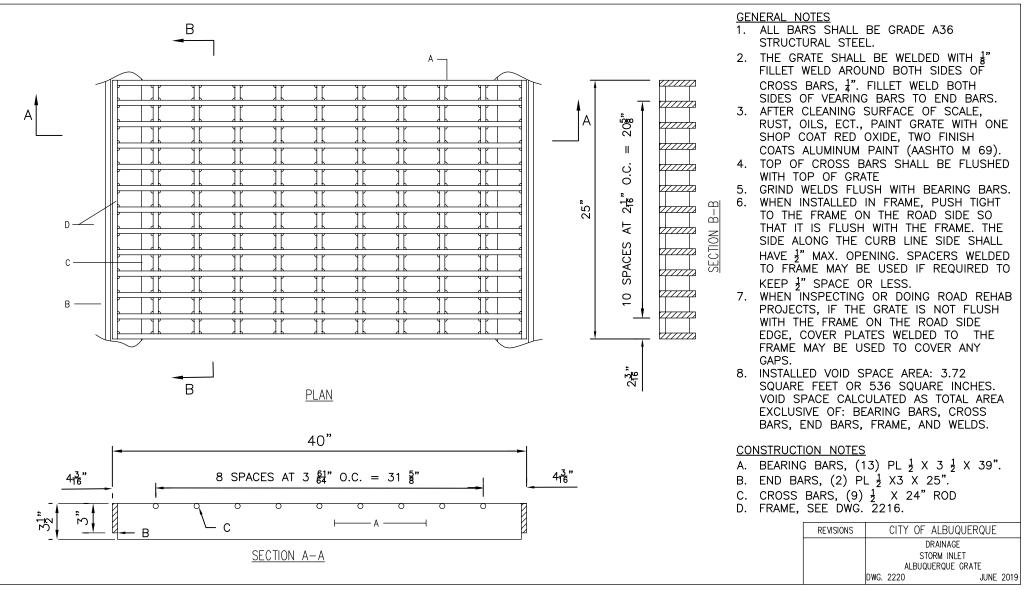


NOT TO SCALE

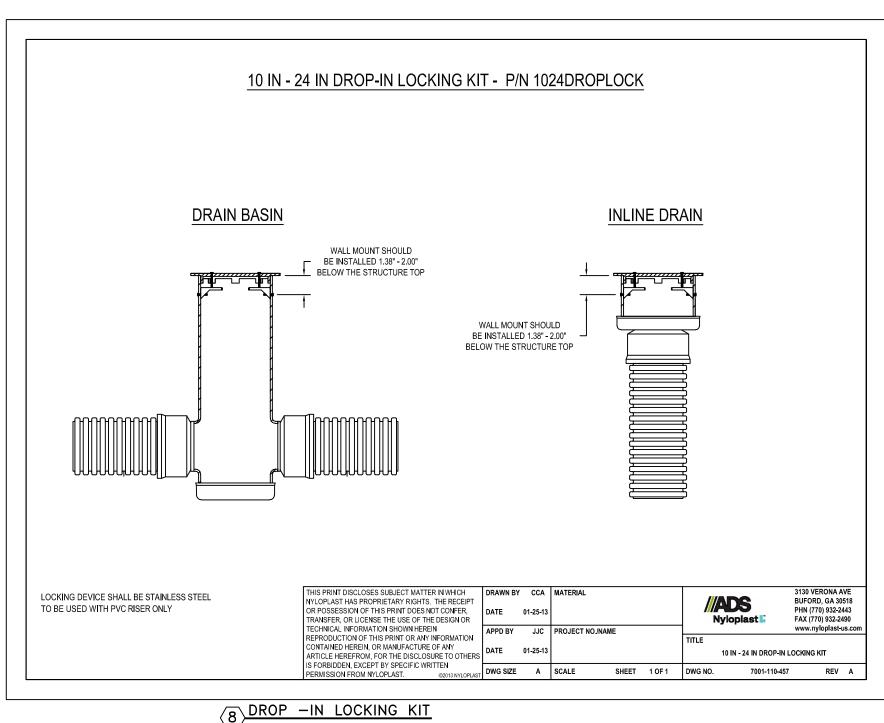


PAVING SPECIAL VALLEY GUTTERS

MOT TO STRAIF

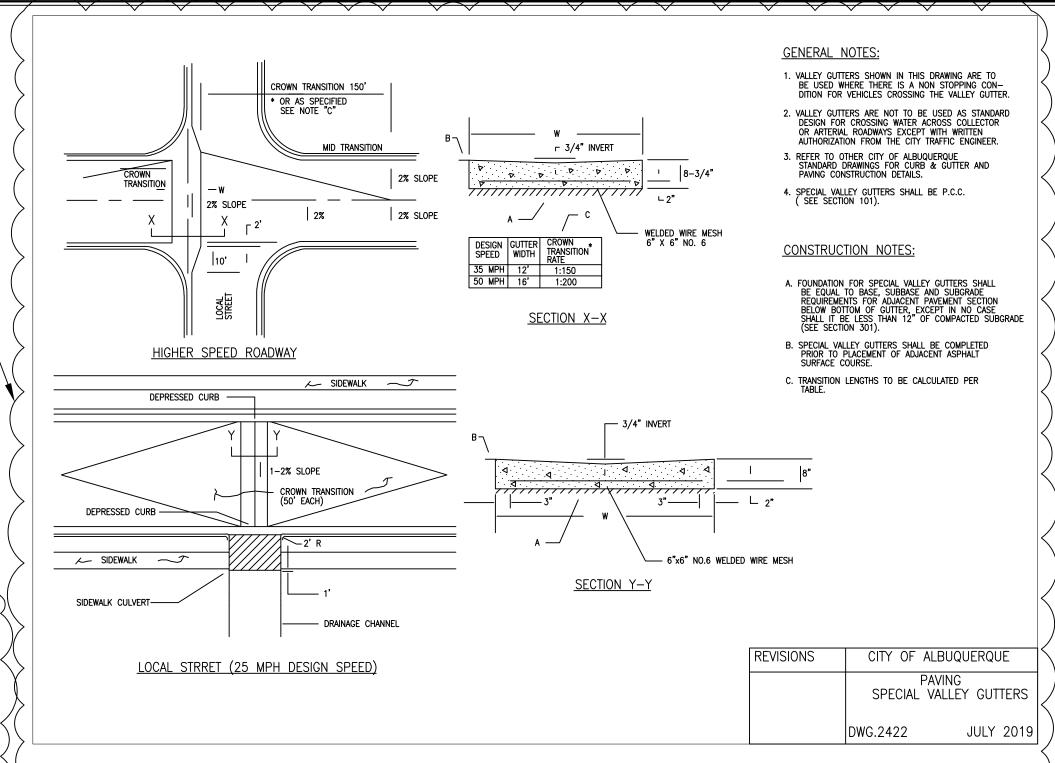

DRAINAGE STORM INLET

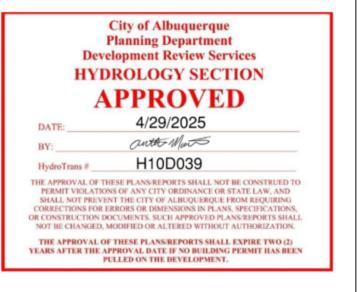



Engineering | Surveying Materials Testing

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ENGINEERING SHEET:

UTILITY DETAILS

OF

LA MORADA COMMERCIAL

DEVELOPMENT

|| ||CLIENT:

PROJECT NAME:

TED JARAMILLO

FOR

PROJECT NUMBER:

23192

PROJECT ENGINEER:

JEREMY BAKER, PE DRAWN BY: LPS

REVISIONS

No. DATE DESCRIPTION

1 6-21-24 ADDED VALLEY GUTTER DETAIL
2 8-27-24 DETAIL NAMES UPDATED



C-109