CITY OF ALBUQUERQUE



August 28, 2019

Vince Carrica, PE Tierra West LLC 5571 Midway Park Place NE Albuquerque, NM

Re:

U-Haul West Bluff

1801 Atrisco Dr. NW Albuquerque NM 87120

Request for Certificate of Occupancy

Transportation Development Final Inspection

Engineer's/Architect's Stamp dated 08-22-2019 (H11D059)

Certification dated 08-22-19

Dear Mr. Carrica.

Based upon the information provided in your Pictures received 8-28-19, Transportation Development has no objection to the issuance of a Permanent Certificate of

Occupancy. This letter serves as a "green tag" from Transportation Development for a PO Box 1293 Permanent Certificate of Occupancy to be issued by the Building and Safety Division.

If you have any questions, please contact Ernie Gomez at (505) 924-3981.

Albuquerque

Sincerely,

NM 87103

Ernest Armijo, P.E.

Senior Engineer, Planning Dept.

www.cabq.gov

Development Review Services

Ernie Gomez


Plan Checker, Planning Dept. **Development Review Services**

EG

via: email


C:

CO Clerk, File

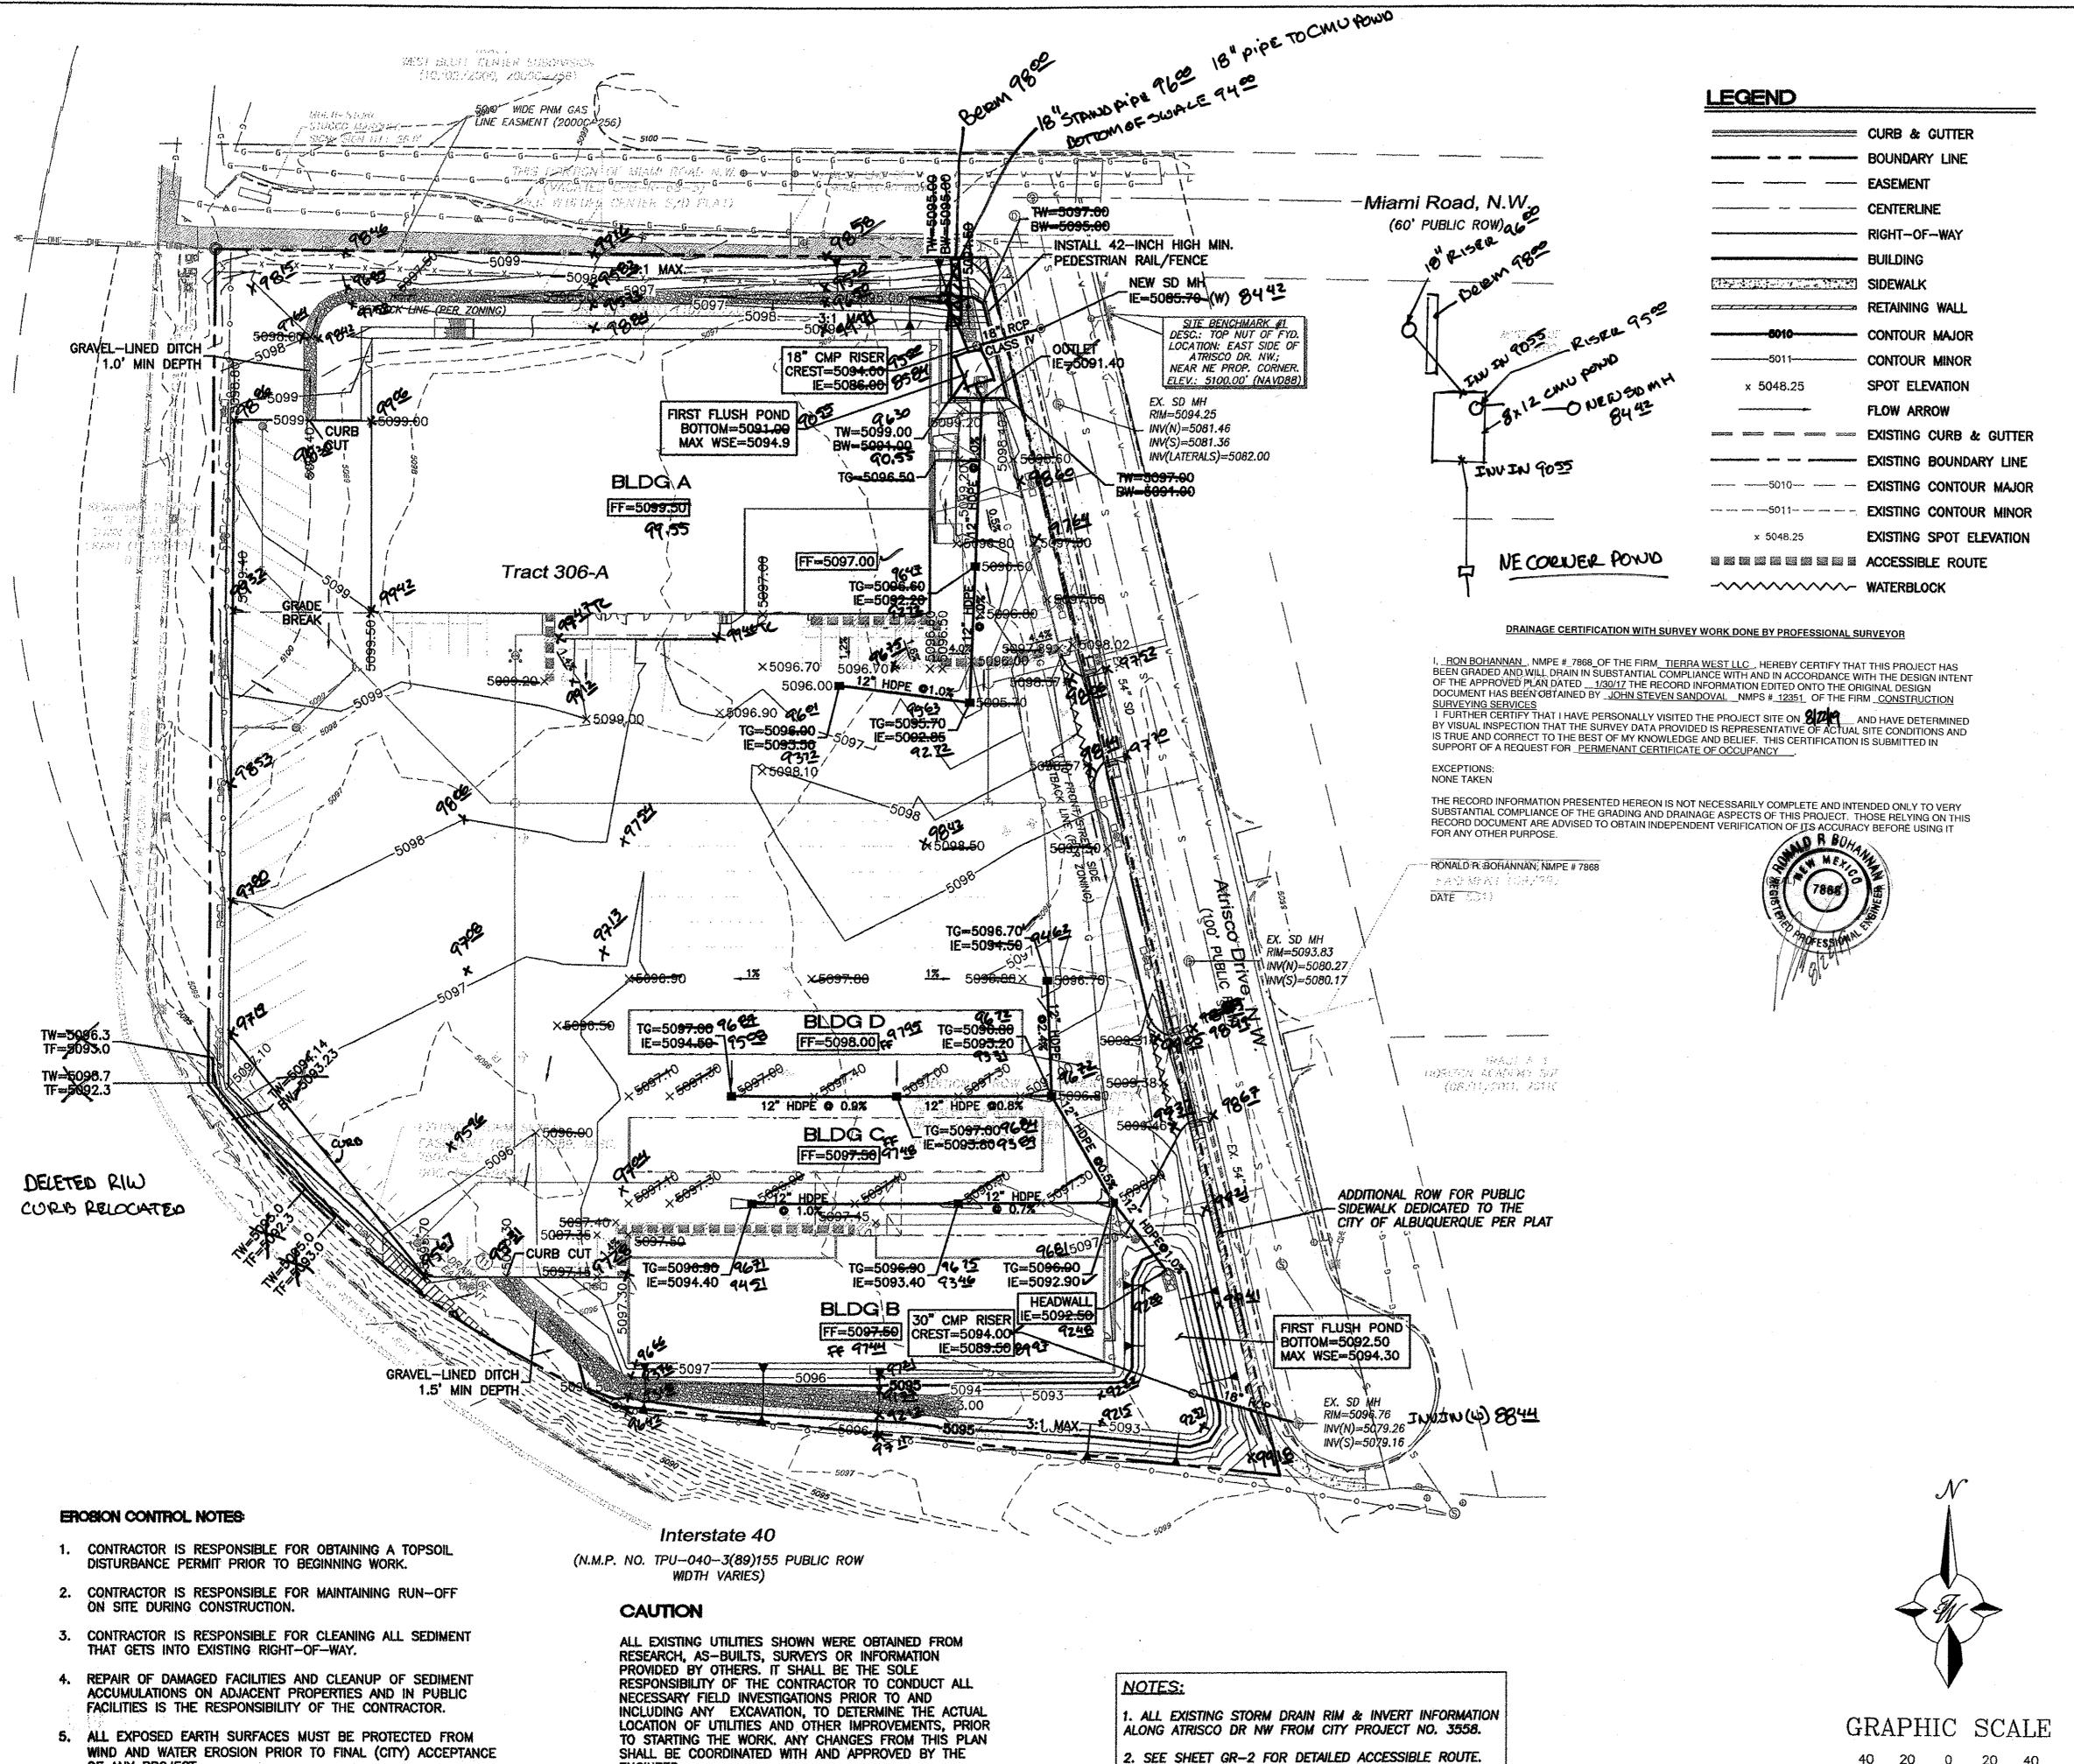

OF ANY PROJECT.


ENGINEER.

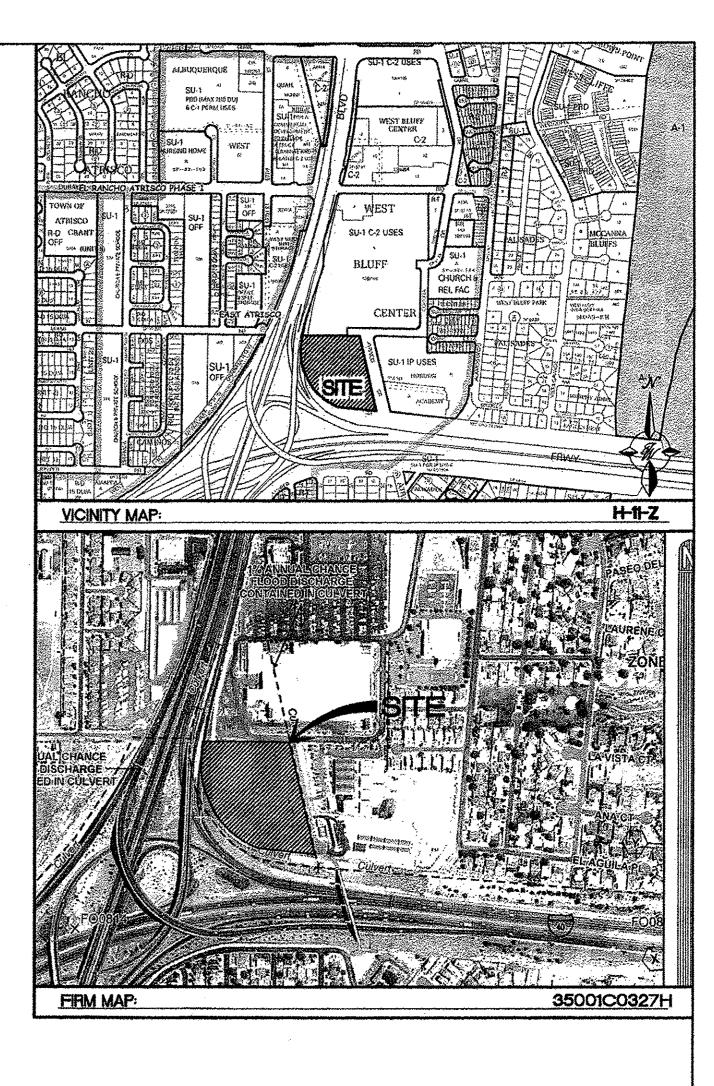

NOTICE TO CONTRACTORS

- 1. AN EXCAVATION/CONSTRUCTION PERMIT WILL BE REQUIRED BEFORE BEGINNING ANY WORK WITHIN CITY RIGHT-OF-WAY.
- 2. ALL WORK DETAILED ON THESE PLANS TO BE PERFORMED, EXCEPT AS OTHERWISE STATED OR PROVIDED HERON, SHALL BE CONSTRUCTED IN ACCORDANCE WITH CITY OF ALBUQUERQUE INTERIM STANDARD SPECIFICATIONS FOR PUBLIC WORKS CONSTRUCTION, 1985.
- 3. TWO WORKING DAYS PRIOR TO ANY EXCAVATION, CONTRACTOR MUST CONTACT LINE LOCATING SERVICE, 765-1234, FOR LOCATION OF EXISTING UTILITIES.
- 4. PRIOR TO CONSTRUCTION, THE CONTRACTOR SHALL EXCAVATE AND VERIFY THE HORIZONTAL AND VERTICAL LOCATIONS OF ALL CONSTRUCTIONS, SHOULD A CONFLICT EXIST, THE CONTRACTOR SHALL NOTIFY THE ENGINEER SO THAT THE CONFLICT CAN BE RESOLVED WITH A MINIMUM AMOUNT OF DELAY.
- 5. BACKFILL COMPACTION SHALL BE ACCORDING TO TRAFFIC/STREET USE.
- 6. MAINTENANCE OF THESE FACILITIES SHALL BE THE RESPONSIBILITY OF THE OWNER OF THE PROPERTY SERVED.
- 7. WORK ON ARTERIAL STREETS SHALL BE PERFORMED ON A 24-HOUR BASIS.

APPROVAL	NAME	DATE
INSPECTOR		

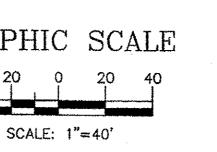


	WEST BLUFF	DRAWN BY DY		
	BUSINESS CENTER GRADING AND	<i>DATE</i> 1/30/17		
	DRAINAGE PLAN	2016061-GRB		
EN CONTROLL		SHEET #		
	TIERRA WEST, LLC	GR-1		

JOB #

2016061

5571 MIDWAY PARK PLACE NE ALBUQUERQUE, NM 87109 (505) 858-3100 RONALD R. BOHANNAN www.tierrawestlic.com P.E. #7868

ENGINEER'S SEAL

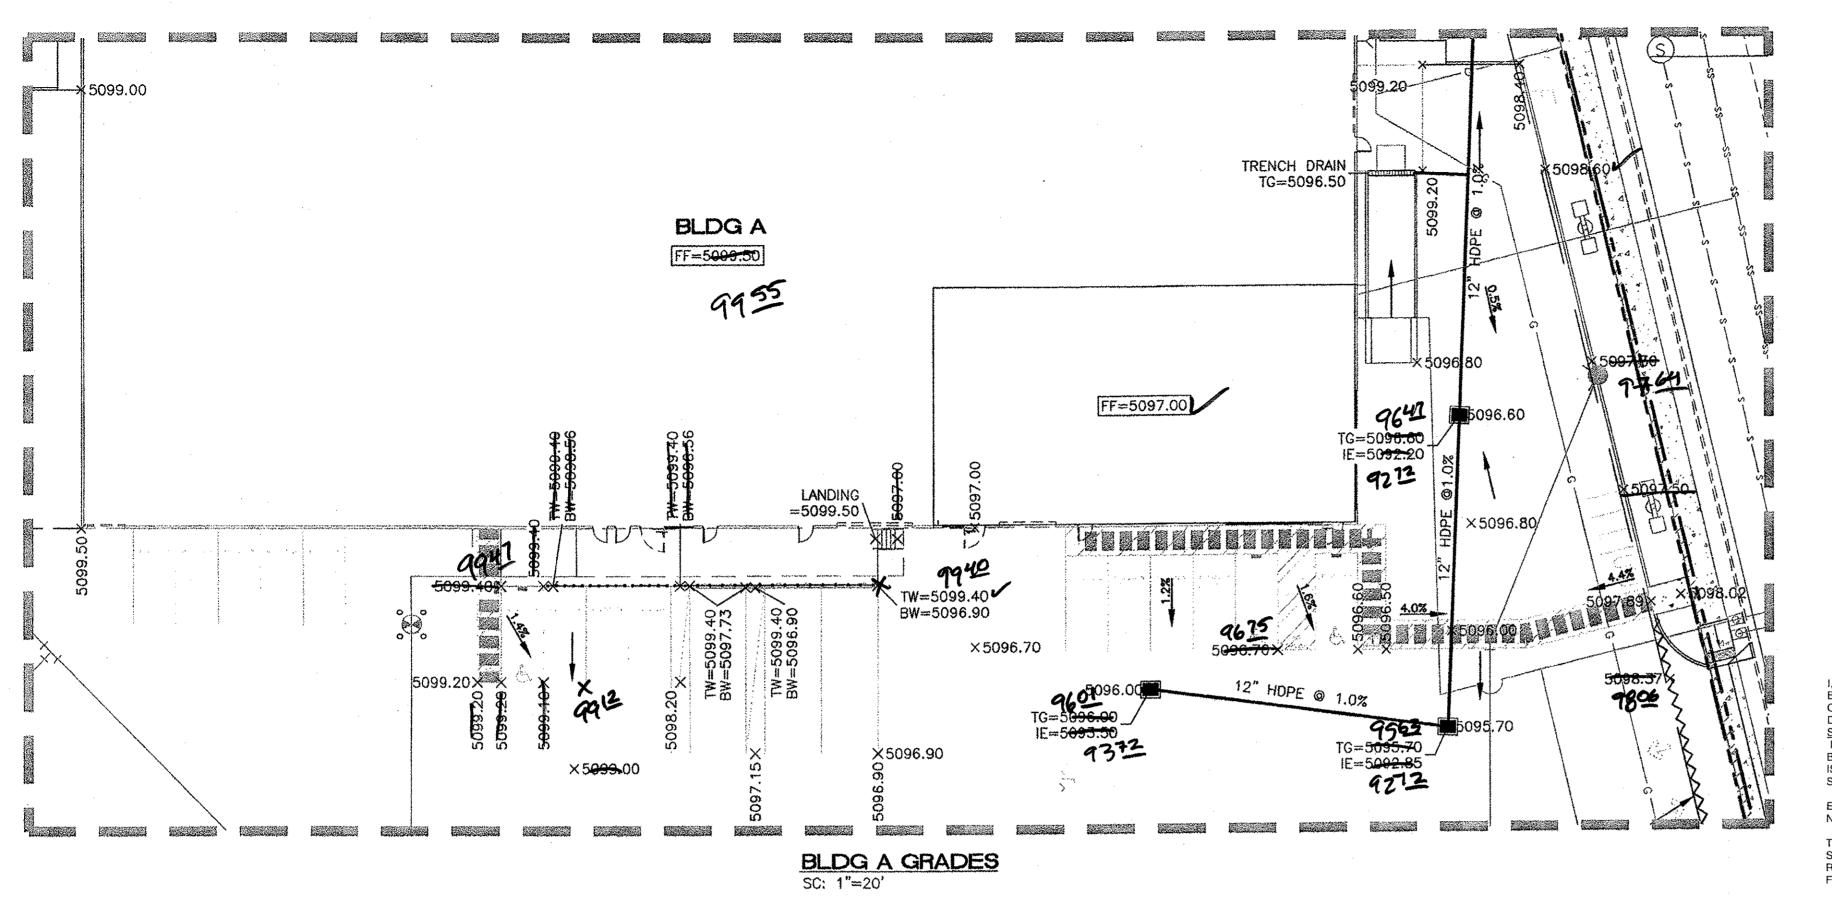

EROSION CONTROL NOTES

- 1. CONTRACTOR IS RESPONSIBLE FOR OBTAINING A TOPSOIL DISTURBANCE PERMIT PRIOR TO BEGINNING WORK,
- 2. CONTRACTOR IS RESPONSIBLE FOR MAINTAINING RUN-OFF ON SITE DURING CONSTRUCTION.
- 3. CONTRACTOR IS RESPONSIBLE FOR CLEANING ALL SEDIMENT THAT GETS INTO EXISTING RIGHT-OF-WAY.
- 4. REPAIR OF DAMAGED FACILITIES AND CLEANUP OF SEDIMENT ACCUMULATIONS ON ADJACENT PROPERTIES AND IN PUBLIC FACILITIES IS THE RESPONSIBILITY OF THE CONTRACTOR.
- 5. ALL EXPOSED EARTH SURFACES MUST BE PROTECTED FROM WIND AND WATER EROSION PRIOR TO FINAL (CITY) ACCEPTANCE OF ANY PROJECT.

CAUTION

ALL EXISTING UTILITIES SHOWN WERE OBTAINED FROM RESEARCH, AS-BUILTS, SURVEYS OR INFORMATION PROVIDED BY OTHERS. IT SHALL BE THE SOLE RESPONSIBILITY OF THE CONTRACTOR TO CONDUCT ALL NECESSARY FIELD INVESTIGATIONS PRIOR TO AND INCLUDING ANY EXCAVATION, TO DETERMINE THE ACTUAL LOCATION OF UTILITIES AND OTHER IMPROVEMENTS, PRIOR TO STARTING THE WORK. ANY CHANGES FROM THIS PLAN SHALL BE COORDINATED WITH AND APPROVED BY THE ENGINEER.

DRAINAGE CERTIFICATION WITH SURVEY WORK DONE BY PROFESSIONAL SURVEYOR

I, RON BOHANNAN, NMPE #_7868_OF THE FIRM_TIERRA WEST LLC, HEREBY CERTIFY THAT THIS PROJECT HAS BEEN GRADED AND WILL DRAIN IN SUBSTANTIAL COMPLIANCE WITH AND IN ACCORDANCE WITH THE DESIGN INTENT OF THE APPROVED PLAN DATED _1/30/17 THE RECORD INFORMATION EDITED ONTO THE ORIGINAL DESIGN DOCUMENT HAS BEEN OBTAINED BY JOHN STEVEN SANDOVAL NMPS #_12351 OF THE FIRM CONSTRUCTION SURVEYING SERVICES INC. SURVEYING SERVICES INC.

I FURTHER CERTIFY THAT I HAVE PERSONALLY VISITED THE PROJECT SITE ON 10 MIN AND HAVE DETERMINED BY VISUAL INSPECTION THAT THE SURVEY DATA PROVIDED IS REPRESENTATIVE OF ACTUAL SITE CONDITIONS AND IS TRUE AND CORRECT TO THE BEST OF MY KNOWLEDGE AND BELIEF. THIS CERTIFICATION IS SUBMITTED IN SUPPORT OF A REQUEST FOR PERMENANT CERTIFICATE OF OCCUPANCY


NONE TAKEN


THE RECORD INFORMATION PRESENTED HEREON IS NOT NECESSARILY COMPLETE AND INTENDED ONLY TO VERY SUBSTANTIAL COMPLIANCE OF THE GRADING AND DRAINAGE ASPECTS OF THIS PROJECT. THOSE RELYING ON THIS RECORD DOCUMENT ARE ADVISED TO OBTAIN INDEPENDENT VERIFICATION OF THIS RECURACY BEFORE USING IT FOR ANY OTHER PURPOSE.

RONALD R. BOHANNAN, NMPE # 7868






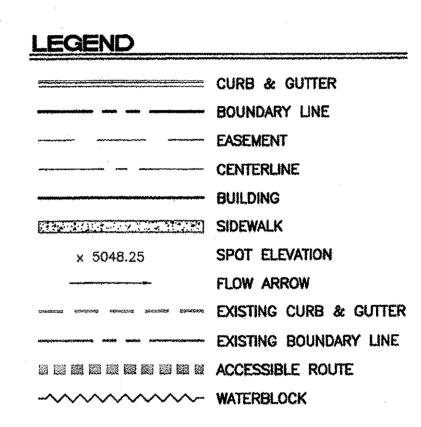

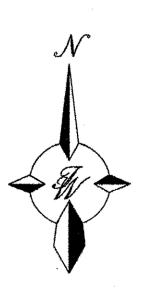

GRAPHIC SCALE

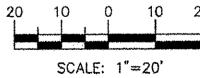

DRAWN BY

DY


1/25/17

2016**061**-GRB

SHEET #

0.87' WATER BLOCK


SECTION A-A

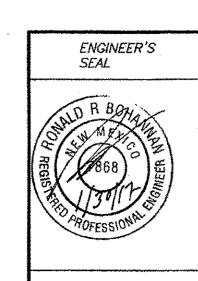


}	ST BLUFF NESS CENTER						
GRADING AND DRAINAGE PLAN							
***************************************	TIERRA WEST, LLC						


RONALD R. BOHANNAN P.E. #7868

GR-2 5571 MIDWAY PARK PLACE NE ALBUQUERQUE, NM 87109 (505) 858-3100 www.tierrawestllc.com JOB # 2016061

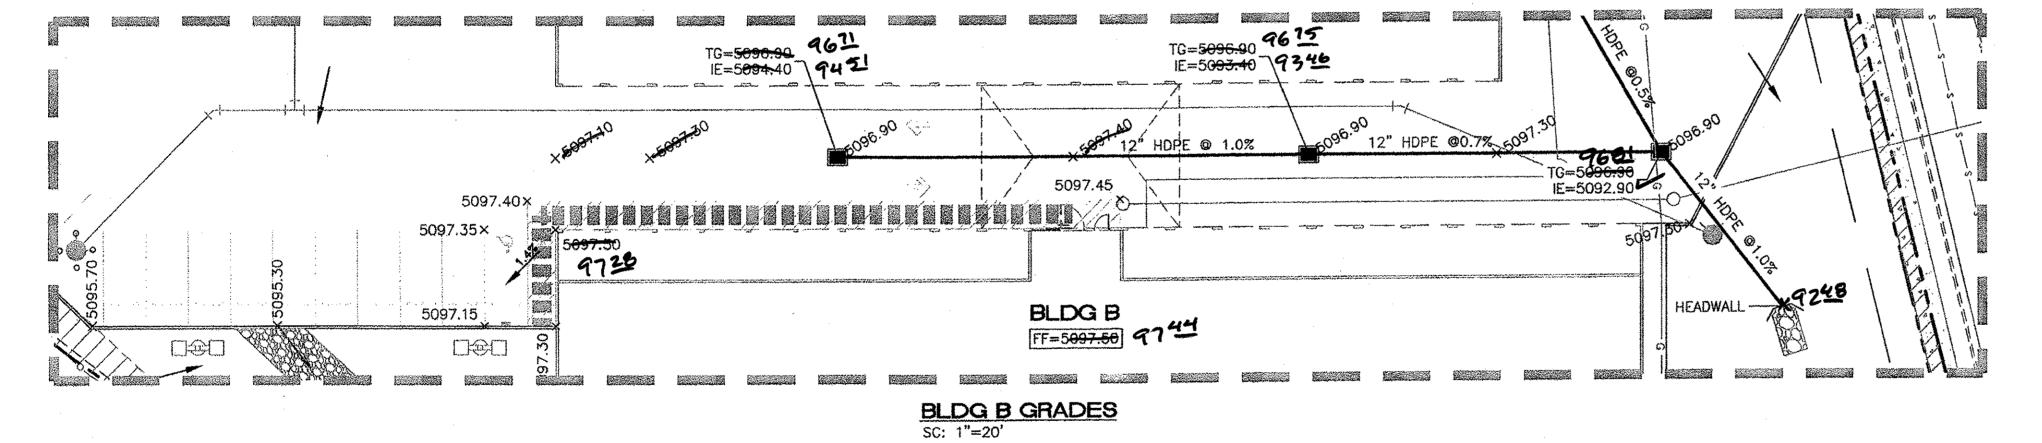


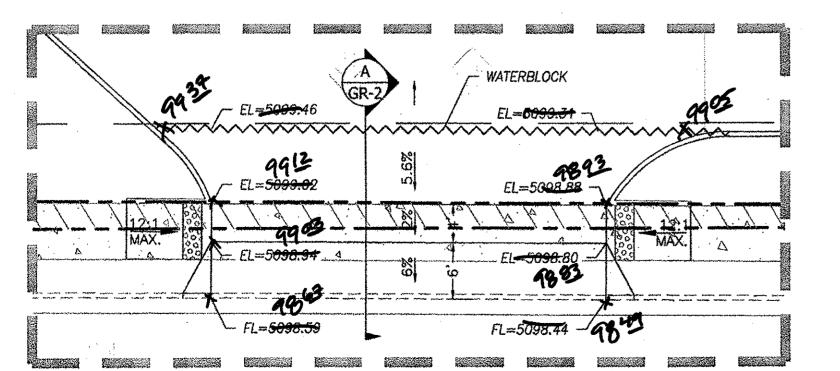



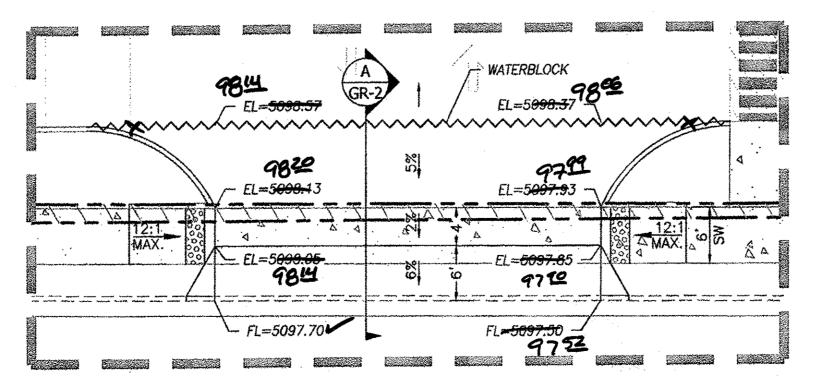

NORTH ENTRANCE
SC: 1"=10'

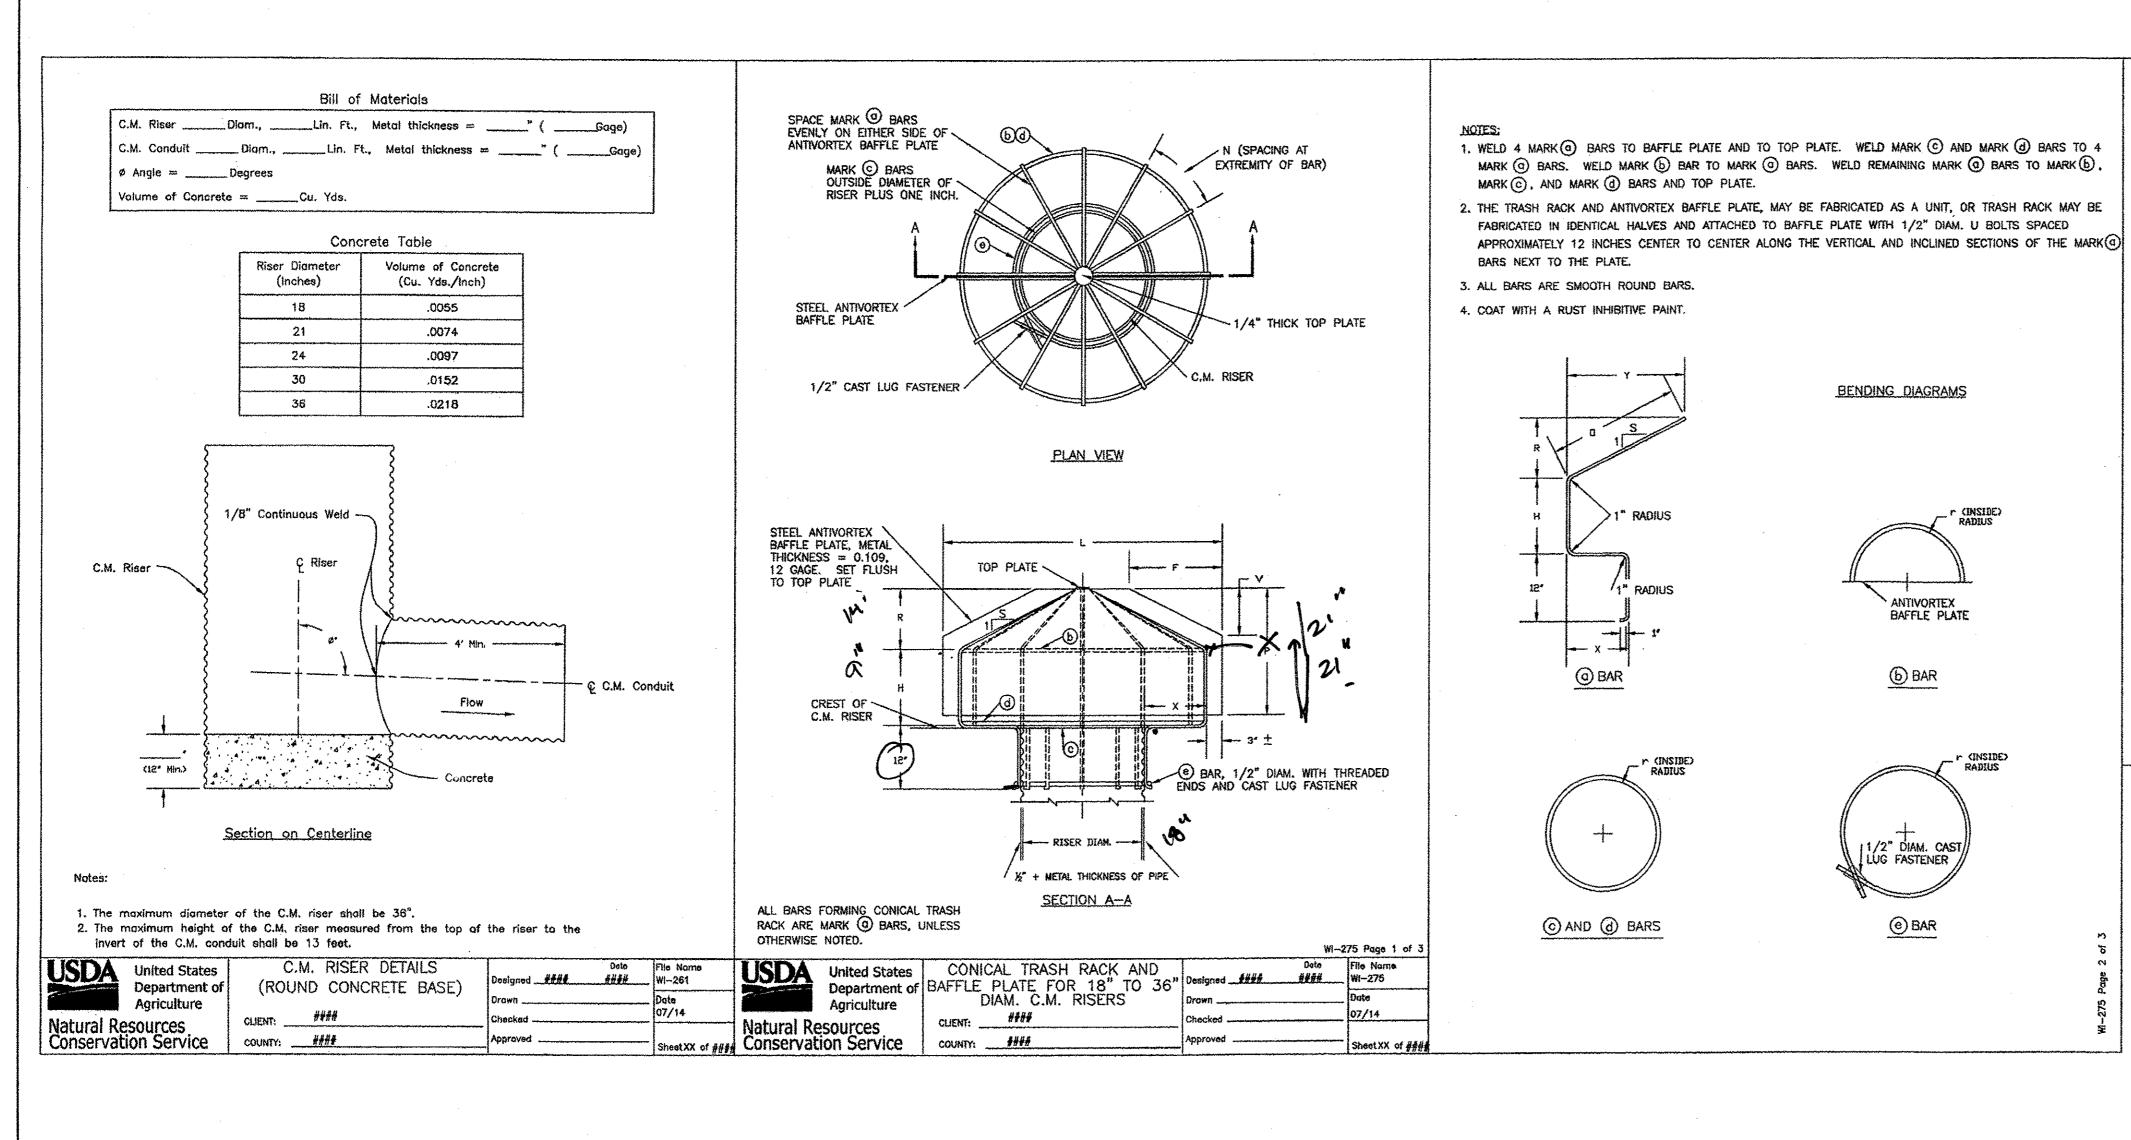

1.	<i>7</i> 9
4" WALL CAP TO	
MATCH CMU COLOR - & TEXTURE	
TW-TOP OF WALL, ELEVATION PER PLAN	
8" CMU BLOCK. BOND BEAM SEE NOTE 9	
JOINT REINFORCEMENT WATER PROOFING (HENRY SEE TABLE AQUA-BLOCK WB OR EQUAL)	
GROUT SOLID————————————————————————————————————	
OTHER COURSE Y-BARS	
4" WEEP HOLE GRAVEL DRAIN W/ 10' O.C. GEOTEXTILE FABRIC	÷
OPEN JOINTS 12" WIDE X 12" HIGH, CONTINUOUS WALL LENGTH	
FOOTING, ELEVATION X-BARS	
DOWELS SEE NOTE 6 TYP.	
3-1/2" to #5 BARS	
3-1/2" \ \ \ \ \ \ \ \ \ \ \ \ \ \ \ \ \ \ \	7
В	

8 INCH	REIN	FORCED	CONC	RETE MASONRY	WALL
H	Α	В	T	Y-BARS	X-BARS
ftin.	in.	ft,-in.	in.		
2'-0" 2'-8" 3'-4" 4'-0" 4'-8" 5'-4" 6'-0"	8" 8" 8" 10" 12" 14" 16"	2'-0" 2'-0" 2'-4" 2'-8" 3'-4" 3'-10" 4'-8"	9" 9" 9" 9" 10" 12"	#4 @32" O.C. #4 @32" O.C. #4 @32" O.C. #4 @32" O.C. #5 @32" O.C. #6 @16" O.C. #6 @ 8" O.C.	#4 @24" O.C. #4 @24" O.C. #4 @24" O.C. #4 @18" O.C. #4 @18" O.C. #4 @12" O.C.

12 INCH	4 REIN	VFORCED	CONC	RETE MASONRY	WALL
Н	Α	В	T	Y-BARS	X-BARS
ftin.	in.	ftin.	in.		
5'-4" 6'-0" 6'-8" 7'-4" 8'-0" 8'-8"	14" 15" 16" 18" 20" 20"	3'-8" 4'-2" 4'-6" 4'-10" 5'-4" 5'-8"	10" 12" 12" 12" 12" 12"	#6 @18" O.C. #4 @16" O.C. #6 @24" O.C. #6 @16" O.C. #7 @18" O.C. #7 @16" O.C.	#4 @24" O.C. #4 @18" O.C. #5 @18" O.C. #5 @18" O.C. #6 @12" O.C. #6 @12" O.C.

GENERAL NOTES:

- ALL CONCRETE IS TO BE 4000 PSI @ 28 DAYS.
 MINIMUM COMPACTION UNDER FOOTINGS IS TO BE 95% PER ASTM. D 1557 FOR A DEPTH OF 12" MOISTURE CONTENT IS
- TO BE ± 2.0%.

 3. BACK FILL AGAINST WALLS IS TO BE HAND-PLACED AND
- COMPACTED.
 4. ALL BARS ARE TO BE GRADE 60, ASTM 615.
- TRUSS TYPE DUR-O-WALL EVERY OTHER COURSE.
 DOWELS SHALL BE AT LEAST EQUAL IN SIZE AND SPACING TO V-BARS, SHALL PROJECT A MINIMUM OF 30 BAR DIA. INTO THE FILLED BLOCK CORES, AND SHALL EXTEND TO THE
- TOE OF THE FOOTING.

 7. PROVIDE KEY FOR 8" AND 12" WALLS WHERE H EXCEEDS 6'-0"

 8. USE EITHER EXPANSION JOINTS ON 20' CENTERS OR PILASTERS EVERY 16'.
- 9. BOND BEAM, 1-#4 BARS FOR WALLS UNDER 3'-4", 2-#4 BARS FOR WALLS UNDER 5'-4", 2-#5 BARS FOR WALLS OVER 5'-4".

RETAINING WALL DETAIL

			a BARS	5/8" DI	METER				ANTIV	ORTEX BA	FFLE PLAT	Ε,
Н	R	Х	Υ	S	0	TOTAL	NO.	N	L	P	F	٧
NCHES	INCHES	INCHES	INCHES		INCHES	LENGTH	REQ'D	INCHES		INCHES	INCHES	INCHES
			<u> </u>	18	" DIAMETER	R CORRUGATI	ED METAL	RISER		1		
9	14-1/8	6	14-1/8		20	4'	10	11-7/16	3'	21	8	8
				21	" DIAMETEI	R CORRUGAT	ED METAL	RISER				
12	9-1/4	9	18-1/2	2	20-5/8	4' 6-5/8"	12	12-3/8	4'	18	12	5
				24	* DIAMETEI	R CORRUGAT	ED METAL	RISER				
15	11~3/8	12	22-3/4	2	25-3/8	5' 5-3/8"	12	14-13/16	4'-6"	24	18	9
				30	" DIAMETEI	R CORRUGAT	ED METAL	RISER				
18	9-1/2	15	28-1/2	3	30	6' 4"	14	15-13/16	6'	24	21	7
				36	" DIAMETEI	R CORRUGAT	ED METAL	RISER		7		
21	12-1/2	21	37-5/8	3	39-1/2	7'10-1/2"	16	17-5/16	7'-6"	30	30	10

TABLE OF DIMENSIONS AND QUANTITIES

				TABL	E OF DIA	MENSION:	S AND QU	ANTITIES						
BA	RS 5/8" DV	METER	© BAR	S 5/8" D	IAMETER	d BA	RS 5/8" DI	AMETER	@ BAF	RS 5/8" D	IÁMETER	TOP PLATE		
NO.	r	LENGTH	NO.	r	LENGTH	NO.	r	LENGTH	NO.	r	LENGTH	DIAM.		
REQ'D.	INCHES	INCHES	REQ'D	INCHES	INCHES	REQ'D	INCHES	INCHES	REQ'D	INCHES	INCHES	INCHES		
	L			18"	DIAMETER	CORRUG	ATED METAL	RISER	***************************************					
2	14-5/16	46	1	10	62-10	1	14-5/16	92	1	10-1/4	73	3		
		_		21"	DIAMETER	CORRUG	ATED METAL	RISER						
2	18-13/16	60	1	11-1/2	72-1/4	1	18-13/16	120	1	11-3/4	82-1/2	3-1/2		
				24"	DIAMETER	CORRUG	ATED METAL	RISER						
2	23-5/16	74	***	13	81-8	1	23-5/16	148	1	13-1/4	91-1/2	3-1/2		
				30"	DIAMETER	CORRUG	ATED METAL	RISER	,,,,,,,,,,,,,,,,,,,,,,,,,,,,,,,,,,,,,,					
2	29- 5/16	93	1	16	100-1/2	1	29-5/16	186	1	16-1/4	111	4		
				36"	DIAMETER	CORRUG	ATED METAL	RISER						
2	38-3/8	121-1/2	1	19	119-5	1	38-3/8	243	1	19-1/4	129	4		

DRAINAGE CERTIFICATION WITH SURVEY WORK DONE BY PROFESSIONAL SURVEYOR

I, RON BOHANNAN, NMPE #_7868_OF THE FIRM_TIERRA WEST LLC_, HEREBY CERTIFY THAT THIS PROJECT HAS BEEN GRADED AND WILL DRAIN IN SUBSTANTIAL COMPLIANCE WITH AND IN ACCORDANCE WITH THE DESIGN INTENT OF THE APPROVED PLAN DATED _1/30/17 THE RECORD INFORMATION EDITED ONTO THE ORIGINAL DESIGN DOCUMENT HAS BEEN OBTAINED BY _JOHN STEVEN SANDOVAL_NMPS #_12351_ OF THE FIRM _CONSTRUCTION SURVEYING SERVICES INC.

I FURTHER CERTIFY THAT I HAVE PERSONALLY VISITED THE PROJECT SITE ON ______ AND HAVE DETERMINED BY VISUAL INSPECTION THAT THE SURVEY DATA PROVIDED IS REPRESENTATIVE OF ACTUAL SITE CONDITIONS AND IS TRUE AND CORRECT TO THE BEST OF MY KNOWLEDGE AND BELIEF. THIS CERTIFICATION IS SUBMITTED IN SUPPORT OF A REQUEST FOR _PERMENANT CERTIFICATE OF OCCUPANCY____.

EXCEPTIONS: NONE TAKEN

THE RECORD INFORMATION PRESENTED HEREON IS NOT NECESSARILY COMPLETE AND INTENDED ONLY TO VERY SUBSTANTIAL COMPLIANCE OF THE GRADING AND DRAINAGE ASPECTS OF THIS PROJECT. THOSE RELYING ON THIS RECORD DOCUMENT ARE ADVISED TO OBTAIN INDEPENDENT VERIFICATION OF ITS ACCURACY BEFORE USING IT FOR ANY OTHER PURPOSE.

RONALD R. BOHANNAN, NMPE # 7868

DATE



ENGINEER'S SEAL	WEST BLUFF	DRAWN BY
IN R BOW	BUSINESS CENTER GRADING AND	<i>DATE</i> 1/30/17
THE WEST COLUMN	DRAINAGE DETAILS	2016061-GRB
7868 1 WE		SHEET #
OFESSIONAL EN	TIERRA WEST, LLC 5571 MIDWAY PARK PLACE NE ALBUQUERQUE, NM 87109	GR-3
RONALD R. BOHANNAN P.E. #7868	(505) 858-3100 www.tierrawestllc.com	JOB # 2016061