

GENERAL NOTES:

- A. See sheet CG.0 for complete list of general notes and symbol/linetype legend that apply to all sheets.
- B. Surface features associated with underground utilities are shown on paving plans for clarity. See applicable utility plans for construction notes and details.
- C. Contractor shall field verify site for existing conditions (spoils, borrow areas, etc.) prior to bidding earthwork quantities.
- D. Contractor to reference Architectural specifications and soils report for recommendations on building pad earthwork, concrete and asphalt sections.

				60	
	TC	FL		TC	FL
1	4.95	4.45	1	3.65	3.65
2	4.36	4.36	2	4.23	3.73
3	4.95	4.28	3	4.31	3.81
C16			C9		
	TC	FL		TC	FL
1	3.23	3.23	1	4.15	3.65
2	3.86	3.36	2	4.03	3.53
3	3.98	3.48	3	3.41	3.41


REFER TO SHEET C2.2 FOR CURVE & LINE TABLES


AS INDICATED BY THE AS-BUILT INFORMATION SHOWN HEREON, THE BE ADDRESSED ON THE LETTER DATED 11/2/05 WITH THE EXCEPTION OF ITEM 4 WHICH READ" The elevations of the new pavement north of the building have not been built to design grades. The water block near the northwest corner of the building has not been constructed." IN REVIEW OF THE AS-BUILT GRADES COLLECTED AND PROVIDED BY JOAQUINE ARGUELLES, PS ON 10/21/05 AND SUPPLEMENTED ON 2/02/06, IT APPEARS THAT THE AFORMENTIONED WATER BLOCK WAS BUILT APPROXIMATELY 45' TO THE WEST, WHICH ADDED AN ADDITIONAL 0.08 AC OF AREA THAT DRAINS INTO THE DETENTION PONDS ADJACENT TO 57TH St. THE ACCOMPANYING DRAINAGE PLAN ADDRESSES THIS CHANGE. HOWEVER, THE DISPLACEMENT OF THE WATER BLOCK HAS LESSENED THE DESIGN SLOPE OF THE ORIGINAL SWALE TO THE RETENTION POND FROM 2% TO .5% ALONG THIS 125' SWALE. ALTHOUGH POSITIVE DRAINAGE IS CURRENTLY APPARENT AS SHOWN ON THE PROVIDED AS-BUILTS, AUTOZONE MUST PROVIDE MAINTENANCE OF THIS SWALE TO ENSURE THAT BIRDBATHS DON'T PROPAGATE AS THE ASPHALT AGES. IF THIS OCCURS OVER THE COURSE OF TIME, IT IS RECOMMENDED THAT A CONCRETE RIBBON CHANNEL OR UNDERGROUND SLOTTED DRAIN BE INSTALLED TO ENSURE POSITIVE DRAINAGE TO THE RETENTION POND.

IT IS BASED UPON THIS EVALUATION OF AS-CONSTRUCTED CONDITIONS THAT ISSUANCE OF A FINAL CERTIFICATE OF OCCUPANCY (CO) IS HEREBY RECOMMENDED WITH THE NOTING OF THE FUTURE RECOMMENDATIONS MENTIONED ABOVE, AND THAT THE SITE APPEARS TO HAVE BEEN CONSTRUCTED IN GENERAL COMPLIANCE OF THE APPROVED PLAN.

COLLECTION OF THE AS-BUILT INFORMATION WAS PERFORMED BY JOAQUINE ARGUELLES, PS (NM 7472) THIS INFORMATION IS INTENDED ONLY TO VERIFY SUBSTANTIAL COMPLIANCE WITH THE GRADING & DRAINAGE ASPECTS OF THIS PROJECT.


THIS CERTIFICATION DOES NOT ADDRESS OR EVALUATE ADA ACCESSIBILITY ISSUES OR COMPLIANCE. THOSE RELYING ON THIS RECORD DOCUMENT ARE ADVISED TO OBTAIN INDEPENDENT VERIFICATION OF ITS ACCURACY BEFORE USING IT FOR ANY OTHER PURPOSE.

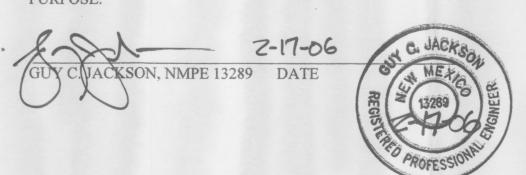

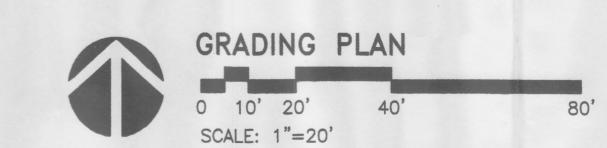



Designing to Shape the future

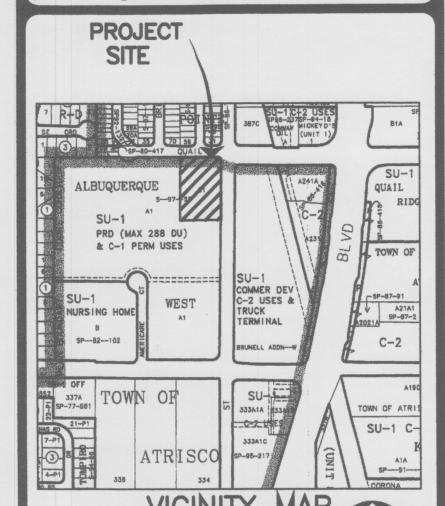

LEGAL DESCRIPTION

TRACT LETTERED C-ONE (C-1), OF THE PLAT
OF TRACTS A-1 AND C-1, ALBUQUERQUE
WEST, A SUBDIVISION IN ALBUQUERQUE,
BERNALILLO COUNTY, NEW MEXICO, AS THE
SAME IS SHOWN AND DESIGNATED ON THE PLAT
THEREOF, FILED IN THE OFFICE OF THE COUNTY
CLERK OF BERNALILLO COUNTY, NEW MEXICO
ON JULY 25, 1997 IN PLAT BOOK 97C, FOLIO
232.

BENCH MARK
ALBUQUERQUE CONTROL MONUMENT "12-H11"
ELEV=5102.17



ARCHITECT

AUTOZONE 57TH & QUAIL


RFB# A04029


2-05


GRADING PLAN

DRAWING NO.

C2.0

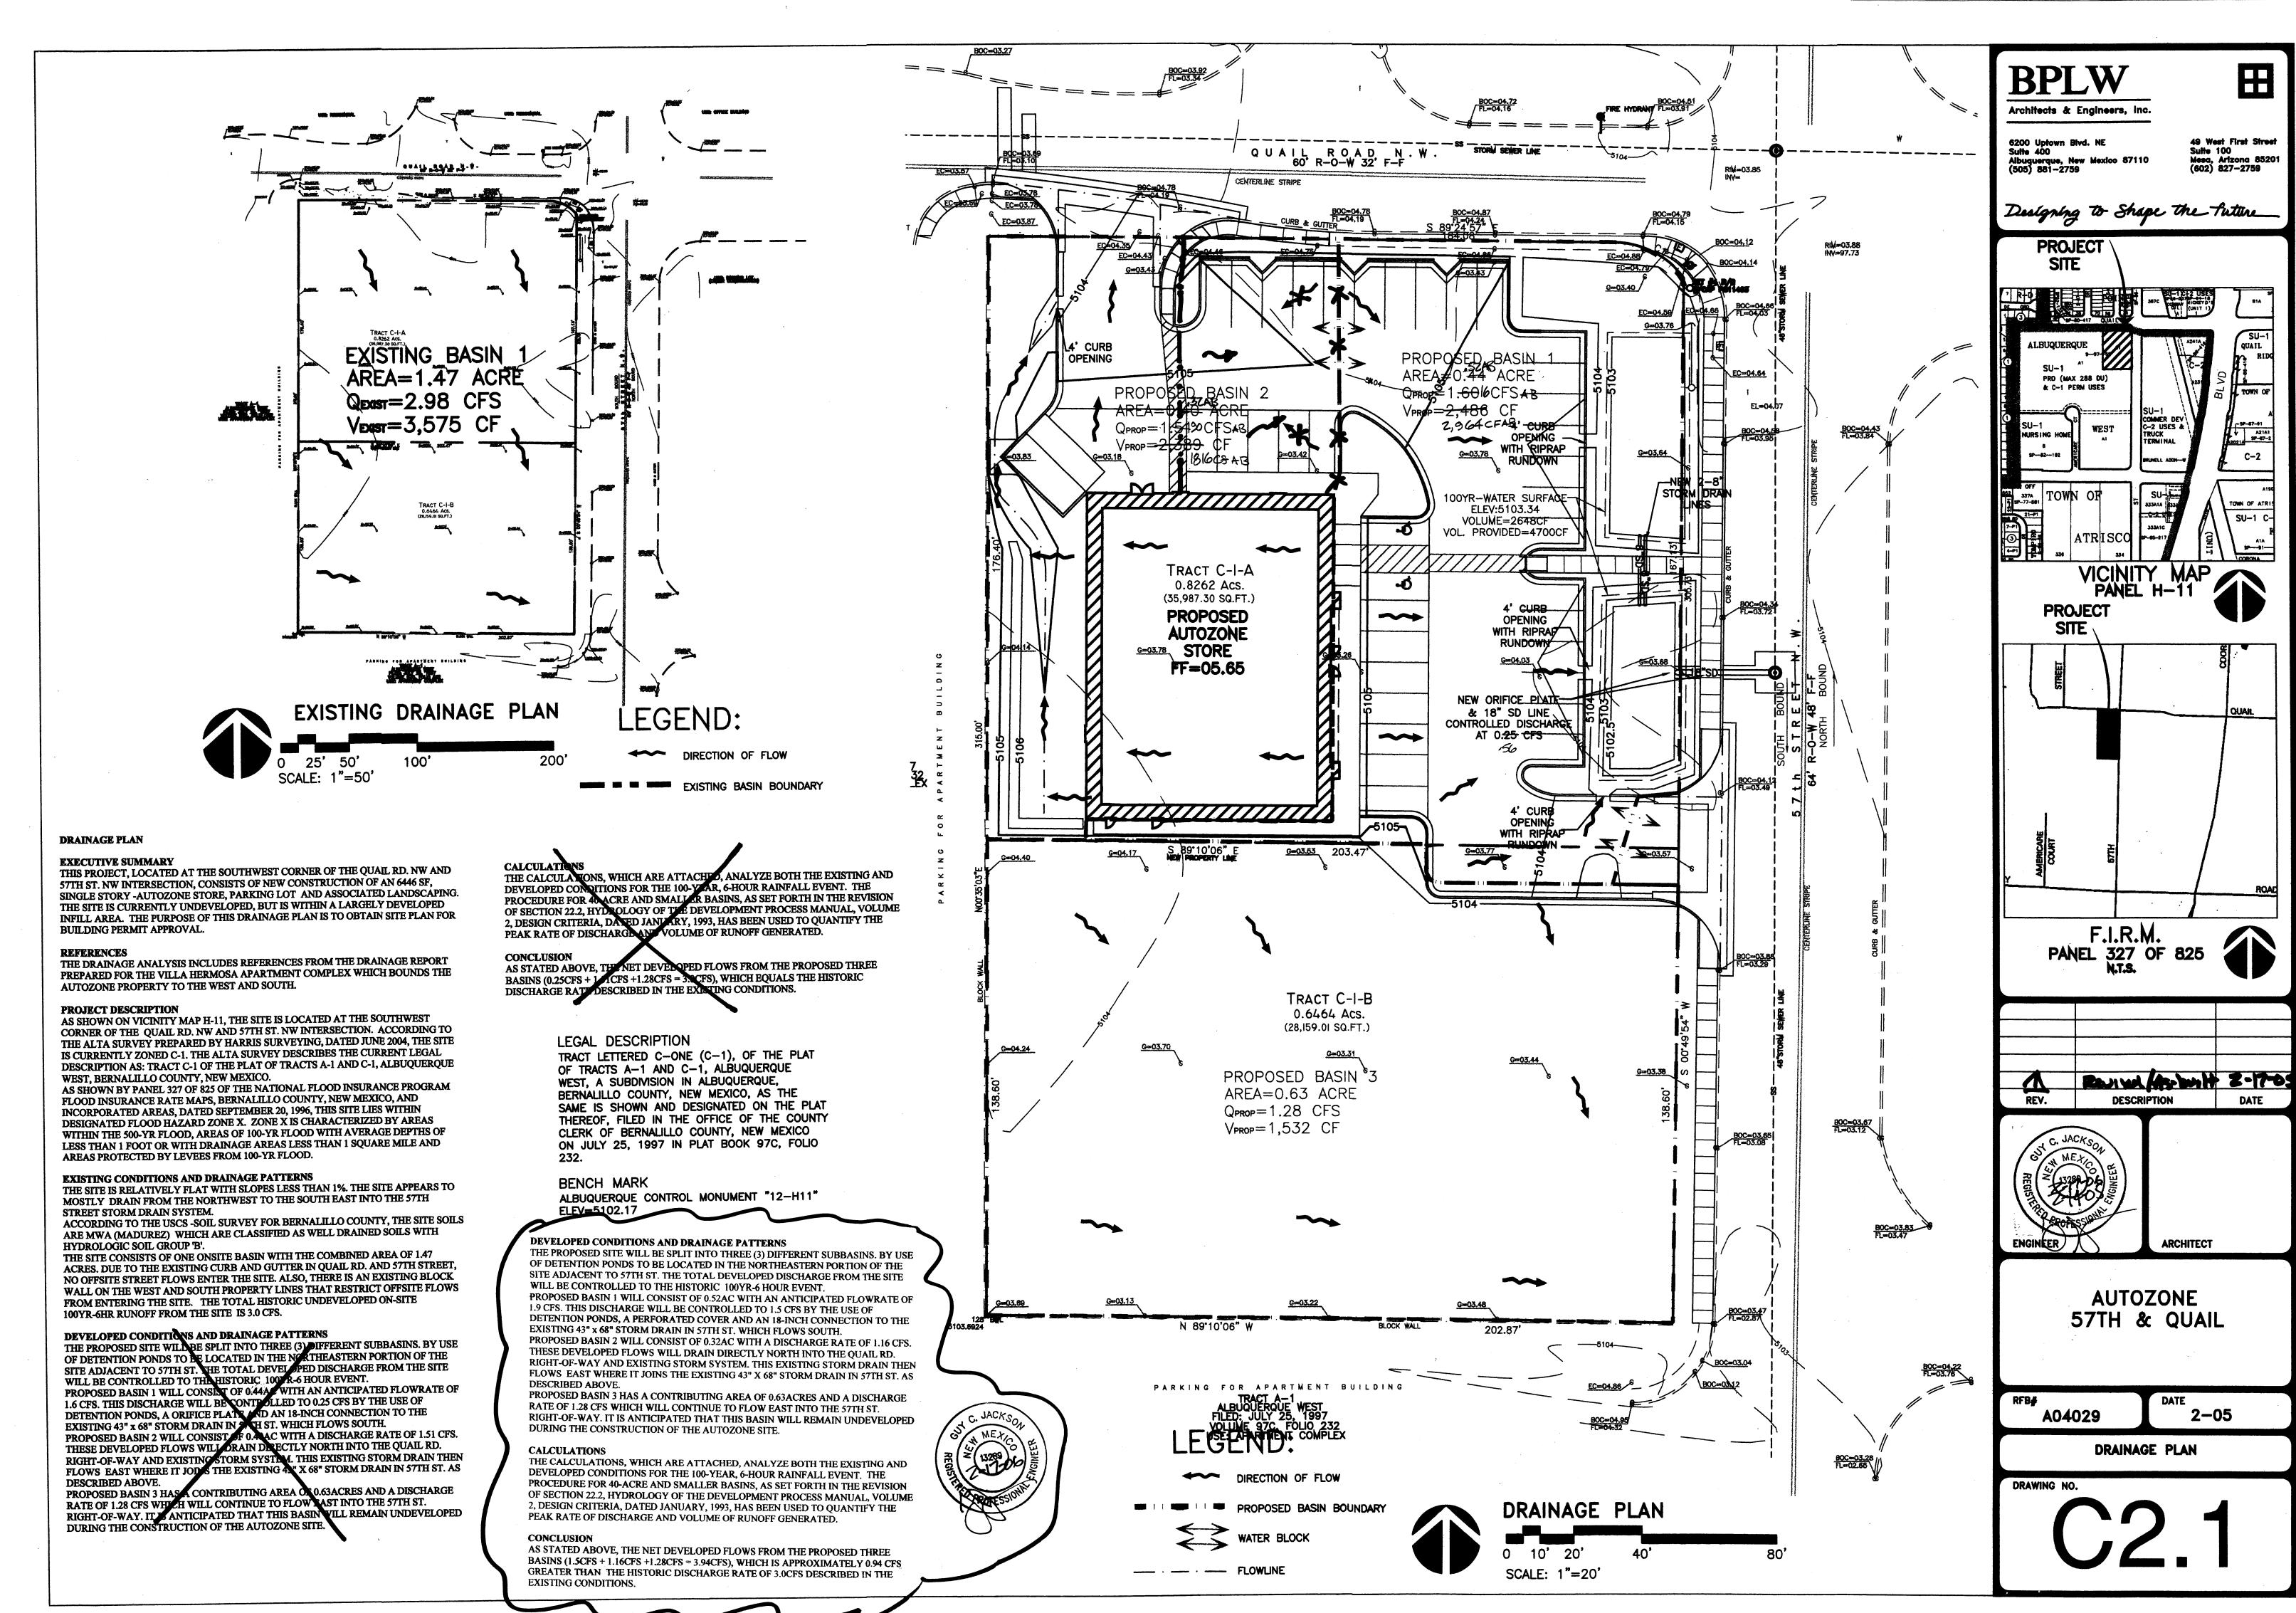

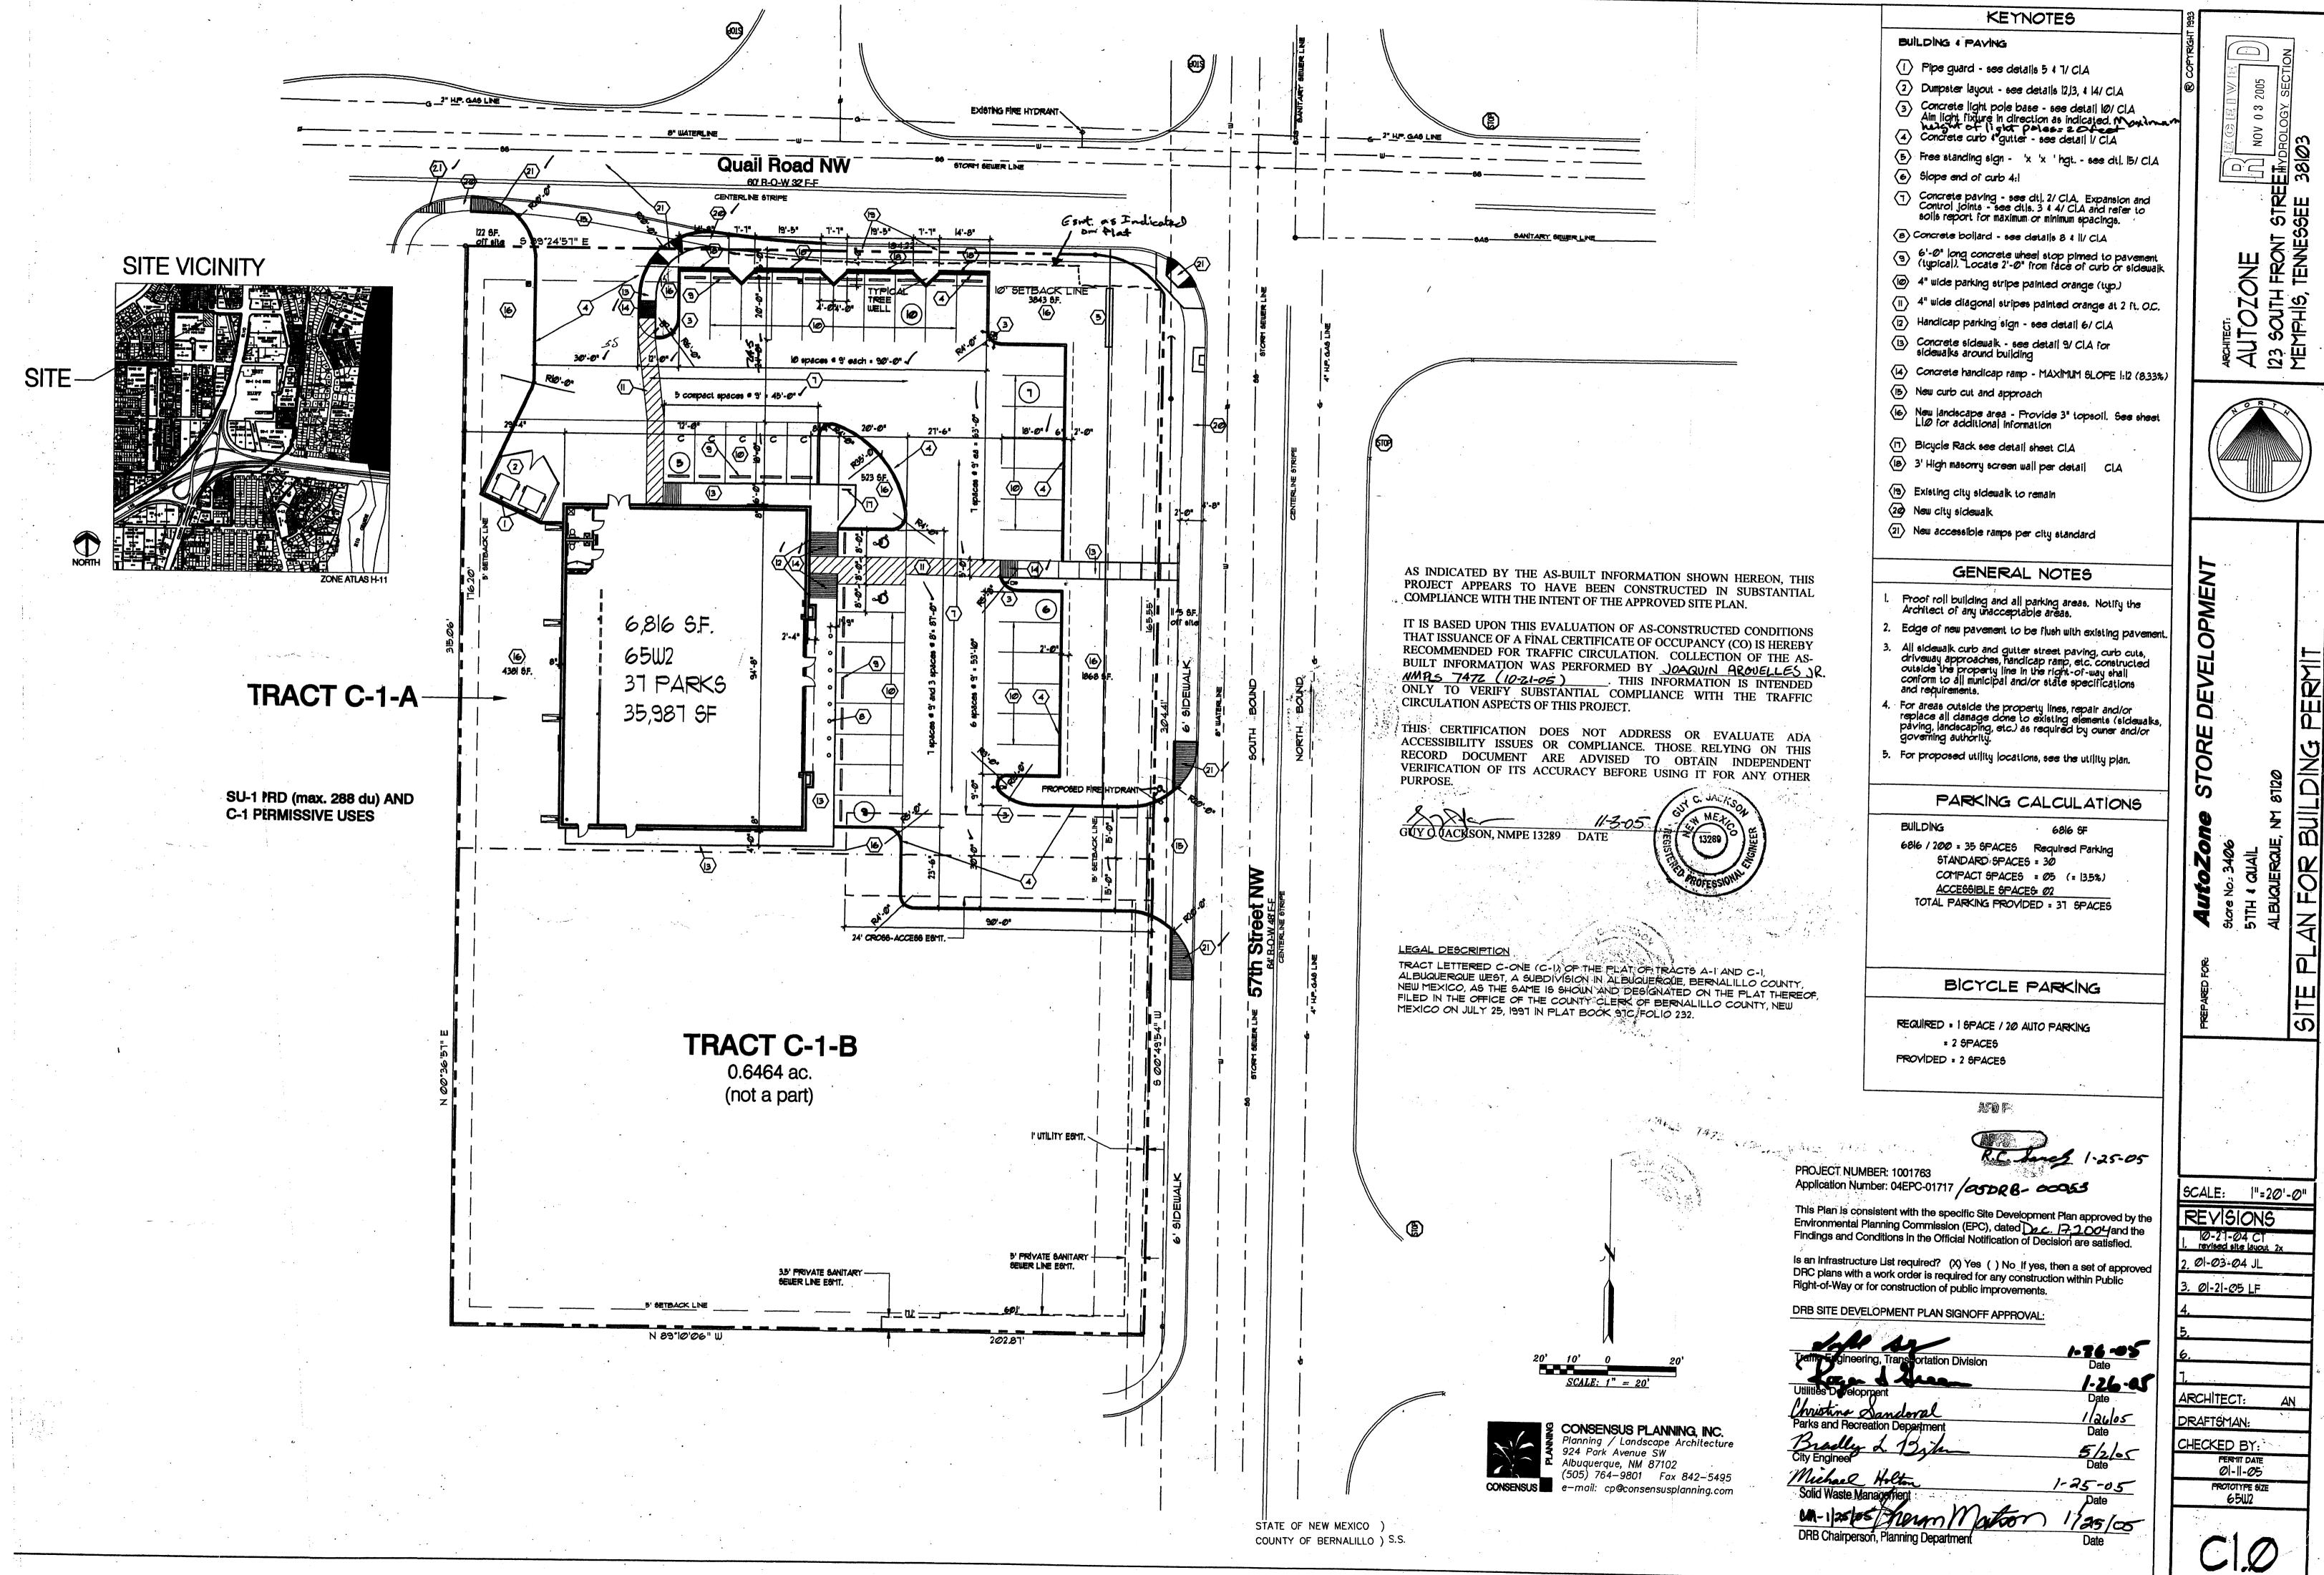

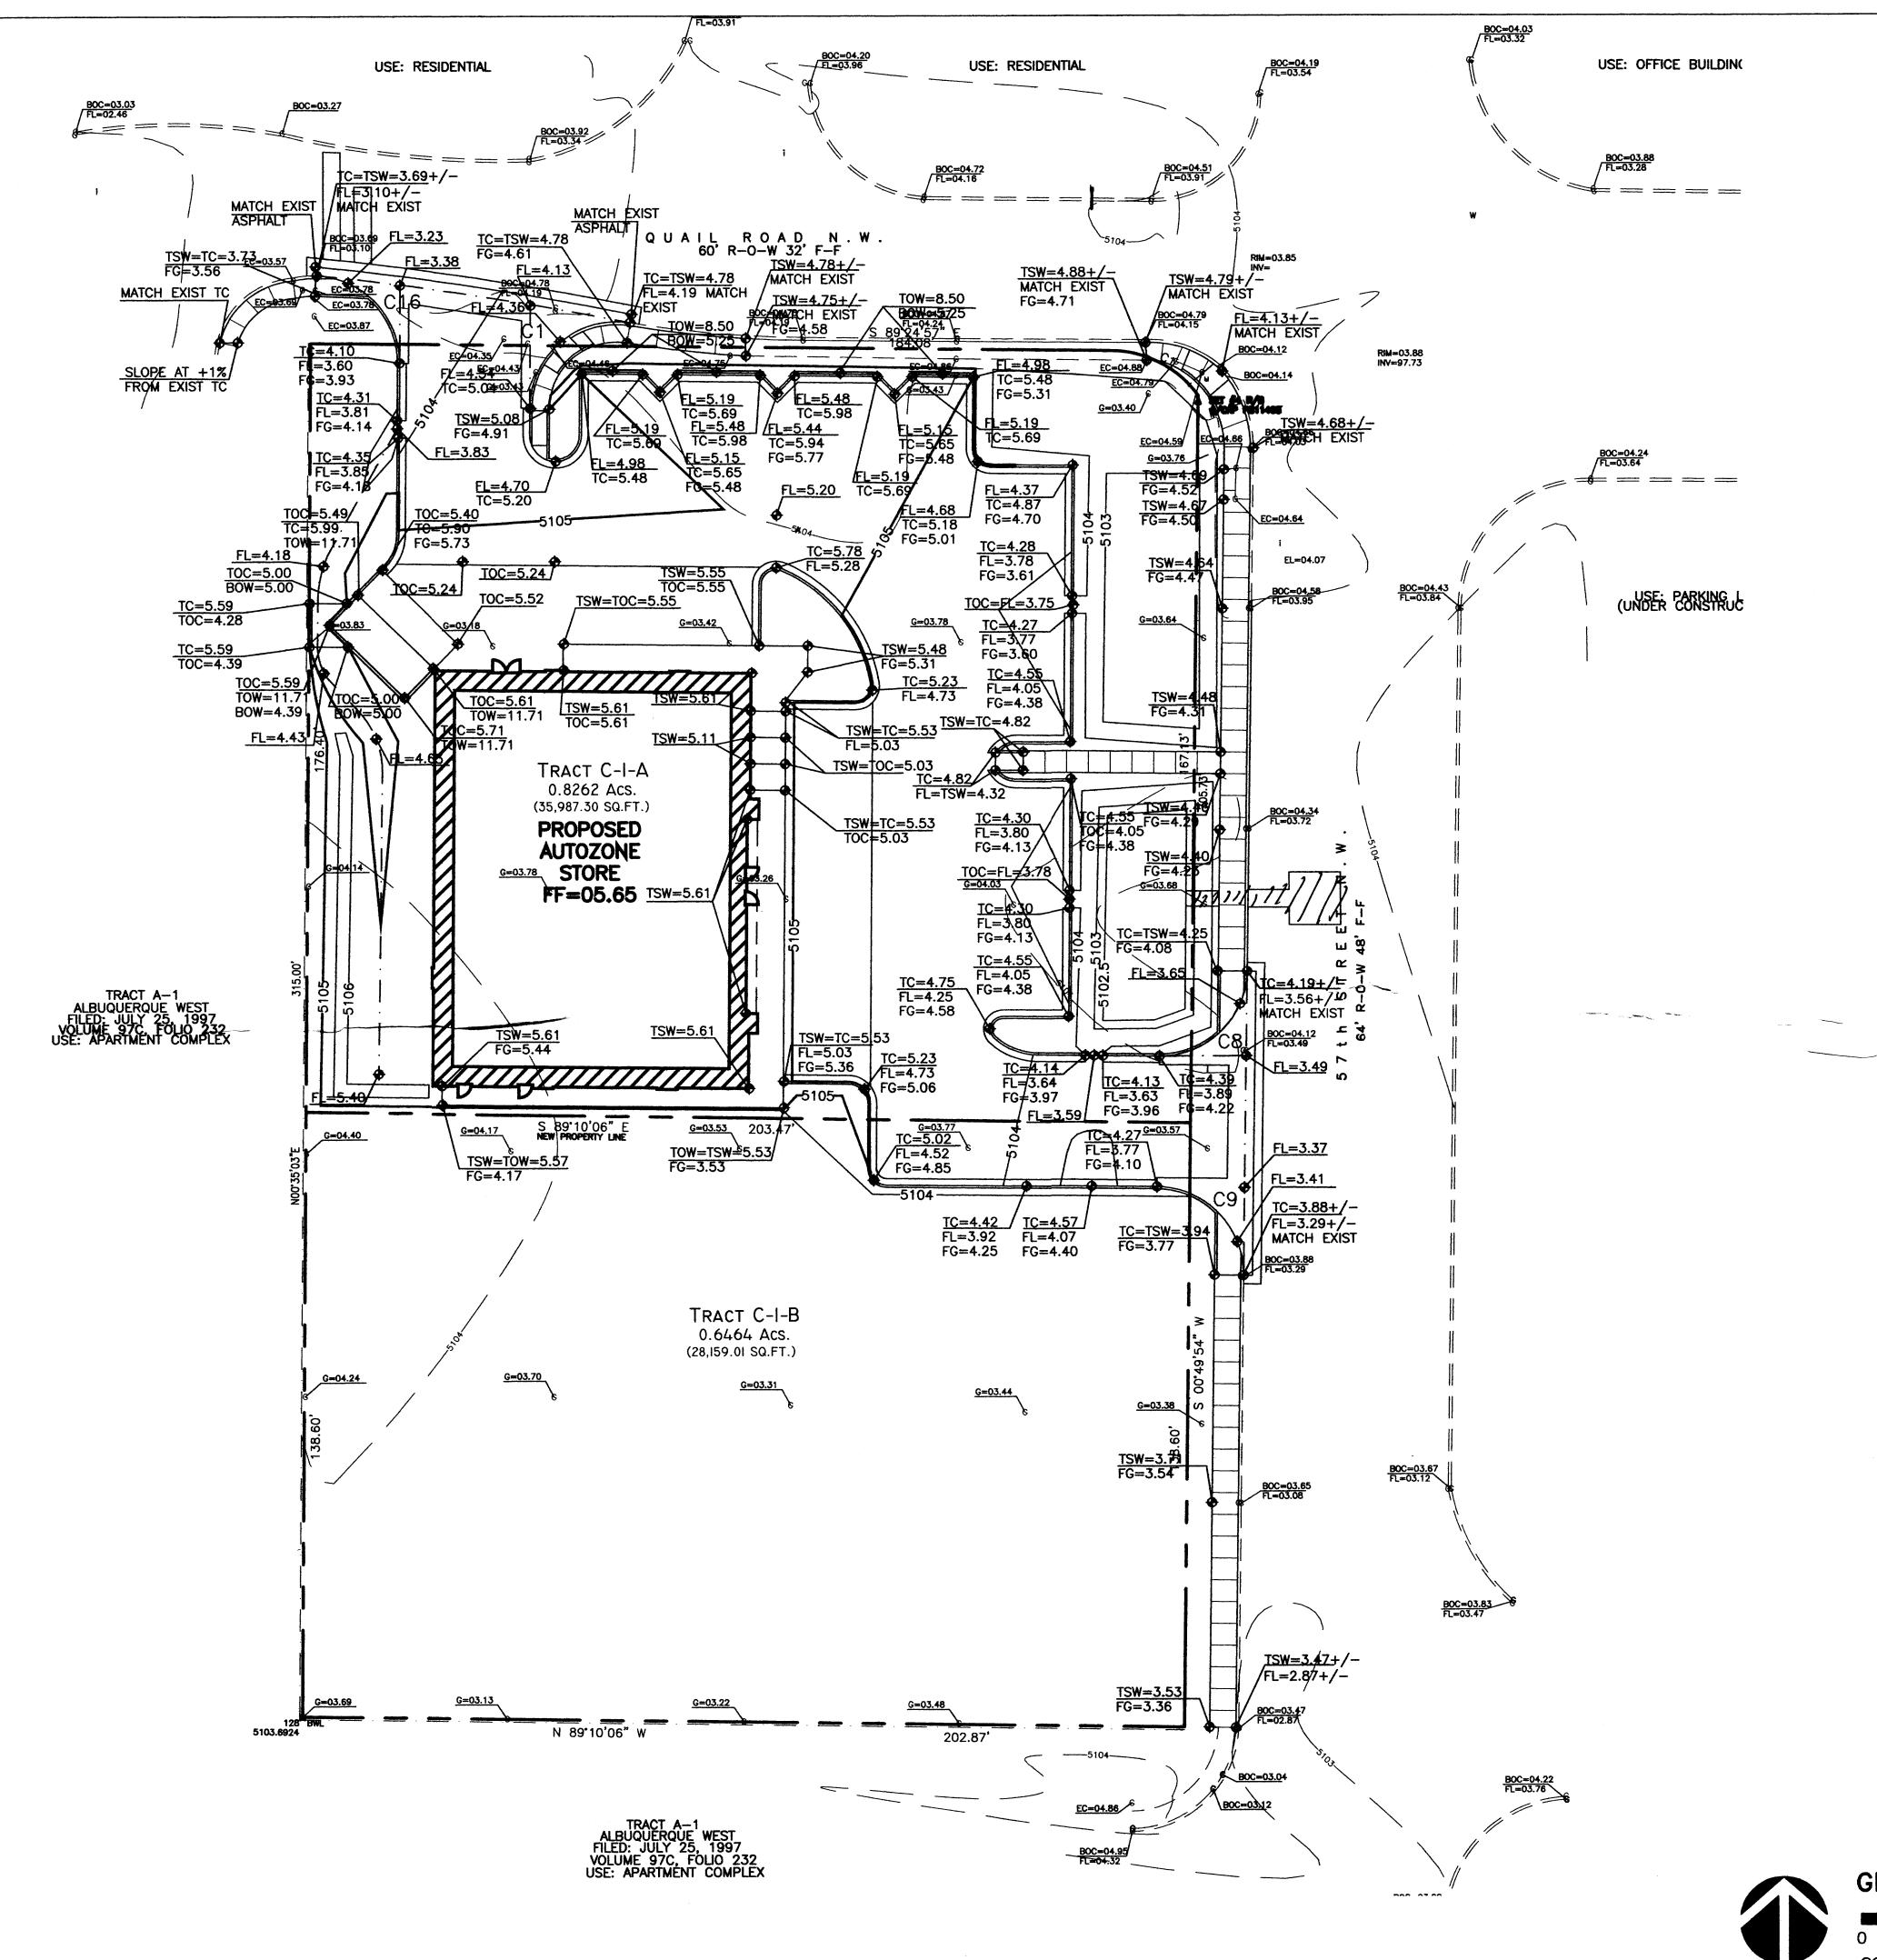

GENERAL NOTES:

- A. See sheet CG.0 for complete list of general notes and symbol/linetype legend that apply to all sheets.
- B. Surface features associated with underground utilities are shown on paving plans for clarity. See applicable utility plans for construction notes and details.
- C. Contractor shall field verify site for existing conditions (spoils, borrow areas, etc.) prior to bidding earthwork quantities.
- D. Contractor to reference Architectural specifications and soils report for recommendations on building pad earthwork, concrete and asphalt sections.

	TC	FL			TC	FL
1	4.95	4.45		1	3.65	3.65
2	4.36	4.36		2	4.23	3.73
3	4.95	4.28		3	4.31	3.81
C16				C9		
	TC	FL			TC	FL
1	3.23	3.23		1	4.15	3.65
2	3.86	3.36		2	4.03	3.53
3	3.98	3.48]	3	3.41	3.41

REFER TO SHEET C2.2 FOR CURVE & LINE TABLES


APPROVALS	NAME	DATE
INSPECTOR		

NOTICE TO CONTRACTORS

1. AN EXCAVATION PERMIT WILL BE REQUIRED BEFORE BEGINNING ANY WORK WITHIN CITY RIGHT-OF-WAY 2. ALL WORK DETAILED ON THESE PLANS TO BE PERFORMED, EXCEPT AS OTHERWISE STATED OR PROVIDED HEREON, SHALL BE CONSTRUCTED IN ACCORDANCE WITH CITY OF ALBUQUERQUE INTERIM STANDARD SPECIFICATIONS FOR PUBLIC WORKS CONSTRUCTION, 1985. UPDATE 7

3. TWO WORKING DAYS PRIOR TO ANY EXCAVATION, CONTRACTOR MUST CONTACT LINE LOCATING SERVICE 765—1234, FOR LOCATION OF EXISTING UTILITIES.
4. PRIOR TO CONSTRUCTION, THE CONTRACTOR SHALL EXCAVATE AND VERIFY THE HORIZONTAL AND VERTICAL LOCATIONS OF ALL CONSTRUCTIONS. SHOULD A CONFLICT EXIST, THE CONTRACTOR SHALL NOTIFY THE ENGINEER SO THAT THE CONFLICT CAN BE RESOLVED WITH A MINIMUM AMOUNT OF DELAY.
5. BACKFILL COMPACTION SHALL BE ACCORDING TO COLLECTOR STREET CLASSIFICATION USE.
6. MAINTENANCE OF THESE FACILITIES SHALL BE THE RESPONSIBILITY OF THE OWNER OF THE PROPERTY


7. WORK ON ARTERIAL STREETS SHALL BE PERFORMED ON A 24-HOUR BASIS.

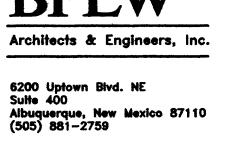

49 West First Street Suite 100 Mesa, Arizona 85201 (602) 827-2759

H


Designing to Shape the future

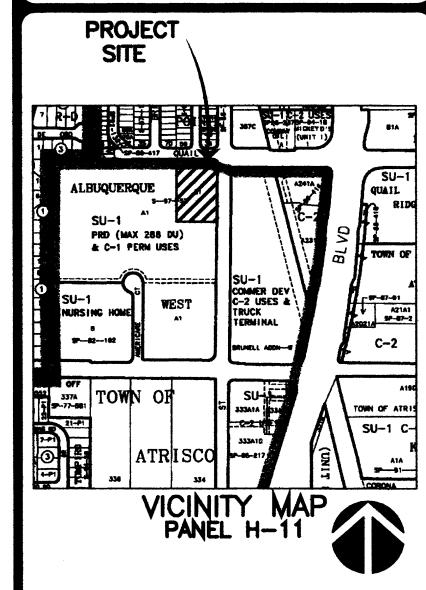

LEGAL DESCRIPTION

TRACT LETTERED C-ONE (C-1), OF THE PLAT
OF TRACTS A-1 AND C-1, ALBUQUERQUE
WEST, A SUBDIVISION IN ALBUQUERQUE,
BERNALILLO COUNTY, NEW MEXICO, AS THE
SAME IS SHOWN AND DESIGNATED ON THE PLAT
THEREOF, FILED IN THE OFFICE OF THE COUNTY
CLERK OF BERNALILLO COUNTY, NEW MEXICO
ON JULY 25, 1997 IN PLAT BOOK 97C, FOLIO
232.

BENCH MARK
ALBUQUERQUE CONTROL MONUMENT "12-H11"
ELEV=5102.17

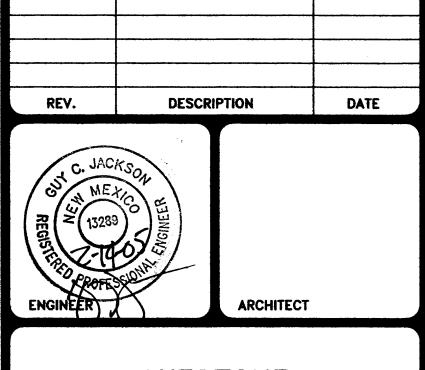

AUTOZONE 57TH & QUAIL


RFB# A04029

2-05

GRADING PLAN

DRAWING NO.

C2.0

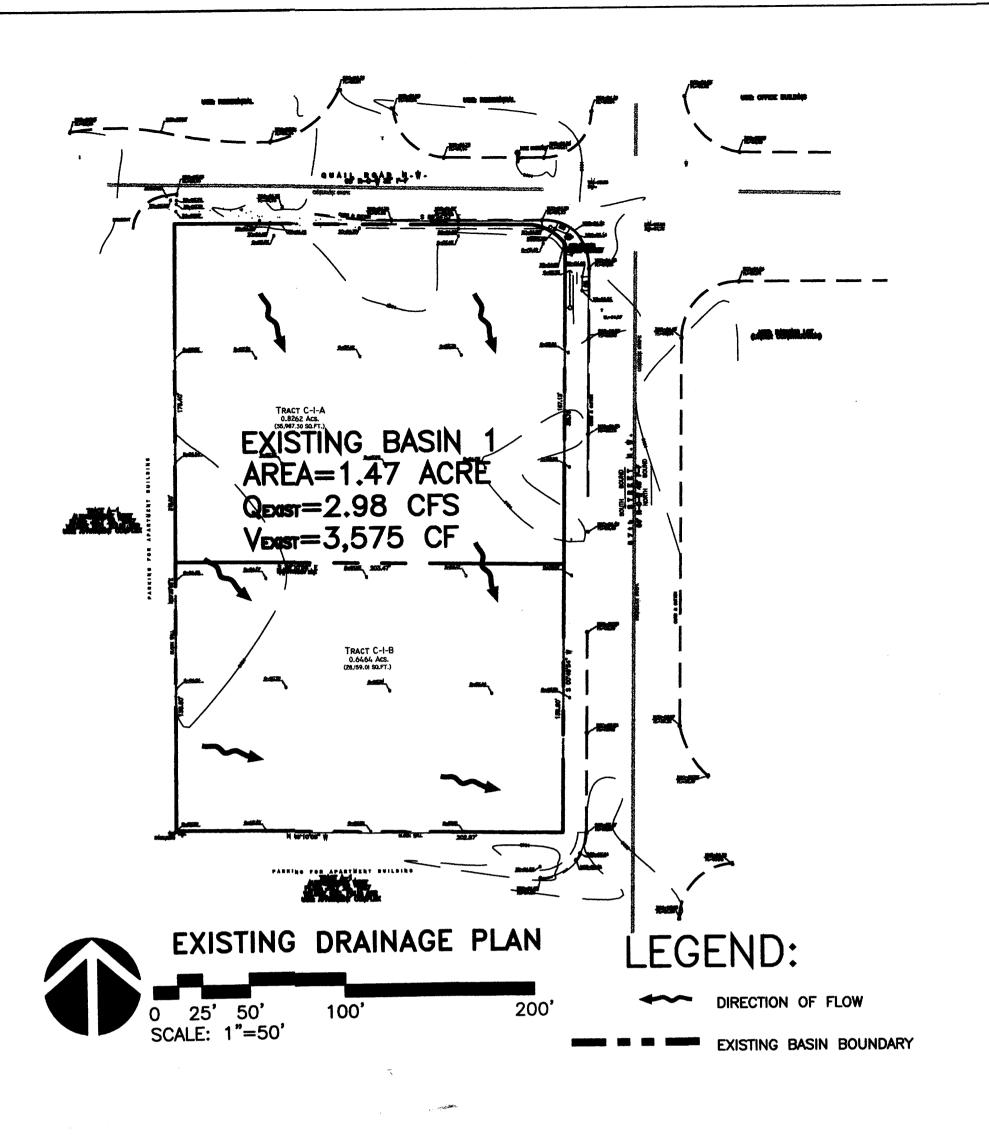

DRAINAGE PLAN

EXECUTIVE SUMMARY

THIS PROJECT, LOCATED AT THE SOUTHWEST CORNER OF THE QUAIL RD. NW AND 57TH ST. NW INTERSECTION, CONSISTS OF NEW CONSTRUCTION OF AN 6446 SF, SINGLE STORY -AUTOZONE STORE, PARKING LOT AND ASSOCIATED LANDSCAPING. THE SITE IS CURRENTLY UNDEVELOPED, BUT IS WITHIN A LARGELY DEVELOPED INFILL AREA. THE PURPOSE OF THIS DRAINAGE PLAN IS TO OBTAIN SITE PLAN FOR BUILDING PERMIT APPROVAL.

REFERENCES

THE DRAINAGE ANALYSIS INCLUDES REFERENCES FROM THE DRAINAGE REPORT PREPARED FOR THE VILLA HERMOSA APARTMENT COMPLEX WHICH BOUNDS THE AUTOZONE PROPERTY TO THE WEST AND SOUTH.

PROJECT DESCRIPTION

AS SHOWN ON VICINITY MAP H-11, THE SITE IS LOCATED AT THE SOUTHWEST CORNER OF THE QUAIL RD. NW AND 57TH ST. NW INTERSECTION. ACCORDING TO THE ALTA SURVEY PREPARED BY HARRIS SURVEYING, DATED JUNE 2004, THE SITE IS CURRENTLY ZONED C-1. THE ALTA SURVEY DESCRIBES THE CURRENT LEGAL DESCRIPTION AS: TRACT C-1 OF THE PLAT OF TRACTS A-1 AND C-1, ALBUQUERQUE

WEST, BERNALILLO COUNTY, NEW MEXICO. AS SHOWN BY PANEL 327 OF 825 OF THE NATIONAL FLOOD INSURANCE PROGRAM FLOOD INSURANCE RATE MAPS, BERNALILLO COUNTY, NEW MEXICO, AND INCORPORATED AREAS, DATED SEPTEMBER 20, 1996, THIS SITE LIES WITHIN DESIGNATED FLOOD HAZARD ZONE X. ZONE X IS CHARACTERIZED BY AREAS WITHIN THE 500-YR FLOOD, AREAS OF 100-YR FLOOD WITH AVERAGE DEPTHS OF LESS THAN 1 FOOT OR WITH DRAINAGE AREAS LESS THAN 1 SQUARE MILE AND AREAS PROTECTED BY LEVEES FROM 100-YR FLOOD.

EXISTING CONDITIONS AND DRAINAGE PATTERNS

THE SITE IS RELATIVELY FLAT WITH SLOPES LESS THAN 1%. THE SITE APPEARS TO MOSTLY DRAIN FROM THE NORTHWEST TO THE SOUTH EAST INTO THE 57TH STREET STORM DRAIN SYSTEM.

ACCORDING TO THE USCS -SOIL SURVEY FOR BERNALILLO COUNTY, THE SITE SOILS ARE MWA (MADUREZ) WHICH ARE CLASSIFIED AS WELL DRAINED SOILS WITH HYDROLOGIC SOIL GROUP 'B'.

THE SITE CONSISTS OF ONE ONSITE BASIN WITH THE COMBINED AREA OF 1.47 ACRES. DUE TO THE EXISTING CURB AND GUTTER IN QUAIL RD. AND 57TH STREET, NO OFFSITE STREET FLOWS ENTER THE SITE. ALSO, THERE IS AN EXISTING BLOCK WALL ON THE WEST AND SOUTH PROPERTY LINES THAT RESTRICT OFFSITE FLOWS
FROM ENTERING THE SITE. THE TOTAL HISTORIC UNDEVELOPED ON-SITE 100YR-6HR RUNOFF FROM THE SITE IS 3.0 CFS.

DEVELOPED CONDITIONS AND DRAINAGE PATTERNS

THE PROPOSED SITE WILL BE SPLIT INTO THREE (3) DIFFERENT SUBBASINS. BY USE OF DETENTION PONDS TO BE LOCATED IN THE NORTHEASTERN PORTION OF THE SITE ADJACENT TO 57TH ST. THE TOTAL DEVELOPED DISCHARGE FROM THE SITE WILL BE CONTROLLED TO THE HISTORIC 100YR-6 HOUR EVENT. PROPOSED BASIN 1 WILL CONSIST OF 0.44AC WITH AN ANTICIPATED FLOWRATE OF

1.6 CFS. THIS DISCHARGE WILL BE CONTROLLED TO 0.25 CFS BY THE USE OF DETENTION PONDS, A ORIFICE PLATE AND AN 18-INCH CONNECTION TO THE EXISTING 43" x 68" STORM DRAIN IN 57TH ST. WHICH FLOWS SOUTH. PROPOSED BASIN 2 WILL CONSIST OF 0.40AC WITH A DISCHARGE RATE OF 1.51 CFS. THESE DEVELOPED FLOWS WILL DRAIN DIRECTLY NORTH INTO THE QUAIL RD. RIGHT-OF-WAY AND EXISTING STORM SYSTEM. THIS EXISTING STORM DRAIN THEN FLOWS EAST WHERE IT JOINS THE EXISTING 43" X 68" STORM DRAIN IN 57TH ST. AS

DESCRIBED ABOVE. PROPOSED BASIN 3 HAS A CONTRIBUTING AREA OF 0.63ACRES AND A DISCHARGE RATE OF 1.28 CFS WHICH WILL CONTINUE TO FLOW EAST INTO THE 57TH ST. RIGHT-OF-WAY. IT IS ANTICIPATED THAT THIS BASIN WILL REMAIN UNDEVELOPED DURING THE CONSTRUCTION OF THE AUTOZONE SITE.

CALCULATIONS THE CALCULATIONS, WHICH ARE ATTACHED, ANALYZE BOTH THE EXISTING AND DEVELOPED CONDITIONS FOR THE 100-YEAR, 6-HOUR RAINFALL EVENT. THE PROCEDURE FOR 40-ACRE AND SMALLER BASINS, AS SET FORTH IN THE REVISION OF SECTION 22.2, HYDROLOGY OF THE DEVELOPMENT PROCESS MANUAL, VOLUME 2. DESIGN CRITERIA, DATED JANUARY, 1993, HAS BEEN USED TO QUANTIFY THE PEAK RATE OF DISCHARGE AND VOLUME OF RUNOFF GENERATED.


AS STATED ABOVE, THE NET DEVELOPED FLOWS FROM THE PROPOSED THREE BASINS (0.25CFS + 1.51CFS +1.28CFS = 3.0CFS), WHICH EQUALS THE HISTORIC DISCHARGE RATE DESCRIBED IN THE EXISTING CONDITIONS.

LEGAL DESCRIPTION

TRACT LETTERED C-ONE (C-1), OF THE PLAT OF TRACTS A-1 AND C-1, ALBUQUERQUE WEST, A SUBDIVISION IN ALBUQUERQUE, BERNALILLO COUNTY, NEW MEXICO, AS THE SAME IS SHOWN AND DESIGNATED ON THE PLAT THEREOF, FILED IN THE OFFICE OF THE COUNTY CLERK OF BERNALILLO COUNTY, NEW MEXICO ON JULY 25, 1997 IN PLAT BOOK 97C, FOLIO

BENCH MARK

ALBUQUERQUE CONTROL MONUMENT "12-H11" ELEV=5102.17

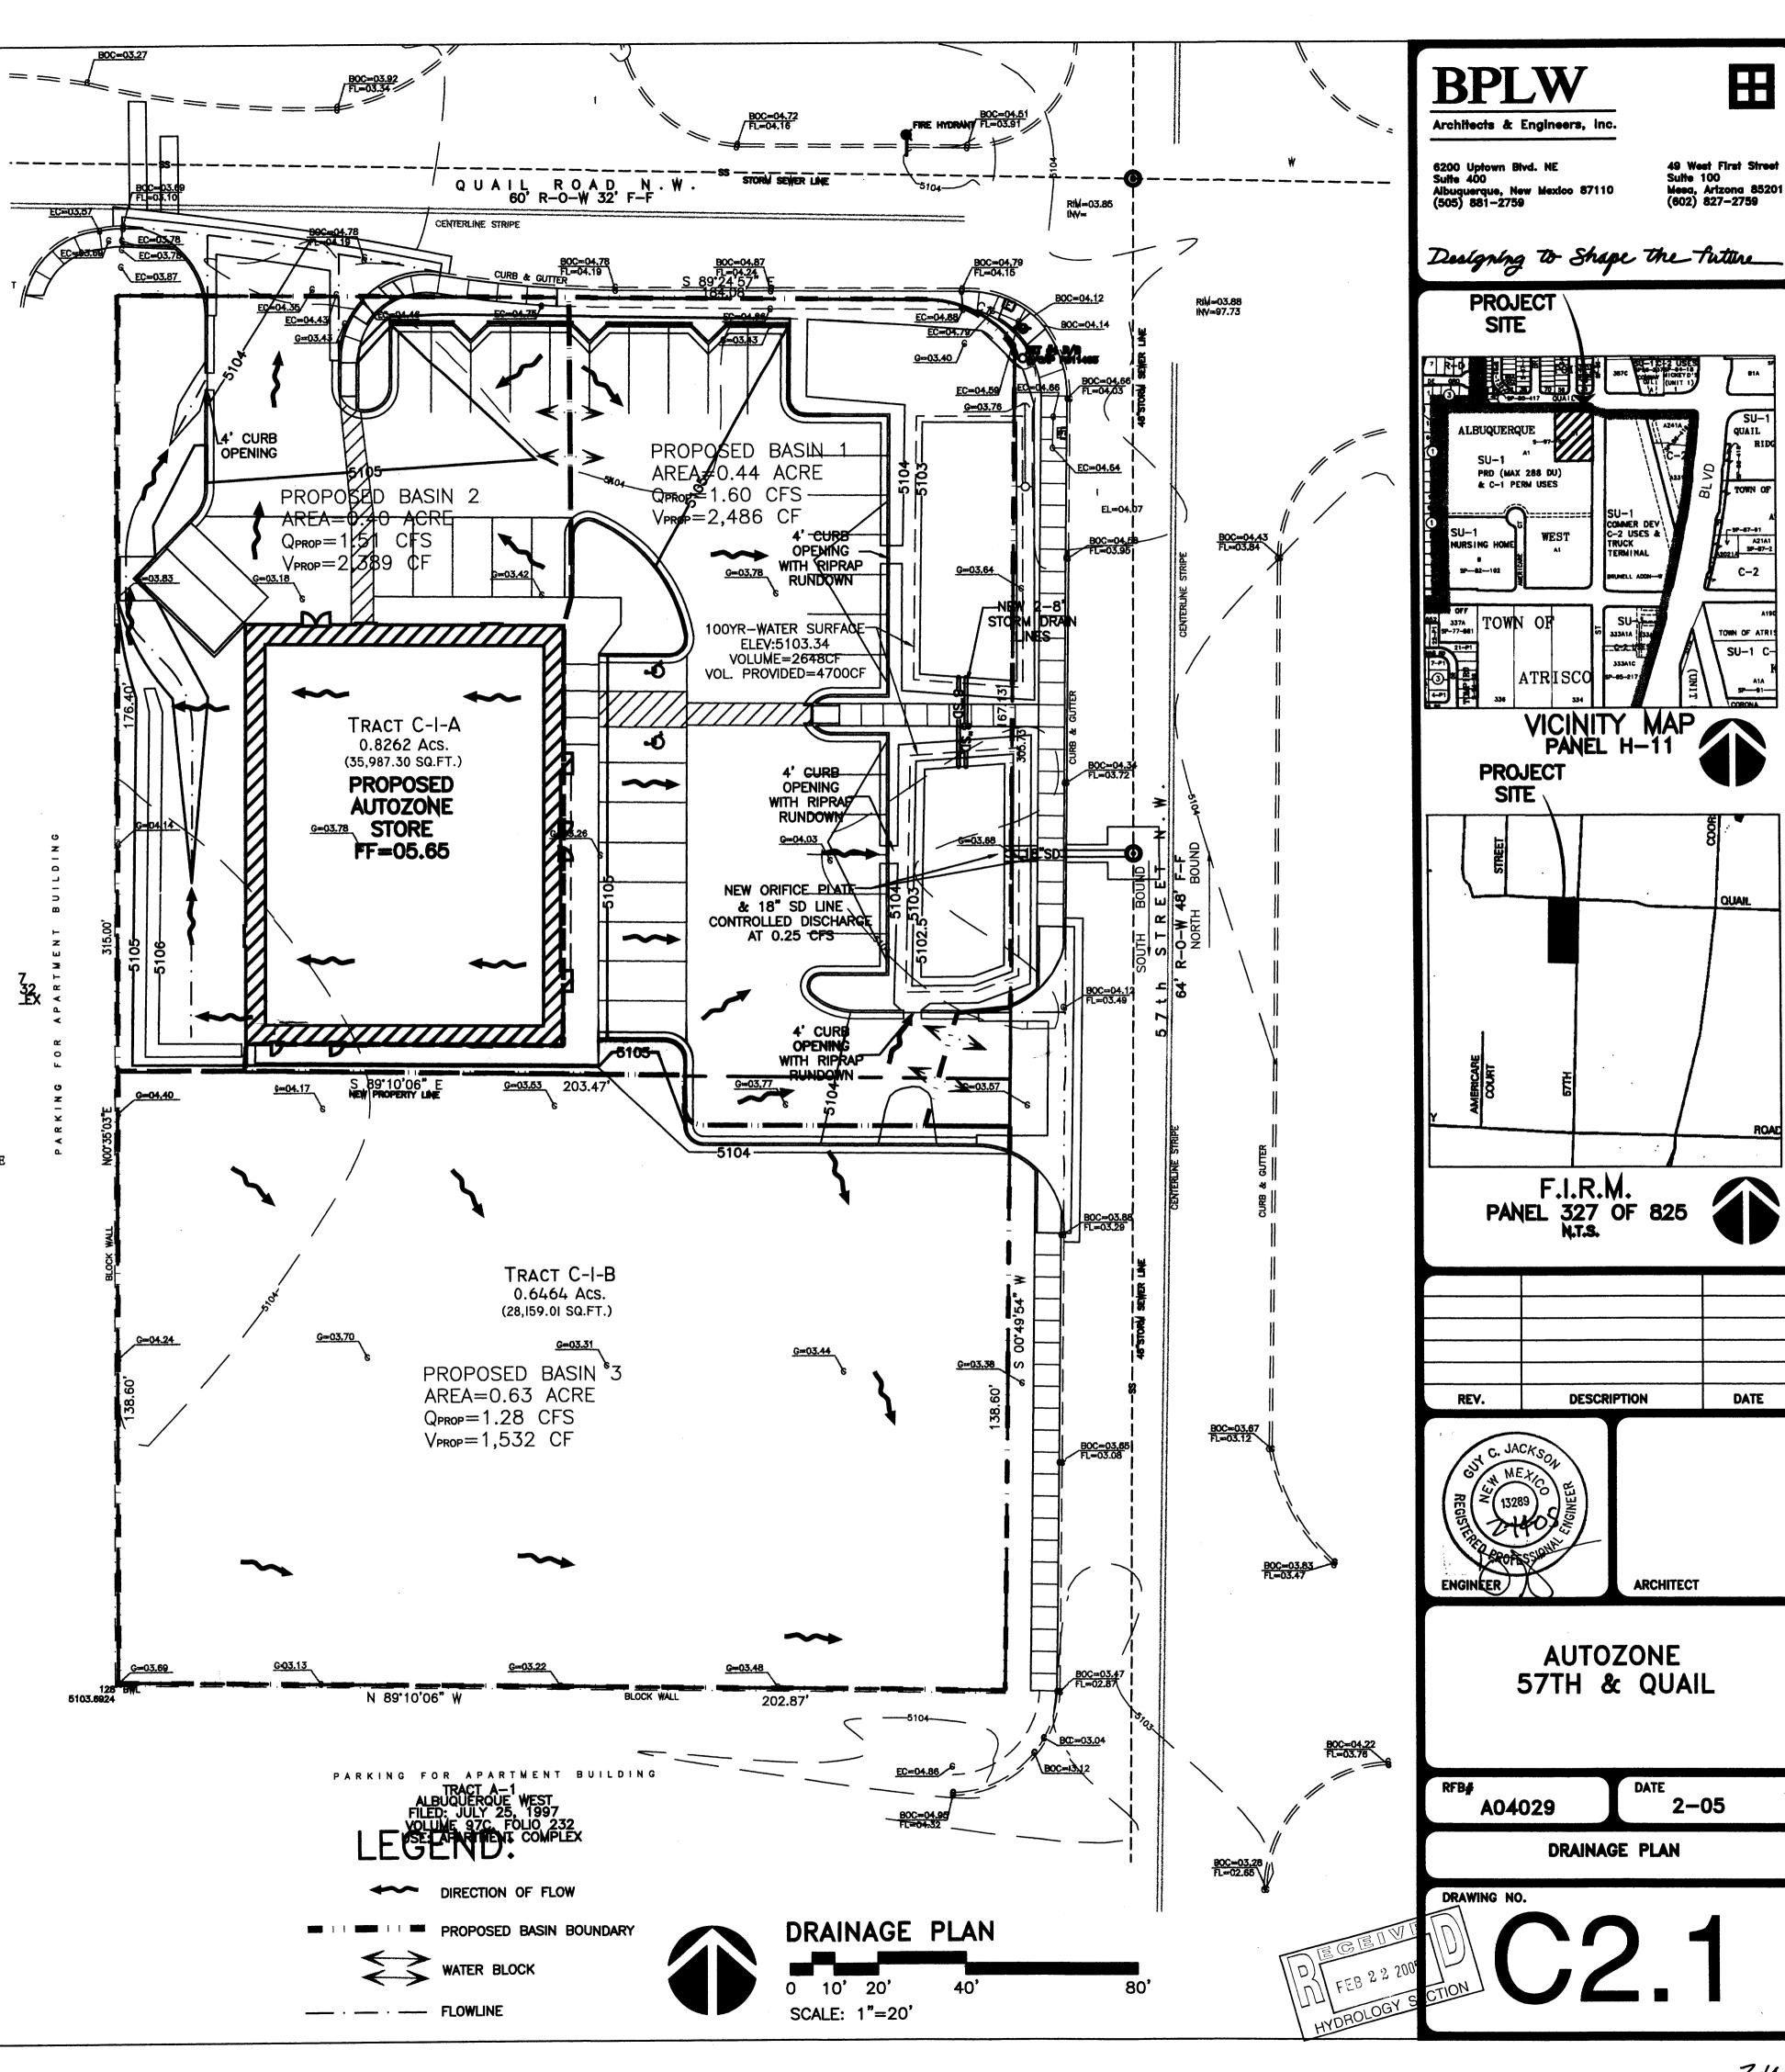


2-05

DATE

田

49 West First Street Suite 100 Mesa, Arizona 85201 (602) 827—2759

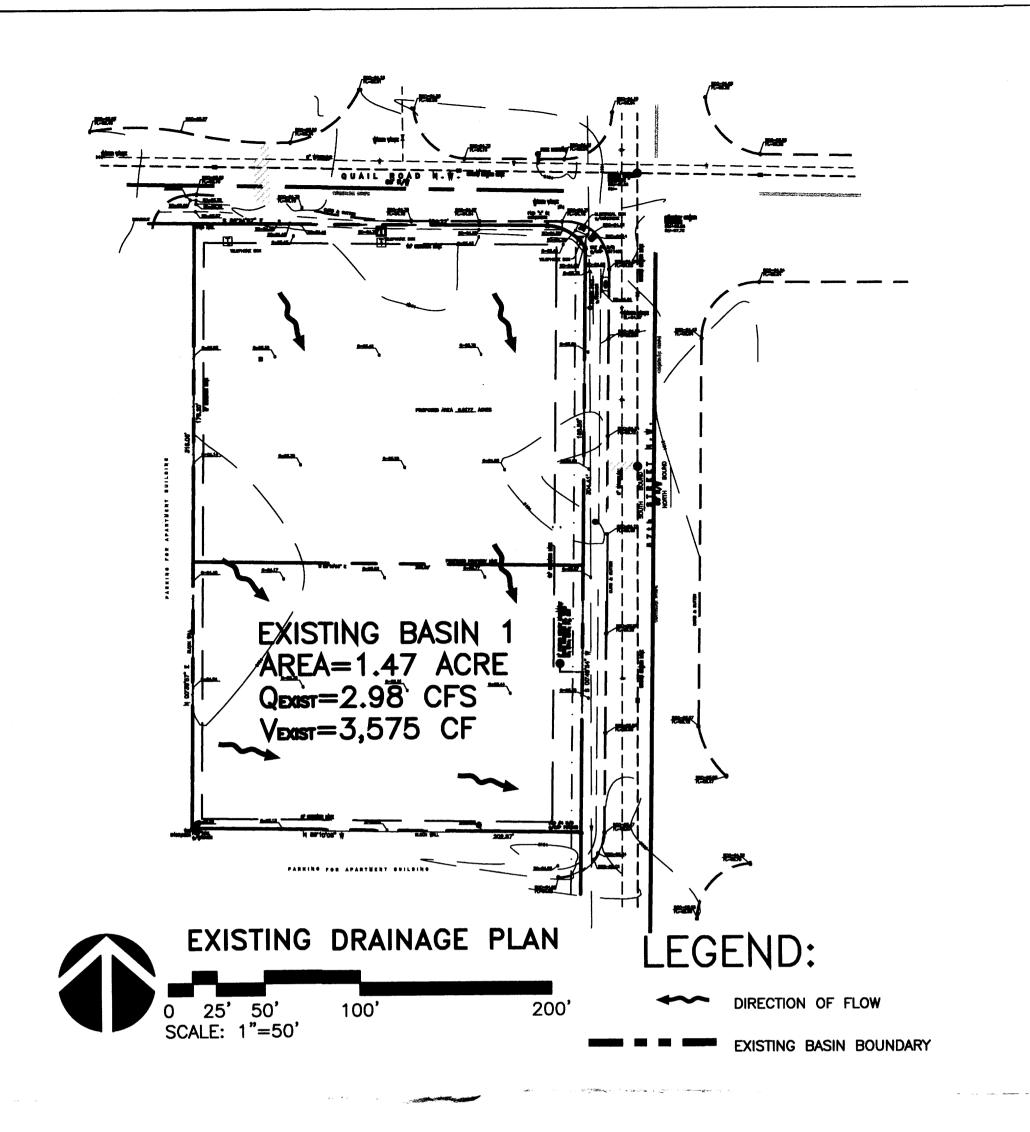

DRAINAGE PLAN

EXECUTIVE SUMMARY

THIS PROJECT, LOCATED AT THE SOUTHWEST CORNER OF THE QUAIL RD. NW AND 57TH ST. NW INTERSECTION, CONSISTS OF NEW CONSTRUCTION OF AN 6446 SF. SINGLE STORY -AUTOZONE STORE, PARKING LOT AND ASSOCIATED LANDSCAPING. THE SITE IS CURRENTLY UNDEVELOPED, BUT IS WITHIN A LARGELY DEVELOPED INFILL AREA. THE PURPOSE OF THIS DRAINAGE PLAN IS TO OBTAIN SITE PLAN FOR BUILDING PERMIT APPROVAL.

THE DRAINAGE ANALYSIS INCLUDES REFERENCES FROM THE DRAINAGE REPORT PREPARED FOR THE VILLA HERMOSA APARTMENT COMPLEX WHICH BOUNDS THE AUTOZONE PROPERTY TO THE WEST AND SOUTH.

AS SHOWN ON VICINITY MAP H-11, THE SITE IS LOCATED AT THE SOUTHWEST CORNER OF THE QUAIL RD. NW AND 57TH ST. NW INTERSECTION. ACCORDING TO THE ALTA SURVEY PREPARED BY HARRIS SURVEYING, DATED JUNE 2004, THE SITE IS CURRENTLY ZONED C-1. THE ALTA SURVEY DESCRIBES THE CURRENT LEGAL DESCRIPTION AS: TRACT C-1 OF THE PLAT OF TRACTS A-1 AND C-1, ALBUQUERQUE

WEST, BERNALILLO COUNTY, NEW MEXICO. AS SHOWN BY PANEL 327 OF 825 OF THE NATIONAL FLOOD INSURANCE PROGRAM FLOOD INSURANCE RATE MAPS, BERNALILLO COUNTY, NEW MEXICO, AND INCORPORATED AREAS, DATED SEPTEMBER 20, 1996, THIS SITE LIES WITHIN DESIGNATED FLOOD HAZARD ZONE X. ZONE X IS CHARACTERIZED BY AREAS WITHIN THE 500-YR FLOOD, AREAS OF 100-YR FLOOD WITH AVERAGE DEPTHS OF LESS THAN 1 FOOT OR WITH DRAINAGE AREAS LESS THAN 1 SQUARE MILE AND AREAS PROTECTED BY LEVEES FROM 100-YR FLOOD.

EXISTING CONDITIONS AND DRAINAGE PATTERNS THE SITE IS RELATIVELY FLAT WITH SLOPES LESS THAN 1%. THE SITE APPEARS TO MOSTLY DRAIN FROM THE NORTHWEST TO THE SOUTH EAST INTO THE 57TH

STREET STORM DRAIN SYSTEM. ACCORDING TO THE USCS -SOIL SURVEY FOR BERNALILLO COUNTY, THE SITE SOILS ARE MWA (MADUREZ) WHICH ARE CLASSIFIED AS WELL DRAINED SOILS WITH HYDROLOGIC SOIL GROUP 'B'.

THE SITE CONSISTS OF ONE ONSITE BASIN WITH THE COMBINED AREA OF 1.47 ACRES. DUE TO THE EXISTING CURB AND GUTTER IN QUAIL RD. AND 57TH STREET, NO OFFSITE STREET FLOWS ENTER THE SITE. ALSO, THERE IS AN EXISTING BLOCK WALL ON THE WEST AND SOUTH PROPERTY LINES THAT RESTRICT OFFSITE FLOWS FROM ENTERING THE SITE. THE TOTAL HISTORIC UNDEVELOPED ON-SITE 100YR-6HR RUNOFF FROM THE SITE IS 3.0 CFS.

DEVELOPED CONDITIONS AND DRAINAGE PATTERNS

THE PROPOSED SITE WILL BE SPLIT INTO THREE (3) DIFFERENT SUBBASINS. BY USE OF DETENTION PONDS TO BE LOCATED IN THE NORTHEASTERN PORTION OF THE SITE ADJACENT TO 57TH ST. THE TOTAL DEVELOPED DISCHARGE FROM THE SITE WILL BE CONTROLLED TO THE HISTORIC 100YR-6 HOUR EVENT.

PROPOSED BASIN 1 WILL CONSIST OF 0.44AC WITH AN ANTICIPATED FLOWRATE OF 1.6 CFS. THIS DISCHARGE WILL BE CONTROLLED TO 0.25 CFS BY THE USE OF DETENTION PONDS, A STANDPIPE AND AN 8-INCH CONNECTION TO THE EXISTING 43" x 68" STORM DRAIN IN 57TH ST. WHICH FLOWS SOUTH.

PROPOSED BASIN 2 WILL CONSIST OF 0.40AC WITH A DISCHARGE RATE OF 1.51 CFS. THESE DEVELOPED FLOWS WILL DRAIN DIRECTLY NORTH INTO THE QUAIL RD. RIGHT-OF-WAY AND EXISTING STORM SYSTEM. THIS EXISTING STORM DRAIN THEN FLOWS EAST WHERE IT JOINS THE EXISTING 43" X 68" STORM DRAIN IN 57TH ST. AS DESCRIBED ABOVE.

PROPOSED BASIN 3 HAS A CONTRIBUTING AREA OF 0.63ACRES AND A DISCHARGE RATE OF 1.28 CFS WHICH WILL CONTINUE TO FLOW EAST INTO THE 57TH ST. RIGHT-OF-WAY. IT IS ANTICIPATED THAT THIS BASIN WILL REMAIN UNDEVELOPED DURING THE CONSTRUCTION OF THE AUTOZONE SITE.

CALCULATIONS

THE CALCULATIONS, WHICH ARE ATTACHED, ANALYZE BOTH THE EXISTING AND DEVELOPED CONDITIONS FOR THE 100-YEAR, 6-HOUR RAINFALL EVENT. THE PROCEDURE FOR 40-ACRE AND SMALLER BASINS, AS SET FORTH IN THE REVISION OF SECTION 22.2, HYDROLOGY OF THE DEVELOPMENT PROCESS MANUAL, VOLUME 2. DESIGN CRITERIA, DATED JANUARY, 1993, HAS BEEN USED TO QUANTIFY THE PEAK RATE OF DISCHARGE AND VOLUME OF RUNOFF GENERATED.

CONCLUSION


AS STATED ABOVE, THE NET DEVELOPED FLOWS FROM THE PROPOSED THREE BASINS (0.25CFS + 1.51CFS +1.28CFS = 3.0CFS), WHICH EQUALS THE HISTORIC DISCHARGE RATE DESCRIBED IN THE EXISTING CONDITIONS.


LEGAL DESCRIPTION


TRACT LETTERED C-ONE (C-1), OF THE PLAT OF TRACTS A-1 AND C-1, ALBUQUERQUE WEST, A SUBDIVISION IN ALBUQUERQUE, BERNALILLO COUNTY, NEW MEXICO, AS THE SAME IS SHOWN AND DESIGNATED ON THE PLAT THEREOF, FILED IN THE OFFICE OF THE COUNTY CLERK OF BERNALILLO COUNTY, NEW MEXICO ON JULY 25, 1997 IN PLAT BOOK 97C, FOLIO

BENCH MARK

ALBUQUERQUE CONTROL MONUMENT "12-H11" ELEV=5102.17

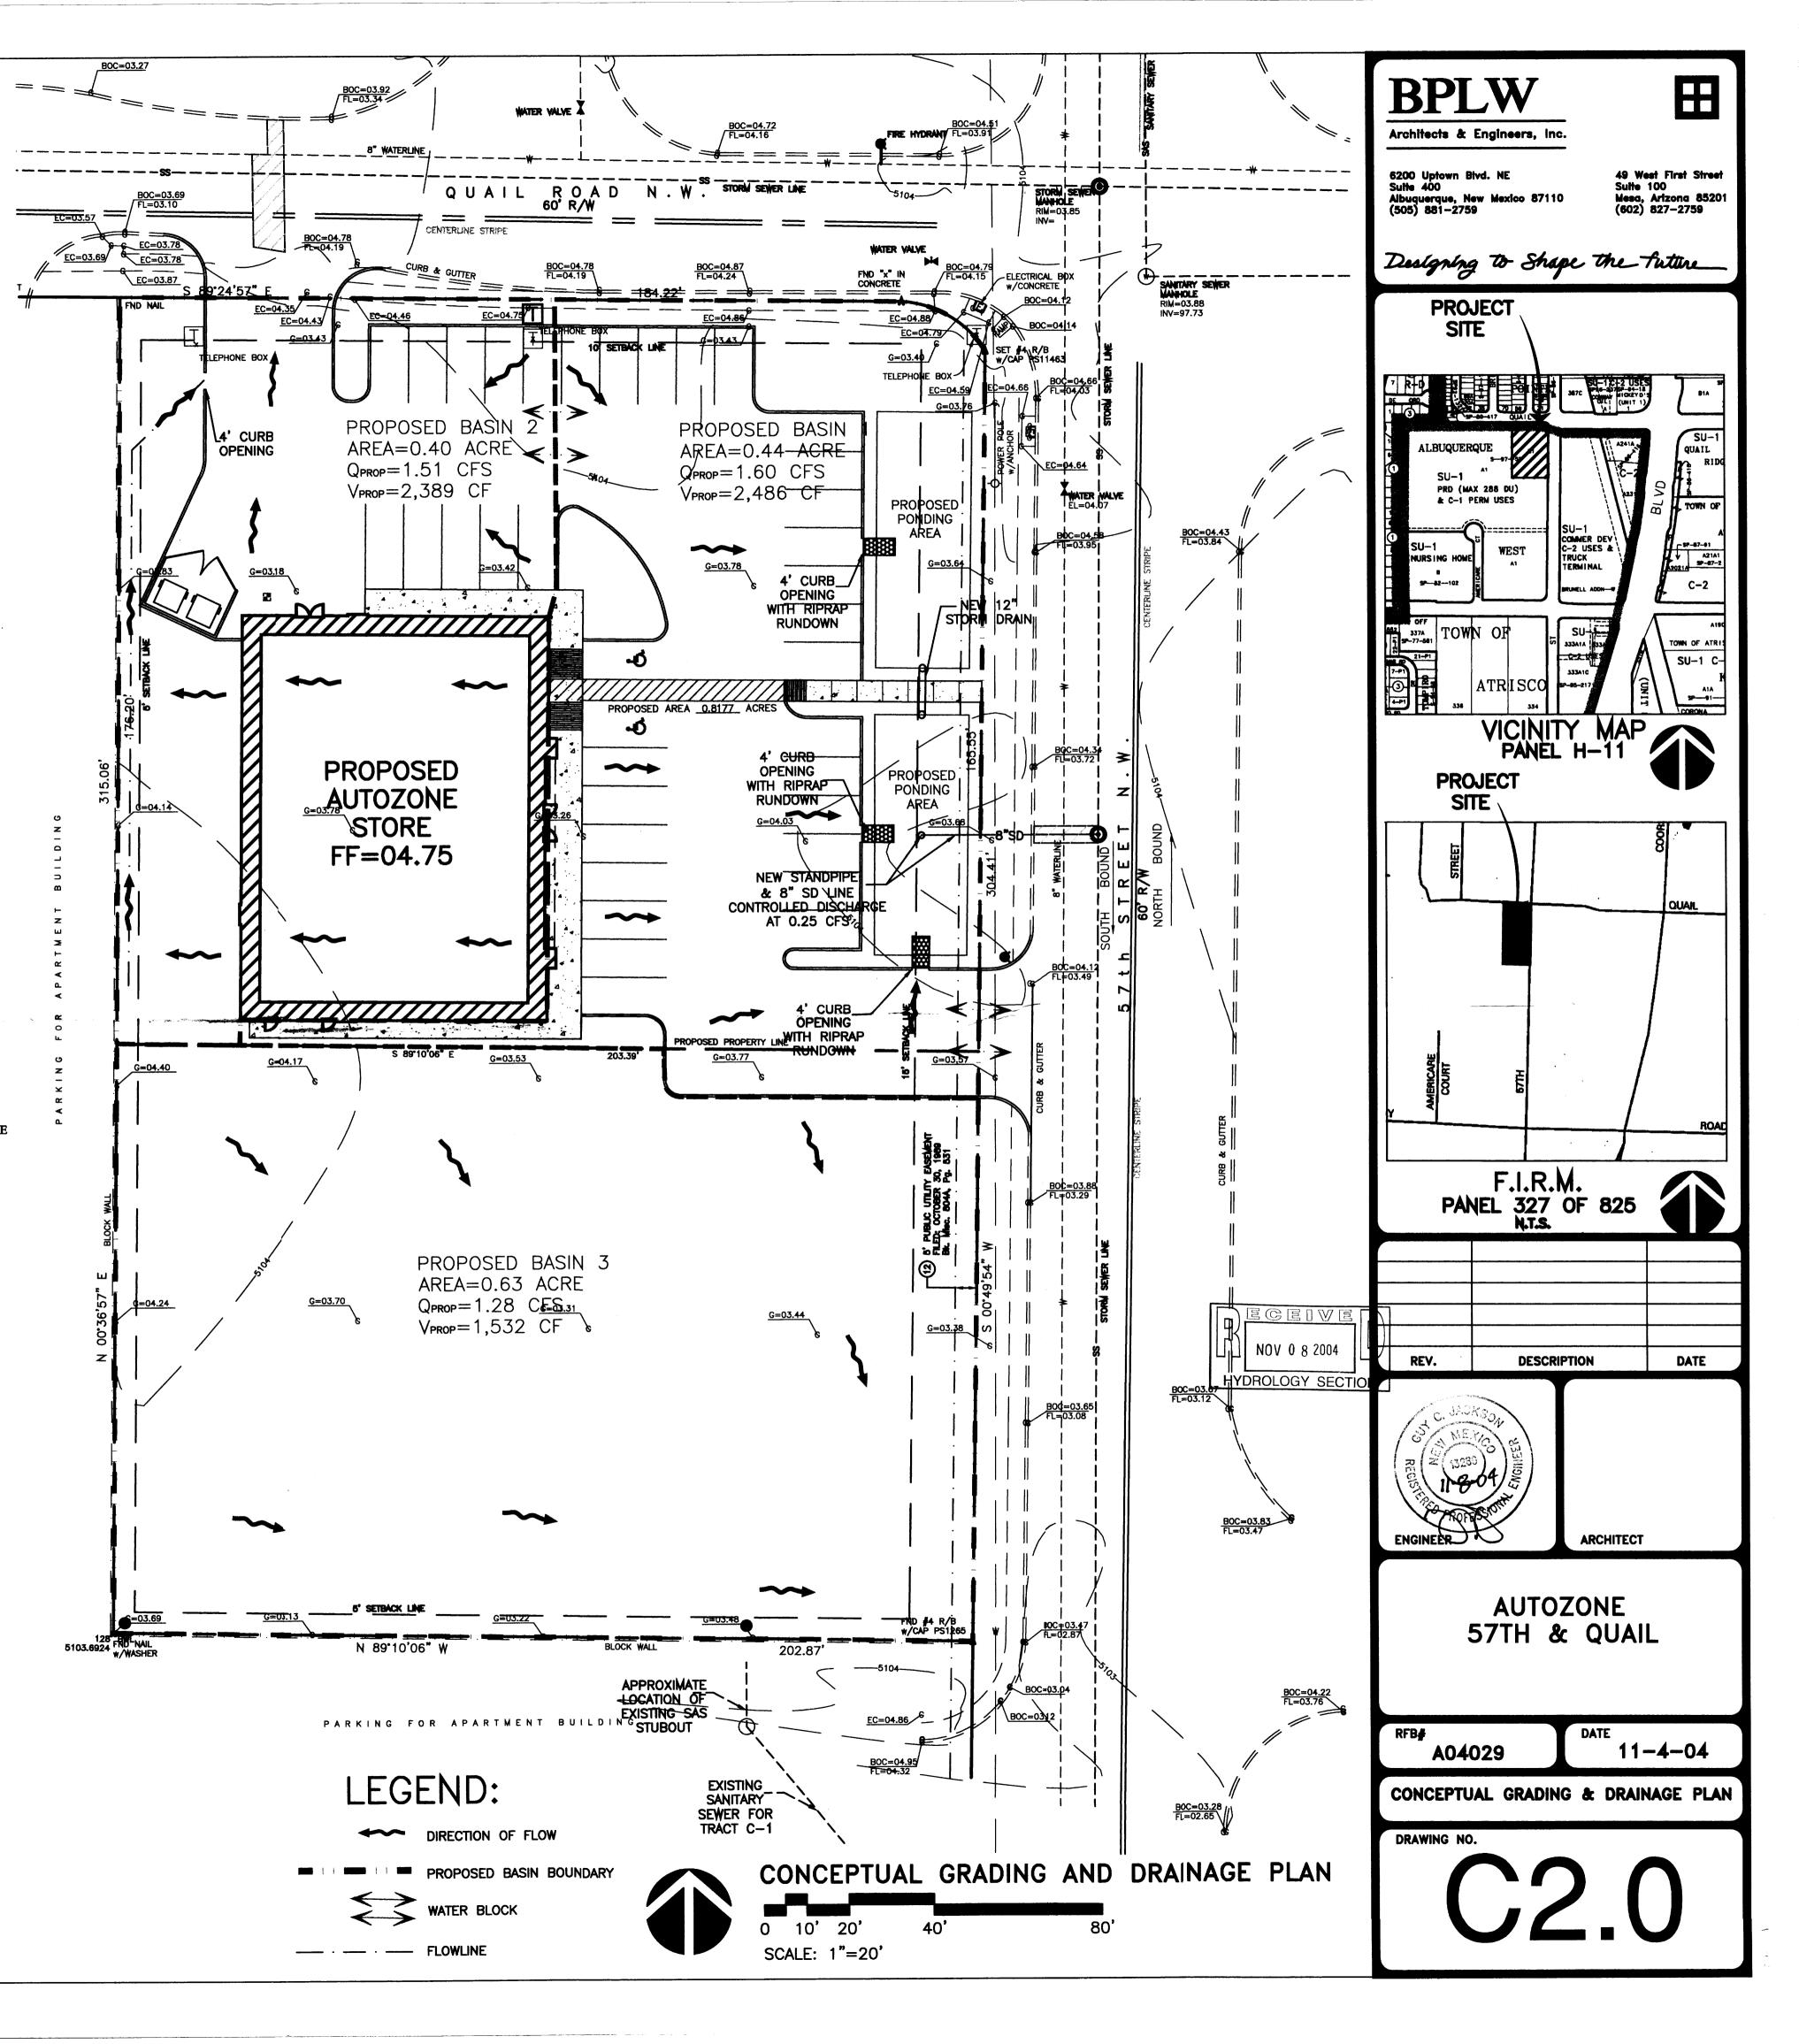

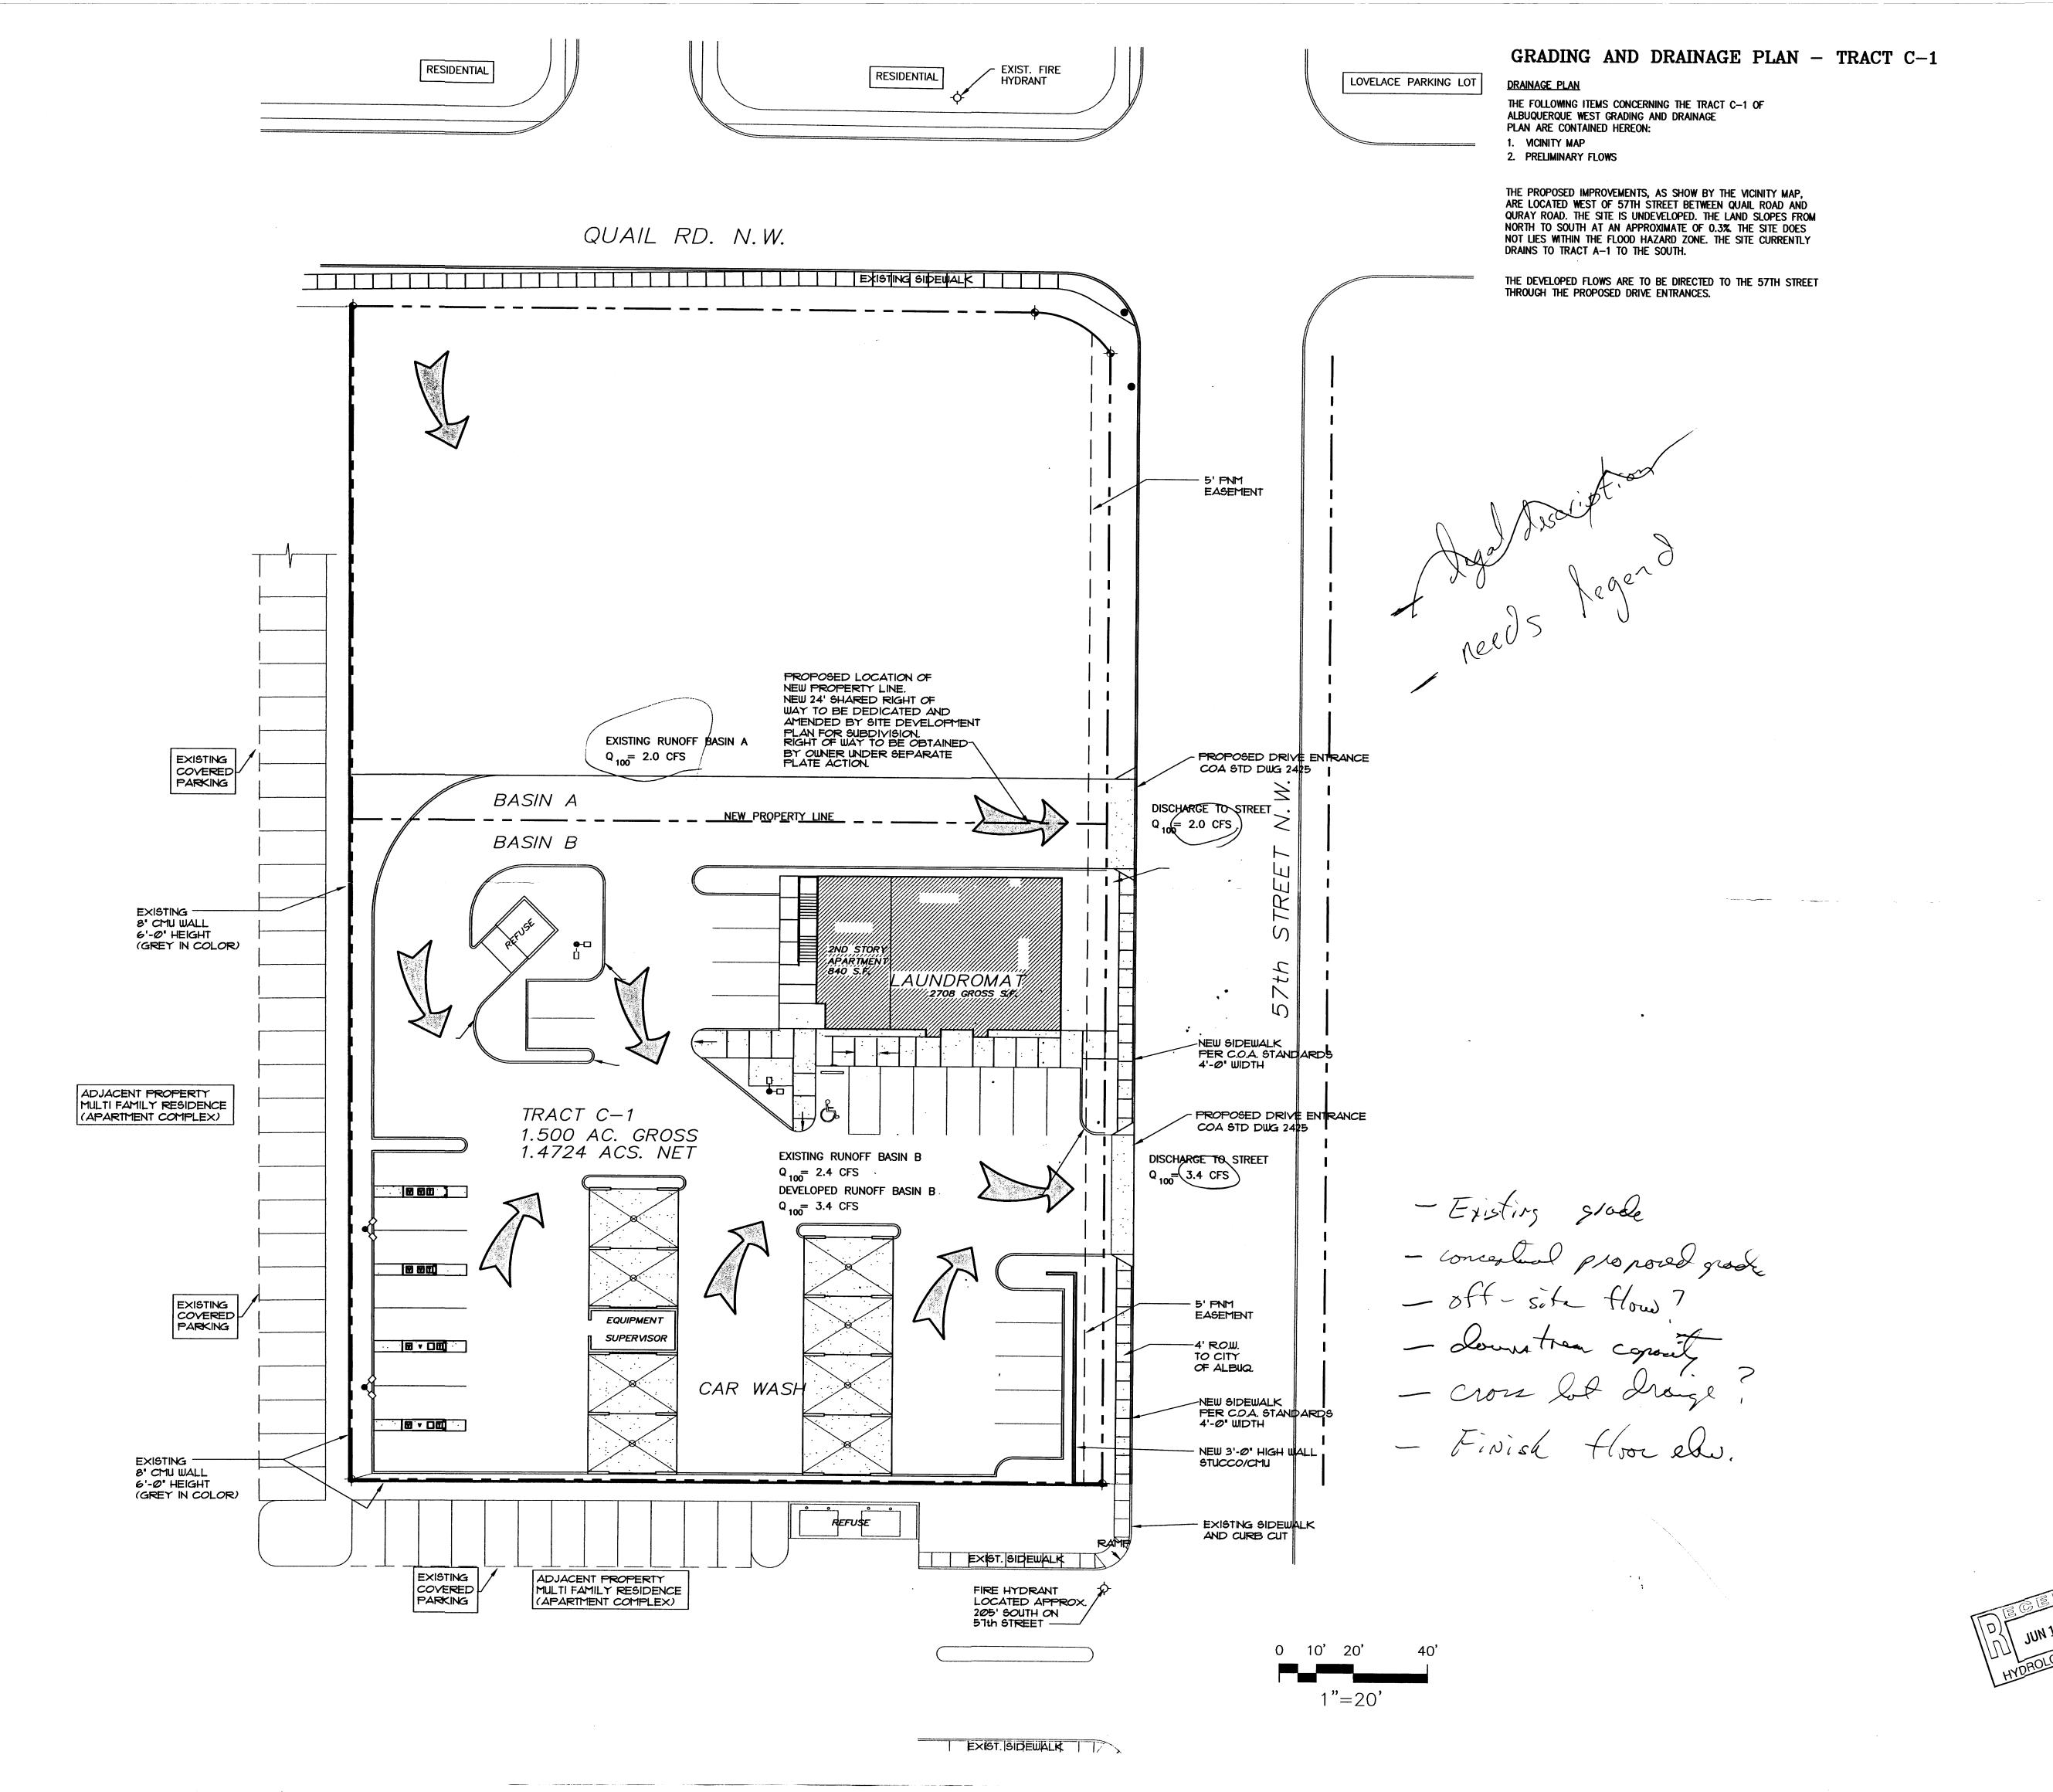

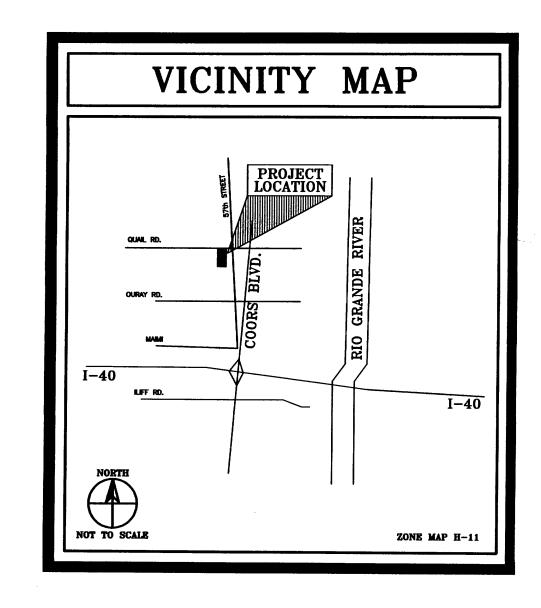



PRELIMINARY GRADING AND DRAINAGE PLAN

FEBRUARY 27, 2002

SCALE: 1"=20'



CLAUDIO VIGIL ARCHITECTS

LAUNDROMAT/CAR WASH

57th STREET ALBUQUERQUE, NEW MEXICO



C-1

PROJECT NUMBER
01265

SHEET

OWNERSHIP OF INSTRUMENTS OF SERVICE
All design concepts, details, plans, specifications, computer
files, field data, notes and other documents and instruments
prepared by Claudio Vigil Architects, P.C. as instruments of service
shall remain the property of Claudio Vigil Architects, P.C. Claudio
Vigil Architects, P.C. shall retain all common law, statutory and
other reserved rights, including the copyright thereto.

1801 Rio Grande NW, #2, Albuquerque, NM 87104 Phone: 505/842-1113 Fax: 505/842-1330