## CITY OF ALBUQUERQUE



Planning Department Transportation Development Services

February 2, 2015

Shawn Biazar, P.E. SBS Construction and Engineering, LLC 10209 Snowflake Court Albuquerque, NM 87114

## Re: Starbucks and Burger King, 1000 Rio Grande Blvd. NW Traffic Circulation Layout Engineer's Stamp dated 01 16 15 (H12 D021)

Engineer's Stamp dated 01-16-15 (H13-D021)

Dear Mr. Biazar:

Albuquerque

New Mexico 87103

www.cabq.gov

Based upon the information provided in your submittal received 01-22-15, the above referenced plan cannot be approved for Building Permit until the following comments are addressed:

- PO Box 12931.The combination of the fast food restaurant and the coffee shop meets the<br/>warrant for a Traffic Impact Study. Call to set up a Traffic Scoping Meeting.
  - 2. Label existing curb ramp at the corner of Aspen Avenue and Rio Grande Blvd. Call out for it to remain undisturbed.
  - 3. Label curb radii for all dead-end islands. Radii needs to be a minimum of 15 feet for passenger cars (See Figure 23,7.2, Page 23-88 of DPM.). For the southeast corner of the site development, radii of 10 feet and 8 feet are shown, and they need to be increased to 15 feet.
    - 4. Please show and label the Aspen Avenue/23<sup>rd</sup> Street intersection to show the proximity of new drivepad location to this intersection.
    - 5. The drive onto Rio Grande Blvd. does not meet the required queuing throat length for an arterial street (Table 23.7.1, page 23-91). The throat will have to be lengthened. It's best to call and discuss this comment.
    - 6. The design delivery route for the larger delivery vehicles needs to be shown.
    - 7. At the northwest corner of Burger King, add curb or barrier to separate pedestrian traffic from vehicular traffic where the radius of 23 feet is shown.
    - 8. For Notes 14, 10 and 27, increase the width of the ADA accessible route from 4 feet to 6 feet. Per the DPM, a 6-foot wide ADA accessible pedestrian pathway is required from the HC parking stall access aisles to the building entrances.
    - 9. Provide a pavement typical section for the asphalt parking lot.

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- 10. Show the mini clear sight distance triangle per page 23-74 of the DPM for the drivepad onto Aspen. Please add the following note to this clear sight triangle; "Landscaping and signage will not interfere with clear sight requirements. Therefore, signs, walls, trees, and shrubbery between 3 and 8 feet tall (as Therefore, signs, walls, trees, and shrubbery between 3 and 8 feet tall (as measured from the gutter pan) will not be acceptable in this area."
- 11. For the new site drive onto Rio Grande Boulevard, provide a clear sight triangle that is in compliance with Page 23-28 of the DPM for intersections. Also add the note "Landscaping and signay will not interfere with clear sight requirements. Therefore, signs, walls, trees, and shrubbery between 3 and 8 requirements. Therefore, signs, walls, trees, and shrubbery between 3 and 8 requirements. Therefore, signs, walls, trees, and shrubbery between 3 and 8 requirements. Therefore, signs, walls, trees, and shrubbery between 3 and 8 requirements.
- 12. To provide further clarification for the queuing length for the vehicles, list the total length of the queue for both the Burger King and the Starbucks drive-thru on the site plan view.
- 13. For Keyed Note 7, please list the length for each one of the curb cut removals and replacements on the plan view.
- 14. Near Keyed Note 9, call out the existing sidewalk width. For Keyed Note 8, have call-out note saying that existing sidewalk is to remain undisturbed. Make sure Keyed Note 8 is called out on all areas in between existing curb cuts where sidewalk is supposed to remain undisturbed.
- 15. For the 6-foot sidewalk tie-in to existing sidewalk on Rio Grande Boulevard, call out for a smooth tie-in.
- 16. For the uni-directional ramps shown as part of Keyed Note 40 for the drive onto Rio Grande Boulevard, provide detail complete with detectable warning devices.
- 17. For Keyed Note 21, provide a ramp detail.
- 18. For the aisle for handicapped parking in the center of the parking lot, increase from 3.5 feet to the required minimum width of 5 feet. If it helps, in order to gain this extra width for this aisle, parking spaces only need to be a minimum width of 8.5 feet.
- 19. Please include two copies of the traffic circulation layout at the next submittal.

Resubmit acceptable package along with fully completed Drainage Transportation Information Sheet to front counter personnel for log in and evaluation by Transportation. If you have any questions, please contact me at (505) 924-3924.

Sincerely,

Jeanne Wolfenbarger, P.E. Senior Engineer, Planning Dept. Development Review Services



## City of Albuquerque

Planning Department

Development & Building Services Division

DRAINAGE AND TRANSPORTATION INFORMATION SHEET

(REV 02/2013)

Project Title:	Building Permit #:	City Drainage #:	
DRB#: EPC#:		Work Order#:	
Legal Description:			
City Address:			
Engineering Firm:		Contact:	
Address:			
Phone#: Fax#:		E-mail:	
Owner:		Contact:	
Address:			
Phone#: Fax#:		E-mail:	
Architect:		Contact:	
Address:			
Phone#: Fax#:		E-mail:	
Surveyor:		Contact:	
Address:			
Phone#: Fax#:		E-mail:	
Contractor:		Contact:	
Address:			
Phone#: Fax#:		E-mail:	
TYPE OF SUBMITTAL:	CHECK TYPE OF APPROV	AL/ACCEPTANCE SOUGHT:	
DRAINAGE REPORT	SIA/FINANCIAL GUARANTEE RELEASE		
DRAINAGE PLAN 1st SUBMITTAL	PRELIMINARY PLAT APPROVAL		
DRAINAGE PLAN RESUBMITTAL	S. DEV. PLAN FOR SUB'D APPROVAL		
CONCEPTUAL G & D PLAN	S. DEV. FOR BLDG. PERMI	S. DEV. FOR BLDG. PERMIT APPROVAL	
GRADING PLAN	SECTOR PLAN APPROVAL	SECTOR PLAN APPROVAL	
EROSION & SEDIMENT CONTROL PLAN (ESC)	FINAL PLAT APPROVAL		
ENGINEER'S CERT (HYDROLOGY)	CERTIFICATE OF OCCUPANCY (PERM)		
CLOMR/LOMR	CERTIFICATE OF OCCUPANCY (TCL TEMP)		
TRAFFIC CIRCULATION LAYOUT (TCL)	FOUNDATION PERMIT APPROVAL		
ENGINEER'S CERT (TCL)	BUILDING PERMIT APPROVAL		
ENGINEER'S CERT (DRB SITE PLAN)	GRADING PERMIT APPROVAL SO-19 APPROVAL		
ENGINEER'S CERT (ESC)	PAVING PERMIT APPROVAL ESC PERMIT APPROVAL		
SO-19	WORK ORDER APPROVAL ESC CERT. ACCEPTANCE		
OTHER (SPECIFY)	GRADING CERTIFICATION	N OTHER (SPECIFY)	
WAS A PRE-DESIGN CONFERENCE ATTENDED:	Yes No Co	ppy Provided	
DATE SUBMITTED:	By:		


Requests for approvals of Site Development Plans and/or Subdivision Plats shall be accompanied by a drainage submittal. The particular nature, location, and scope to the proposed development defines the degree of drainage detail. One or more of the following levels of submittal may be required based on the following


1. Conceptual Grading and Drainage Plan: Required for approval of Site Development Plans greater than five (5) acres and Sector Plans


2. Drainage Plans: Required for building permits, grading permits, paving permits and site plans less than five (5) acres

3. **Drainage Report**: Required for subdivision containing more than ten (10) lots or constituting five (5) acres or more

4. Erosion and Sediment Control Plan: Required for any new development and redevelopment site with 1-acre or more of land disturbing area, including project less than 1-acre than are part of a larger common plan of development

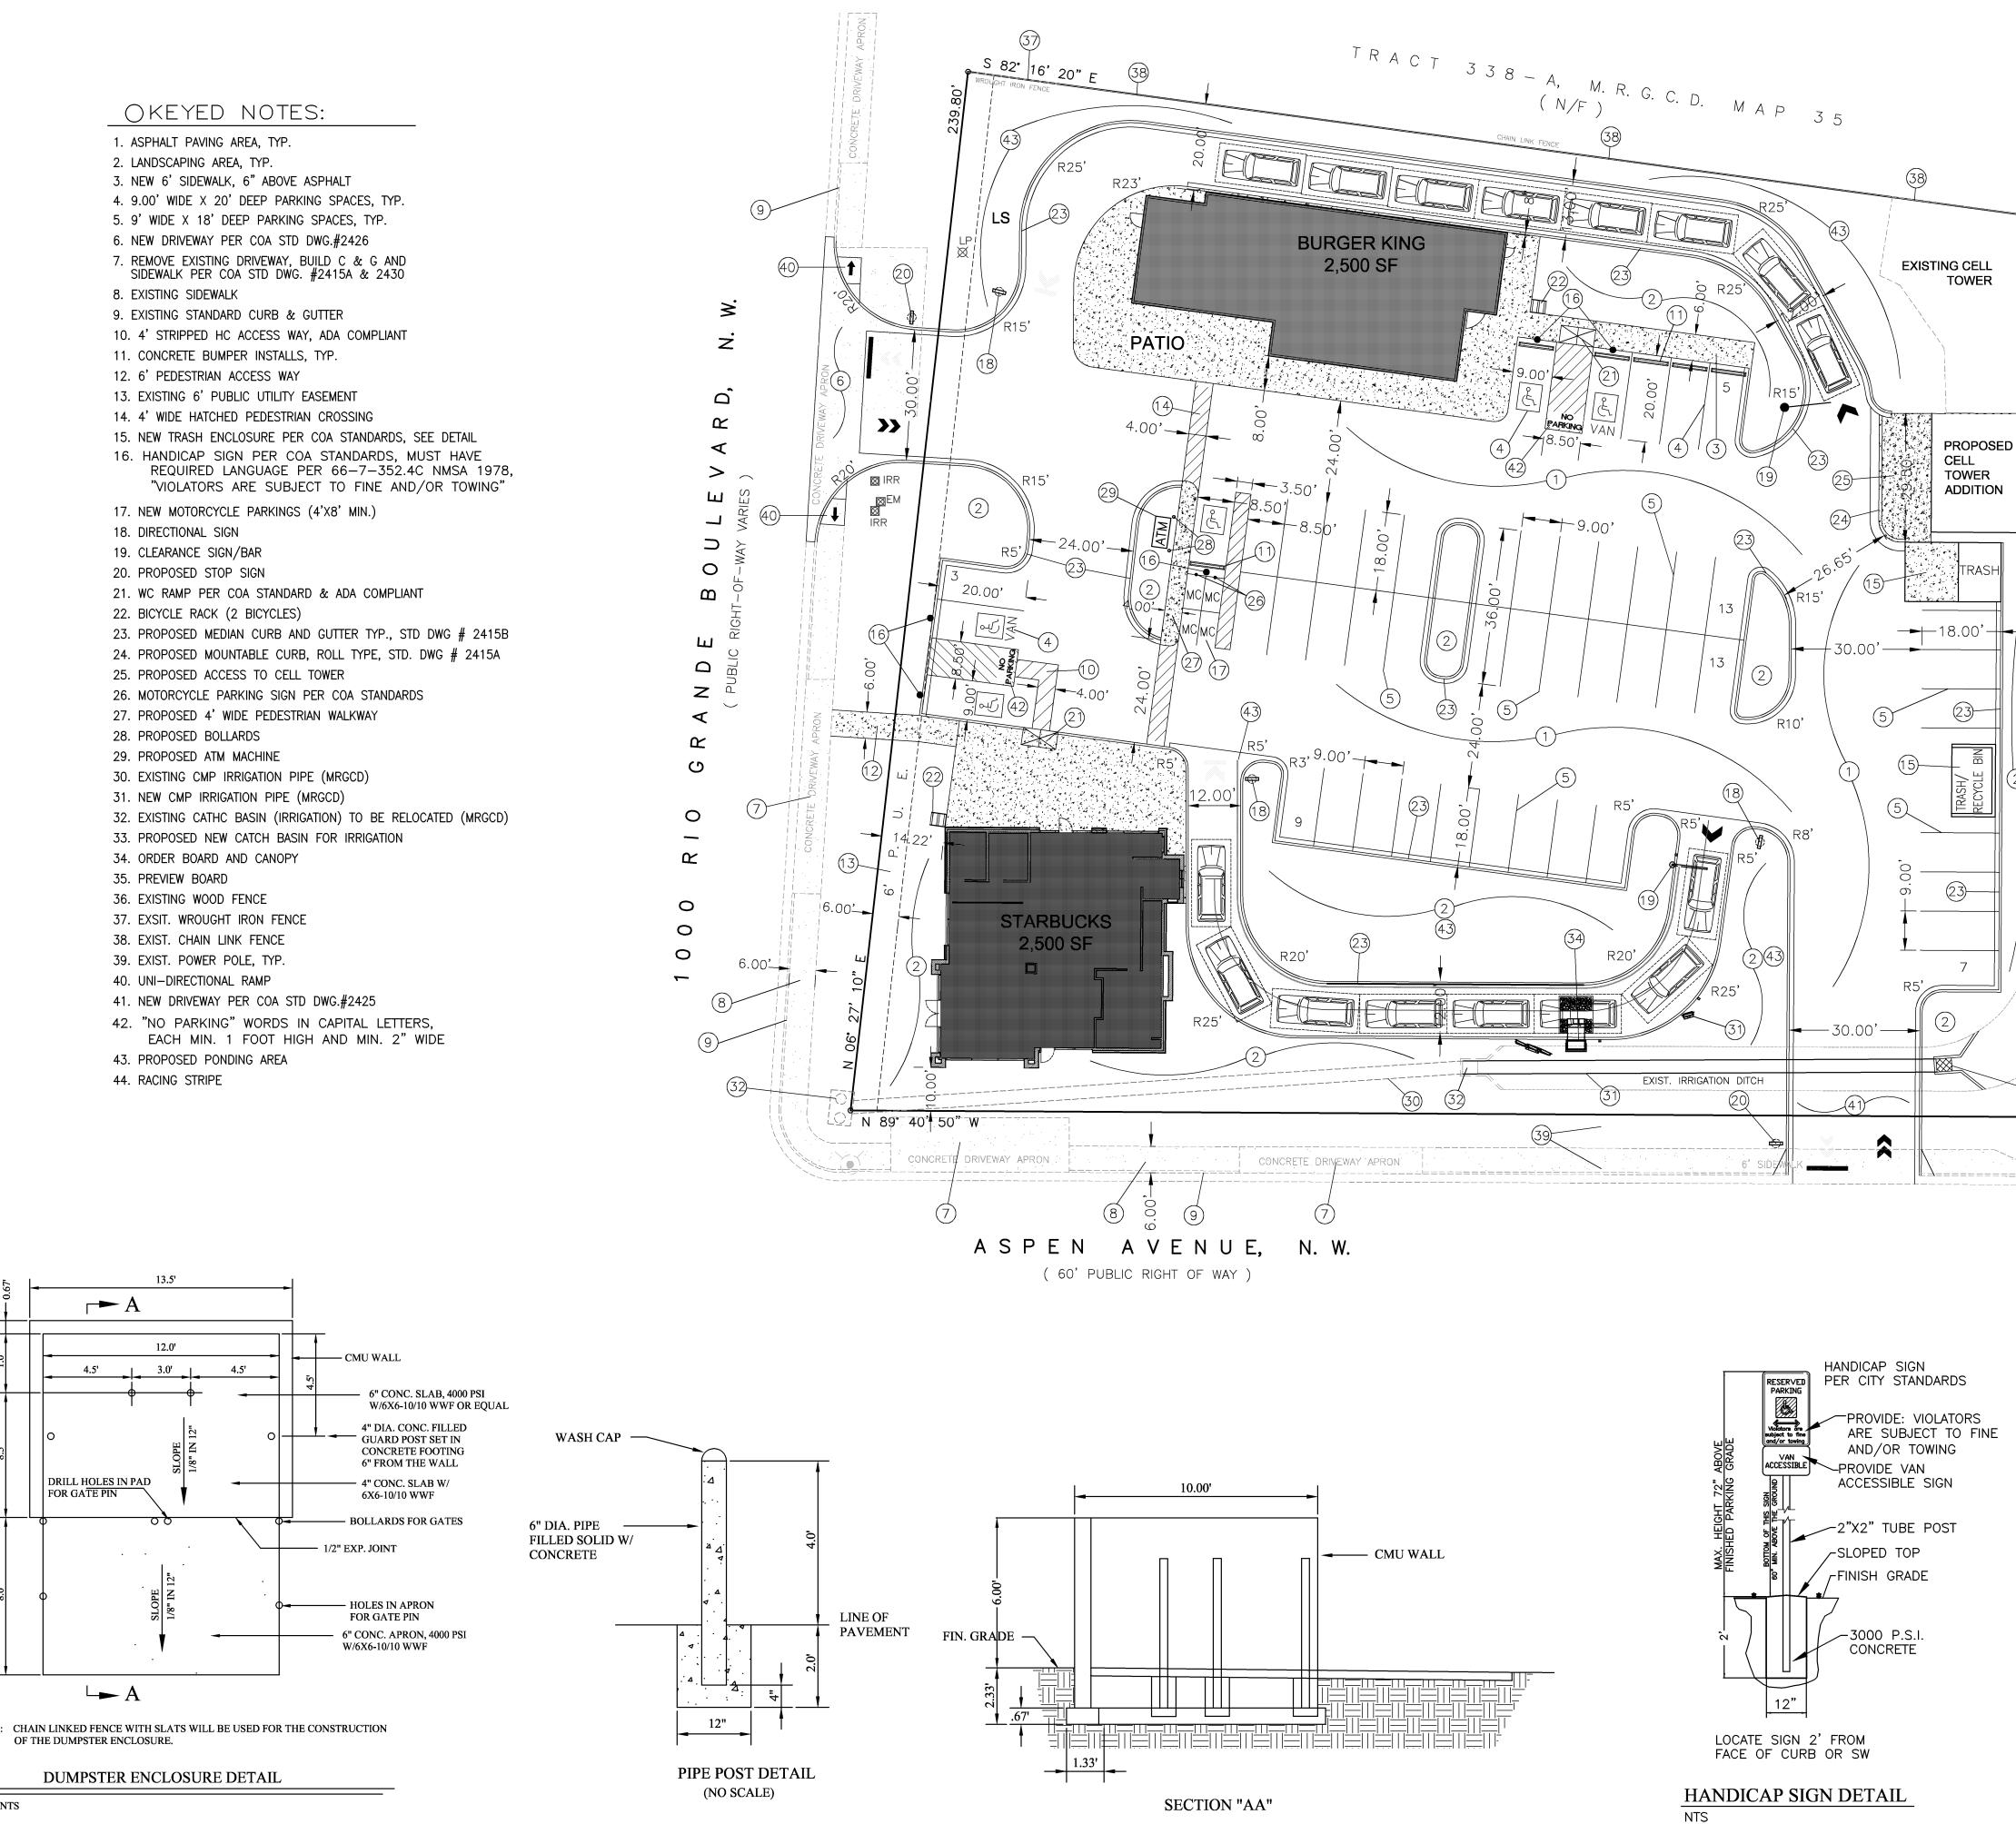

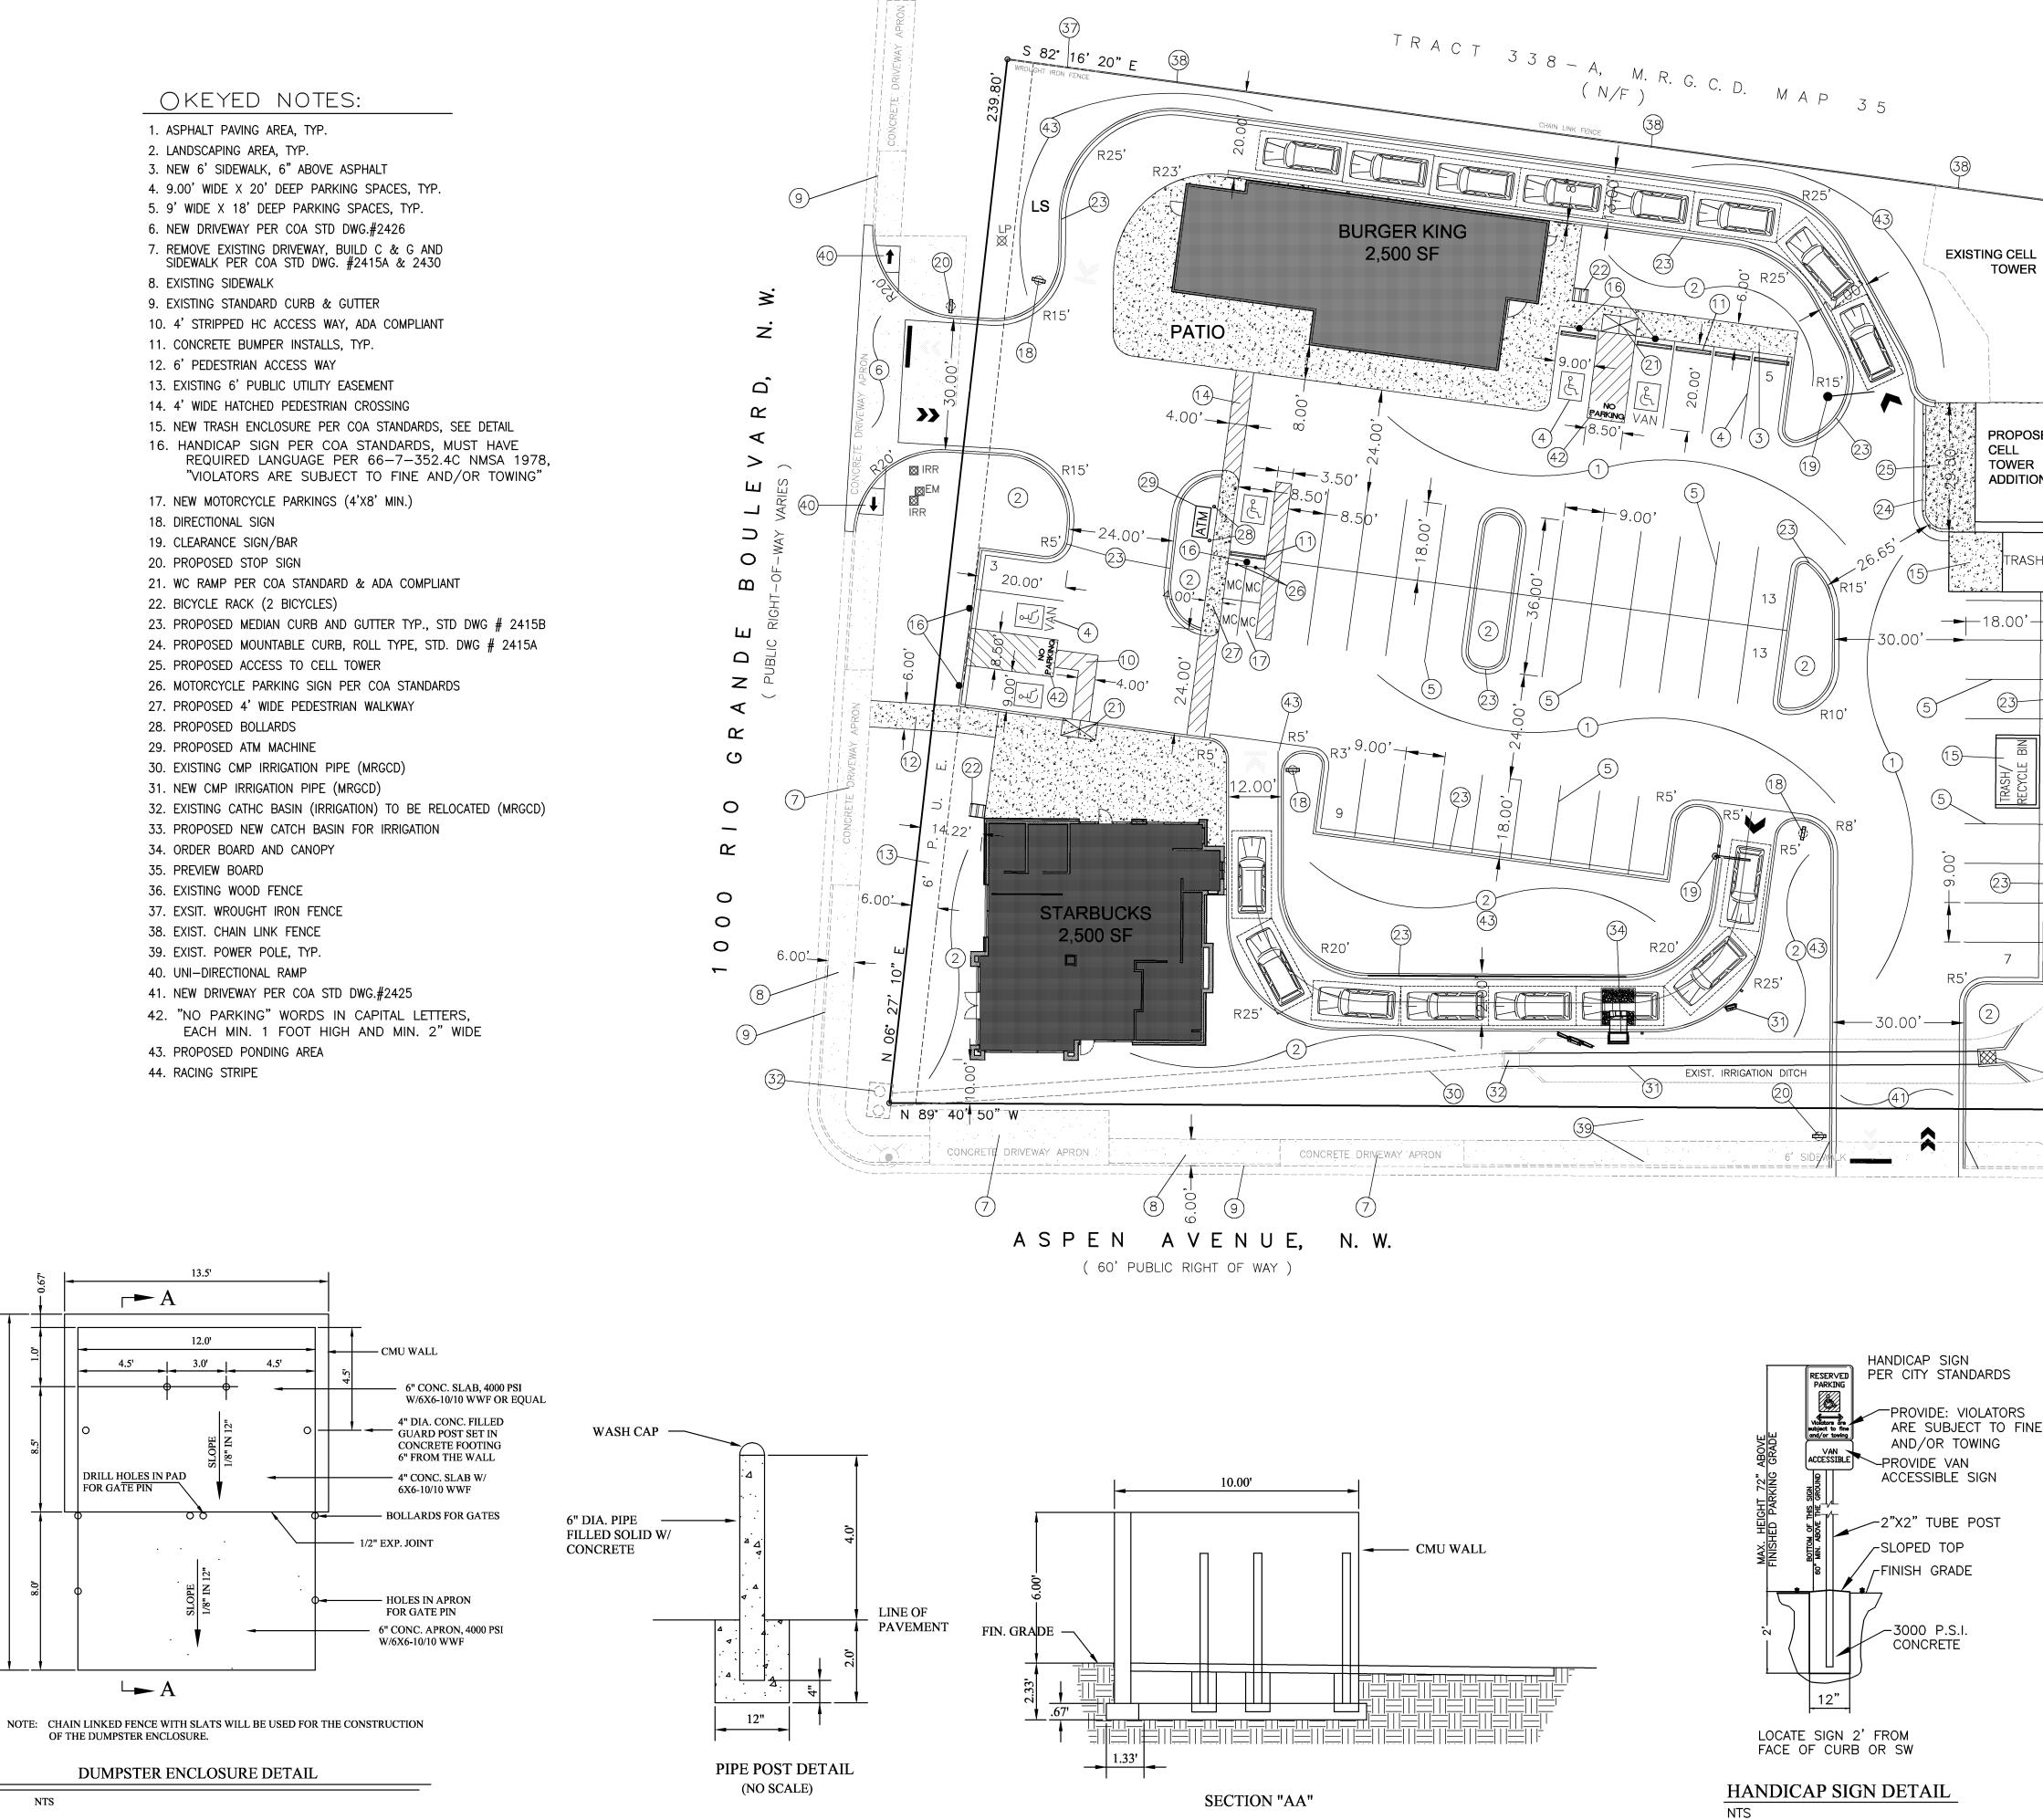

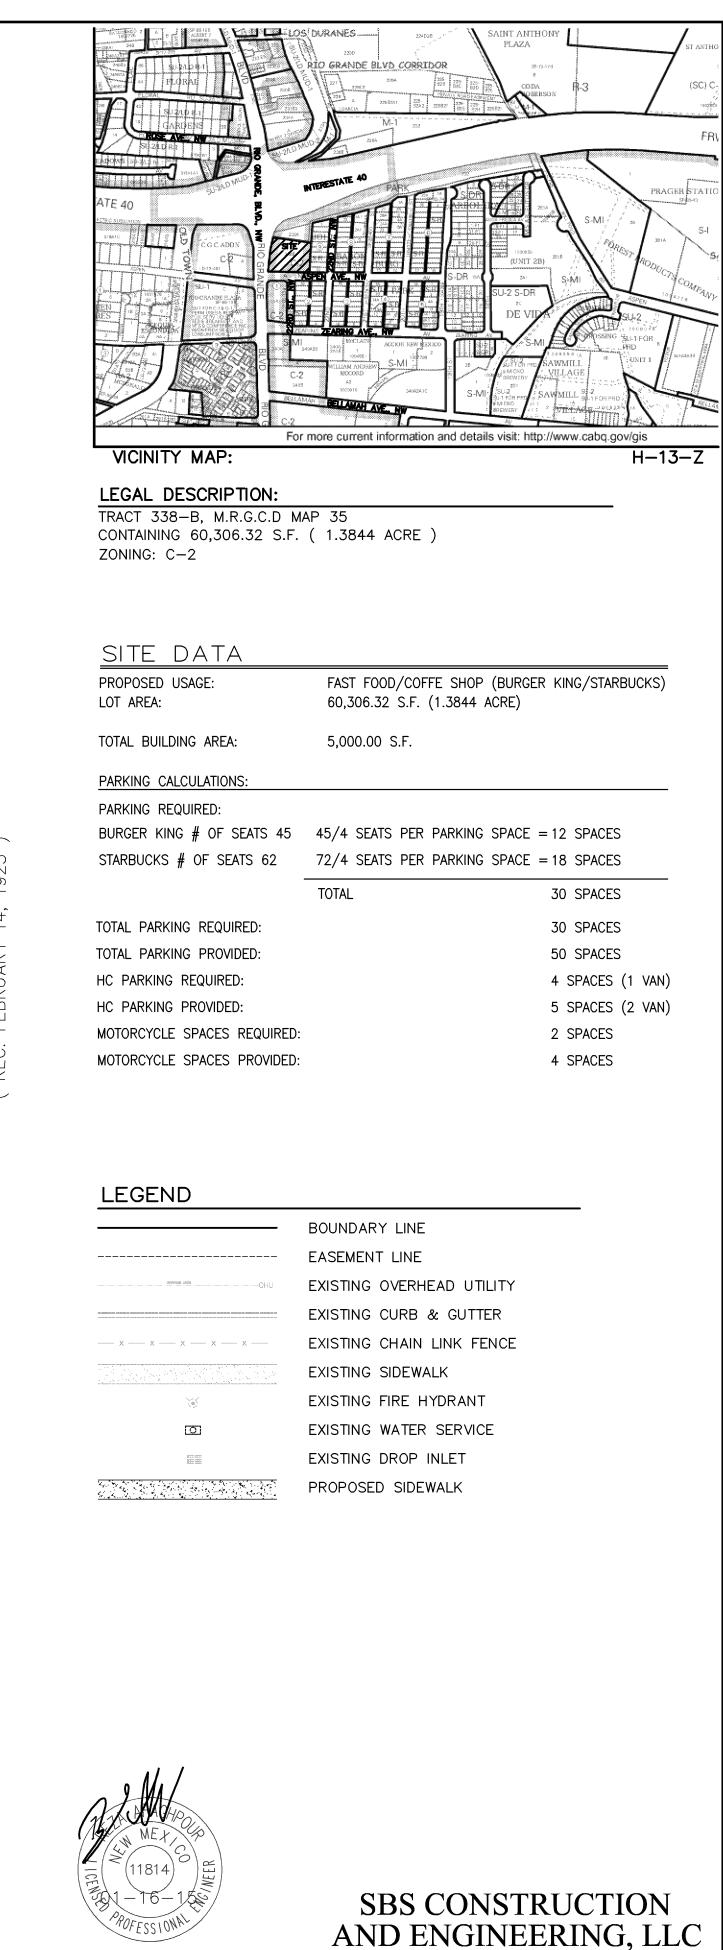

**REZA AFAGHPOUR** P.E. #11814

GRAPHIC SCALE

SCALE: 1"=20'

10209 SNOWFLAKE CT., NW ALBUQUERQUE, NEW MEXICO 87114 (505)804-5013

E 20	1000 RIO GRANDE BLVD., NW SITE PLAN FOR BUILDING PERMIT					
	DRAWING:	DRAWN BY:	DATE:	SHEET #		
0'	201309-SP.DWG	SH-B	12-18-2014	1		
LAST REVISION: 01-16-15						

9  $\sim$ LOT  $\triangleleft \frown$  $\circ$   $\circ$ \_.\_\_ YO 00 Υ Υ LOT Ш бО XĽ σ  $\bigcirc$ -36  $\circ$  $\cap$ 284.36' 

260.20'

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