CITY OF ALBUQUERQUE



December 22, 2020

Luis Noriega, PE Tierra West, LLC 5571 Midway Park NE Albuquerque, NM 87109

Re: Sandia Lab FCU 1100 Rio Grande Blvd NW Traffic Circulation Layout Engineer's Stamp Date 12-15-2020 (H13-D109)

Dear Mr. Noriega,

Based upon the information provided in your submittal received 12-15-2020, the above referenced plan cannot be approved for Building Permit until the following comments are addressed:

PO Box 1293	1.	Shared Site access: driveways that straddle property lines, or are entirely on one propertybut are to be used by another property, shall have an access easement. Please include a copy of your shared access agreement with the adjacent property owner. If there is an approved plat, then it needs to be provide to redefine the new lot lines. Please address this issue and/or an approved plat submitted. Condition of TCL Approval.
Albuquerque	2.	Private access easement on plat need to be shown as well as , all beneficiaries, maintenance responsibilities must be shown/listed on an approved plat. An approved is required prior to TCL/building permit approval .
NM 87103	3.	The curb ramps that are south of the proposed building are not lined up across the parking aisle.
www.cabq.gov	4.	A Traffic Study evaluating the alternative of a roundabout versus a traffic signal is needed at the Florence intersection. The type of traffic control at the intersection should be decided and agreed upon by all stakeholders prior to platting action. All improvements within the right-of-way should be built per work order and placed onto an infrastructure list.

If you have any questions, please contact me at (505) 924-3991.

Sincerely,

Jeanne Wolfenbarger

Jeanne Wolfenbarger, P.E., Planning Dept. Development Review Services

C: CO Clerk, File



City of Albuquerque


Planning Department Development & Building Services Division DRAINAGE AND TRANSPORTATION INFORMATION SHEET (REV 11/2018)

Project Title:	Building	Permit #: Hydrology File #:
DRB#:	EPC#:	Work Order#:
Legal Description:		
City Address:		
Applicant:		Contact:
Address:		
		E-mail:
Owner:		Contact:
Address:		
		E-mail:
TYPE OF SUBMITTAL: PLAT (_# OF LOTS)	_ RESIDENCE DRB SITE ADMIN SITE
IS THIS A RESUBMITTAL?:	Yes	No
DEPARTMENT: TRAFFIC/ TRAN	SPORTATION _	HYDROLOGY/ DRAINAGE
Check all that Apply: TYPE OF SUBMITTAL: ENGINEER/ARCHITECT CERTIFICA PAD CERTIFICATION CONCEPTUAL G & D PLAN GRADING PLAN DRAINAGE MASTER PLAN	ATION	TYPE OF APPROVAL/ACCEPTANCE SOUGHT:
DRAINAGE MASTER PLAN DRAINAGE REPORT FLOODPLAIN DEVELOPMENT PER ELEVATION CERTIFICATE CLOMR/LOMR TRAFFIC CIRCULATION LAYOUT TRAFFIC IMPACT STUDY (TIS) OTHER (SPECIFY) PRE-DESIGN MEETING?	(TCL)	FINAL PLAT APPROVAL SIA/ RELEASE OF FINANCIAL GUARANTEE FOUNDATION PERMIT APPROVAL GRADING PERMIT APPROVAL SO-19 APPROVAL PAVING PERMIT APPROVAL GRADING/ PAD CERTIFICATION WORK ORDER APPROVAL CLOMR/LOMR FLOODPLAIN DEVELOPMENT PERMIT OTHER (SPECIFY)
DATE SUBMITTED	Bv	


COA STAFF:

ELECTRONIC SUBMITTAL RECEIVED:

FEE PAID:

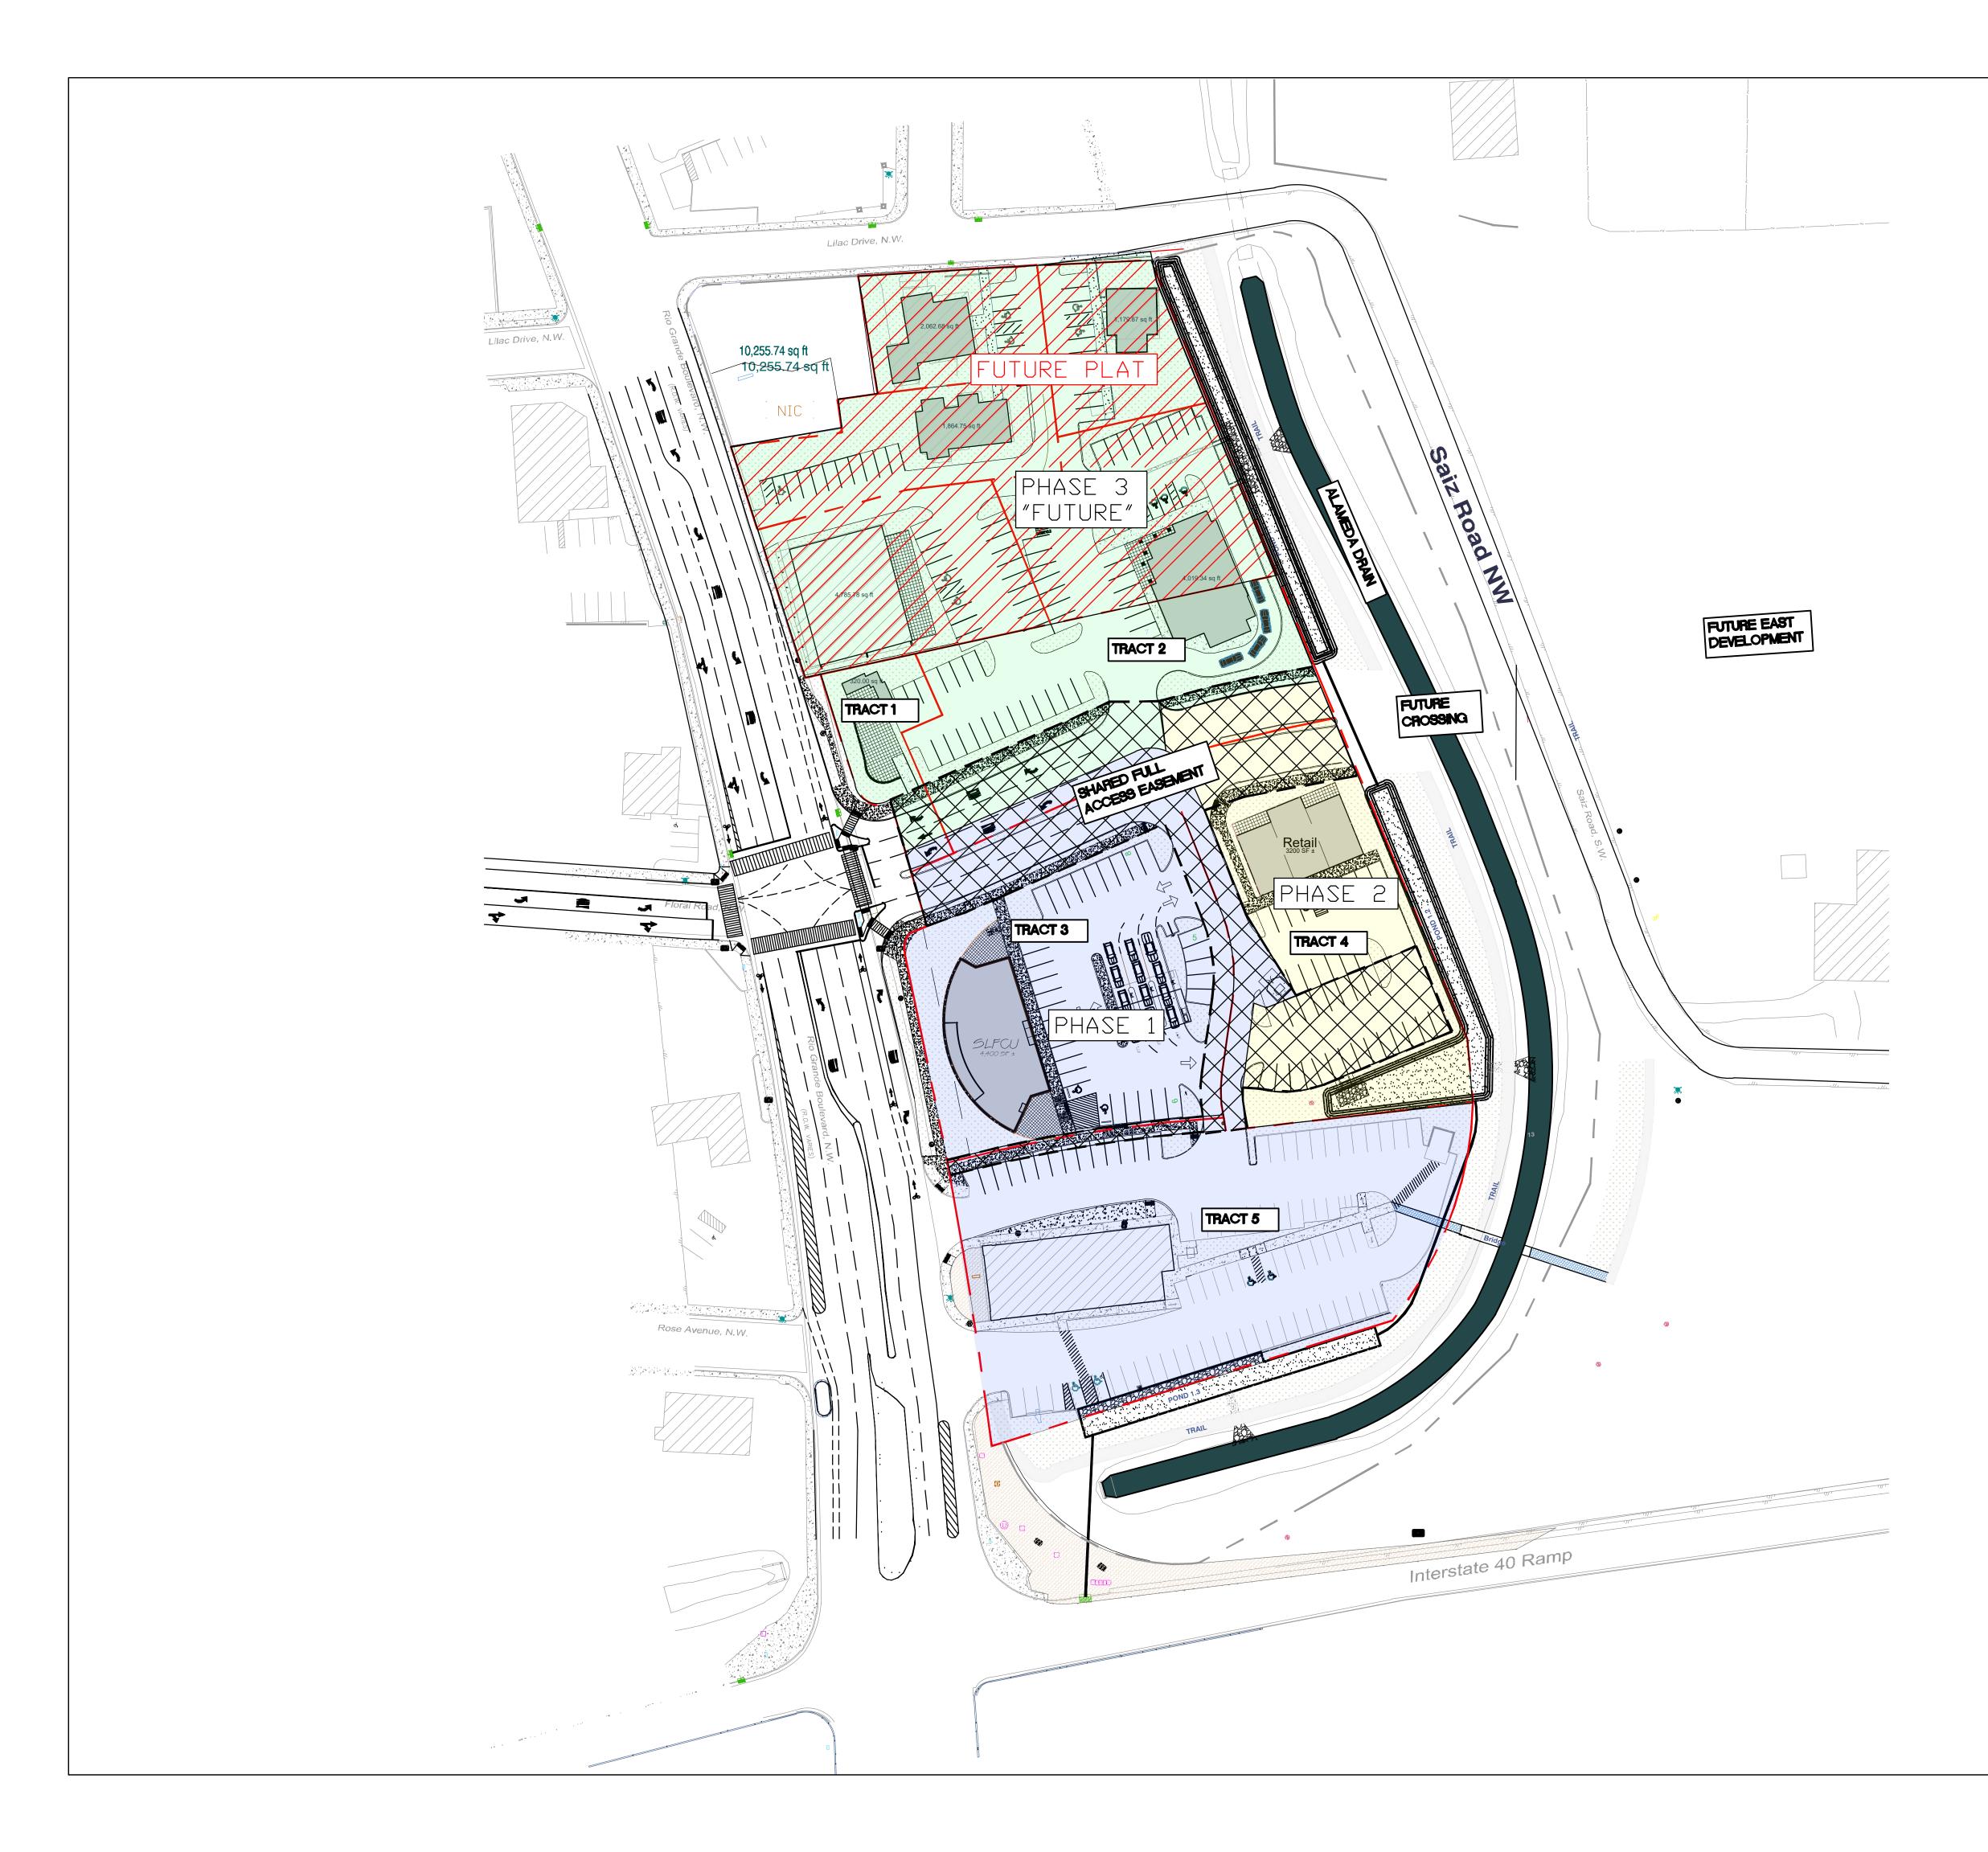


LEGEND	
	CURB & GUTTER PROPOSED PROPERTY LINE
	PROPOSED BUILDING
	PAVEMENT
	SIDEWALK
	LANDSCAPING
	LANE
	STRIPING
	EXISTING CURB & GUTTER
	EXISTING BOUNDARY LINE
	EXISTING SIDEWALK

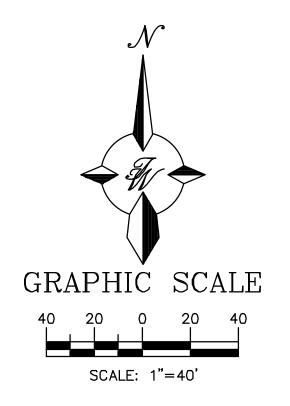

PRELIMINARY NOT FOR CONSTRUCTION


SEAL	SANDIA LAB FCU	<i>DRAWN BY</i> RG
	RIO GRANDE + 1-40	<i>DATE</i> 10-8-2020
	CONSTRUCTION PHASING EXHIBIT	2012100-SP
		SHEET #
	TIERRA WEST, LLC 5571 MIDWAY PARK PL NE ALBUQUERQUE, NEW MEXICO 87109	E1
RONALD R. BOHANNAN P.E. #7868	(505) 858–3100 www.tierrawestllc.com	<i>JOB #</i> 2012100

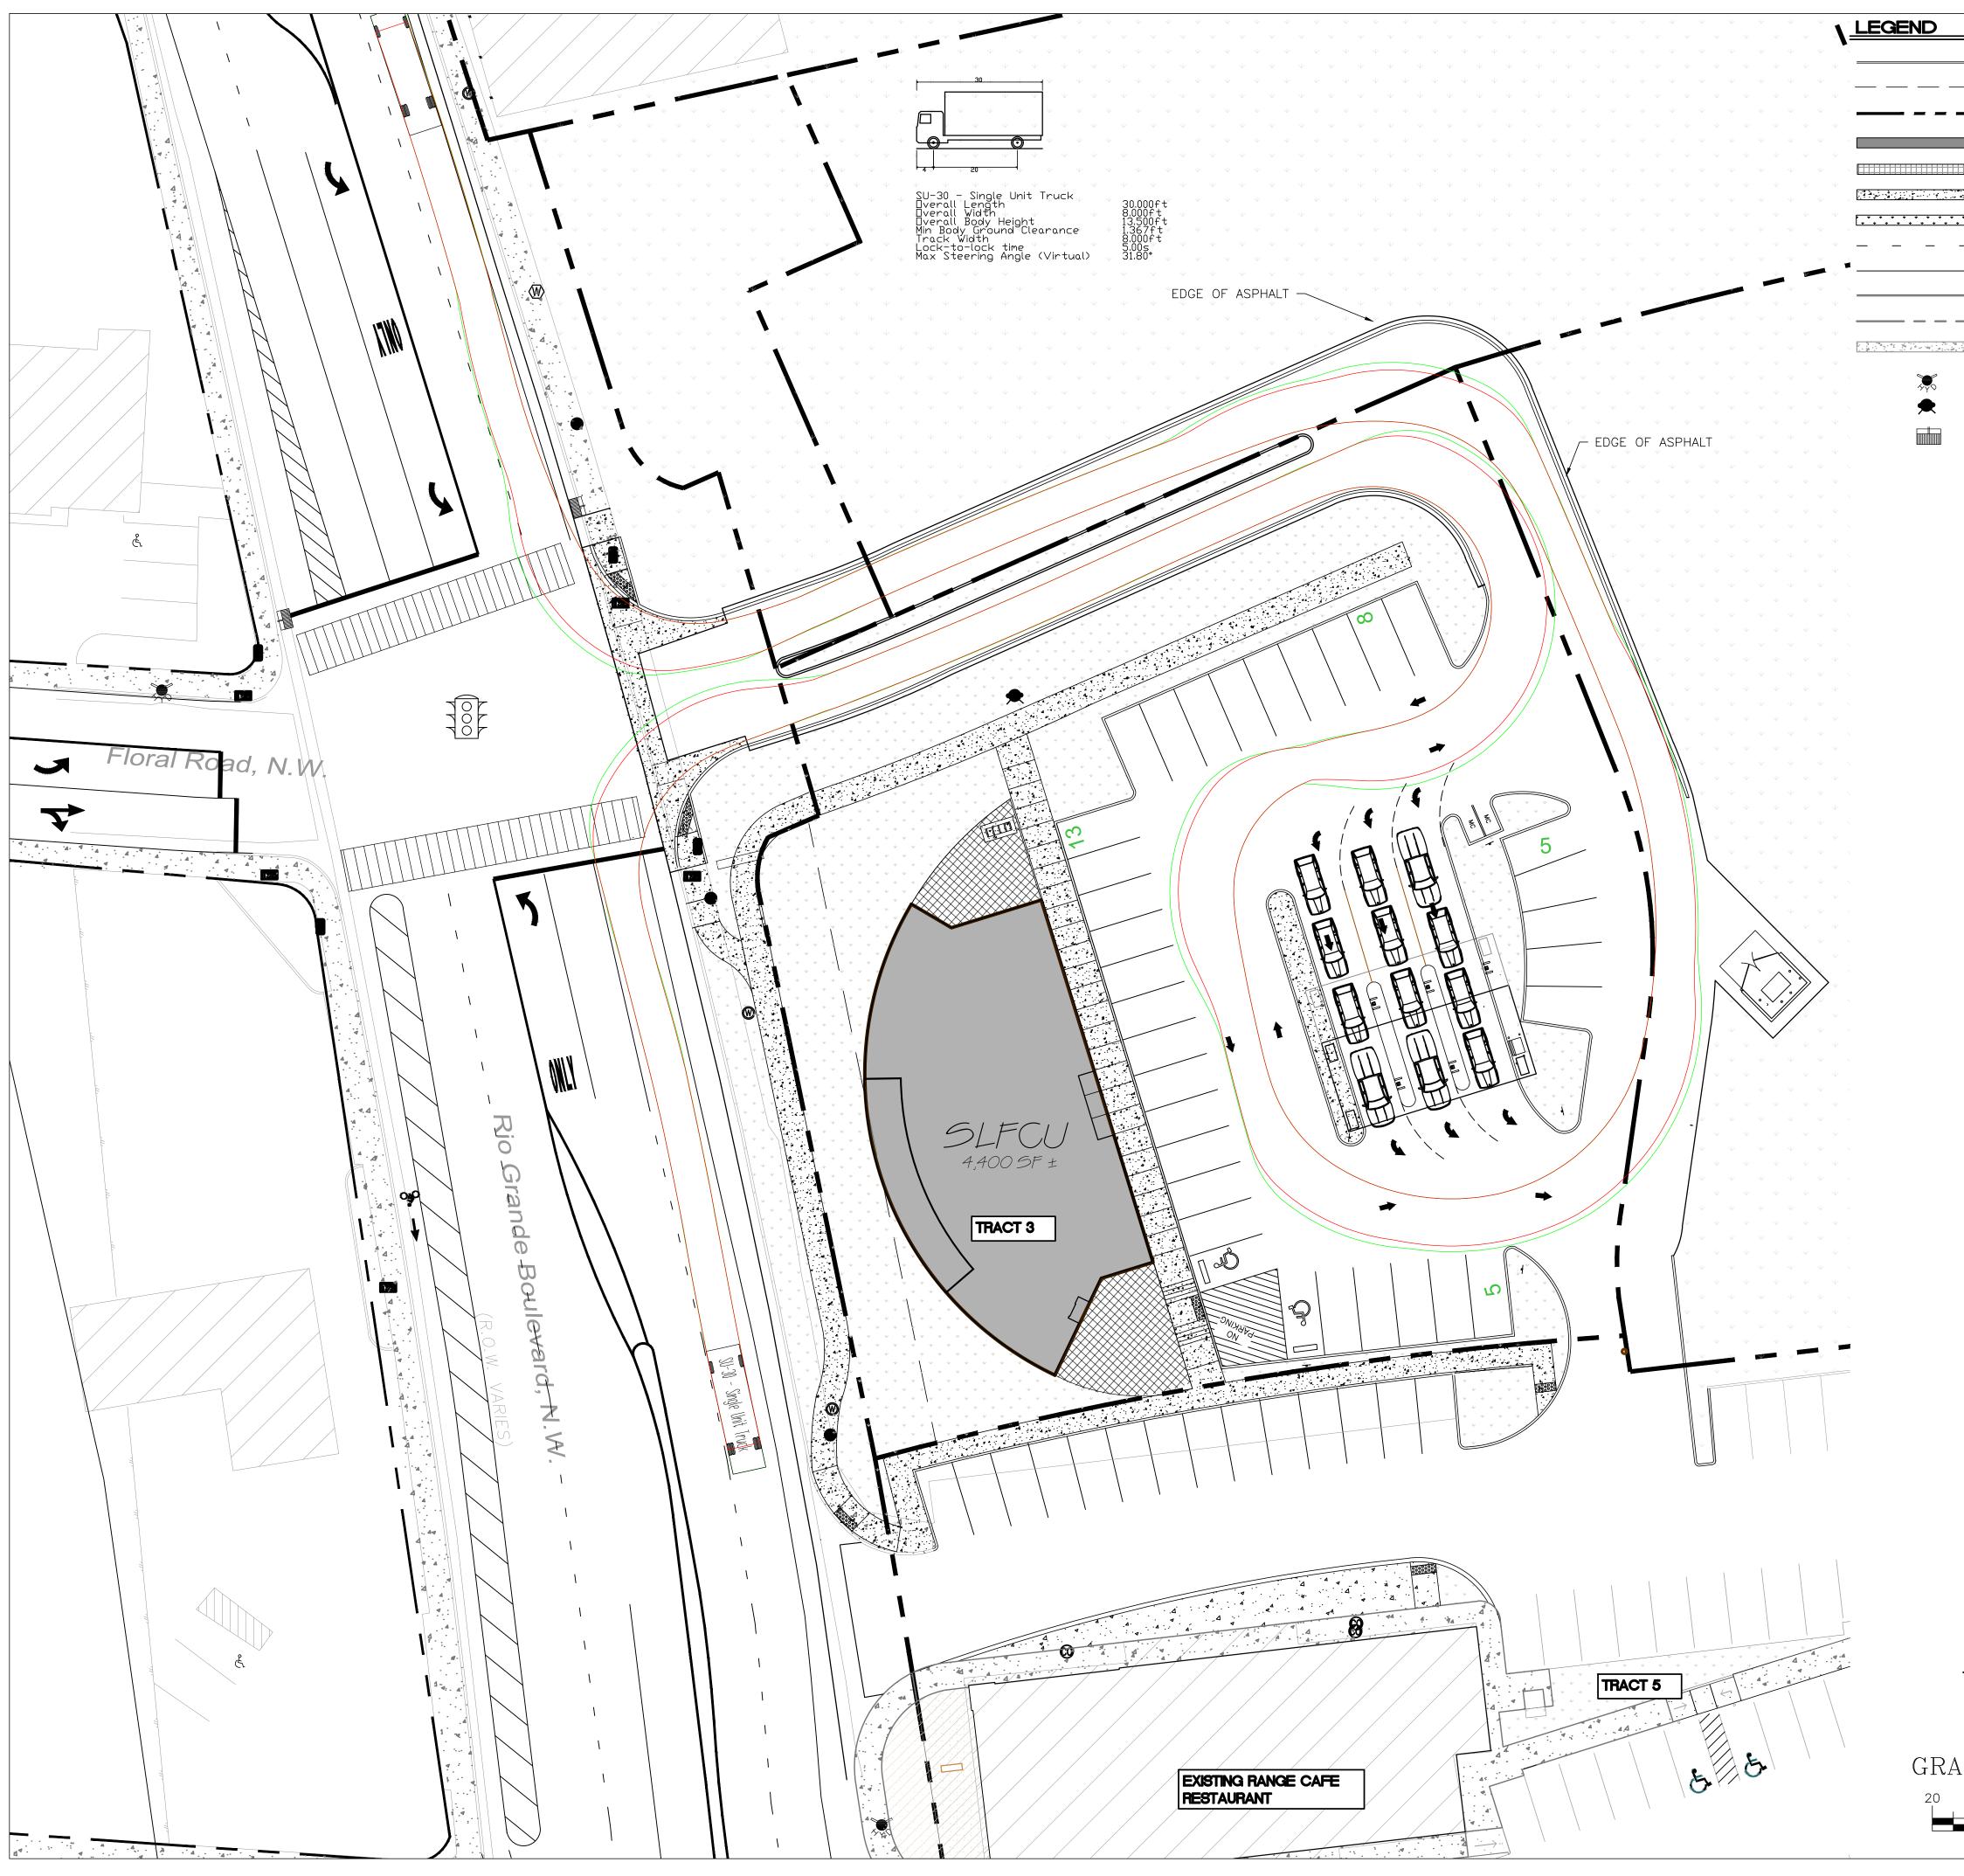

	CURB & GUTTER EASEMENT
	PROPOSED PROPERTY LINE
	PROPOSED BUILDING
	PAVEMENT
	SIDEWALK
* * * *	LANDSCAPING
	LANE
	STRIPING
	EXISTING CURB & GUTTER
	EXISTING BOUNDARY LINE
	EXISTING SIDEWALK
	EXISTING HYDRANT
	PROPOSED HYDRANT
	EXISTING SD INLET

FIG and the integrated Development Ordinance visit: http://www.caba.gov/alaning/codes-policies-regulations/integrated-development-ordinance	N M M
VICINITY MAP:	<u>H-13-Z</u>

N		PRELIMINARY NOT FOR CONSTRUCTION	
	ENGINEER'S SEAL	RIO GRANDE + 1-40 PHASE 1	DRAWN BY RG DATE
		SU-30 VEHICLE TURNING MOVEMENT	10-8-2020 <i>DRAWING</i> 2012100-SP -SLFCU
APHIC SCALE $10 0 10 20$		TIERRA WEST, LLC 5571 MIDWAY PARK PL NE ALBUQUERQUE, NEW MEXICO 87109	sheet # E4
SCALE: 1"=20'	RONALD R. BOHANNAN P.E. #7868	(505) 858-3100 www.tierrawestllc.com	<i>JOB #</i> 2012100

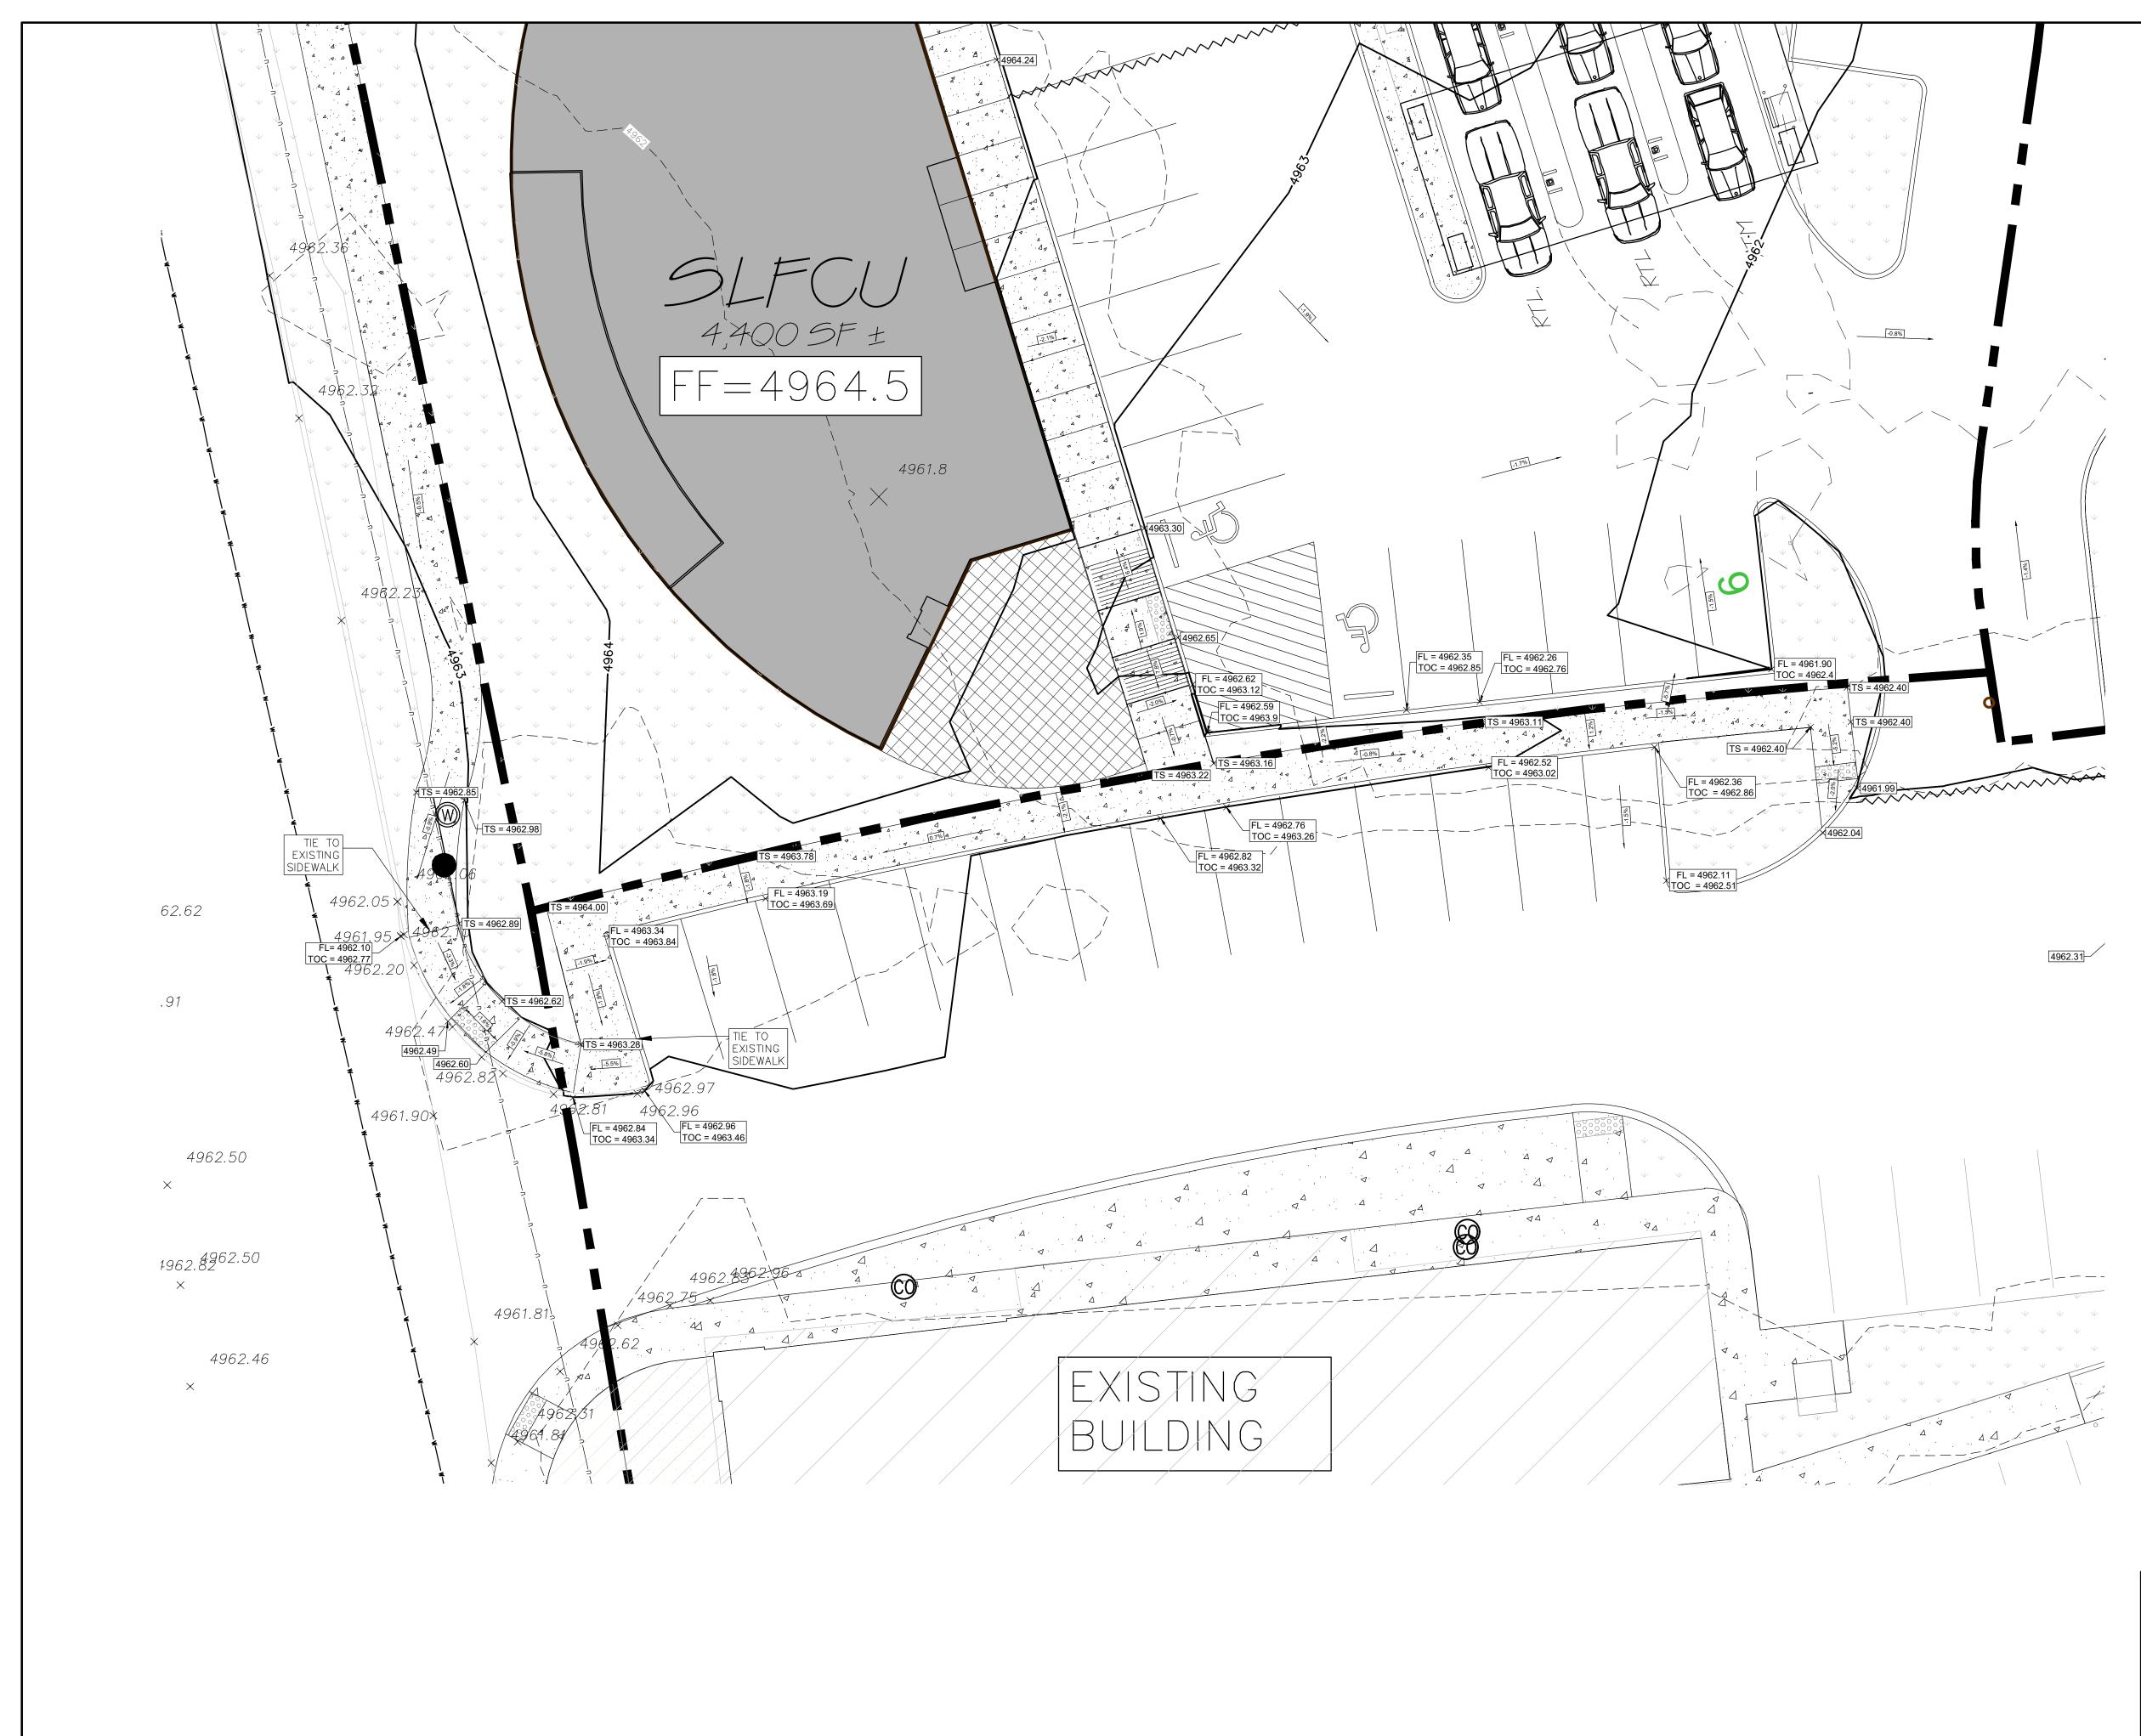


LEGEND

	PROPOSED BOUNDARY LINE
	EXISTING BOUNDARY LINE
	CONCRETE SIDEWALK
<u> 111111111111111111111111111111111111</u>	LANDSCAPING
	TEXTURED PAVEMENT
	RIP-RAP
	GRADE BREAK
	PROPOSED CONTOUR MAJOR
5011	PROPOSED CONTOUR MINOR
	PROPOSED FLOW ARROW
× 5048.25	PROPOSED SPOT ELEVATION
	CURB & GUTTER
\bigcirc	EX. STORM DRAIN MANHOLE
	EX. STORM DRAIN INLET
SD	EX. STORM DRAIN UTILITY LINE
5010	EXISTING CONTOUR MAJOR
<u> </u>	EXISTING CONTOUR MINOR
x 5048.25	EXISTING SPOT ELEVATION


SPOT ELEVATION LEGEND

FL=FLOW LINE TOC=TOP OF CURB TS= TOP OF SIDEWALK NOTE: ALL OTHER TO BE FLOW LINE ELEVATIONS

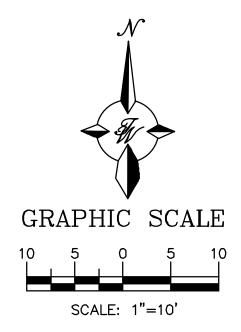

'FOR REFERENCE ONLY'

ENGINEER'S SEAL	SANDIA LAB FCU RIO GRANDE BLVD + I-40	<i>DRAWN BY</i> RG
	ADA SIDEWALK RAMP	<i>DATE</i> 10-8-2020
	CONNECTION DETAIL	2012100-BASE-GRD -CROSSING
	THERRA WEST, LLC 5571 MIDWAY PARK PL NE ALBUQUERQUE, NEW MEXICO 87109	<i>sheet #</i> E-5
RONALD R. BOHANNAN P.E. #7868	(505) 858—3100 www.tierrawestllc.com	<i>JOB </i>

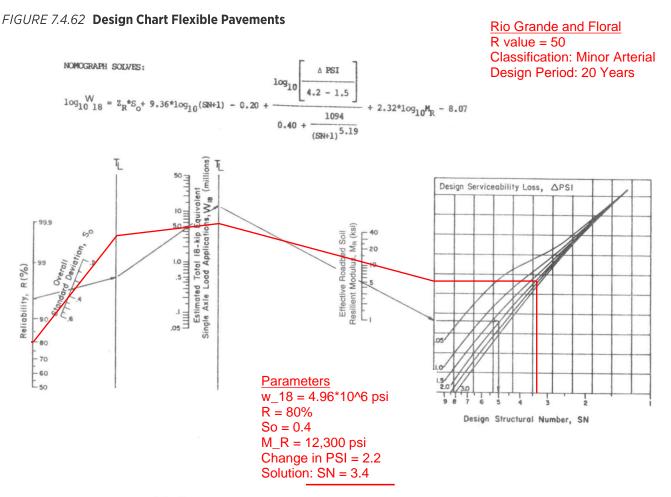

Design Chart for Flexible Pavements Based on Using Mean Values for Each Input

<u>Structural Coefficients of Pavement Components</u> d1 = Asphaltic Concrete (AC): a1 = 0.42 d2 = Aggregate Base Course (ABC): a2 = 0.1 (Modification Factor: m2 = 1.15) d3 = Sub-base Material: a3 = 0.06d = layer thickness in inches


- SN = a1*d1 + a2*d2*m2 + a3*d3
- $3.4 = 0.42^{*}d1 + 0.1^{*}6^{*}1.15 + 0.06^{*}12$

d1 = 4.74 inches (Use 5 inch thick asphalt)

Final Design (Within Rio Grande Blvd ROW)

Asphalt Concrete = 5" Base Course = 6" Subgrade = 12"



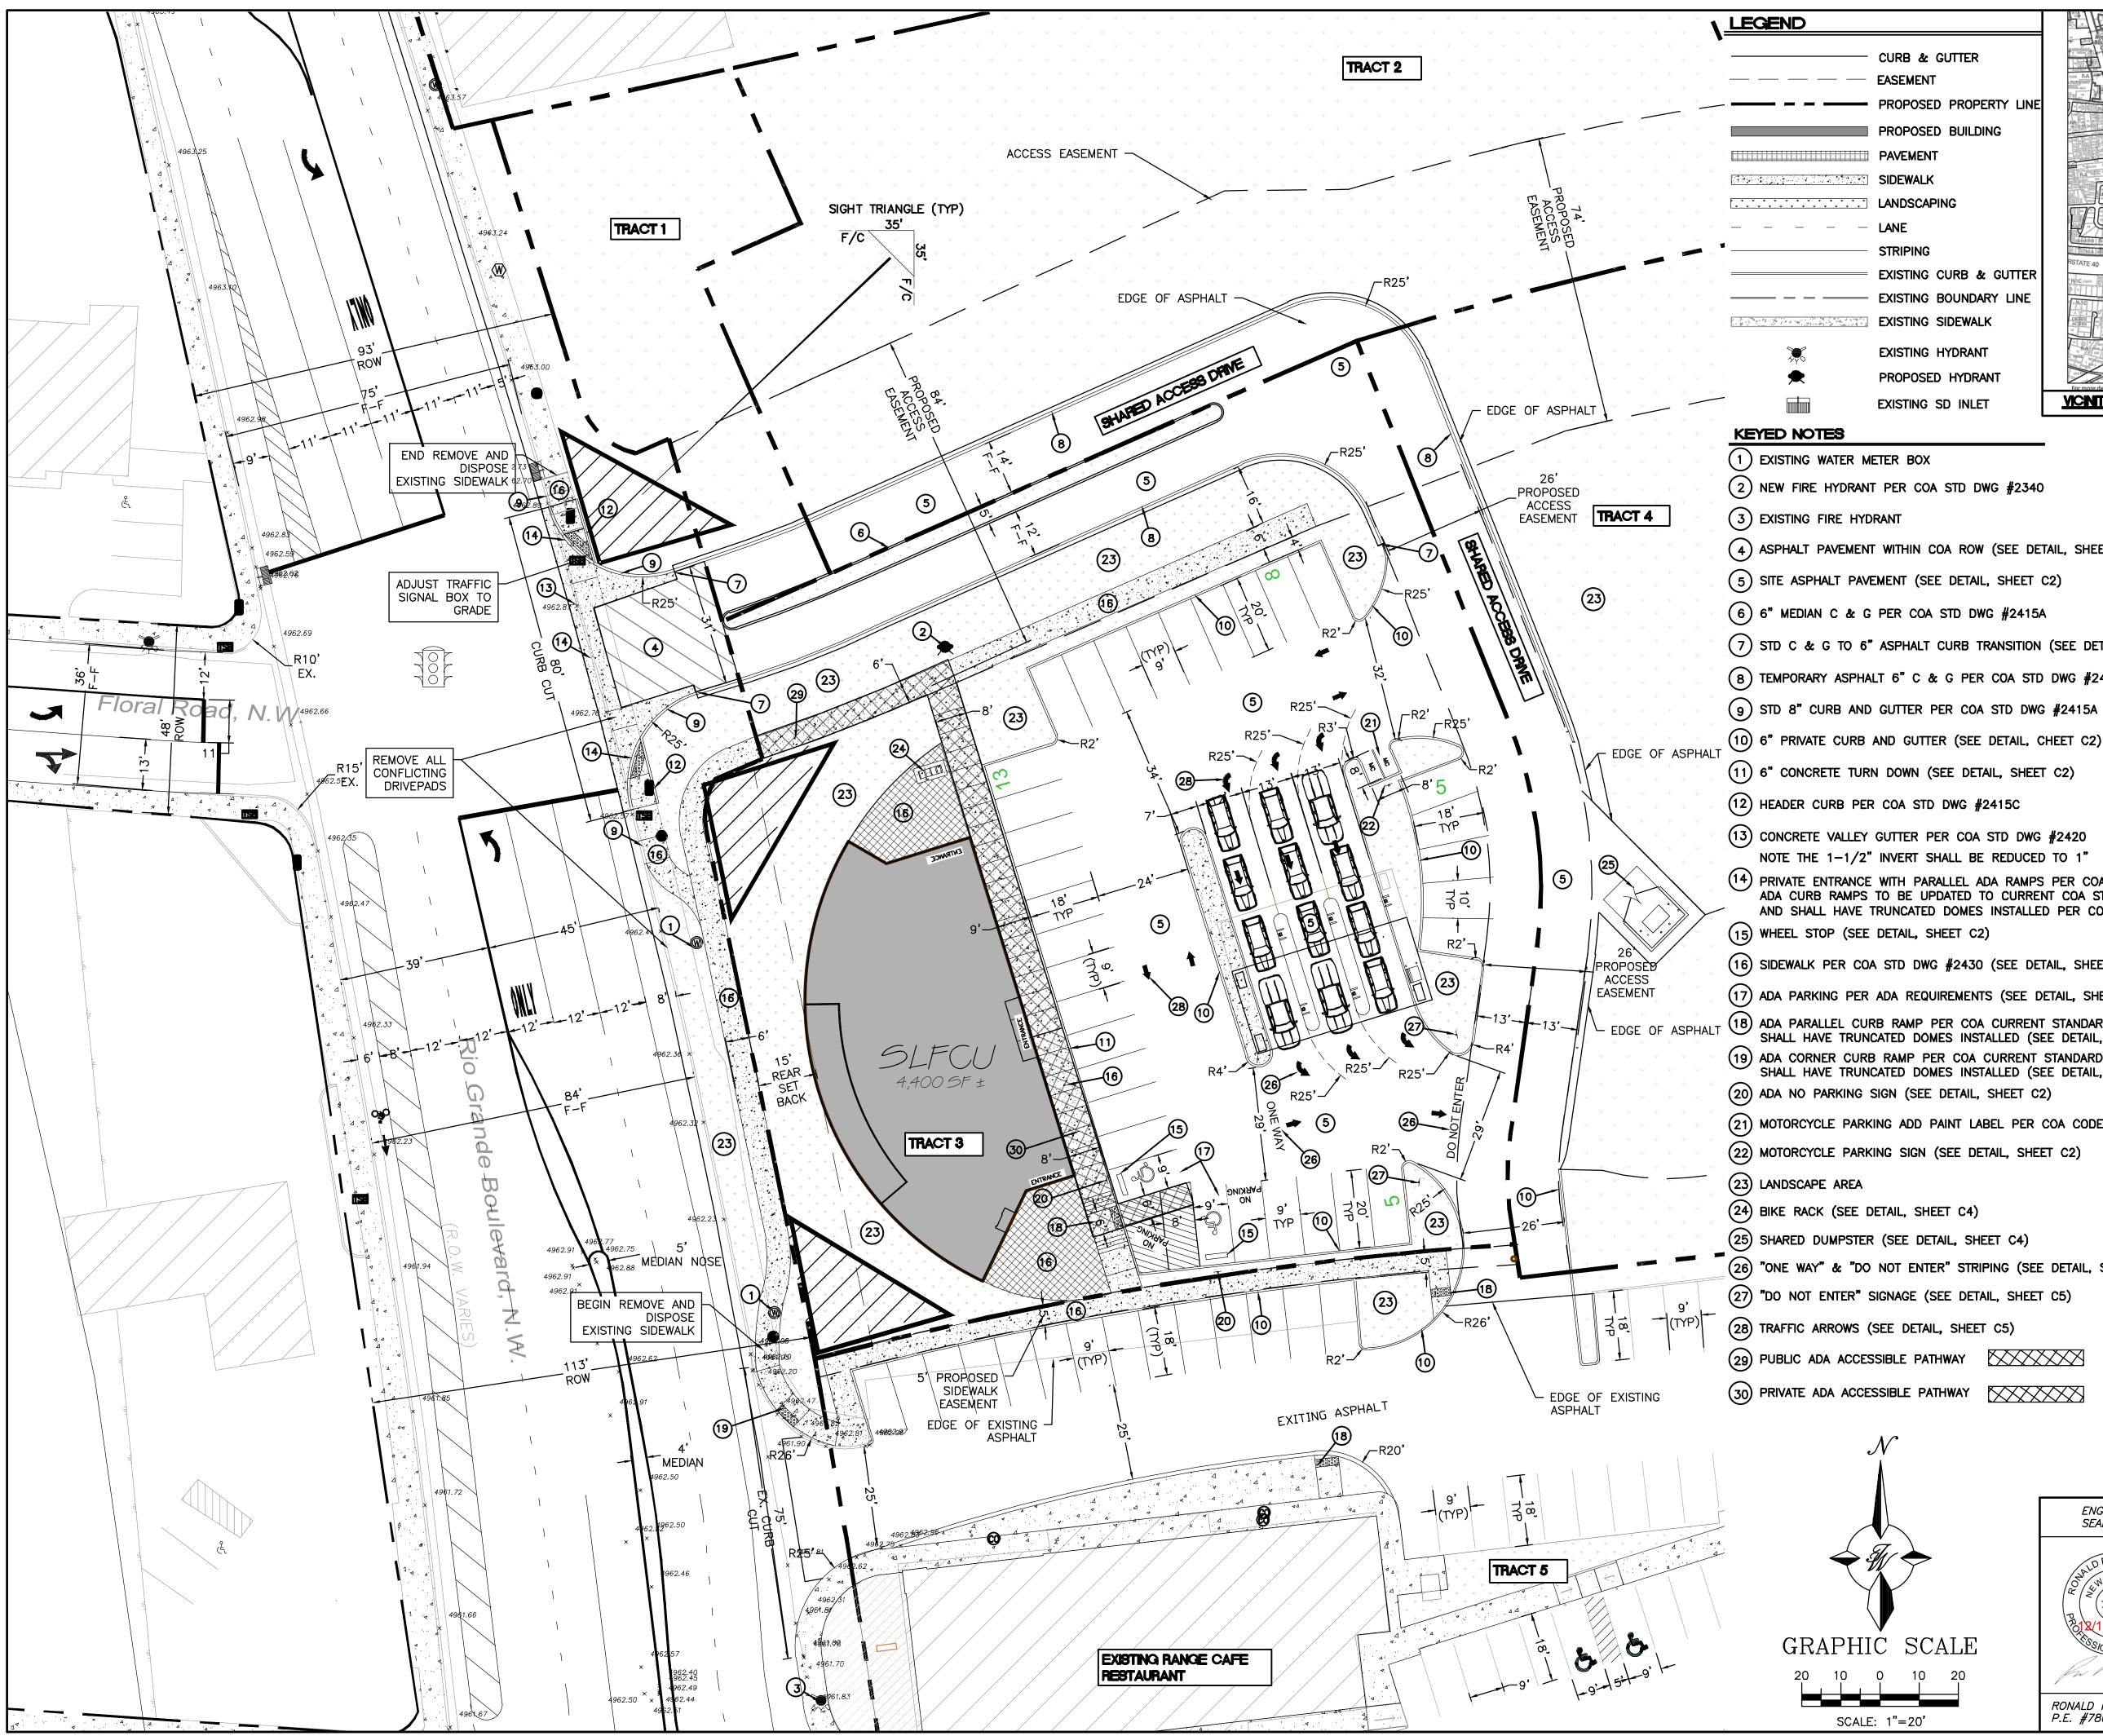

 CURB & GUTTER EASEMENT PROPOSED PROPERTY LINE PROPOSED BUILDING PAVEMENT SIDEWALK LANDSCAPING LANE STRIPING EXISTING CURB & GUTTER EXISTING BOUNDARY LINE EXISTING SIDEWALK EXISTING HYDRANT PROPOSED HYDRANT 	Rio Grande Rio Grande CO10 Rio Rei Constante CO10 Rio Rei Constante Rio Rei Constante Rio Rei Constante Rio Constante		PD C C C C C C C C C C C C C C C C C C C	N N
EXISTING SD INLET	For more details about the Integrated Development Ordin	ance visit: http://www.cabg.gov/planning/codes-policie	s-reculations/integrated-development-ordinance	H-13-Z
8				
ER METER BOX		SANDIA LABORATORY F	EDERAL CREDIT UNION (S	SLFCU)
		IDO ZONING:	MX-M	·
DRANT PER COA STD DWG #2340)	PROPOSED USAGE:	BUSINESS	
HYDRANT		LOT AREA:	40,530 SF (0.93 ACR	E)
EMENT WITHIN COA ROW (SEE DETAIL, SHEET C2) -		BUILDING AREA:	4,400 SF	
-	-		QUIRED: 13 (3 SPACES/	-
PAVEMENT (SEE DETAIL, SHEET	C2)	PARKING: SPACES PRO	DVIDED: 32 (INCLUDES HO	PARKING)

HC PARKING: SPACES REQUIRED: 2

HC PARKING: SPACES PROVIDED: 2

MC PARKING: SPACES REQUIRED: 1

MC PARKING: SPACES PROVIDED: 2

(1 PER 1-25 REQUIRED PARKING SPACES)

(3 SPACES OR 10% OF REQUIRED PARKING)

LANDSCAPE AREA PROVIDED: 7400 SF (18%)

LANDSCAPING AND SIGNAGE WILL NOT INTERFERE WITH CLEAR SIGHT REQUIREMENTS. THEREFORE, SIGNS,

WALLS, TREES AND SHRUBBERY BETWEEN 3 AND 8

FEET TALL (AS MEASURED FROM THE GUTTER PAN) WILL NOT BE ACCEPTABLE IN THE CLEAR SIGHT

. ALL CONFLICTING STRIPING SHALL BE ERADICATED BY

WATER BLASTING PER SECTION 443 OF THE COA

ACCORDANCE WITH THE MUTCD (CURRENT EDITION)

6. ALL LANE OR LANES STRIPING TO BE PREFORMED HOT

PREFORMED HOT APPLIED THERMOPLASTIC TAPE.

7. PAINT ALL MEDIAN CURB AND MEDIAN NOSE YELLOW

8. ALL IMPROVEMENTS LOCATED IN THE RIGHT OF WAY

REPLACED WITH SIDEWALK AND CURB AND GUTTER

STANDARD SPECIFICATIONS (LATEST EDITION).

3. ALL SIGNS TO BE COVERED WITH ANTI GRAFFITI

ALL SYMBOLS AND ARROWS STRIPING TO BE

(TYP) PER COA STANDARD SPECIFICATIONS.

MUST BE INCLUDED ON THE WORK ORDER

9. ALL BROKEN OR CRACKED SIDEWALK MUST BE

4. ALL SIGNS AND STRIPING SHALL BE MADE IN

SPECIFICATIONS AND COA STANDARDS.

APPLIED THERMOPLASTIC TAPE.

PER COA STANDARDS

BICYCLE PARKING: SPACES REQUIRED: 3

BICYCLE PARKING: SPACES PROVIDED: 4

(1 VAN ACCESSIBLE)

NOTES

TRIANGLE


COATING.


2.


- 5.


- (6) 6" MEDIAN C & G PER COA STD DWG #2415A
- (7) STD C & G TO 6" ASPHALT CURB TRANSITION (SEE DETAIL, SHEET C3)
- (8) TEMPORARY ASPHALT 6" C & G PER COA STD DWG #2415C
- 10 6" PRIVATE CURB AND GUTTER (SEE DETAIL, CHEET C2)
- (11) 6" CONCRETE TURN DOWN (SEE DETAIL, SHEET C2)
- (13) CONCRETE VALLEY GUTTER PER COA STD DWG #2420
- NOTE THE 1-1/2" INVERT SHALL BE REDUCED TO 1" (14) private entrance with parallel ada ramps per coa std dwg #2426 ADA CURB RAMPS TO BE UPDATED TO CURRENT COA STD'S AND SHALL HAVE TRUNCATED DOMES INSTALLED PER COA STD DWG #2446
- (16) SIDEWALK PER COA STD DWG #2430 (SEE DETAIL, SHEET C2)
- (17) ADA PARKING PER ADA REQUIREMENTS (SEE DETAIL, SHEET C2)
- (18) ADA PARALLEL CURB RAMP PER COA CURRENT STANDARDS #2443 AND SHALL HAVE TRUNCATED DOMES INSTALLED (SEE DETAIL, SHEET C4) (19) ADA CORNER CURB RAMP PER COA CURRENT STANDARDS #2441 AND SHALL HAVE TRUNCATED DOMES INSTALLED (SEE DETAIL, SHEET C4) (20) ADA NO PARKING SIGN (SEE DETAIL, SHEET C2)
- (21) MOTORCYCLE PARKING ADD PAINT LABEL PER COA CODE
- (22) MOTORCYCLE PARKING SIGN (SEE DETAIL, SHEET C2)
- (25) SHARED DUMPSTER (SEE DETAIL, SHEET C4)
- (26) "ONE WAY" & "DO NOT ENTER" STRIPING (SEE DETAIL, SHEET C5)
- (27) "DO NOT ENTER" SIGNAGE (SEE DETAIL, SHEET C5)
- (29) PUBLIC ADA ACCESSIBLE PATHWAY
- "PRELIMINARY NOT FOR CONSTRUCTION"


	ENGINEER'S SEAL	RIO GRANDE + 1-40	<i>DRAWN BY</i> RG
$\langle \mathcal{A} \rangle$	ALD R. BOHAN	PHASE 1 TRAFFIC CIRCULATION	<i>DATE</i> 10-8-2020
	C T868	LAYOUT PLAN	<i>DRAWING</i> 2012100-SP -SLFCU
V PHIC SCALE	812/15/2020 4	TIERRA WEST, LLC	SHEET #
10 0 10 20	for telle	5571 MIDWAY PARK PL NE ALBUQUERQUE, NEW MEXICO 87109	
SCALE: 1"=20'	RONALD R. BOHANNAN P.E. #7868	(505) 858–3100 www.tierrawestllc.com	<i>JOB #</i> 2012100

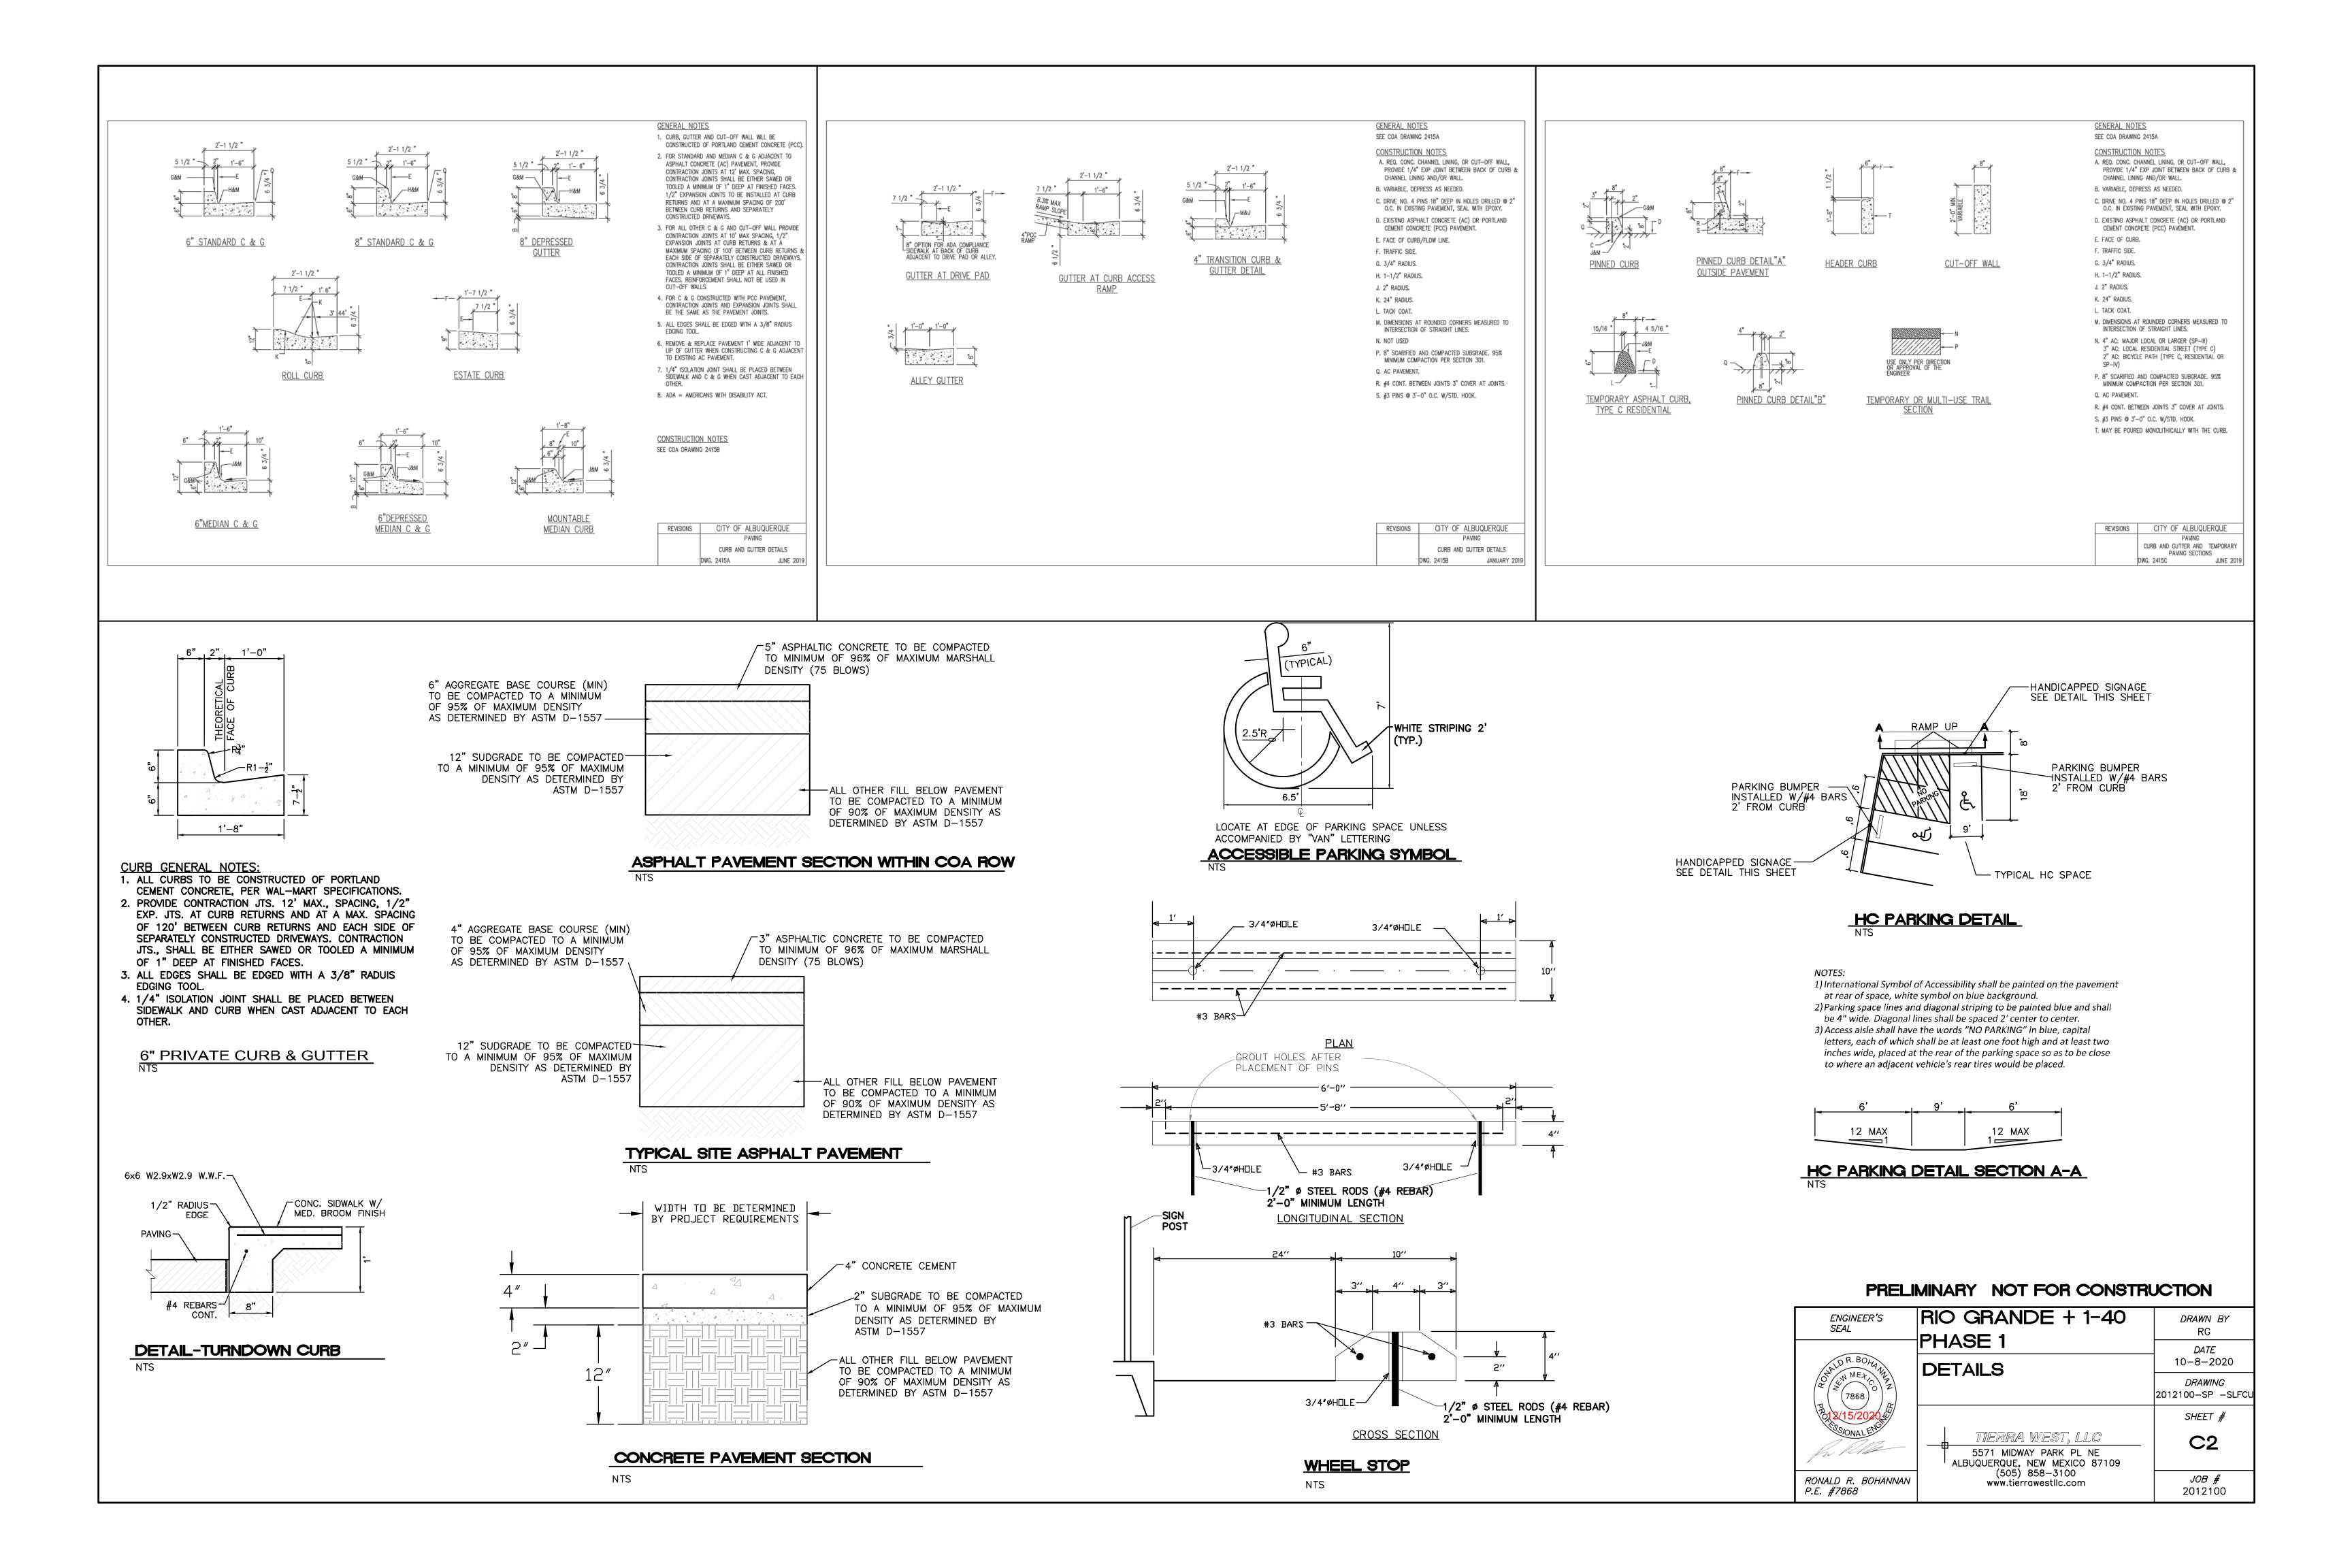


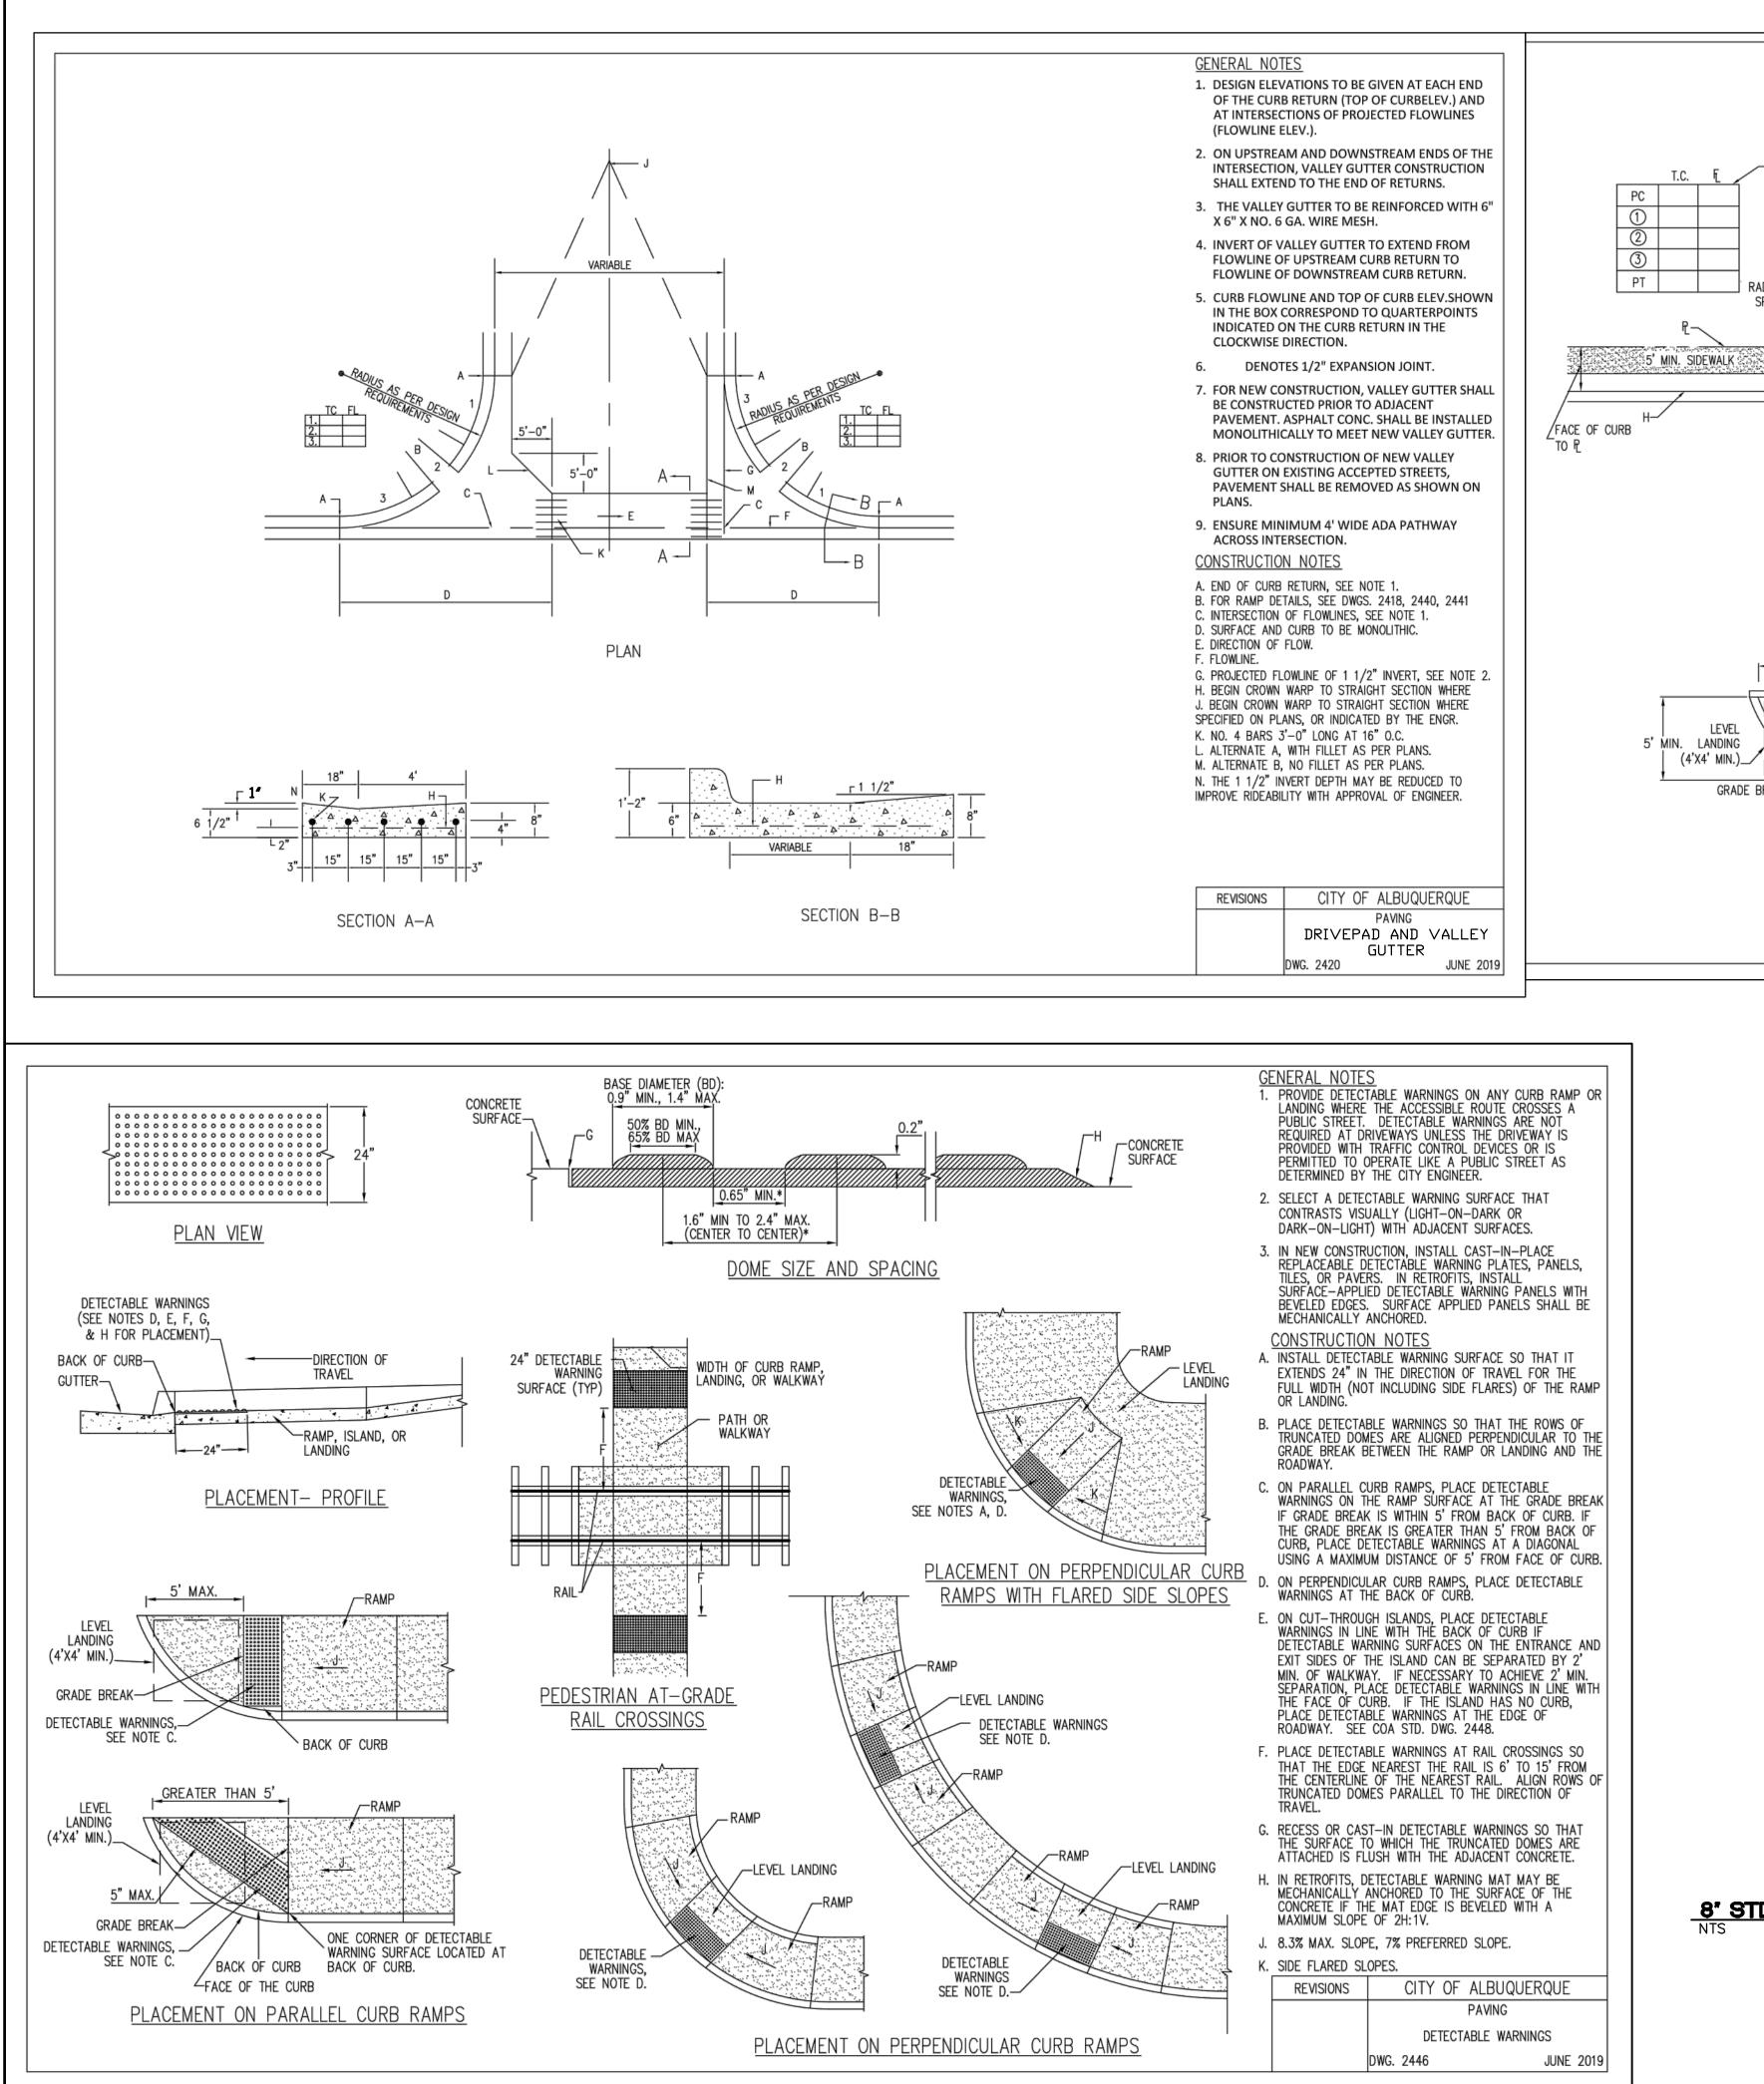


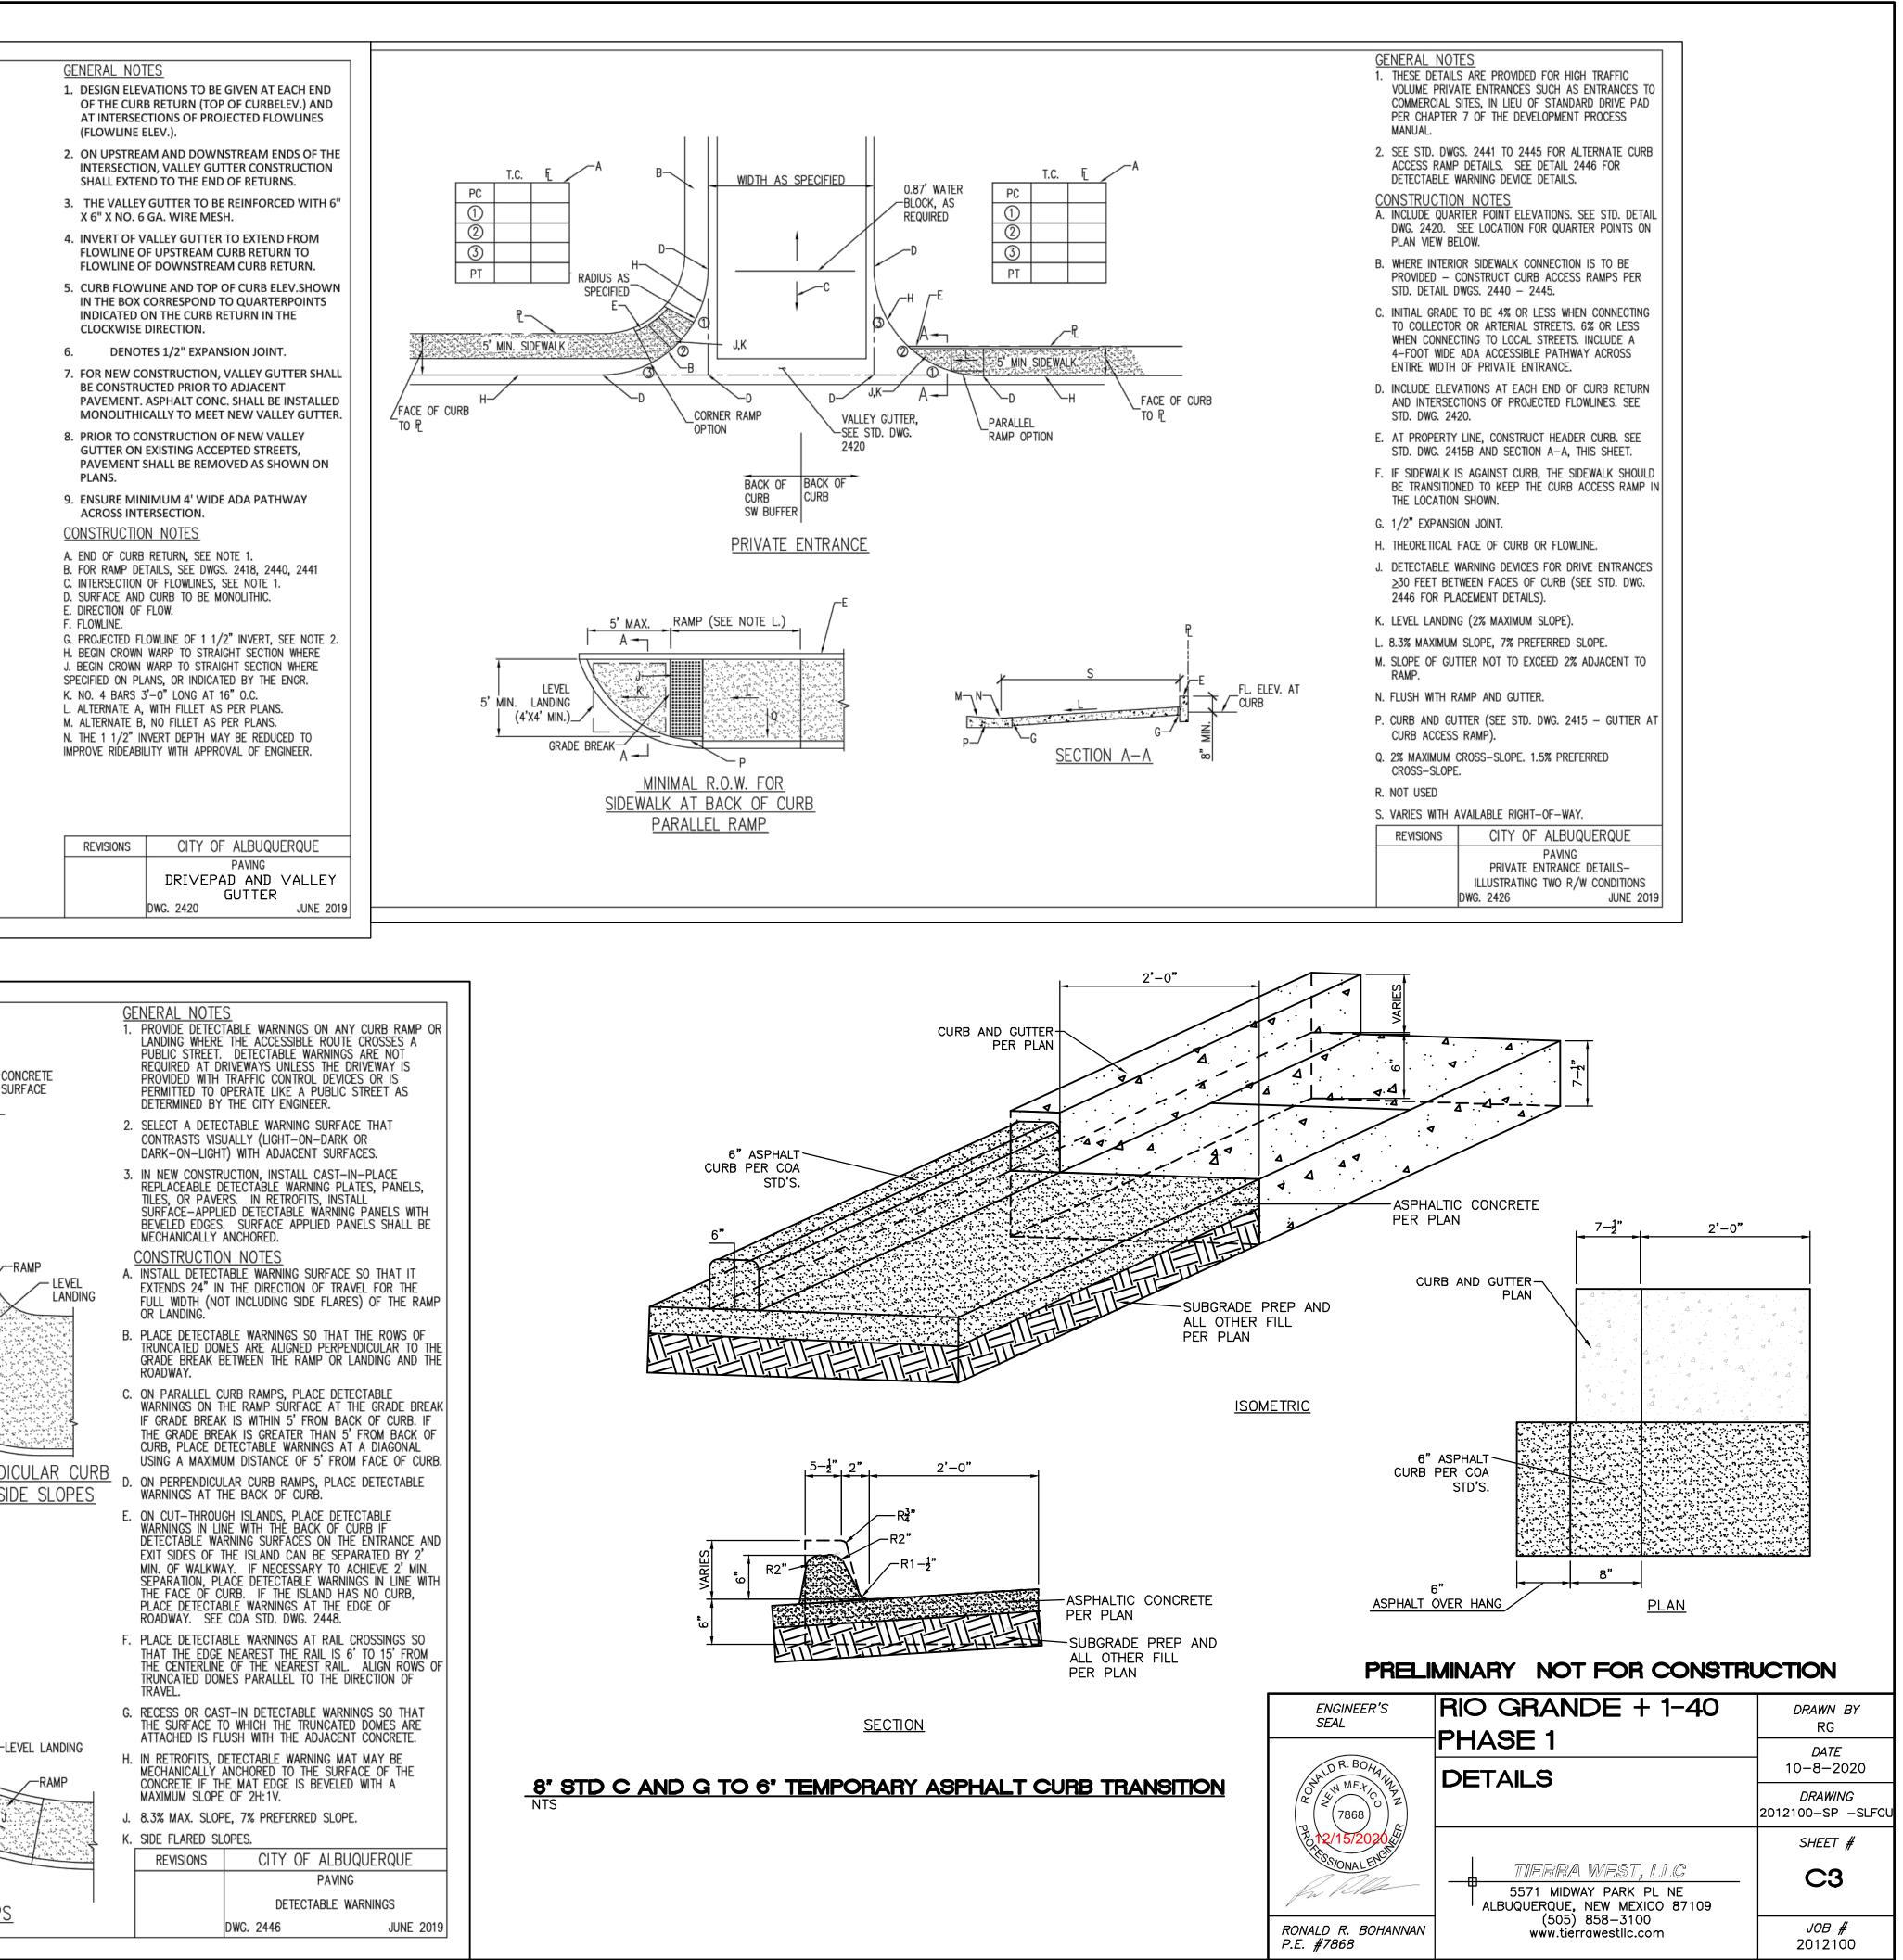


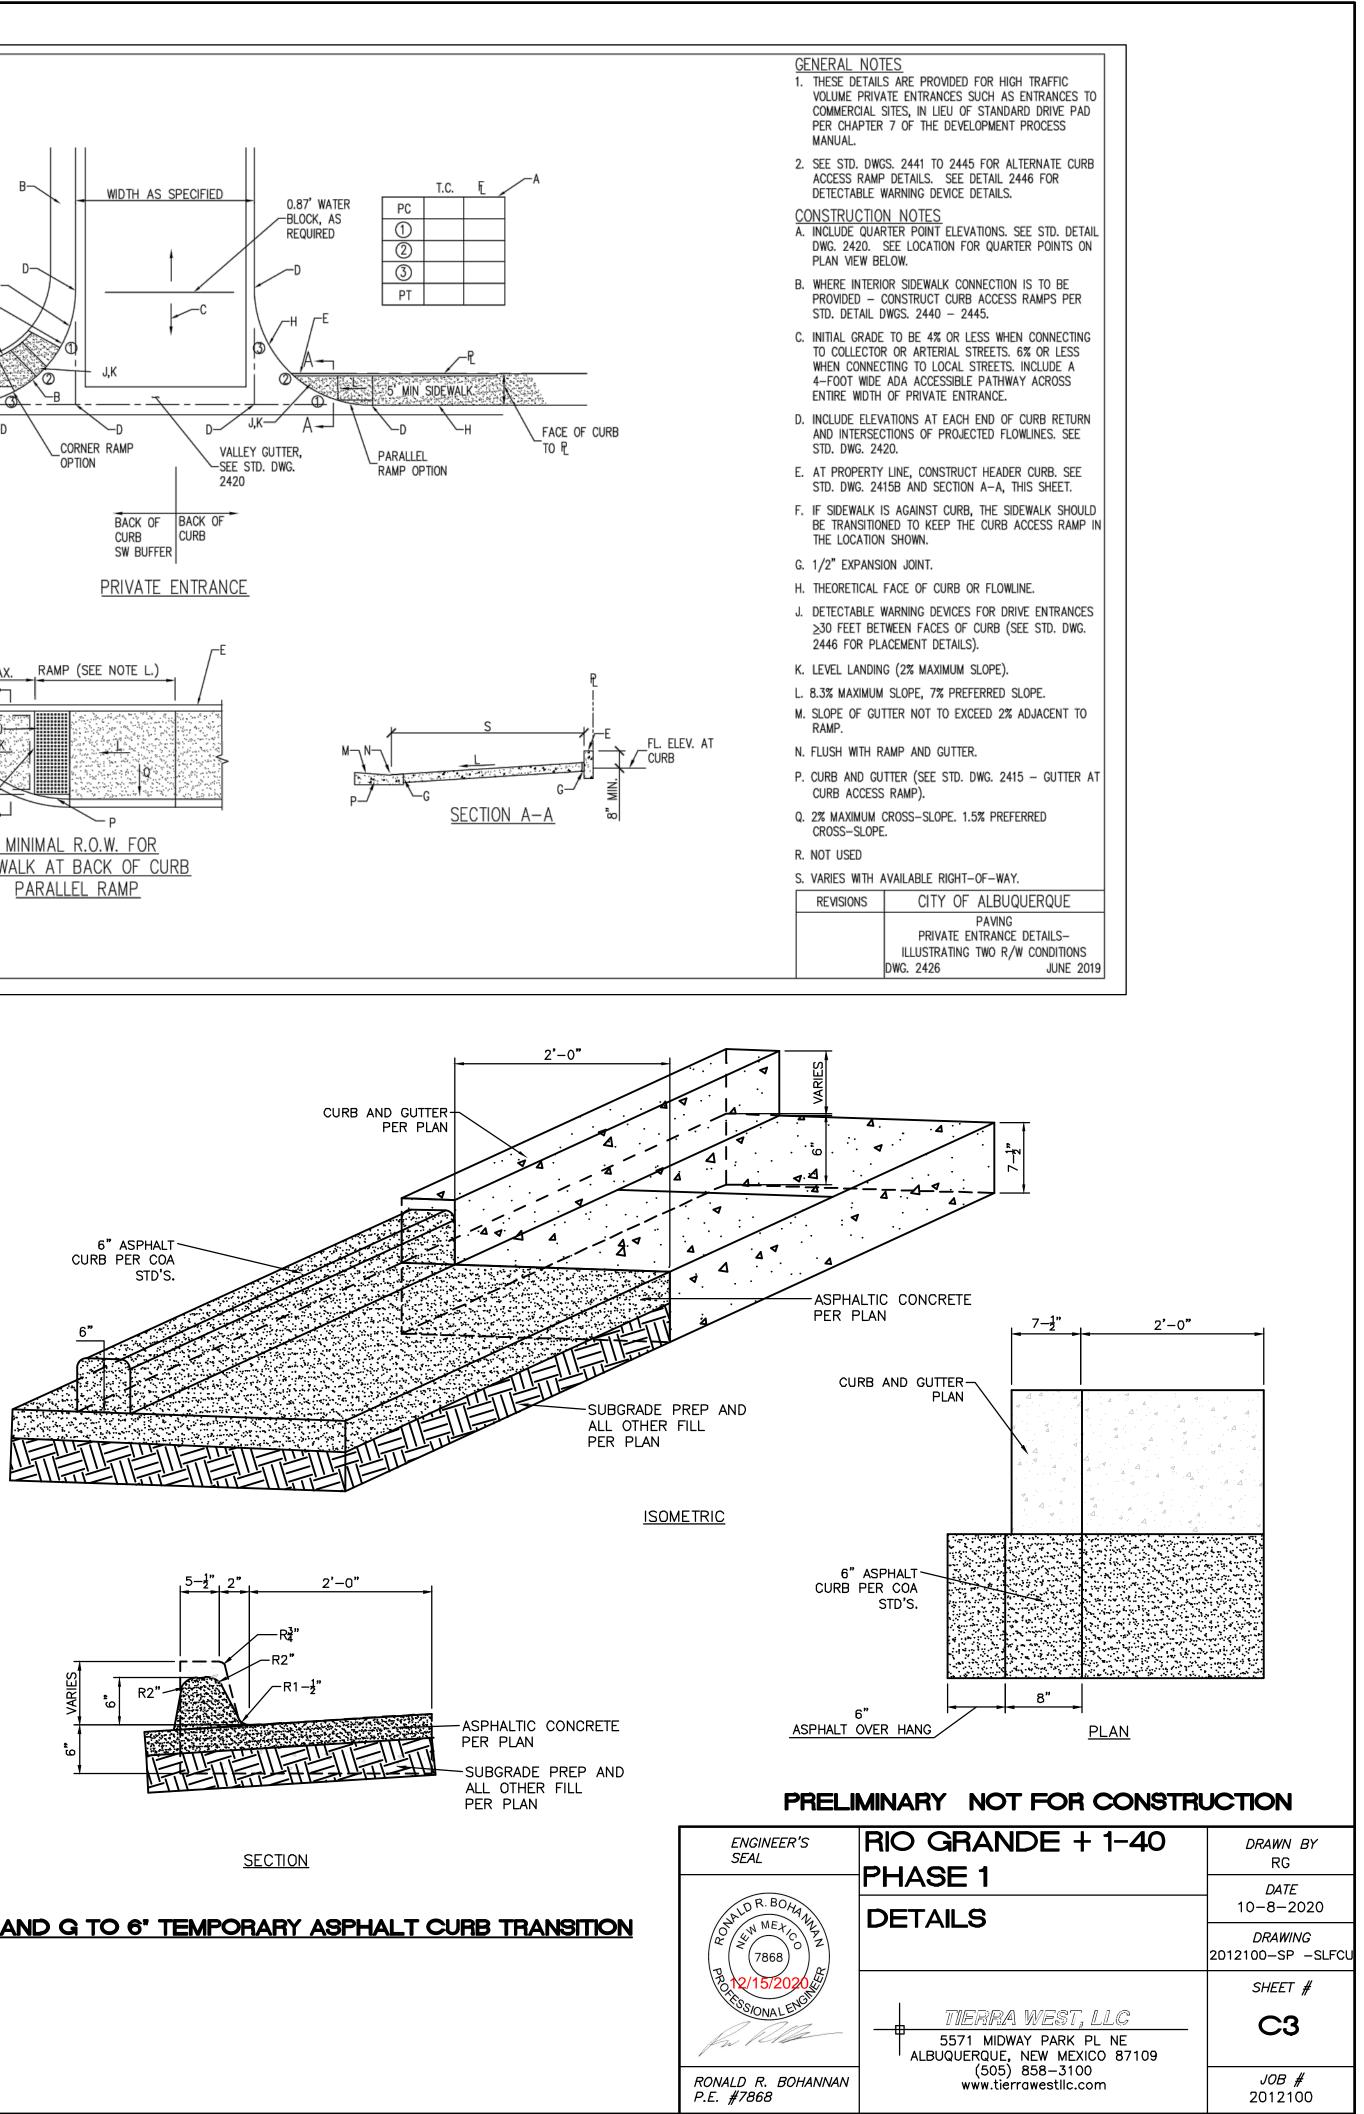


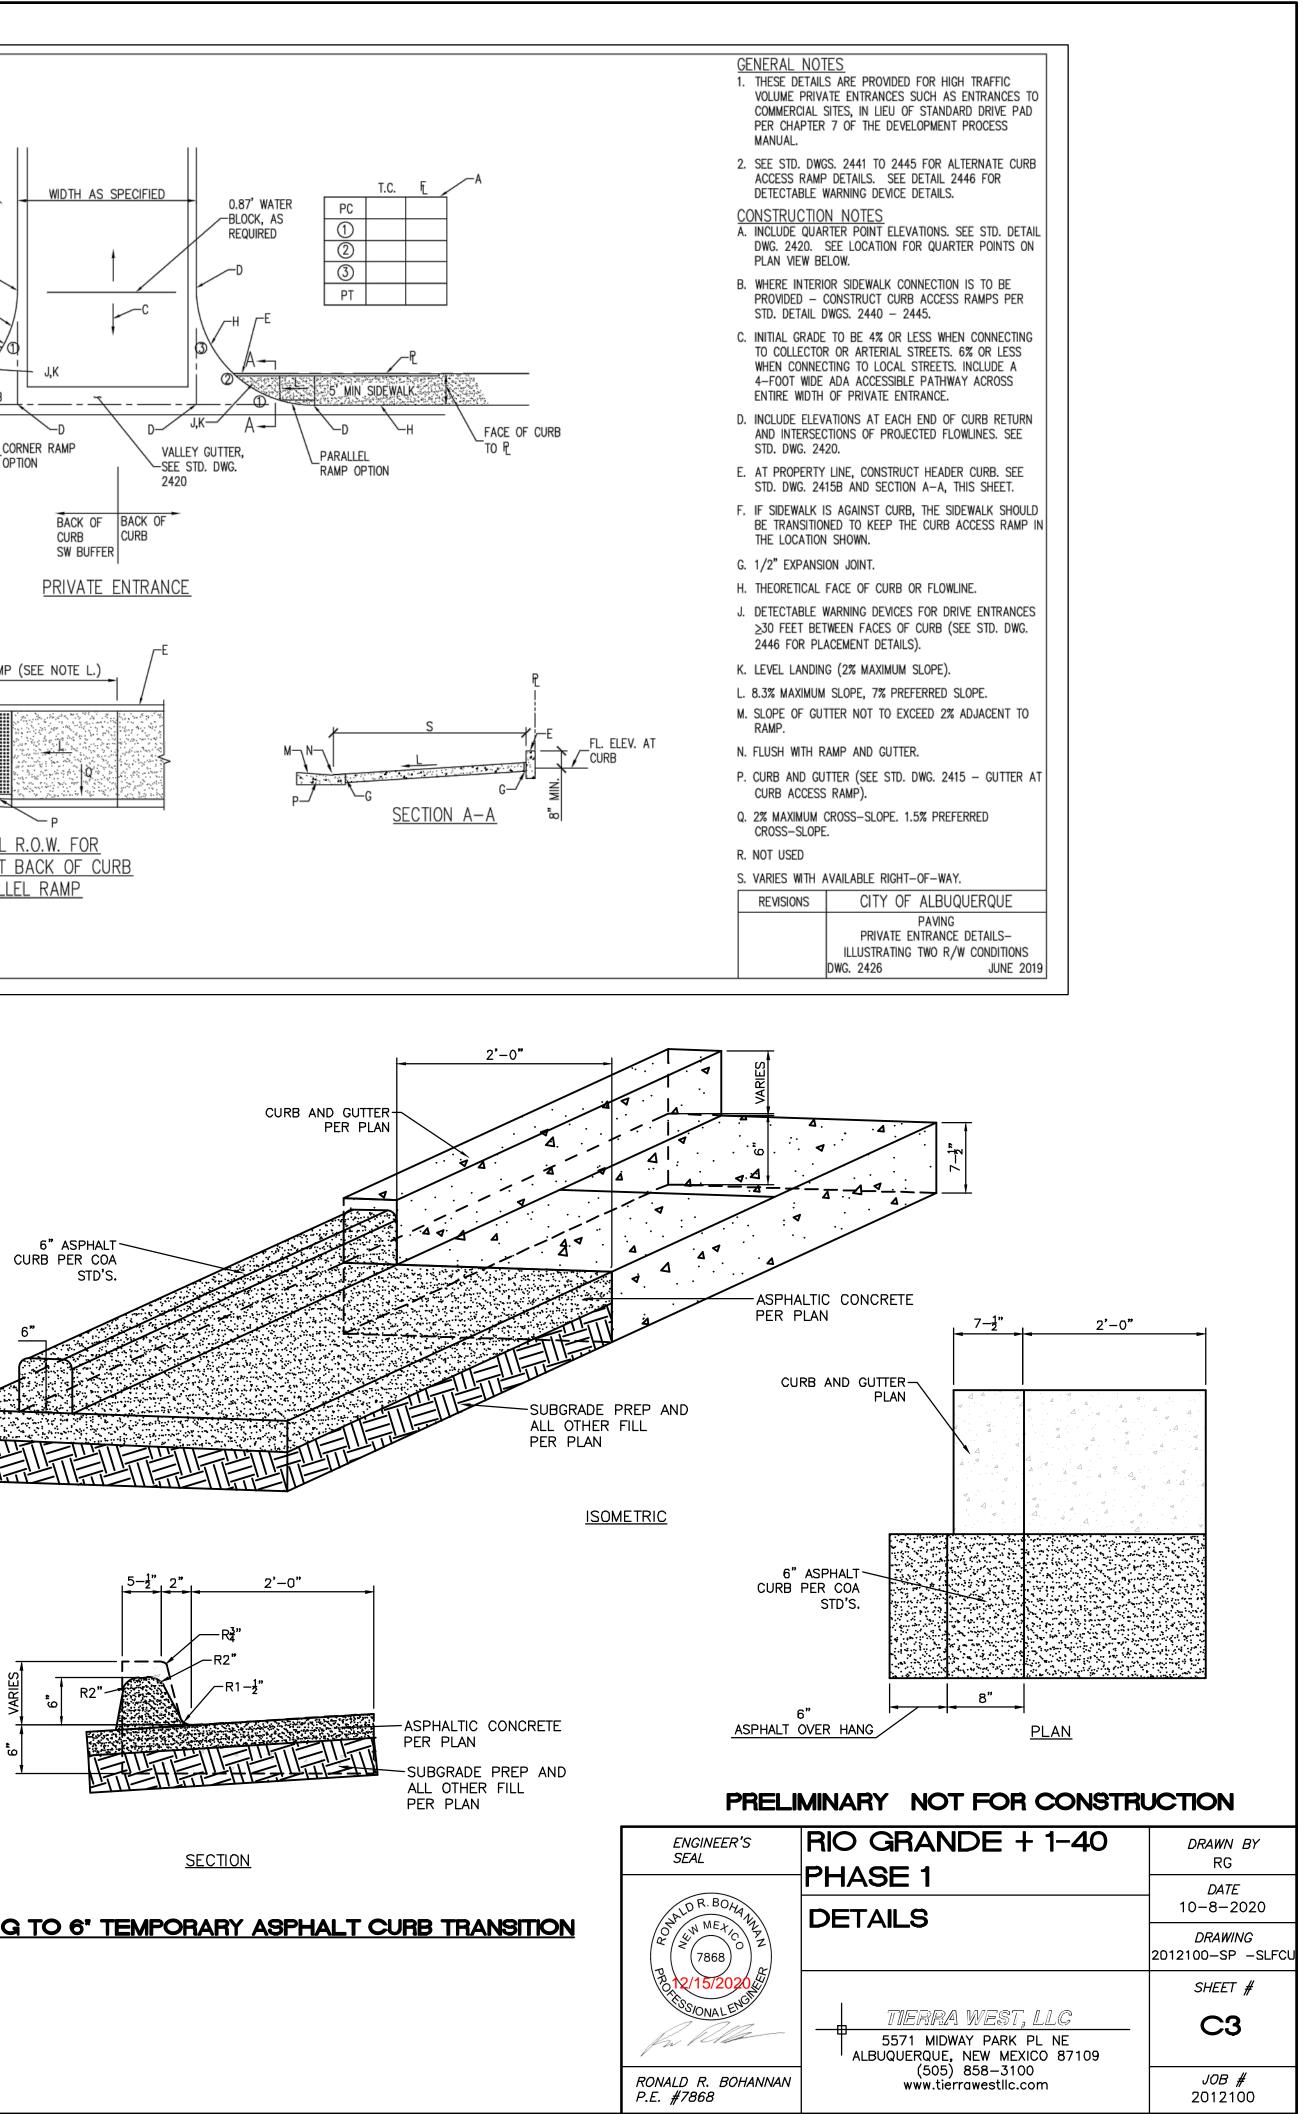

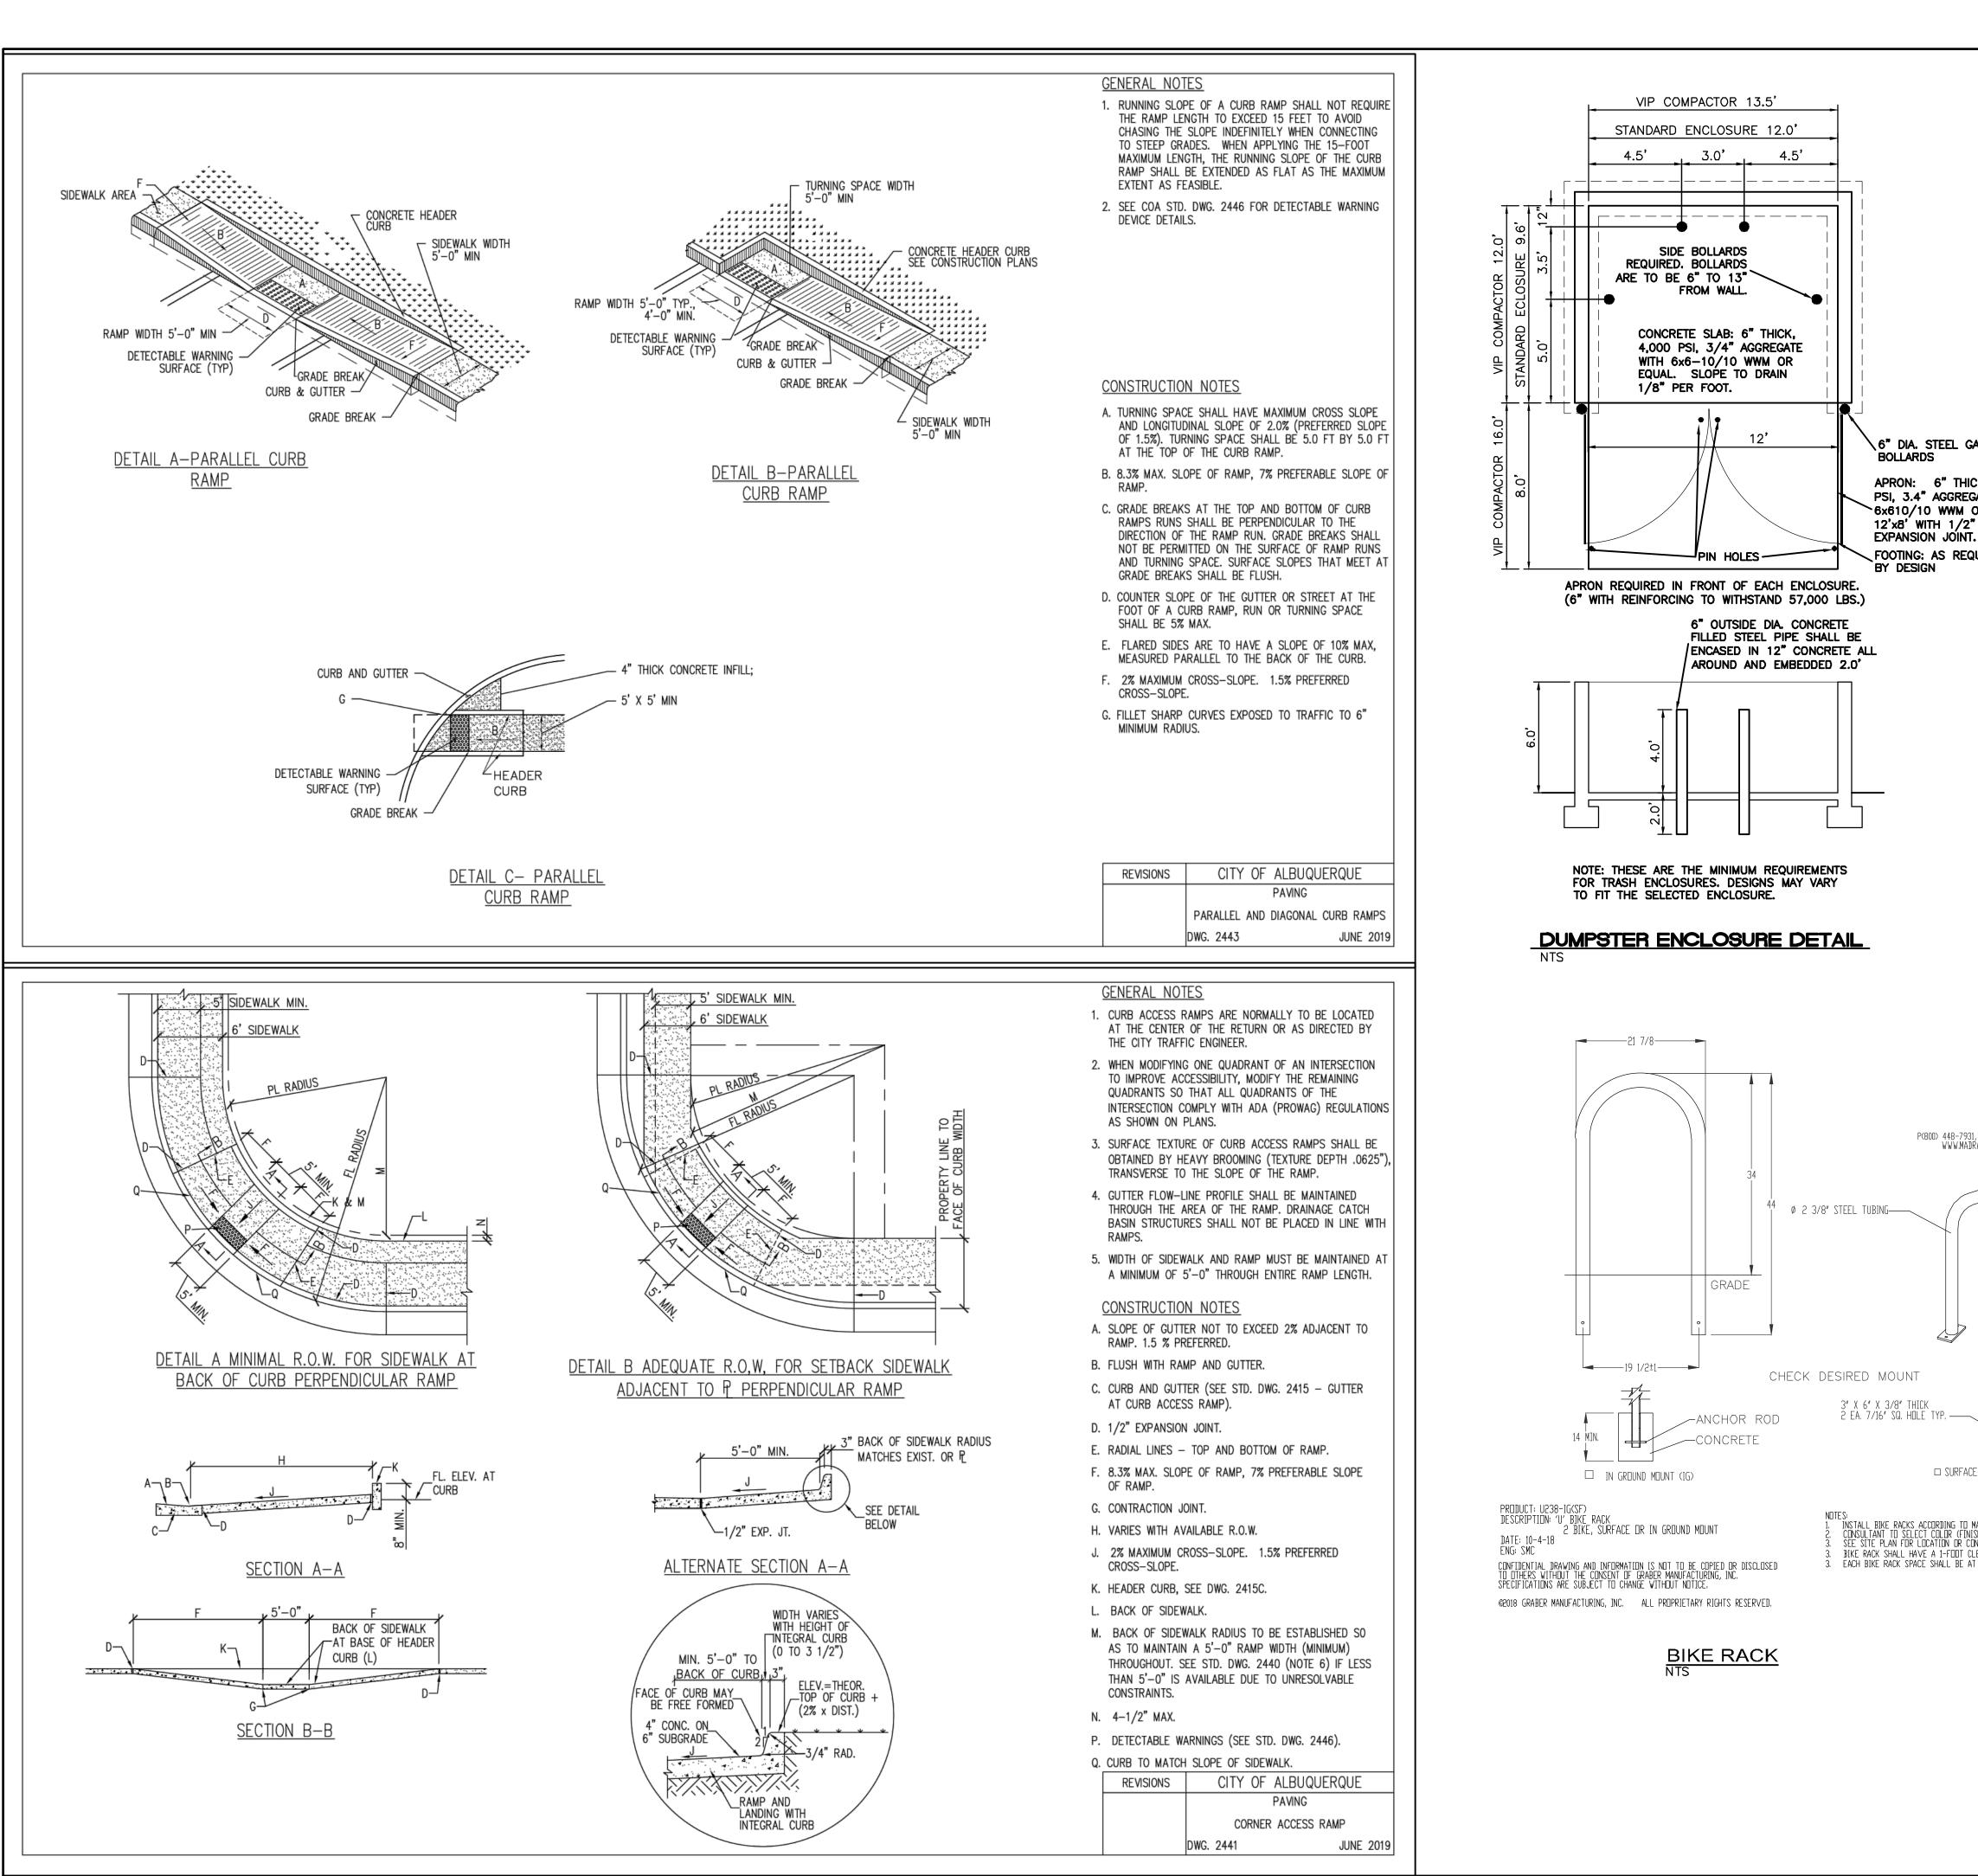


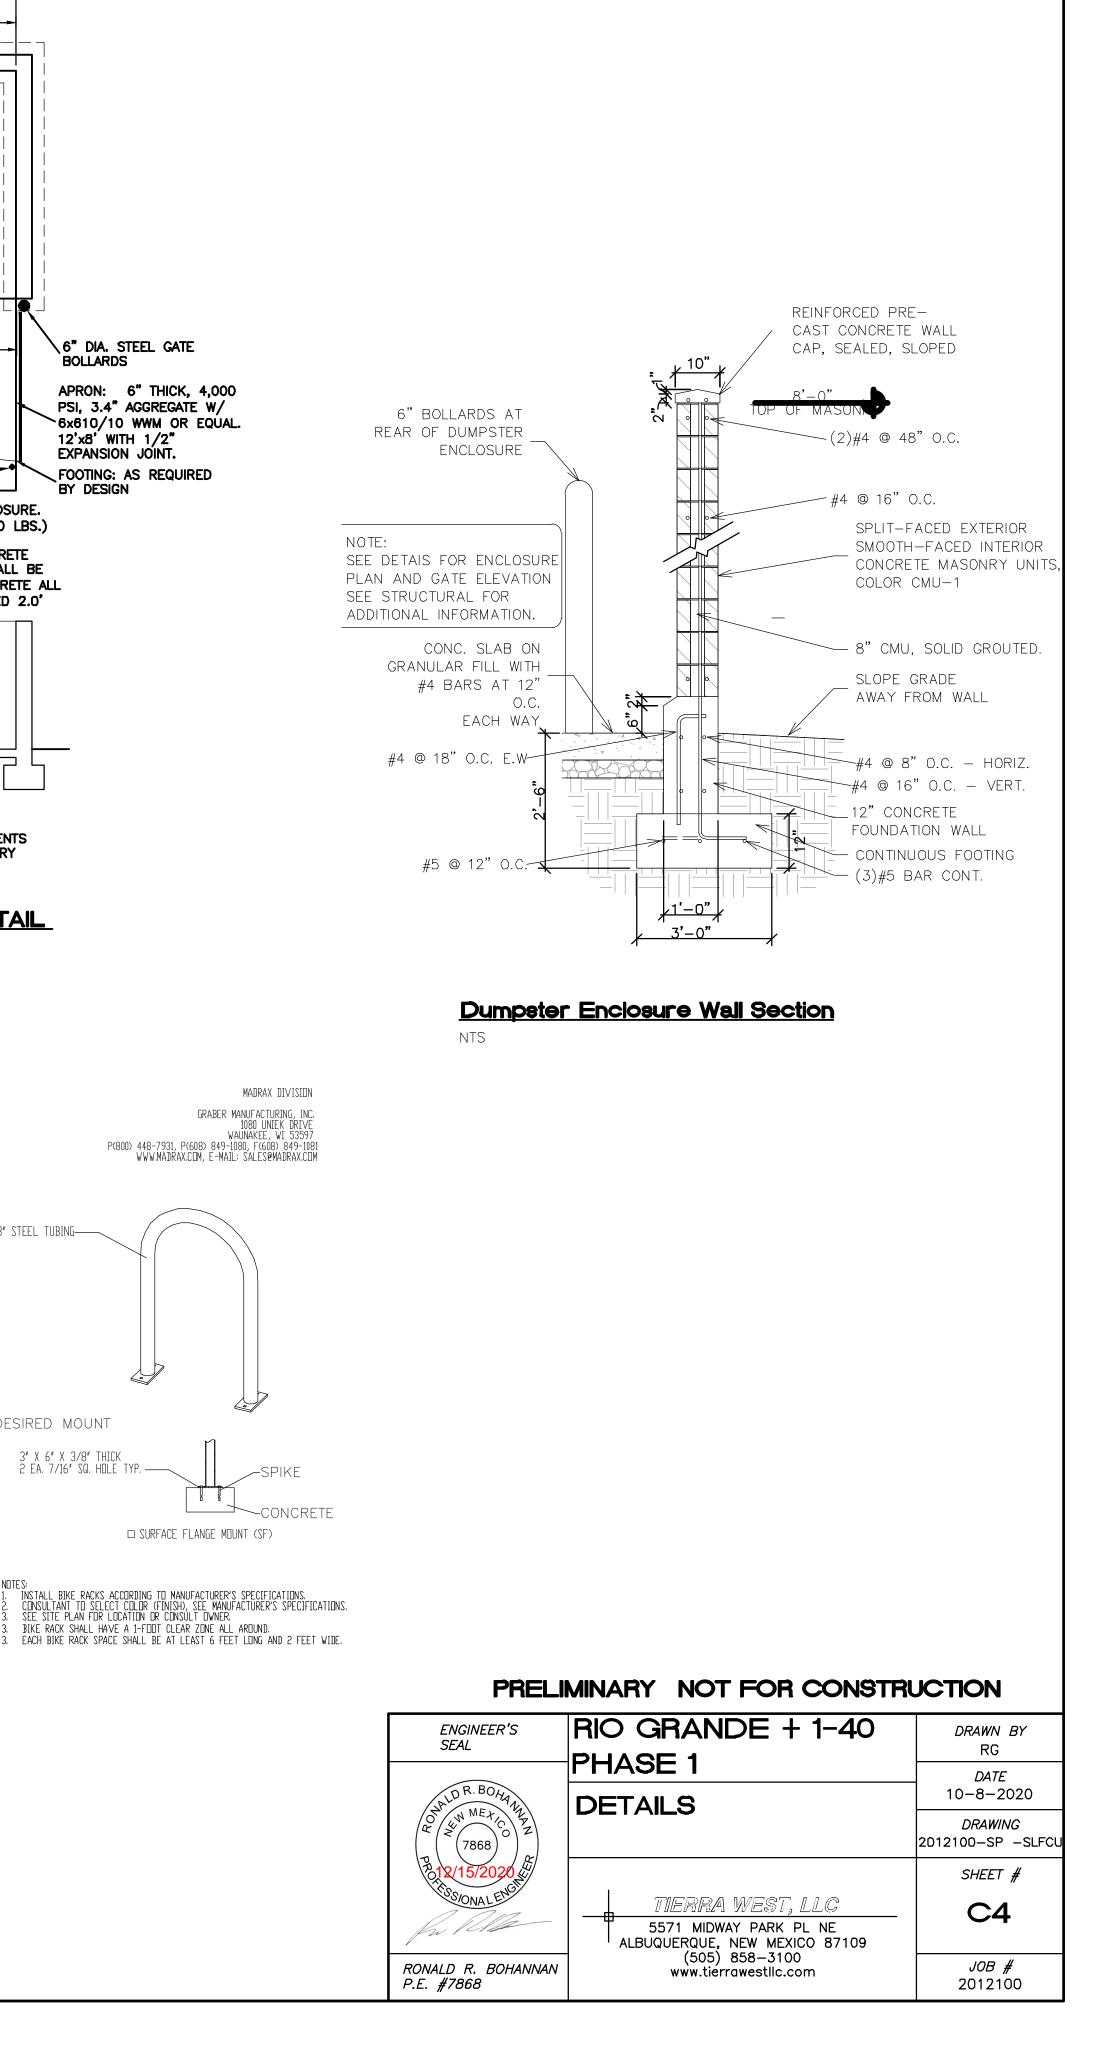

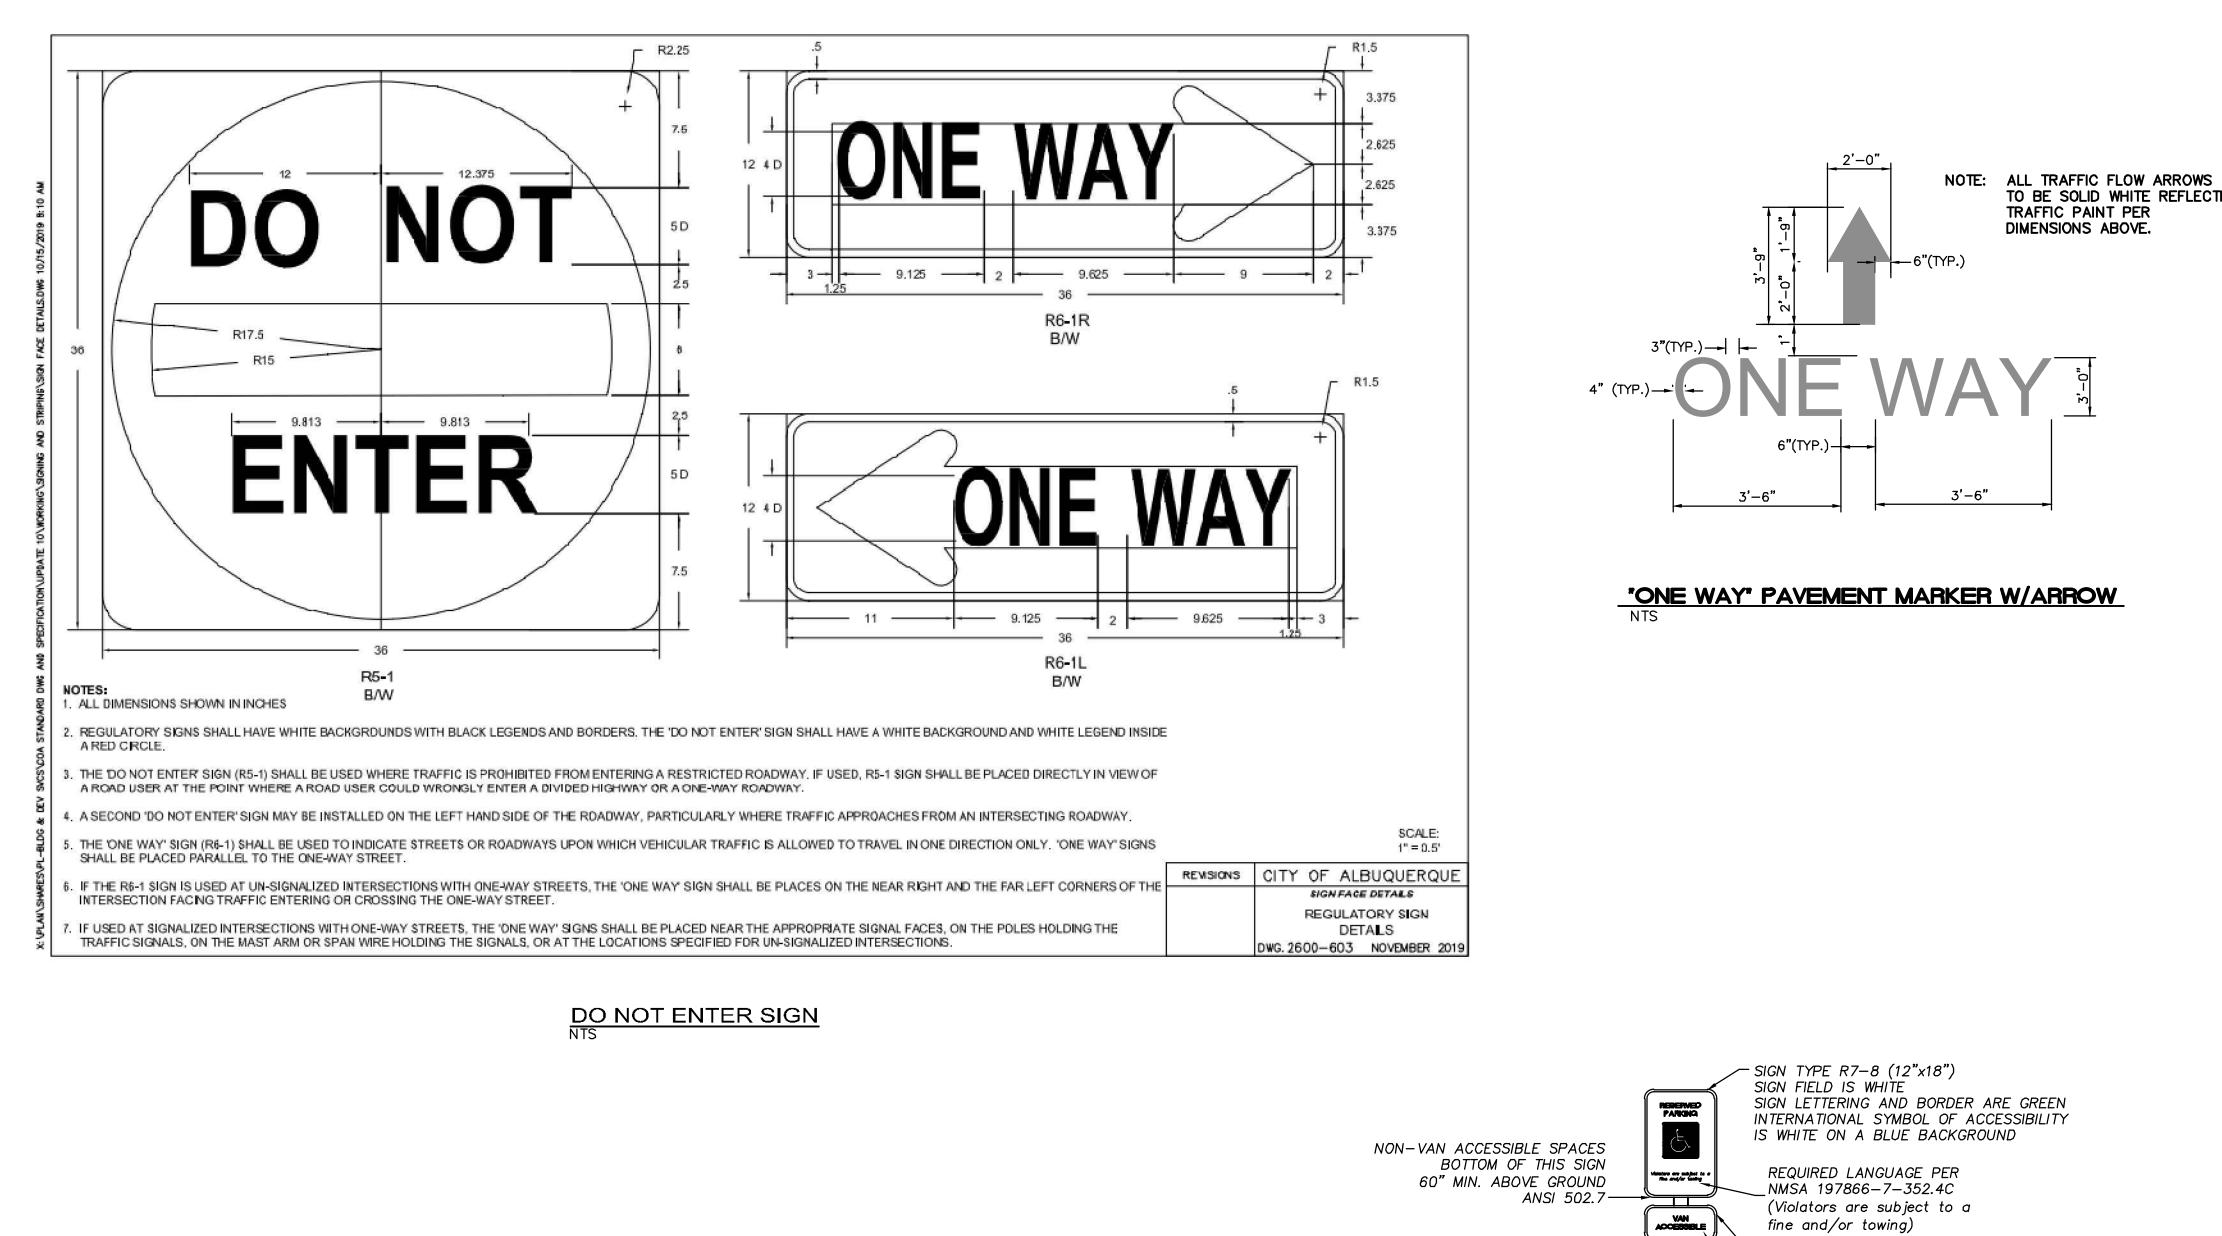

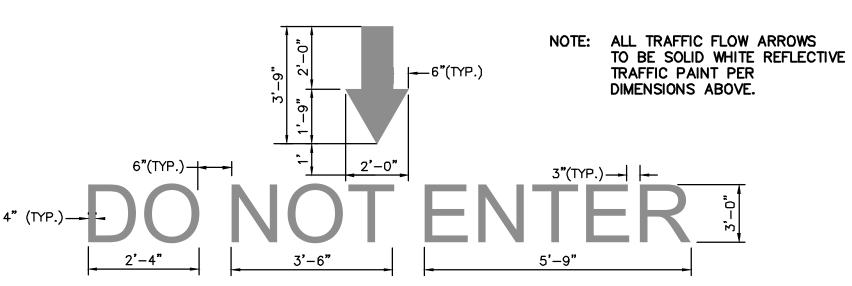


DO NOT ENTER PAVEMENT MARKER W/ARROW NTS

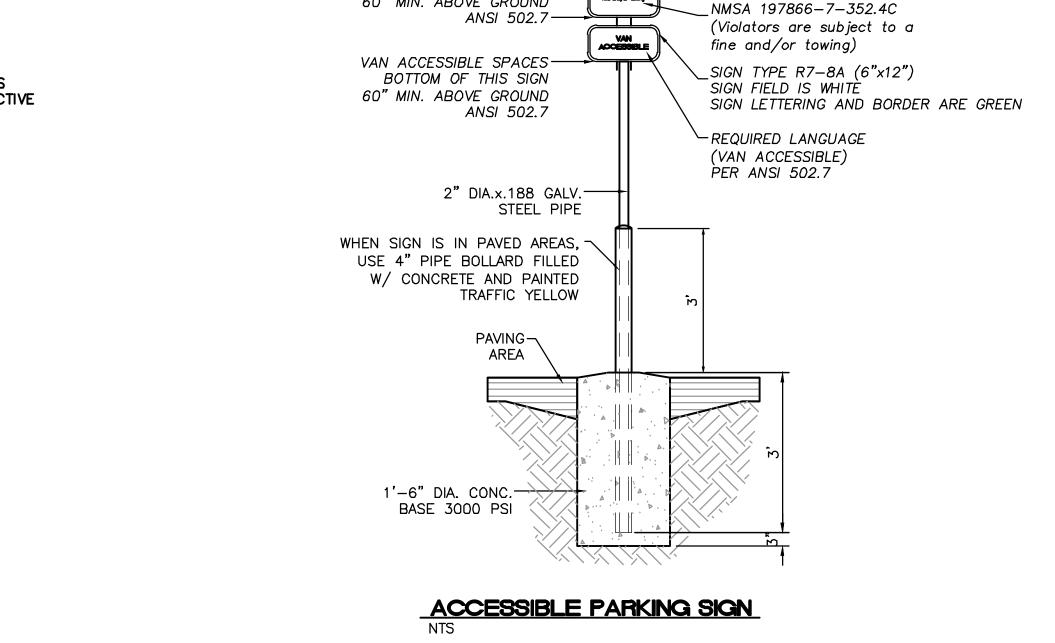

TRAFFIC PAINT PER

DIMENSIONS ABOVE.

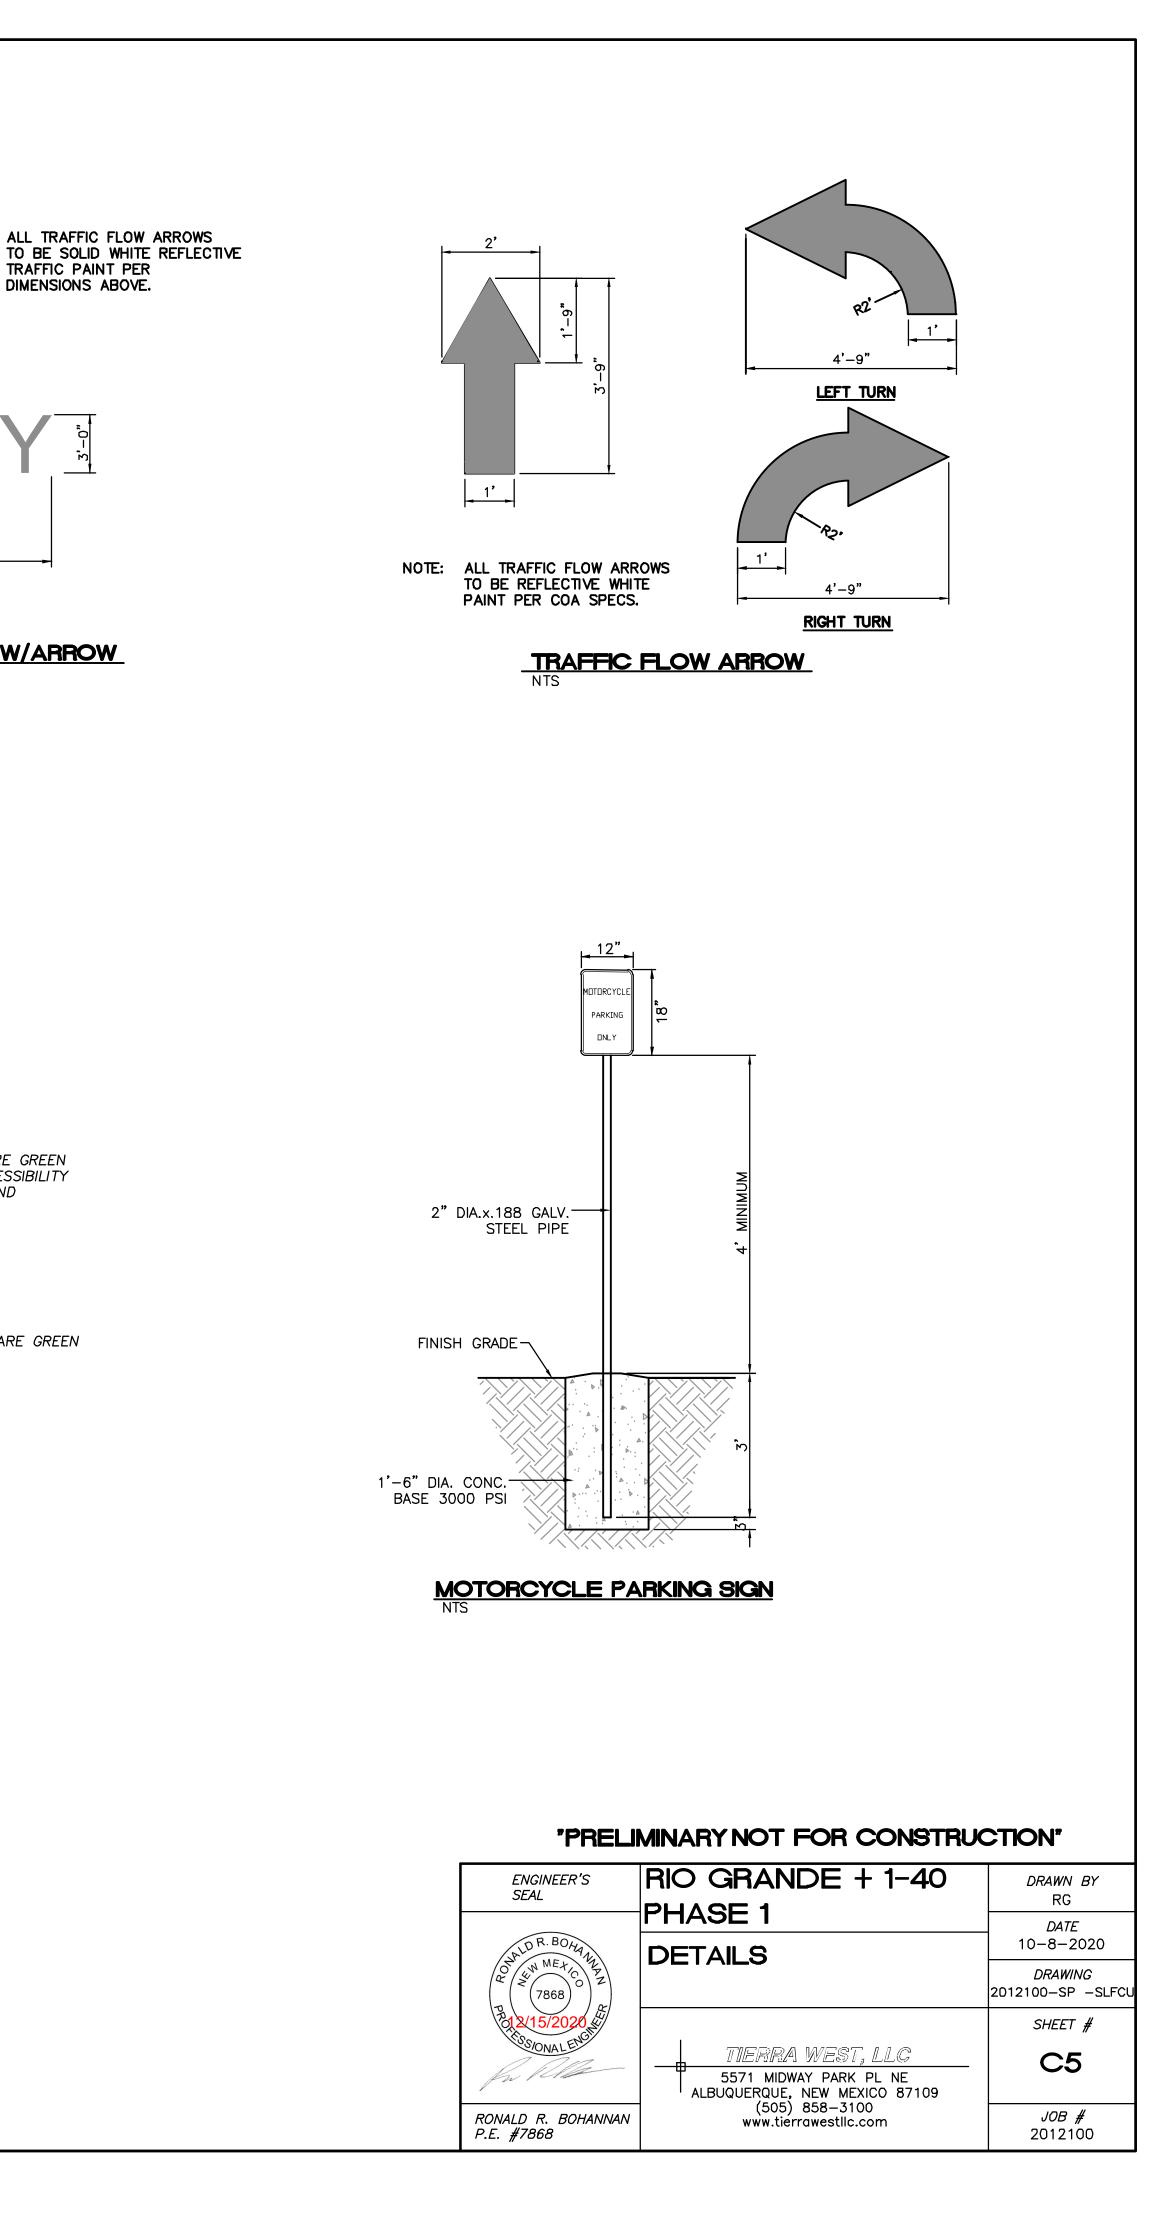



TIERRA WEST, LLC

December 15, 2020

Mr. Nilo Salgado-Fernandez, P.E. Development Review Services PO BOX 1293 Albuquerque, NM 87103

RE: SANDIA LAB FCU 1100 RIO GRANDE BLVD NW TRAFFIC CIRCULATION LAYOUT COMMENTS DATED: NOVEMBER 17, 2020

Dear Salgado-Fernandez

Per the correspondence dated November 17, 2020, please find the following responses addressing the comments listed below:

- ADA curb ramps must be updated to current standards and have truncated domes (add to keyed note 7) installed.
 Response: Keyed note 7 updated, Language added to keyed note #14, 18 and 19.
- 2. Motorcycle parking spaces: Label pavements MC. Response: Pavement Labeled "MC"
- All one-way drives shall have "One Way" and "Do Not Enter" signage and pavement markings. Provide details of posted signed and striping.
 Response: See Keyed Note #26 and #27, Signage face and striping details added to sheet C5.
- 4. Provide a way arrows for the proposed drive thru lanes on orientation. **Response: Traffic flow arrows added to site plan, details provided on sheet C5.**
- 5. Please specify the City Standards Drawings Number when applicable. **Response: 2020 city standard numbers added as applicable.**
- 6. Shared Site access: driveways that straddle property lines, or are entirely on one property but are to be used by another property, shall have an access easement. Please include a copy of your shared access agreement with the adjacent property owner. If there is an approved plat, then it needs to be provided to redefine the new lot lines. Please address this issue and/or an approved plat submitted. <u>Condition of TCL Approval.</u> Response: A copy of the approved plat and shared access agreement will be supplied as condition of approval.
- Private access easement on plat need to be shown as well as, all beneficiaries, maintenance responsibilities must be shown/listed on an approved plat. An approved is required prior to <u>TCL / Building Permit approval.</u> Response: A copy of the approved plat is fore coming and will be supplied as a condition of approval.
- Keyed note 20 (both sides) and DO NO ENTER (pavement markings) will need to be provided at exit onto shared access road.
 Response: See updated TCL plan

5571 Midway Park Pl. NE Albuquerque, NM 87109 505) 858-3100 fax (505) 858-1118 1-800-245-3102 tierrawestllc.com

- You will need to coordinate with Traffic Operations on the existing signal to assure that the correct phasing and cycle length are appropriate for the proposed development.
 Response: Acknowledged
- 10. You are proposing temporary asphalt curbing onto the proposed site development why? And need to provide detail on how you will connect a STD C&G asphalt curbing. You will need to provide concrete (STD C&G) at the proposed curb return to your site development lot. Response: Temporary asphalt curbing is proposed due to the fact that the access drive will need to be modified in the near future to accommodate future developments in the area. See keyed note #7, and a STD C&G to asphalt curb transition detail is provided on sheet C3. Standard C&G will be provided at the curb return, see updated TCL.
- Entrance access: is 12ft adequate enough to handle any delivery / Refuge vehicles entering and existing for its temporary condition? Verify.
 Response: See sheet E4 Truck turning exhibit, lane widths were updated accordingly.
 Design vehicle used was SU-30 per DPM.
- 12. Construction removal / build notes are in conflict with keyed note 16 at Rio Grande frontage. **Response: Keyed note removed**
- 13. Keyed Note 6: Call out sidewalk per COS STD DWG 2430 instead of concrete pavement. **Response: keyed note #6 updated, See keyed note #16.**
- Keyed Note 8: COA STD DWG 2443 is reference, but there is no such number. Please provide separate detail.
 Response: See keyed note #18, detail provided on sheet C4
- 15. Keyed Note 12: References 2415C, there is no such number. Clarify. **Response: Keynote #12 changed to #8, reference number was taken from COA section** 2400 Standard Details for Paving Update No. 10 (Revised March 2020), detail provided on sheet C2.
- 16. You are referencing COA STD DWG 2600 (NM DOT) please provide all these details. **Response: Standard details taken from COA Standard detail drawings – Section 2600 at cabq.gov. Separate details have been provided as replacements.**
- Proposed keyed note 7 needs to connect to propose keyed note 6 and add truncated dome verbiage to the note 7.
 Response: Site plan updated and keyed note # 7 changed, see keyed note # 14, verbiage added to keyed note #14.
- 18. Since you are building to the southern property, then the corner ramp will need to be replaced and a detail provide on how you will connect / tie-in new concrete onto existing ramp without interfering with ADA slopes. Response: See exhibit 5, ramp will be replaced and new sidewalk connection will not interfere with ADA slopes.
- 19. Proposed median entrance: Why have you set the median nose back and proposed striping at entrances?

Response: Striping was removed, median nose set back to property line to improve accessibility to proposed site.

- 20. Make sure keyed note 11 matches up with existing striping at intersection and contact Traffic Operations to make sure this is what the intention of crosswalk striping. **Response: Keynote #11 deleted**
- ADA parking aisle striping and pavement markings (No Parking): details of striping thickness, letter size and color will need to be provided.
 Response: See updated detail, sheet C2.
- 22. Limits of proposed asphalt pavement within COA ROW will need to follow COA DPM and standards with R value (min) 50. Show these limits Response: See attached pavement design calculations. Design SN = 3.4. Paving within proposed Rio Grande ROW will include 5" Asphalt on 6" Aggregate base on 12" subgrade. See keyed note #4 and detail on sheet C2.
- ADA ramp opening will be blocked by parking stall on the south portion of parking stall. Clear up this concern.
 Response: ADA ramp opening was removed.
- 24. Main entrance: Are you proposing a 6 ft. valley gutter? If so, please annotated that the invert should be 1 inch instead of 1.5 inches.
 Response: See keyed note #13 and entrance detail, sheet C3.

If you have any questions or need additional information regarding this matter, please do not hesitate to contact me.

