CITY OF ALBUQUERQUE

Planning Department Alan Varela, Director



November 12, 2024

Dave Hickman Jeebs & Zuzu, LLC 5924 Anaheim Ave. NE, Suite A Albuquerque, NM 87113

RE: 3017 11th Street NE

Grading and Drainage Plan Engineer's Stamp Date: 10/29/24

Hydrology File: H13D122

Dear Mr. Hickman:

Based upon the information provided in your submittal received 11/06/2024, the Grading & Drainage Plan is <u>approved</u> for action by the Development Facilitation Team (DFT) on Site Plan for Building Permit or for action by the Development Hearing Officer (DHO) on Preliminary Plat.

PO Box 1293

PRIOR TO BUILDING PERMIT:

Albuquerque

1. Please submit a more detailed Grading & Drainage Plan to Hydrology for review and approval. This digital (.pdf) is emailed to PLNDRS@cabq.gov along with the Drainage Transportation Information Sheet.

NM 87103

As a reminder, if the project total area of disturbance (including the staging area and any work within the adjacent Right-of-Way) is 1 acre or more, then an Erosion and Sediment Control (ESC) Plan and Owner's certified Notice of Intent (NOI) is required to be submitted to the Stormwater Quality Engineer (Dough Hughes, PE, jhughes@cabq.gov, 505-924-3420) 14 days prior to any earth disturbance.

www.cabq.gov

If you have any questions, please contact me at 505-924-3314 or amontoya@cabq.gov.

Sincerely,

Anthony Montoya, Jr., P.E. Senior Engineer, Hydrology

anth Mars

Planning Department, Development Review Services



City of Albuquerque Planning Department

Development & Building Services Division

DRAINAGE AND TRANSPORTATION INFORMATION SHEET (DTIS)

Project Title:				
Legal Description:				
City Address, UPC, OR Parcel:				
Applicant/Agent:		_ Contact:		
Address:		Phone:		
Email:				
Applicant/Owner:		Contact	:	
Address:				
Email:				
TYPE OF DEVELOPMENT: Plat (# of lo			Single Family Home	
			All other Developments	
	RE-SUBMITTAL:	YES	NO	
DEPARTMENT: TRANS	PORTATION	HYDROLO	OGY/DRAINAGE	
Check all that apply under Both	the Type of Submittal a	nd the Type	of Approval Sought:	
TYPE OF SUBMITTAL:		TYPE OF APPROVAL SOUGHT:		
Engineering / Architect Certification		Pad Certification		
Conceptual Grading & Drainage Plan		Building Permit		
Grading & Drainage Plan, and/or Drainage		Grading Permit		
Report		Paving Permit		
Drainage Report (Work Order)		SO-19 Permit		
Drainage Master Plan		Foundation Permit		
Conditional Letter of Map Revision (CLOMR)		Certificate of Occupancy - Temp Perm		
Letter of Map Revision (LOMR)		Preliminary / Final Plat		
Floodplain Development Permit		Site Plan for Building Permit - DFT		
Traffic Circulation Layout (TCL) – Administrative		Work Order (DRC)		
Traffic Circulation Layout (TCL) – DFT Approval		Release of Financial Guarantee (ROFG) CLOMR / LOMR		
Traffic Impact Study (TIS)		Conceptual TCL - DFT		
Street Light Layout		OTHER (SPECIFY)		
		OTTLK	(51 2011 1)	

REV. 04/03/24

DATE SUBMITTED:

October 10, 2024

Tiquan Chen
Planning Department, City of Albuquerque
600 Second St NW
Albuquerque, NM 87102

RE: Application for Grading and Drainage Plan for

the subdivision of 3017 11th Street NW

Dear Tiquan,

We are providing to your office for review our proposed grading and drainage report in connection with the proposed subdivision of 3017 11th Street. This project was recently heard by the DFT and there were no unresolved comments at that time. We are now pursuing the Preliminary Plat action and will need your approval for that action.

I have attached a grading and drainage plan for the two lots which include the footprints of the proposed single family homes to be situated on each lot. I have also included the drainage calculations.

Please let me know if there is anything else that you need or if you have any questions.

We really appreciate you!

Sincerely,

J. David Hickman,

Architect

64.8 64.8 -64.0-New Home FF = 65.564.3 65.0 64.5 **-**•64.8-64.0 65.2 -64.0job no: 65.0 drawn: **Author** checked: Checker New Home 65.1 Aug. 18, 2021 date: Garage FF = 65.5FF = 65.5 65.0 65.0 ⁻64.0 65.0 64.4 64.5 64.5 64.9 64.7 RESIDENCE 64.8 1 Drainage Plan
1" = 10'-0" ₹ 5 sheet no:

ADDRESS: 3017 11th St NW, Albuquerque, NM

LEGAL DESCRIPTION: LOT 8-A MCDONALD ACRES SUBDIVISION

SITE AREA: 0.58 AC (25,265 SF)

BENCHMARK: City of Albuquerque Station "SMW=8" being an aluminum disc

with ELEV= 4969.73 (NAVD 1988)

SURVEYOR: Harris Surveying September, 2022

FLOOD HAZARD: From FEMA Map 35001C0332G (9/26/2008), this site is identified as Zone 'X' which is an area with reduced flood risk due to levee.

OFFSITE FLOW: The site does not accept offsite flow.

EXISTING CONDITIONS: The site is currently an undeveloped residential lot in the North Valley with limited slope.

PROPOSED IMPROVEMENTS: The proposed improvements include 2 single-family residences with a shared access road, private patios, and depressed landscaping.

DRAINAGE APPROACH: The site drainage will include onsite retention of the SWQ volume with limited discharge.

Existing land treatment: 100% A PRECIPITATION ZONE: 2

Q = (1.54)(0.58) = 0.9 CFS

Proposed land treatment: 66% C and 34% D Q= [(0.66)(2.87)+(0.34)(4.12)](0.58)=1.9 CFS North Valley discharge limited to 2.75 CFS/AC (0.58 ac) = 1.6 CFS

SWQ V= (25,265)(0.42/12)= 884 CF

Site runoff will discharge to several onsite retention ponding areas located in the surrounding yard areas. The SWQ volume will be retained onsite and provide for mitigated site discharge.

LEGAL DESCRIPTION: LOT 8-A MCDONALD ACRES SUBDIVISION

SITE AREA: 0.58 AC (25,265 SF)

BENCHMARK: City of Albuquerque Station "SMW=8" being an aluminum disc with ELEV= 4969.73 (NAVD 1988)

SURVEYOR: Harris Surveying September, 2022

FLOOD HAZARD: From FEMA Map 35001C0331H (8/16/12) and 35001C0332G (9/26/2008), this site is identified as Zone 'X' which is an area with reduced flood risk due to levee.

OFFSITE FLOW: The site does not accept offsite flow.

EXISTING CONDITIONS: The site is currently an undeveloped residential lot in the North Valley with limited slope.

PROPOSED IMPROVEMENTS: The proposed improvements include 2 single-family residences with a shared access road, private patios, and depressed landscaping.

DRAINAGE APPROACH: The site drainage will include onsite retention of the SWQ volume with limited discharge.

Existing land treatment: 100% A PRECIPITATION ZONE: 2 Q= (1.71)(0.58)= 1.0 CFS Proposed land treatment: 66% C and 34% D Q = [(0.66)(3.05)+(0.34)(4.34)](0.58) = 2.0 CFSNorth Valley discharge limited to 2.75 CFS/AC (0.58 ac) = 1.6

SWQ V= (8,590)(0.42/12)= 300 CF

S 80° 44' 30" E

FF: 65.5

LOT 58 McDONALDS ACRES SUBDIVISION

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BOOK C2, PAGE 18

TW 65.5 BW 64.2

TW 65.5 BW 64.2

Site runoff will discharge to several onsite retention ponding areas located in the surrounding yard areas. The SWQ volume will be retained onsite and provide for mitigated site discharge.

> LOT 6 McDONALDS ACRES SUBDIVISION FILED: APRIL 17, 1937

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SWQP #1 TOP EL: 64

V = 250 CF

BTM EL: 63

TW 65.5 BW 64.2

N 80° 20' 31" W

McDONALDS ACRES SUBDIVISION

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BOOK C2, PAGE 18

Private Drainage Facilities within City Right-of-Way Notice to Contractor (Special Order 19 ~ "SO-19")

1. Build sidewalk culvert per COA STD DWG 2236. Work is permitted and inspected by DMD Construction Services Division.

2. An excavation permit will be required before beginning any work within City Right-Of-Way.

3. All work on this project shall be performed in accordance with applicable federal, state and local laws, rules and regulations concerning construction safety and health.

4. Prior to any excavation, the contractor must contact **New Mexico One Call, dial "811"** [or (505) 260-1990] for the location of existing utilities.

5. Prior to construction, the contractor shall excavate and verify the locations of all obstructions. Should a conflict exist, the contractor shall notify the engineer so that the conflict can be resolved with a minimum amount of delay.


6. Backfill compaction shall be 95%.

7. Maintenance of the facility shall be the responsibility of the owner of the property being served.

8. Work on arterial streets may be required on a 24hour basis.

9. For excavation and barricading inspections, contact DMD Construction Services Division.

LEGEND EXISTING PROPERTY LINE NEW PROPERTY LINE ____ **EXISTING SPOT ELEVATIONS** G = 4964⊕64 **NEW SPOT ELEVATIONS NEW CONTOUR LINE** FLOW DIRECTION FINISH FLOOR ELEVATION FF 65.5 TOP OF WALL BOTTOM OF WALL **KEY NOTES:** < A. REMOVE EXISTING DRIVEPAD & REPLACE WITH STANDARD CURB & GUTTER & 5' SIDEWALK PER CITY STANDARD DRAWING NO.5 2415 & 2430. B. REMOVE EXISTING CURB & GUTTER AND SIDEWALK AND BUILD NEW DRIVE PAD PER CITY STANDARD DRAWING NO. 2425.

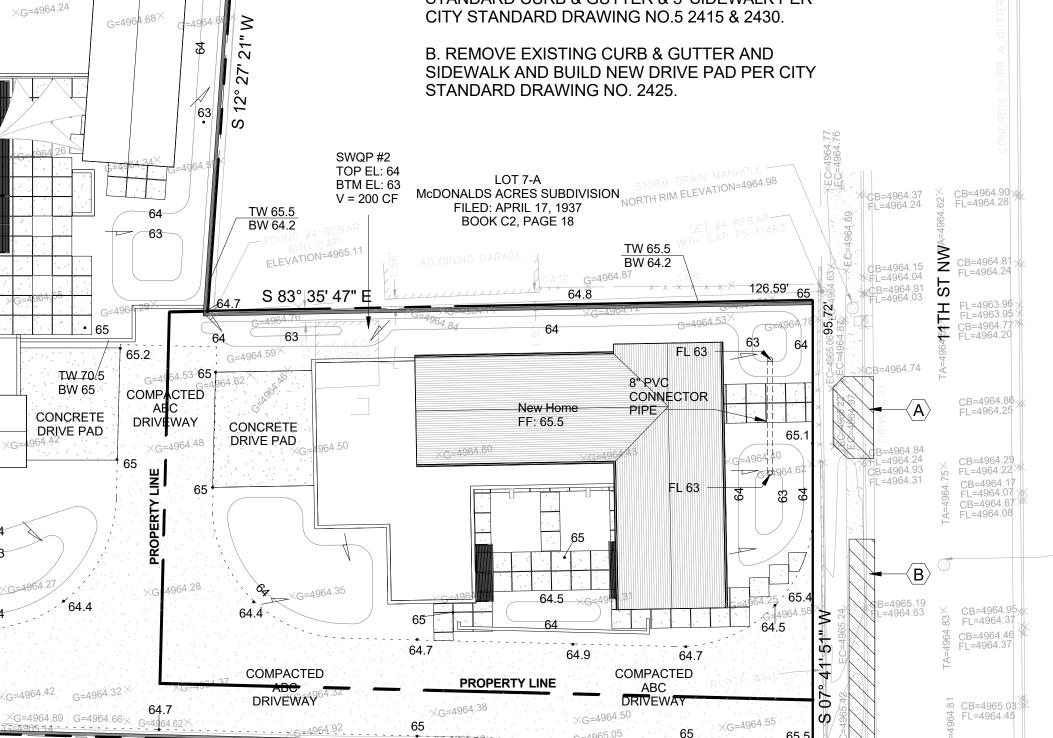

McDONALDS ACRES SUBDIVISION

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LOT 61 McDONALDS ACRES SUBDIVISION


FILED: APRIL 17, 1937

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GENERAL NOTES:

NO WORK SHALL BE PERFORMED IN THE PUBLIC ROW WITHOUT AN APPROVED WORK ORDER OR **EXCAVATION PERMIT.**

VICINITY MAP

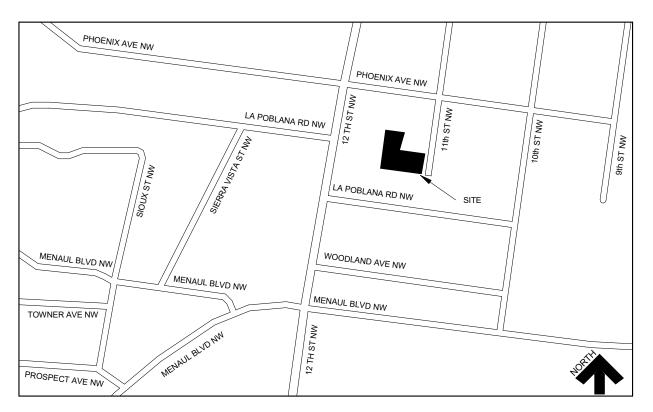

Planning Department
Development Review Services HYDROLOGY SECTION **APPROVED** 11-12-2024 anth Mars HydroTrans # H13D122

> APPROVAL OF GRADING & DRAINAGE PLAN(S) SHALL EXPIRE AFFROVAL OF GRADING & DRAINAGE FLANGS) SHALL EAFIRE "WO (2) YEARS AFTER THE APPROAL DATE BY THE CITY IF NO BUILDING PERMIT HAS BEEN PULLED ON THE DEVELOPMENT.

W ARCHITE MAKING

job no: drawn: checked: 11/6/2024 date:

工

STREET


AND ZUZU.Co

8710 3017 IITH ST. NW ALBUQUERQUE, NM

sheet no:

National Flood Hazard Layer FIRMette 105°39'40"W 35°77"N

250

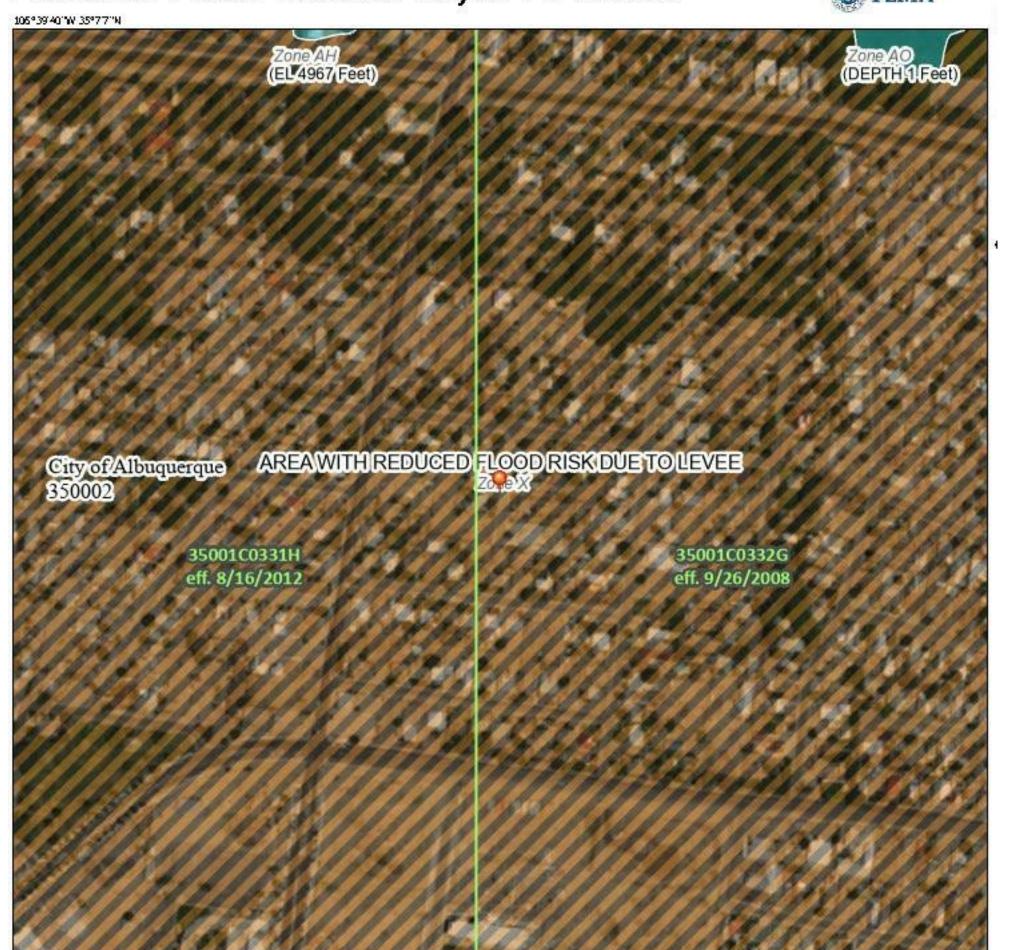

1:6,000

Basemap Imagery Source: USGS National Map 2023

2,000