

LEGAL DESCRIPTION:

LOTS 8-13, BLOCK 1, MATTHEW ADDITION CONTAINING 42,372.92 SF. (0.9727 AC.) MORE OR LESS.

GENERAL NOTES:

1: ADD 4900 TO SPOT ELEVATIONS TO SHOW TRUE ELEVATION.

2: CONTOUR INTERVAL IS ONE (1) FOOT.

3: ELEVATIONS ARE BASED ON CITY OF ALBUQUERQUE CONTROL STATION HAVING AN ELEVATION OF 4958.365 FEET ABOVE SEA LEVEL. 4: UTILITIES SHOWN HEREON ARE IN THEIR APPROXIMATE LOCATION BASED ONLY ON ABOVE GROUND EVIDENCE FOUND IN THE FIELD AND AS-BUILT INFORMATION PROVIDED BY THE CLIENT. UTILITIES SHOWN HEREON, WHETHER INDICATED AS ABANDONED OR NOT, SHALL BE VERIFIED BY OTHERS FOR

EXACT LOCATION AND/ OR DEPTH PRIOR TO EXCAVATION OR DESIGN CON-SIDERATIONS. 5: THIS IS NOT A BOUNDARY SURVEY, BEARINGS ARE ASSUMED, DISTANCES AND

FOUND PROPERTY CORNERS ARE FOR INFORMATIONAL PURPOSES ONLY. 6: SLOPES ARE AT 4:1 MAXIMUM.

EROSION CONTROL PLAN

AND POLLUTION PREVENTION NOTES

1. CONTRACTOR IS RESPONSIBLE FOR OBTAINING A TOPSOIL DISTURBANCE PERMIT PRIOR TO BEGINNING WORK.


2. CONTRACTOR IS RESPONSIBLE FOR CLEANING ALL SEDIMENT OUT OF EXISTING RIGHT-OF-WAY.


3. CONTRACTOR IS RESPONSIBLE FOR MAINTAINING ALL STORM

4. REPAIR OF DAMAGED FACILITIES AND CLEAN-UP OF SEDIMENT ACCUMULATION ON ADJACENT PROPERTIES AND IN PUBLIC FACILITIES IS THE RESPONSIBILITY OF THE CONTRACTOR.


5. ALL EXPOSED EARTH SURFACES MUST BE PROTECTED FROM WIND AND WATER EROSION PRIOR TO FINAL ACCEPTANCE OF ANY

6. ALL THE DISTURBED AREAS MUST BE REVEGETATED.

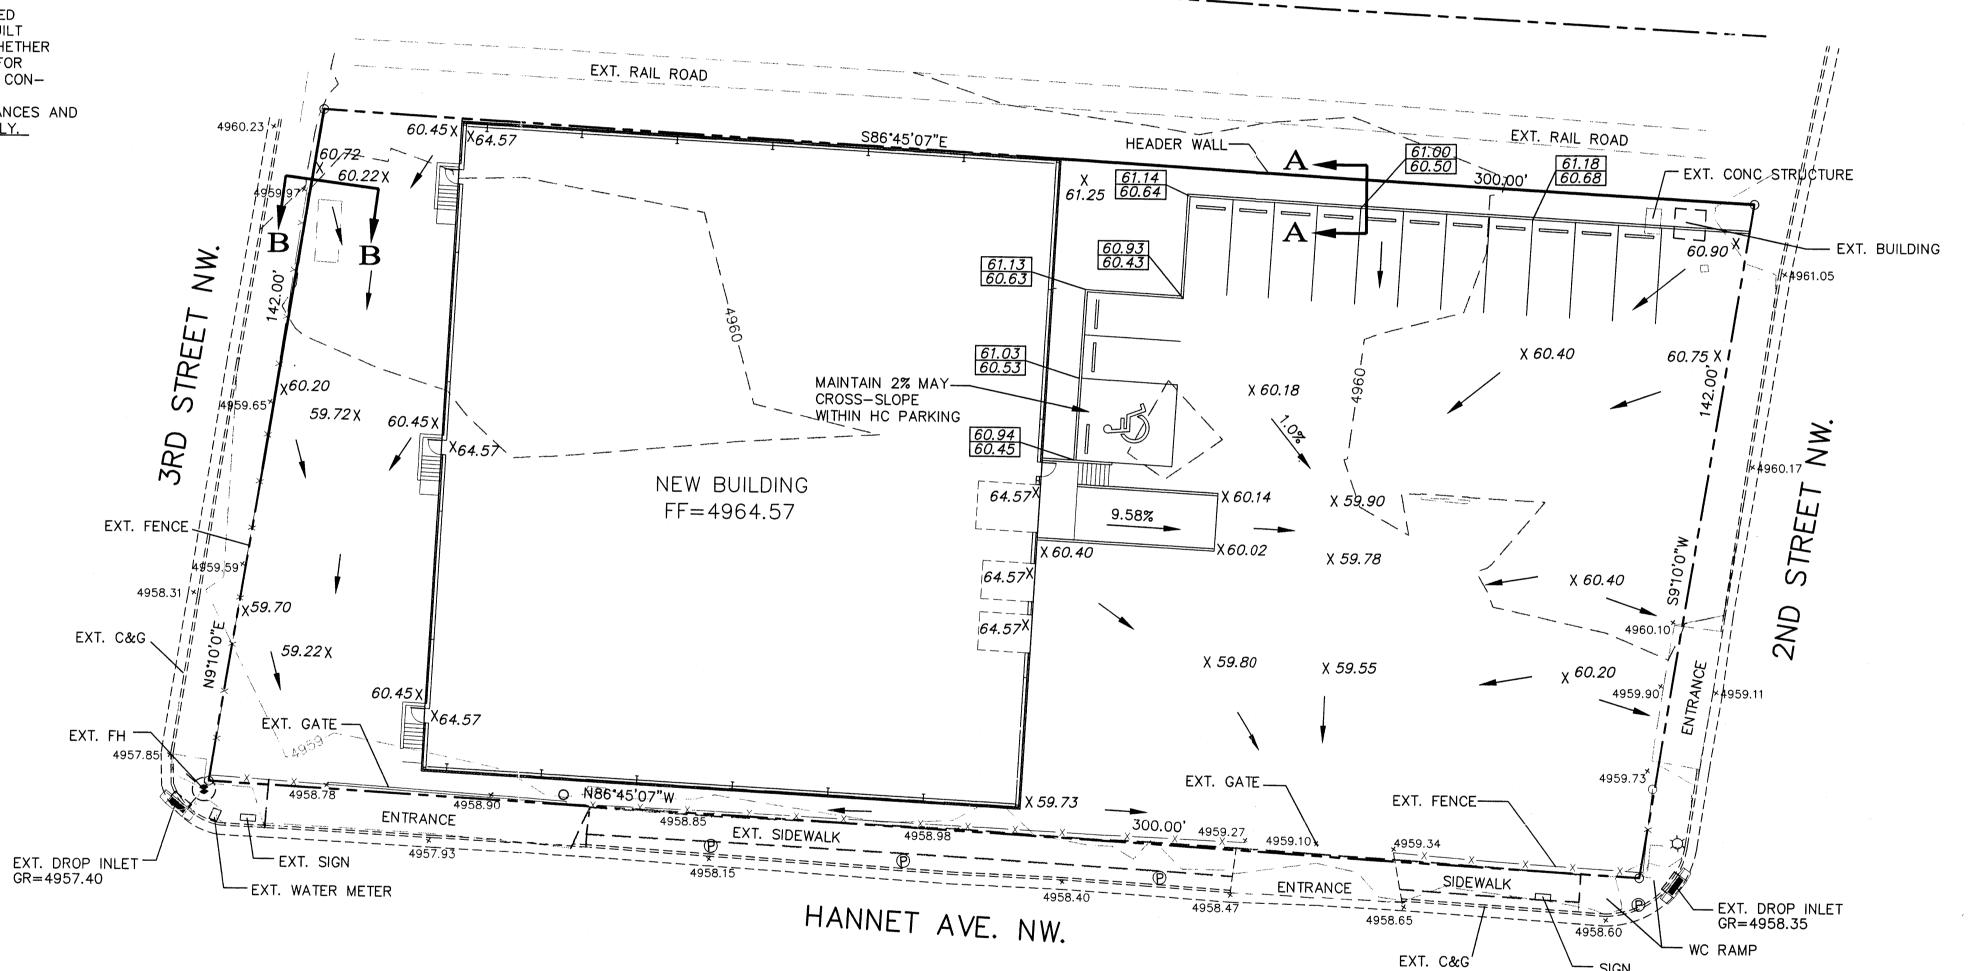

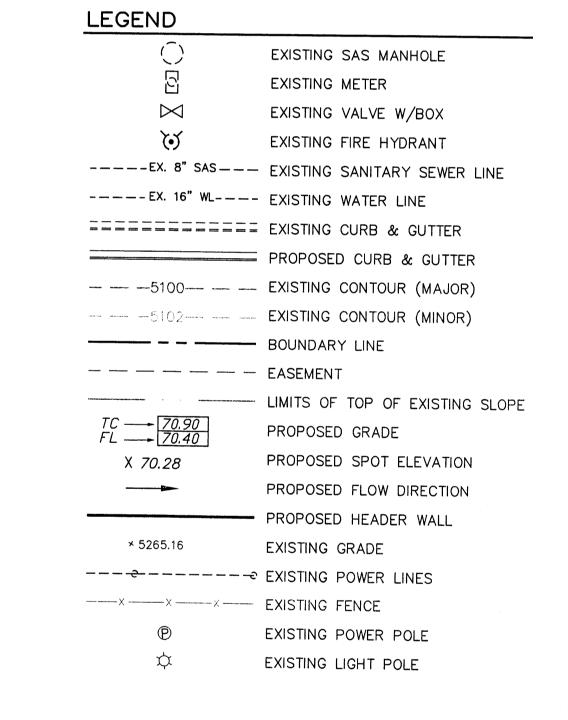



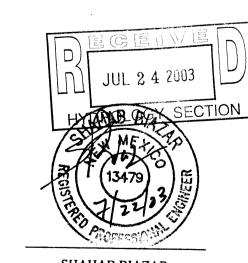

ADVANCED **ENGINEERING** and CONSULTING, LLC


SHAHAB BIAZAR P.E. #13479

10205 SNOWFLAKE CT., NW ALBUQUERQUE, NEW MEXICO 87114 (505)899-5570

CREAMLAND DAIRY WAREHOUSE GRADING AND DRAINAGE PLAN

DRAWING: DRAWN BY: 200332-GR.DWG 07-22-03

GRAPHIC SCALE ROUGH GRADING APPROVAL DATE SCALE: 1"=20'

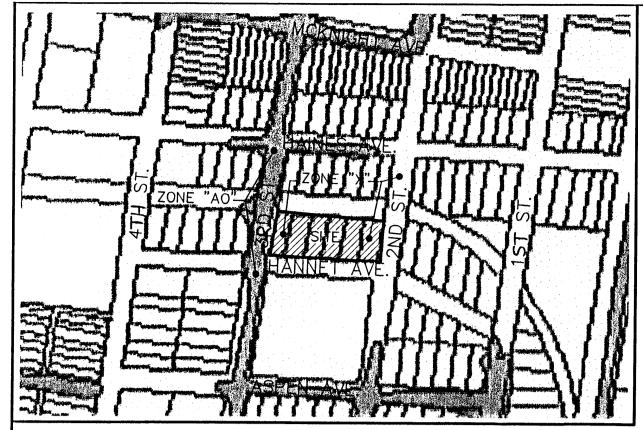

FIRM MAP: 35001C0332 D

**GENERAL NOTES:** 1: ADD 4900 TO SPOT ELEVATIONS TO SHOW TRUE ELEVATION. 2: CONTOUR INTERVAL IS ONE (1) FOOT.


3: ELEVATIONS ARE BASED ON CITY OF ALBUQUERQUE CONTROL STATION HAVING AN ELEVATION OF 4958.365 FEET ABOVE SEA LEVEL. 4: UTILITIES SHOWN HEREON ARE IN THEIR APPROXIMATE LOCATION BASED ONLY ON ABOVE GROUND EVIDENCE FOUND IN THE FIELD AND AS-BUILT INFORMATION PROVIDED BY THE CLIENT. UTILITIES SHOWN HEREON, WHETHER INDICATED AS ABANDONED OR NOT, SHALL BE VERIFIED BY OTHERS FOR EXACT LOCATION AND/ OR DEPTH PRIOR TO EXCAVATION OR DESIGN CON-SIDERATIONS.


5: THIS IS NOT A BOUNDARY SURVEY, BEARINGS ARE ASSUMED, DISTANCES AND FOUND PROPERTY CORNERS ARE FOR INFORMATIONAL PURPOSES ONLY.


6: SLOPES ARE AT 4:1 MAXIMUM.

#### EROSION CONTROL PLAN AND POLLUTION PREVENTION NOTES

- CONTRACTOR IS RESPONSIBLE FOR OBTAINING A TOPSOIL DISTURBANCE PERMIT PRIOR TO BEGINNING WORK.
- 2. CONTRACTOR IS RESPONSIBLE FOR CLEANING ALL SEDIMENT OUT OF EXISTING RIGHT-OF-WAY.
- 3. CONTRACTOR IS RESPONSIBLE FOR MAINTAINING ALL STORM RUNOFF ON SITE.
- 4. REPAIR OF DAMAGED FACILITIES AND CLEAN-UP OF SEDIMENT ACCUMULATION ON ADJACENT PROPERTIES AND IN PUBLIC FACILITIES IS THE RESPONSIBILITY OF THE CONTRACTOR.
- 5. ALL EXPOSED EARTH SURFACES MUST BE PROTECTED FROM WIND AND WATER EROSION PRIOR TO FINAL ACCEPTANCE OF ANY
- 6. ALL THE DISTURBED AREAS MUST BE REVEGETATED.

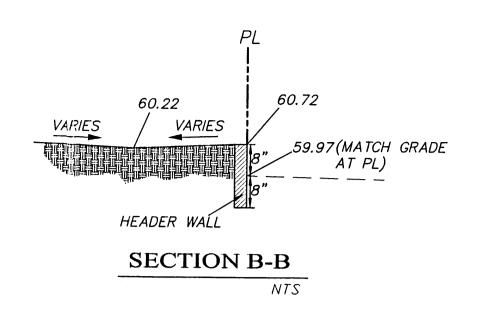

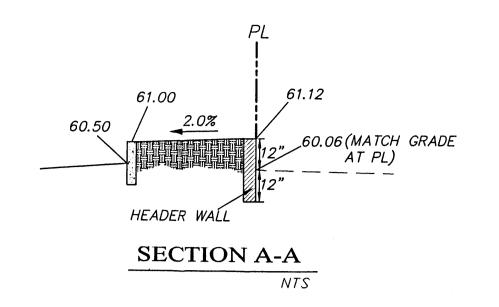

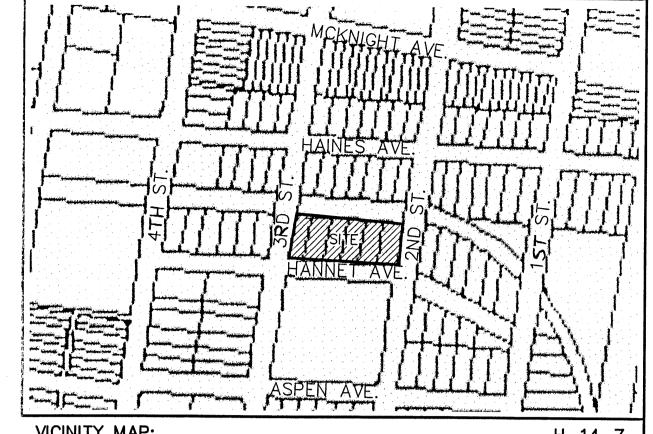

VICINITY MAP:

LEGAL DESCRIPTION: LOTS 8-13, BLOCK 1, MATTHEW ADDITION

CONTAINING 42,372.92 SF. (0.9727 AC.) MORE OR LESS.

HEADER WALL-─ EXT. CONC\_STRÜ¢TURE — EXT. BUILDING X *60.40* MAINTAIN 2% MAYx60.20 (5) X 60.18 CROSS-SLOPE WITHIN HC PARKING NEW BUILDING 64.57<sup>)</sup> FF=4964.<del>57</del> 9.58% EXT. FENCE \( \lambda \) X 60.40 X *59.78* 64.57<sup>X</sup> 64.57<sup>X</sup> EXT. C&G *59.22* X X *59.80* X *59.55* 4959.907 4957.85 4959.73<sup>x</sup> EXT. GATE \_\_\_\_ 60.01 O N86'45'07"W EXT. FENCE-EXT. DROP INLET -GR = 4957.40--- EXT. DROP INLET GR = 4958.35EXT. C&G

LEGEND EXISTING SAS MANHOLE EXISTING METER EXISTING VALVE W/BOX EXISTING FIRE HYDRANT ----EX. 8" SAS--- EXISTING SANITARY SEWER LINE ---- EX. 16" WL---- EXISTING WATER LINE ============ EXISTING CURB & GUTTER PROPOSED CURB & GUTTER - - - 5100 - - EXISTING CONTOUR (MAJOR) - - - 5102 - - EXISTING CONTOUR (MINOR) BOUNDARY LINE \_ \_ \_ \_ \_ \_ \_ EASEMENT LIMITS OF TOP OF EXISTING SLOPE PROPOSED GRADE PROPOSED SPOT ELEVATION X *70.28* PROPOSED FLOW DIRECTION PROPOSED HEADER WALL × 5265.16 EXISTING GRADE ----- EXISTING POWER LINES ----×----×---- EXISTING FENCE EXISTING POWER POLE EXISTING LIGHT POLE

I SHAHAB BIAZAR, NMPE, OF THE ADVANCED ENGINEERING, LLC HEREBY CERTIFY THAT PROJECT HAS BEEN GRADED AND WILL DRAIN IN SUBSTANTIAL COMPLIANCE WITH AND IN ACCORDANCE WITH THE DESIGN INTENT OF THE APPROVED PLAN DATED JULY 22, 2003. THE RECORD INFORMATION EDITED ONTO THE ORIGINAL DESIGN DOCUMENT HAS BEEN OBTAINED BY ME OR UNDER MY DIRECT SUPERVISION AND IS TRUE AND CORRECT TO THE BEST OF MY KNOWLEDGE AND BELIEF. THIS CERTIFICATION IS SUBMITTED IN SUPPORT OF A REQUEST FOR CERTIFICATION OF OCCUPANCY.

THE RECORD INFORMATION PRESENTED HEREON IS NOT NECESSARILY COMPLETE AND INTENDED ONLY TO VERIFY SUBSTANTIAL COMPLIANCE OF THE GRADING AND DRAINAGE ASPECTS OF THIS PROJECT. THOSE RELYING ON THIS RECORD DOCUMENT ARE ADVISED TO OBTAIN INDEPENDENT VERIFICATION OF ITS ACCURACY BEFORE USING IT FOR ANY OTHER PURPOSE.

SHAHAB BIAZAR, NMPE # 13479


DATE






GRAPHIC SCALE



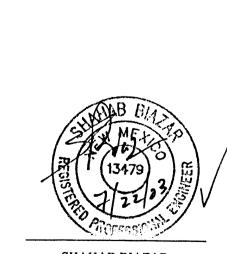

SHAHAB BIAZAR P.E. #13479

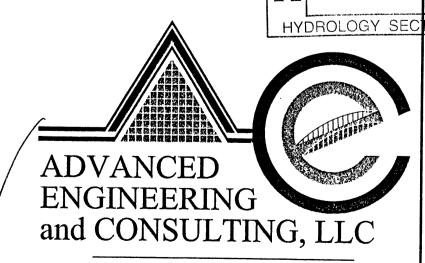

10205 SNOWFLAKE CT., NW ALBUQUERQUE, NEW MEXICO 87114 (505)899-5570

CREAMLAND DAIRY WAREHOUSE GRADING AND DRAINAGE PLAN DRAWN BY:

DRAWING: DATE: 200332-GR.DWG 07-22-03


ROUGH GRADING APPROVAL DATE

LAST REVISION: 07-22-0.

SBB

1 OF 1

FEB 0 5 2004

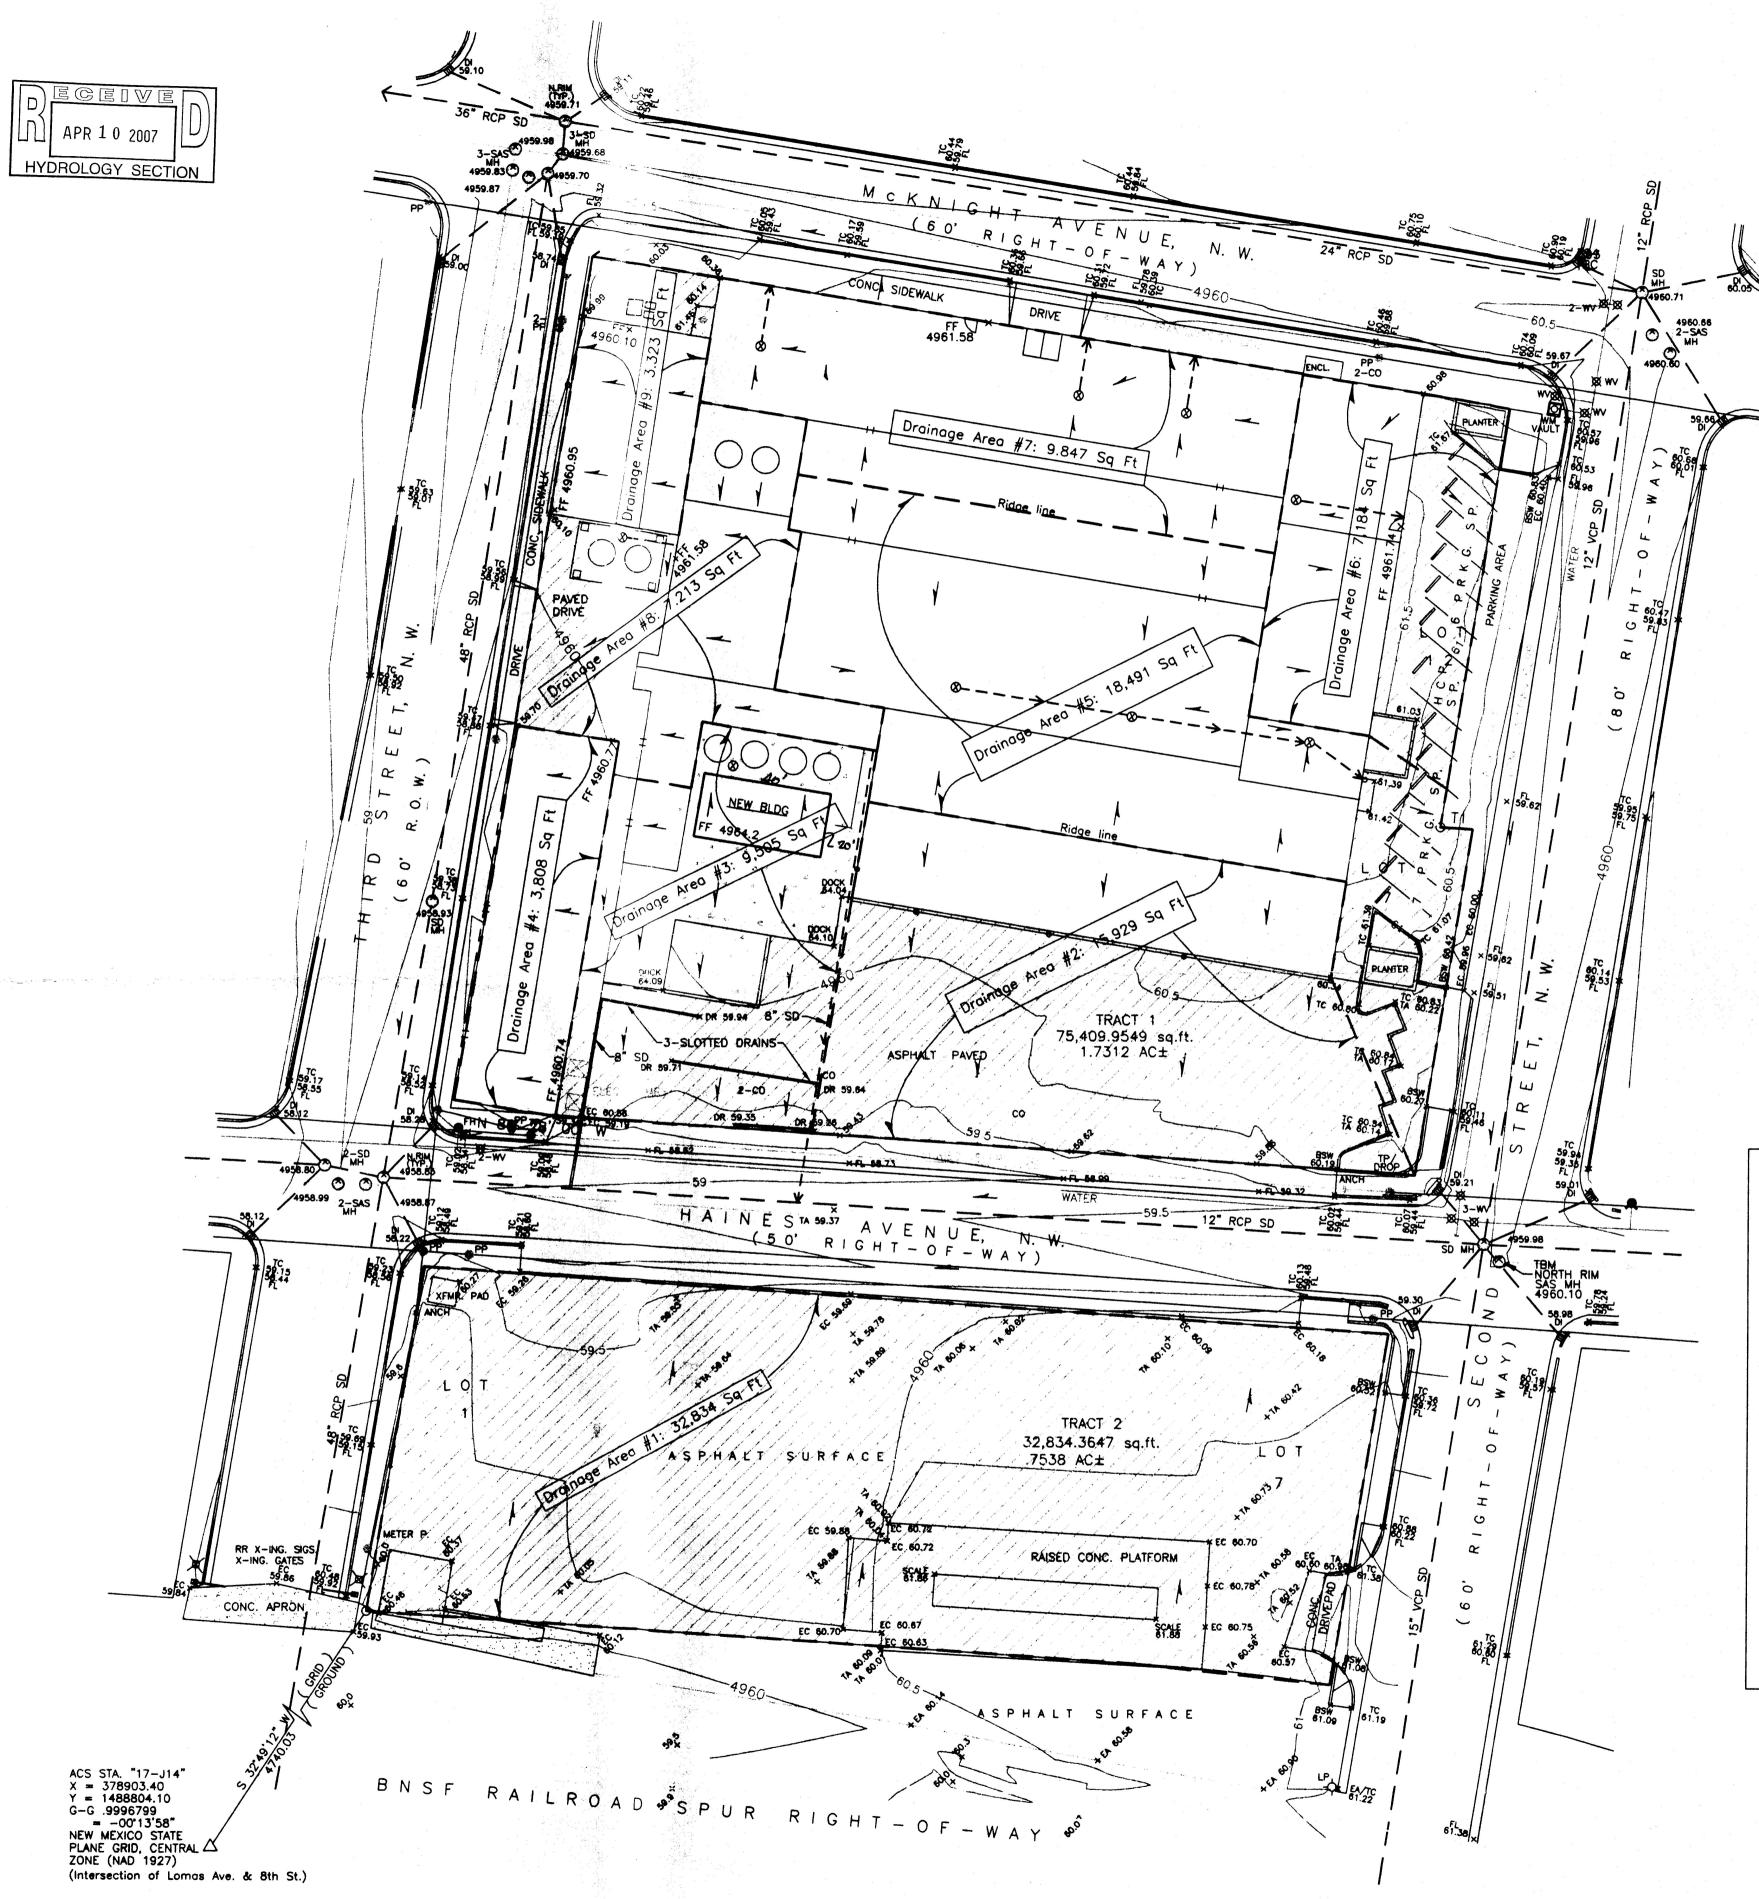

### Stormwater Drainage Flows and Volumes

- 1. Methodology: City of Albuquerque Development Process Manual Chapter 22
- a. Precipitation Zone: Zone 2 per Table A-1
- b. Design Storm for Runoff Volume: 6 Hour with 2, 10 and 100 year return periods.
  c. Land Treatment: Type D (Impervious areas, pavement and roofs) per Table A-4
- d. Excess Precipitation (inches): 2-year = 0.79; 10-year = 1.34; 100-year = 2.12 per
- Table A-8
  e. Peak Discharge (cfs/acre) with 0.2 Hour Time of Concentration: 2-year = 1.86; 10-year = 3.14; 100-year = 4.70 per Table A-9

Drainage Area	Area		Runoff Volume Acre Feet			Peak Discharge - CFS			Discharge Location
	SF	Acres	2-Year	10-Year	100-Year	2-Year	10-Year	100-Year	
, 1	32,834	0.75	0.049	0.083	0.132	1.39	2.36	3.52	South side of Haines with outlet to DI at SE corner of Haines & Third
2	15,929	0.37	0.024	0.041	0.065	0.69	1.16	1.74	North side of Haines with outlet to DI at NE corner of Haines & Third
3	9,505	0.22	0.014	0.025	0.039	0.41	0.69	1.74	Two 8-inch storm drains connected to 12-Inch SD in Haines Avenue
4	3,808	0.09	0.006	0.010	0.016	0.17	0.28	0.42	East side of Third with outlet to DI at NE corner of Haines & Third
5	18,491	0.42	0.028	0.047	0.074	0.78	1.32	1.97	West side of Second with outlet to DI at NW comer of Second & Haines
6	7,184	0.16	0.011	0.018	0.028	0.30	0.50	0.75	West side of Second with outlet to DI at NW corner of Second & Haines
7	9,847	0.23	0.015	0.026	0.041	0.43	0.72	1.08	South side of McKnight with outlet to DI at SE corner of McKnight & Third
8	7,213	0.17	0.011	0.019	0.030	0.32	0.53	0.79	East side of Third with outlet to DI at NE corner of Haines & Third
9	3,323	0.08	0.005	0.009	0.014	0.15	0.25	0.38	East side of Third with outlet to DI at SE comer of McKnight & Third

# **GENERAL NOTES:**

- 1. This is not a boundary survey; data is shown for orientation only. The boundary and topographic survey information depicted by this plan is based upon the survey prepared by Thomas D. Johnston, NMPS NO. 14269, dated 8/17/2006. The site survey and original site plan drawing was prepared by Wayjohn Surveying.
- 2. Bearings are New Mexico State Plane, Central Zone.
  Distances are as measured between recovered monuments. Reference ACS 17-J14.
- Basis of Elevations:
   Benchmark: ACS 1-3/4" aluminum disc, stamped "ACS BM 24-J14", epoxied on top of concrete curb, centered over a drop inlet, NNE quadrant of Constitution Avenue and Fourth Street, NW.
   ELEV. 4958.365
- TBM: North rim of sanitary sewer manhole in center of the intersection of Second Street and Haines Avenue, NW ELEV. 4960.10

DRAINAGE AREA TABULATION

PAVEMENT

32,834

11,335

4,261

3,076

2,745

58,418

AREA

AREA

32,834

15, 929

9,505

3,808

18,491

7,184

9,847

7,213

108,134

ROOF AREA

4,594

15,102

4,108

9,847

4,468

2,545

49,717

5,245(a)

DRAINAGE

AREA

# LEGAL DESCRIPTION

Lots numbered One (1) through Twelve (12), Block numbered Four (4), FRANCISCAN ADDITION, Albuquerque, New Mexico, as the same is shown and designated on the Plat thereof, filed in the Office of the County Clerk of Bernalillo County, New Mexico, on December 17, 1934 in Plat Book D, Page 13.

#### AND

Lots numbered One (1) through Seven (7), Block 7, and Lots numbered One (1) through Seven (7), Block Two (2), ALVARADO ADDITION, Albuquerque, New Mexico, as the same is shown and designated on the Plat thereof, filed in the Office of the County Clerk of Bernalillo County, New Mexico, on March 27, 1924 in Plat Book C2, Page 92.

## FLOOD NOTE

The above described property is located within Zone "X (Area determined to be outside the 0.2% annual chance of flood) per Commnunity Panel No. 350002 0332 E, dated November 19, 2003, and is not located within a Special Flood Hazard Boundary indicated by FEMA Flood Insurance Rate Maps. Determination of Flood Hazard is by graphic plotting only. McKnight Avenue, N.W., Haines Avenue, N.W., and Third Street, N.W. are located within Zone AO with inidicated flood depth of 1 foot.

## LEGEND:

			SPOT ELEVATION
EM EM	ELECTRIC METER	*61.72	ELEVATIONS ARE TO FINISH SURF
● GM	GAS METER	× <sup>6</sup>	EDGE OF ASPHALT
> > × × × × × × × × × × × × × × × × × ×	WATER VALVE		
Ø wM	WATER METER	EC	EDGE OF CONCRETE
O MH	MANHOLE (TYPE NOTED)	TA	TOP OF ASPHALT
0 00	SEWER CLEANOUT	TC	TOP OF CURB / CONCRETE FLOWLINE
		FL	
∵ → FH	FIRE HYDRANT		BACK OF SIDEWALK
● PP	POWER POLE		STORM DRAIN LINE
ANCH	ANCHOR		
ф.	LIGHT POLE		SANITARY SEWER
<b>Ø</b>	ROOF DRAIN		BURIED TELEPHONE CABLE
	NOOF BRAIN		GAS LINE
	CHAIN LINK FENCE		WATER LINE
	CONCRETE BLOCK WALL		WATER CINE
, ,	CONCRETE BLOCK WALL		OVERHEAD POWER LINE
المستري	FLOW DIRECTION		OVERHEAD TELEPHONE CABLE
	EXISTING CONTOURS ©0	.5 FT.	INTERVALS

INDEX CONTOURS ©2.5 FT. INTERVALS

,

LOADING DOCK

RUII DING

В

LAND DEVELOPMENT CONSULTANTS, LLC.
An Associate Firm of Williams & Beck, Inc.

5620 B. SAN FRANCISCO DRIVE NE,

TITLE:

GRADING AND DRAINAGE PLAN

PROJECT FOR:

CREAMLAND
CITY OF ALBUQUERQUE, BERNALILLO COUNTY, NEW MEXICO

ALBUQUERQUE, NEW MEXICO 87109

Phone: (505) 797-4120 Fax: (505) 821-0392 email: ldc\_llc@msn.com

DATE: MARCH, 2007 SHEET NO. 1

(a) Combined area of roof and loading dock.

