
CITY OF ALBUQUERQUE

Planning Department Brennon Williams, Director

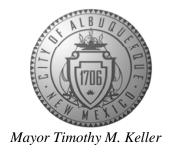

January 31, 2020

Ron Bohannan, P.E. Tierra West, LLC 5571 Midway Park Place, NE Albuquerque, NM 87109

RE: Maverick at University & Menaul

1901 Menaul NE

Grading Plan Stamp Date: 1/29/20 Drainage Report Stamp Date: 12/11/19

Hydrology File: H15D068

Dear Mr. Bohannan,

Based on the submittal received on 1/29/20, this project is approved for Building Permit.

Prior to Certificate of Occupancy (For Information):

Albuquerque

1. Engineer's Certification, per the DPM Chapter 22.7: *Engineer's Certification Checklist For Non-Subdivision* is required.

NM 87103

2. City acceptance and close-out of the public Work Order will be required, unless a financial guarantee has been posted.

www.cabq.gov

3. A Bernalillo County Recorded <u>Drainage Covenant (No Public Easement)</u> is required for the storm water ponds. The original notarized form, exhibit A (legible on 8.5x11 paper), and recording fee (\$25, payable to Bernalillo County) must be turned into DRC (4th, Plaza del Sol) for routing. Please contact Charlotte LaBadie (clabadie@cabq.gov, 924-3996) regarding the routing and recording process for covenants. The routing and recording process for covenants can take a month or longer; Hydrology recommends beginning this process as soon as possible as to not delay approval for certificate of occupancy.

If you have any questions, please contact me at 924-3695 or dpeterson@cabq.gov.

Sincerely,

Dana Peterson, P.E.

Senior Engineer, Planning Dept. Development Review Services



City of Albuquerque

Planning Department

Development & Building Services Division

DRAINAGE AND TRANSPORTATION INFORMATION SHEET (REV 6/2018)

Project Title: Maverik University & Menaul DRB#:		
Legal Description:TR OF LD IN SEC 9 T10N R3E IN THE SIZ SW/4 SE		
City Address: 1901 Menaul Blvd NE, Albuqu	erque, NM 87107	
Applicant: Tierra West, LLC		Contact: Vinny Perea
Address: 5571 Midway Park Place NE, Albud		
Phone#: 505-858-3100	Fax#: 505-858-1118	E-mail: vperea@tierrawestllc.con
Other Contact:		Contact:
Address:		
Phone#:	_ Fax#:	E-mail:
TYPE OF DEVELOPMENT: PLAT	(# of lots) RESIDENO	
IS THIS A RESUBMITTAL? Yes DEPARTMENT TRANSPORTATION	/	AAINAGE
Check all that Apply: TYPE OF SUBMITTAL: ENGINEER/ARCHITECT CERTIFICATION PAD CERTIFICATION CONCEPTUAL G & D PLAN GRADING PLAN DRAINAGE REPORT DRAINAGE MASTER PLAN FLOODPLAIN DEVELOPMENT PERMIT ELEVATION CERTIFICATE CLOMR/LOMR TRAFFIC CIRCULATION LAYOUT (TCL TRAFFIC IMPACT STUDY (TIS) STREET LIGHT LAYOUT OTHER (SPECIFY) PRE-DESIGN MEETING?	✓ BUI CER CER PRE SITH ✓ SITH FINA FOU ✓ GRA OF A OF A	F APPROVAL/ACCEPTANCE SOUGHT: LDING PERMIT APPROVAL ETIFICATE OF OCCUPANCY CLIMINARY PLAT APPROVAL E PLAN FOR SUB'D APPROVAL E PLAN FOR BLDG. PERMIT APPROVAL AL PLAT APPROVAL (RELEASE OF FINANCIAL GUARANTEE UNDATION PERMIT APPROVAL ADING PERMIT APPROVAL (19 APPROVAL VING PERMIT APPROVAL ADING/PAD CERTIFICATION RK ORDER APPROVAL DMR/LOMR DODPLAIN DEVELOPMENT PERMIT HER (SPECIFY)
DATE SUBMITTED: 1/29/2020	By: Vinny Perea 505-858	3-3100
COA STAFF:	ELECTRONIC SUBMITTAL REG	CEIVED:

FEE PAID:

tierrawestllc.com



TIERRA WEST, LLC

January 28, 2020

Mr. Dana Peterson, P.E. Sr. Engineer-Hydrology City of Albuquerque 600 2nd Street NW Albuquerque, NM 87102

RE: MAVERIK AT UNIVERSITY & MENAUL

GRADING PLAN & DRAINAGE REPORT RESPONSE TO COMMENTS

ENGINEER'S STAMP DATE 12/11/19 (H15D068)

Dear Mr. Peterson:

Per your correspondence dated December 13, 2019, please find the following responses addressing the comments listed below:

Prior to Building Permit:

- 1. Provide a Revocable Permit and Slope Easement (measured at a 3:1 slope from top of wall to bottom of wall) for the retaining wall encroaching on University. Final recorded documents can be provided at CO, but they need to be initiated now. Turn in the documents to DRC on the 4th floor for routing and then provide a copy along with a DTIS sheet when resubmitting for building permit approval. There is no resubmittal fee for this action; please include a copy of this letter when resubmitting to receive the reduced fee. Response: The slope easement has been completed and recorded and is attached with this letter. A 12'-wide easement has been established in the location of the proposed retaining wall adjacent to University Blvd. This retaining wall has been shifted to the west to be away from the property line and using an L-footing. The cross section A-A of this wall has been updated on Sheet C6 and an L-Footing retaining wall detail has been added to Detail Sheet C9.
- As a reminder, if the project total area of disturbance (including the staging area and any work within the adjacent right-of-Way) is 1 acre or more, then an Erosion and Sediment Control (ESC) Plan and Owner's certified Notice of Intent (NOI) is required to be submitted to the Stormwater Quality Engineer (Curtis Cherne, PE, ccherne@cabq.gov, 924-3420) 14 days prior to any earth disturbance.

Response: We have received approval from COA on an Erosion and Sediment Control Plan on 1-15-2020 for this site. We are currently working through the NOI process with the owner and understand that no earth disturbance will occur prior to submittal of the NOI to COA.

If you have any questions or need additional information regarding this matter, please do not hesitate to contact me.

Sincerely,

Ronald R. Bohannan, PE

JN: 2018062 RRB/vp

Doc# 2020007700

01/27/2020 09 41 AM Page: 1 of 2 EASE R:\$25:00 Linda Stover: Bernalillo County

Legal Description

Public Slope Easement

A 12' WIDE PUBLIC SLOPE EASEMENT LYING AND SITUATE WITHIN THE TOWN OF ATRISCO GRANT, PROJECTED SECTION 9, TOWNSHIP 10 NORTH, RANGE 3 EAST, N.M.P.M. CITY OF ALBUQUERQUE, BERNALILLO COUNTY, NEW MEXICO, COMPRISING OF A PORTION OF TRACT B-1, TRUCK STOP PLAZA, AS THE SAME IS SHOWN AND DESIGNATED ON THE PLAT THEREOF FILED IN THE OFFICE OF THE COUNTY CLERK OF BERNALILLO COUNTY ON DECEMBER 06, 2019, IN MAP BOOK 2019C, PAGE 122, SAID EASEMENT BEING MORE PARTICULARLY DESCRIBED BY NEW MEXICO STATE PLANE COORDINATE SYSTEM GRID BEARINGS (NAD 83-CENTRAL ZONE) AND GROUND **DISTANCES (US SURVEY FEET) AS FOLLOWS;**

BEGINNING AT THE NORTHEAST CORNER OF DESCRIBED EASEMENT, LYING ON THE WEST RIGHT OF WAY LINE OF UNIVERSITY BOULEVARD, N.E., FROM WHENCE A TIE TO FOUND A.G.R.S. MONUMENT '1_40_12" BEARS S 85°36'46" E, A DISTANCE OF 3459.75 FEET;

THENCE FROM SAID POINT OF BEGINNING, ALONG SAID WEST RIGHT OF WAY LINE, S 00°33'30" W, A DISTANCE OF 180.06 FEET TO THE SOUTHEAST CORNER OF DESCRIBED EASEMENT;

THENCE LEAVING SAID RIGHT OF WAY LINE, N 89°26'30" W, A DISTANCE OF 12.00 FEET TO THE SOUTHWEST CORNER OF DESCRIBED EASEMENT;

THENCE N 00°33'30" E, A DISTANCE OF 180.06 FEET TO THE NORTHWEST CORNER OF DESCRIBED EASEMENT;

THENCE S 89°26'30" E, A DISTANCE OF 12.00 FEET TO THE POINT OF BEGINNING, CONTAINING 0.0496 ACRES (2,161 SQUARE FEET), MORE OR LESS, ALL AS SHOWN ON ATTACHED EXHIBIT "A"

Surveyor's Certificate

I, LARRY W. MEDRANO LICENSED UNDER THE LAWS OF THE STATE OF NEW MEXICO, DO HEREBY CERTIFY THAT THIS LEGAL DESCRIPTION, WAS PREPARED BY ME OR UNDER MY DIRECTION FROM NOTES OF AN ACTUAL FIELD SURVEY, AND THE SURVEY MEETS THE MINIMUM STANDARDS FOR SURVEYING IN NEW MEXICO.

Jaimie M. J.

LARRY W. MEDRANO M.M.P.S. NO. 11993

OFFICIAL SEAL Jaimie N. Garcia NOTARY PUBLIC STATE OF NEW MEXICO Expires: 3.22:202 Commission Expires:


MEDRANO


MEX


ARRY

ZEW


REGISTER POPESSIONAL

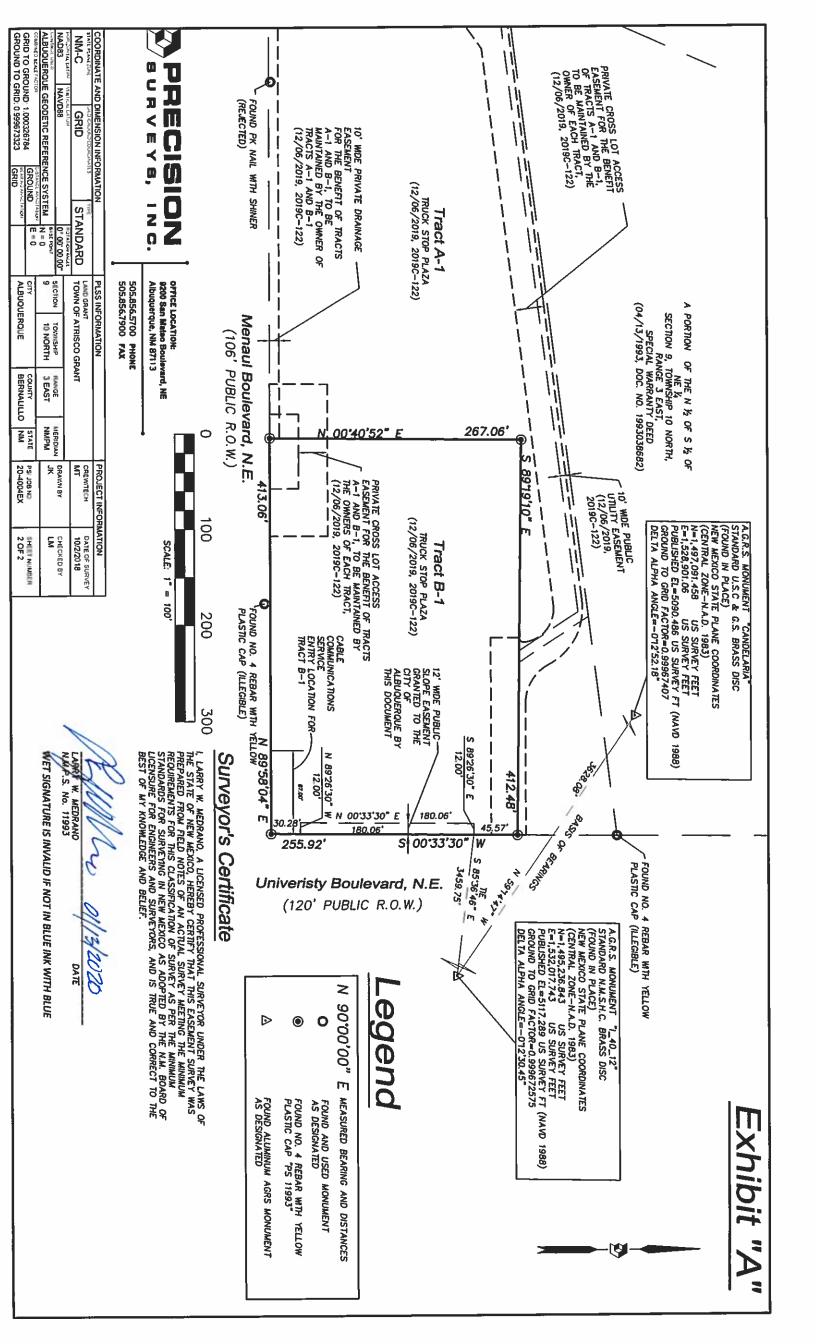

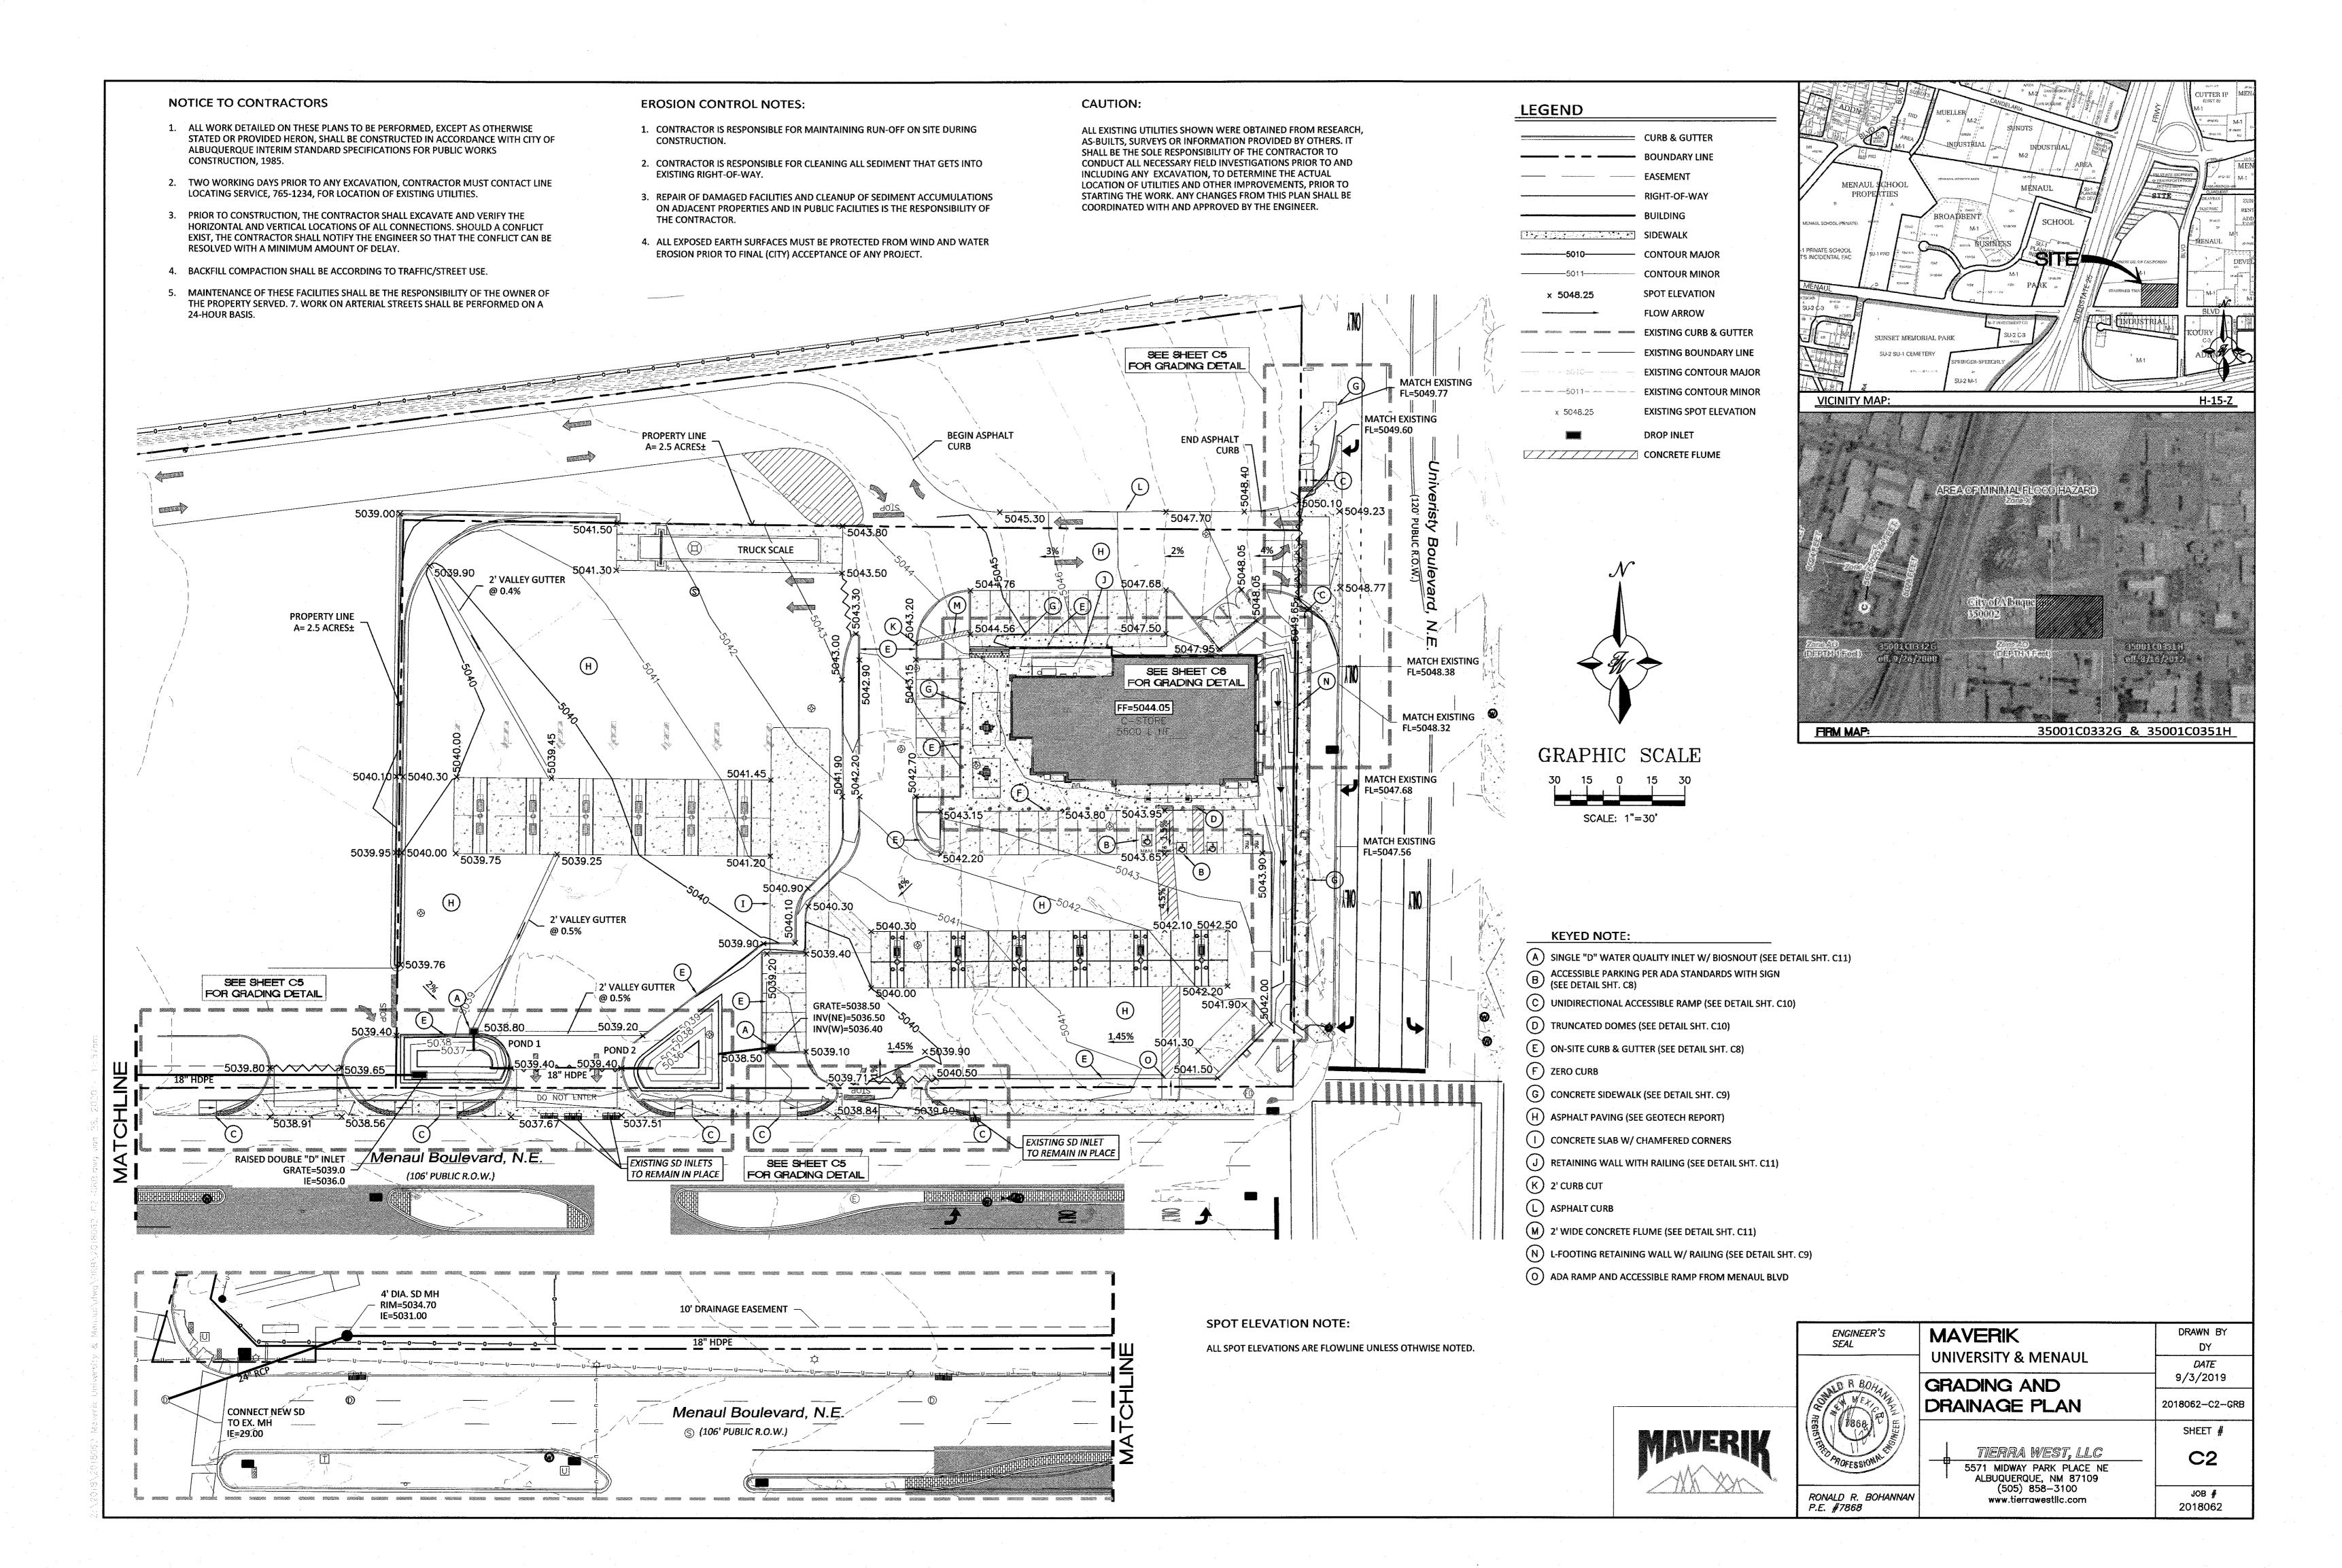


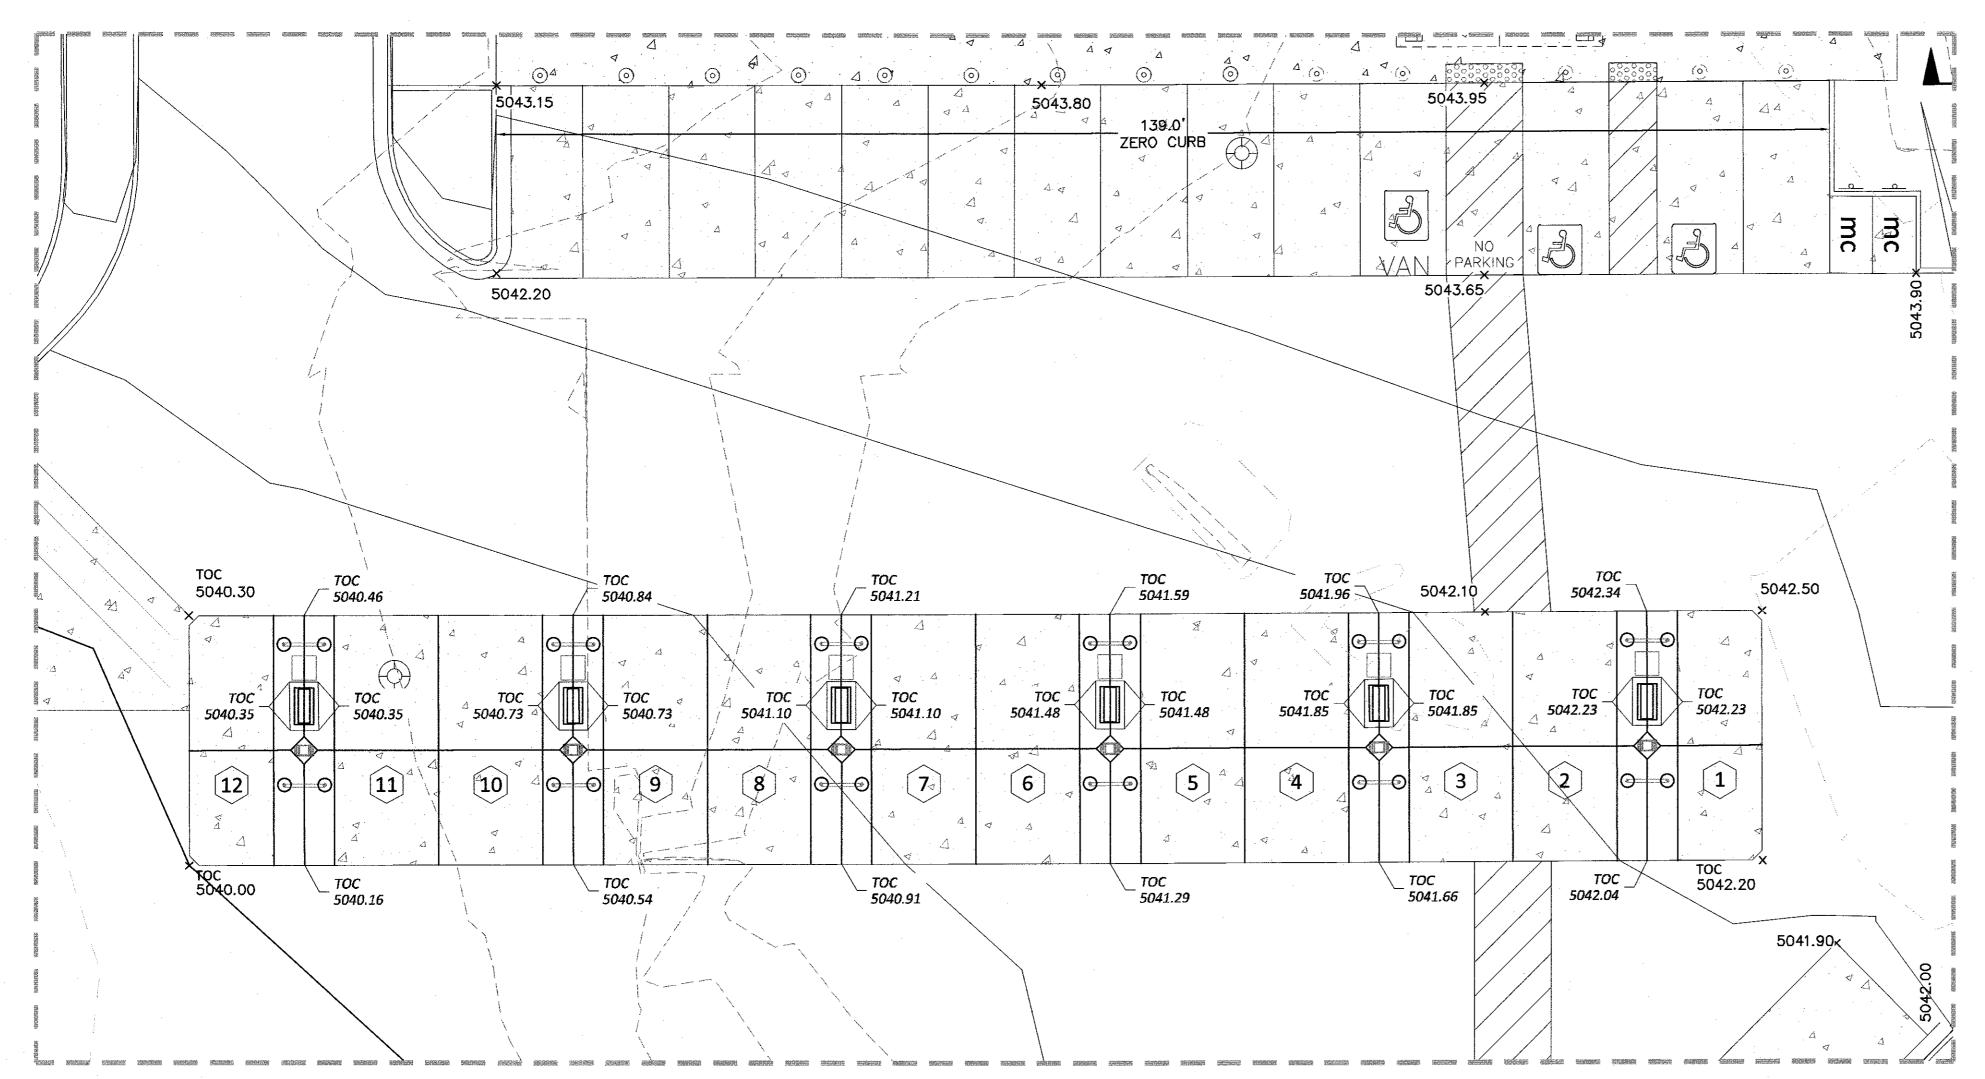

PEDESTRIAN VEHICLE FUELING AREA

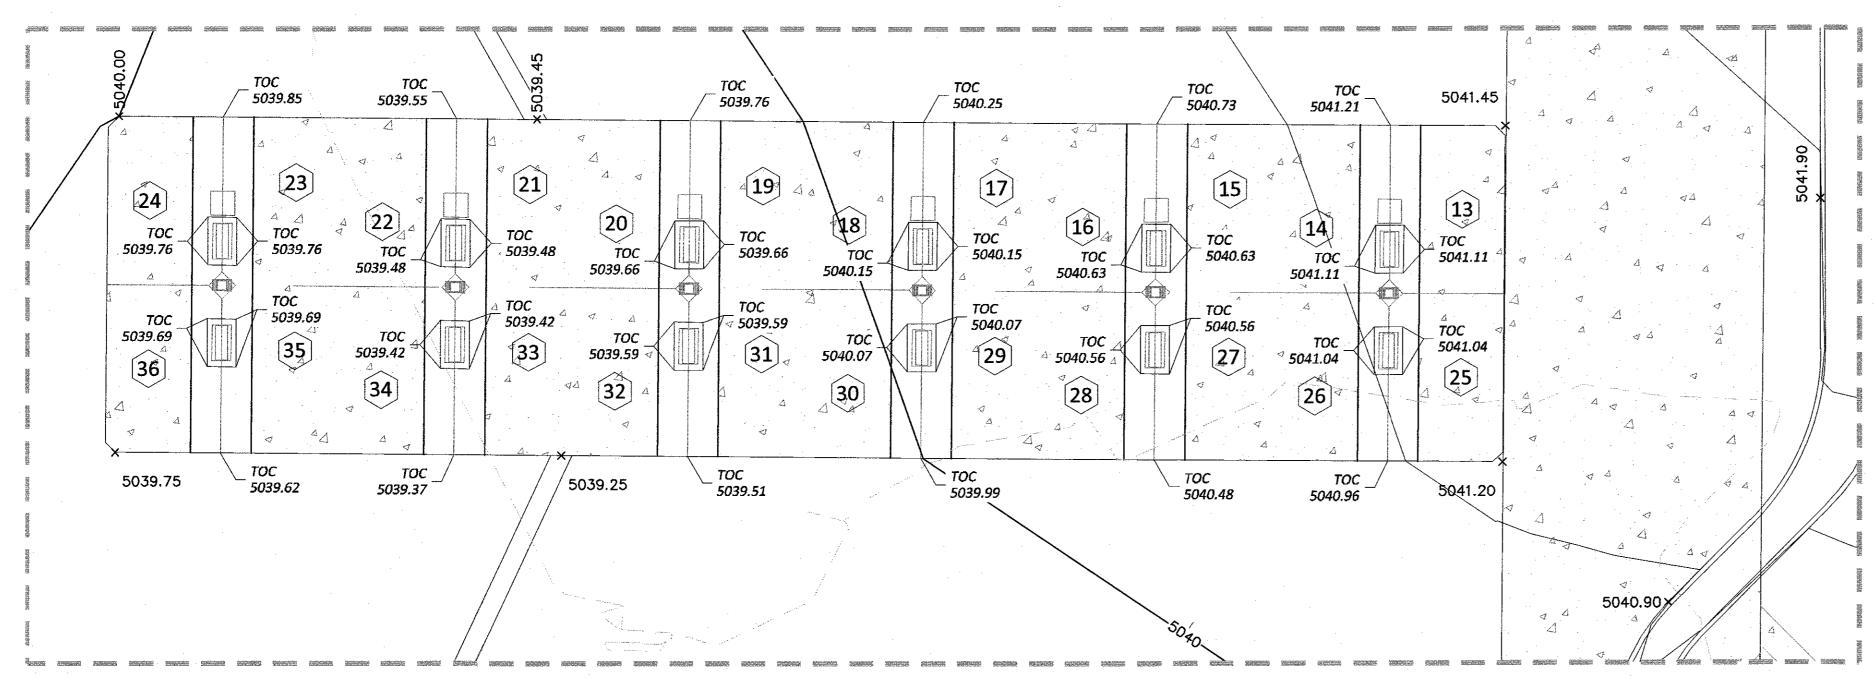


HEAVY TRUCK FUELING AREA

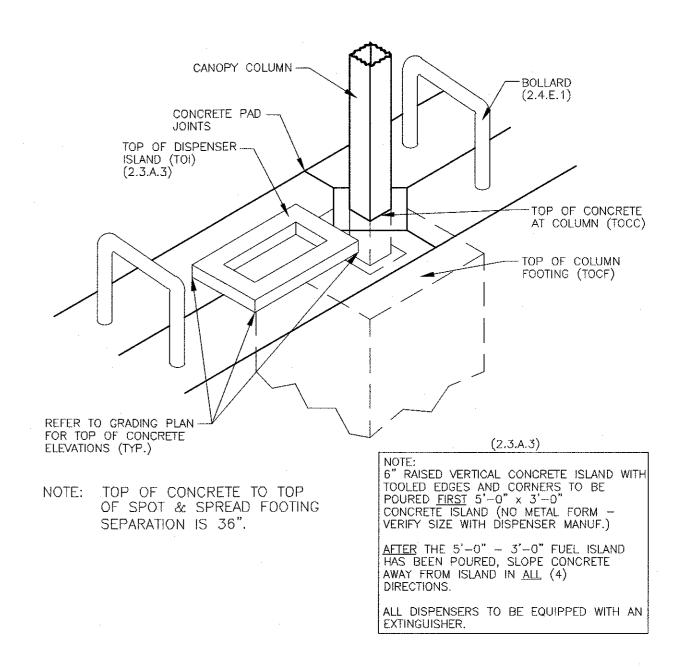


NOTE: TOC=TOP OF CONCRETE **FUEL DISPENSER ELEVATIONS**


FUEL	TOP OF	T.O.C. @	TOP OF
DISPENSER	ISLAND	COLUMN	COL. FTP
1-2	5042.73	5042.19	5039.19
3-4	5042.35	5041.81	5038.81
5-6	5041.98	5041.44	5038.44
7-8	5041.60	5041.06	5038.06
9-10	5041.23	5040.69	5037.69
11-12	5040.85	5040.31	5037.31
13-14	5041.61	5041.08	5038.08
15-16	5041.13	5040.60	5037.60
17-8	5040.65	5040.12	5037.12
19-20	5040.16	5039.63	5036.63
21-22	5039.98	5039.46	5036.46
23-24	5040.26	5039.73	5036.73
25-26	5041.54	5041.08	5038.08
27-28	5041.06	5040.60	5037.60
29-30	5040.57	5040.12	5037.12
31-32	5040.09	5039.63	5036.63
33-34	5039.92	5039.46	5036.46
35-36	5040.19	5039.73	5036.73

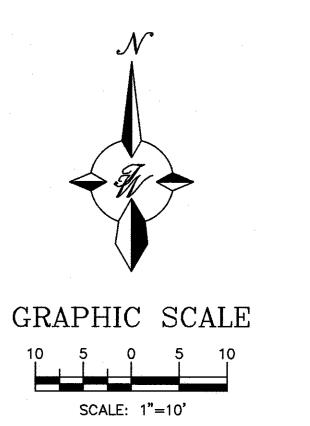

2018062

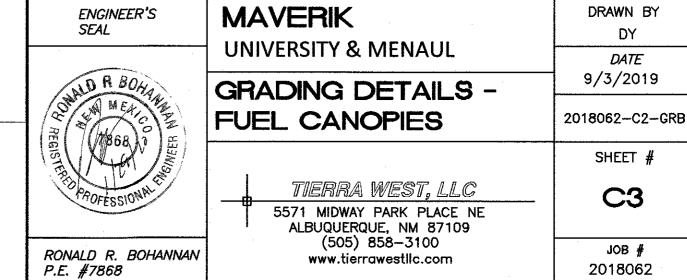



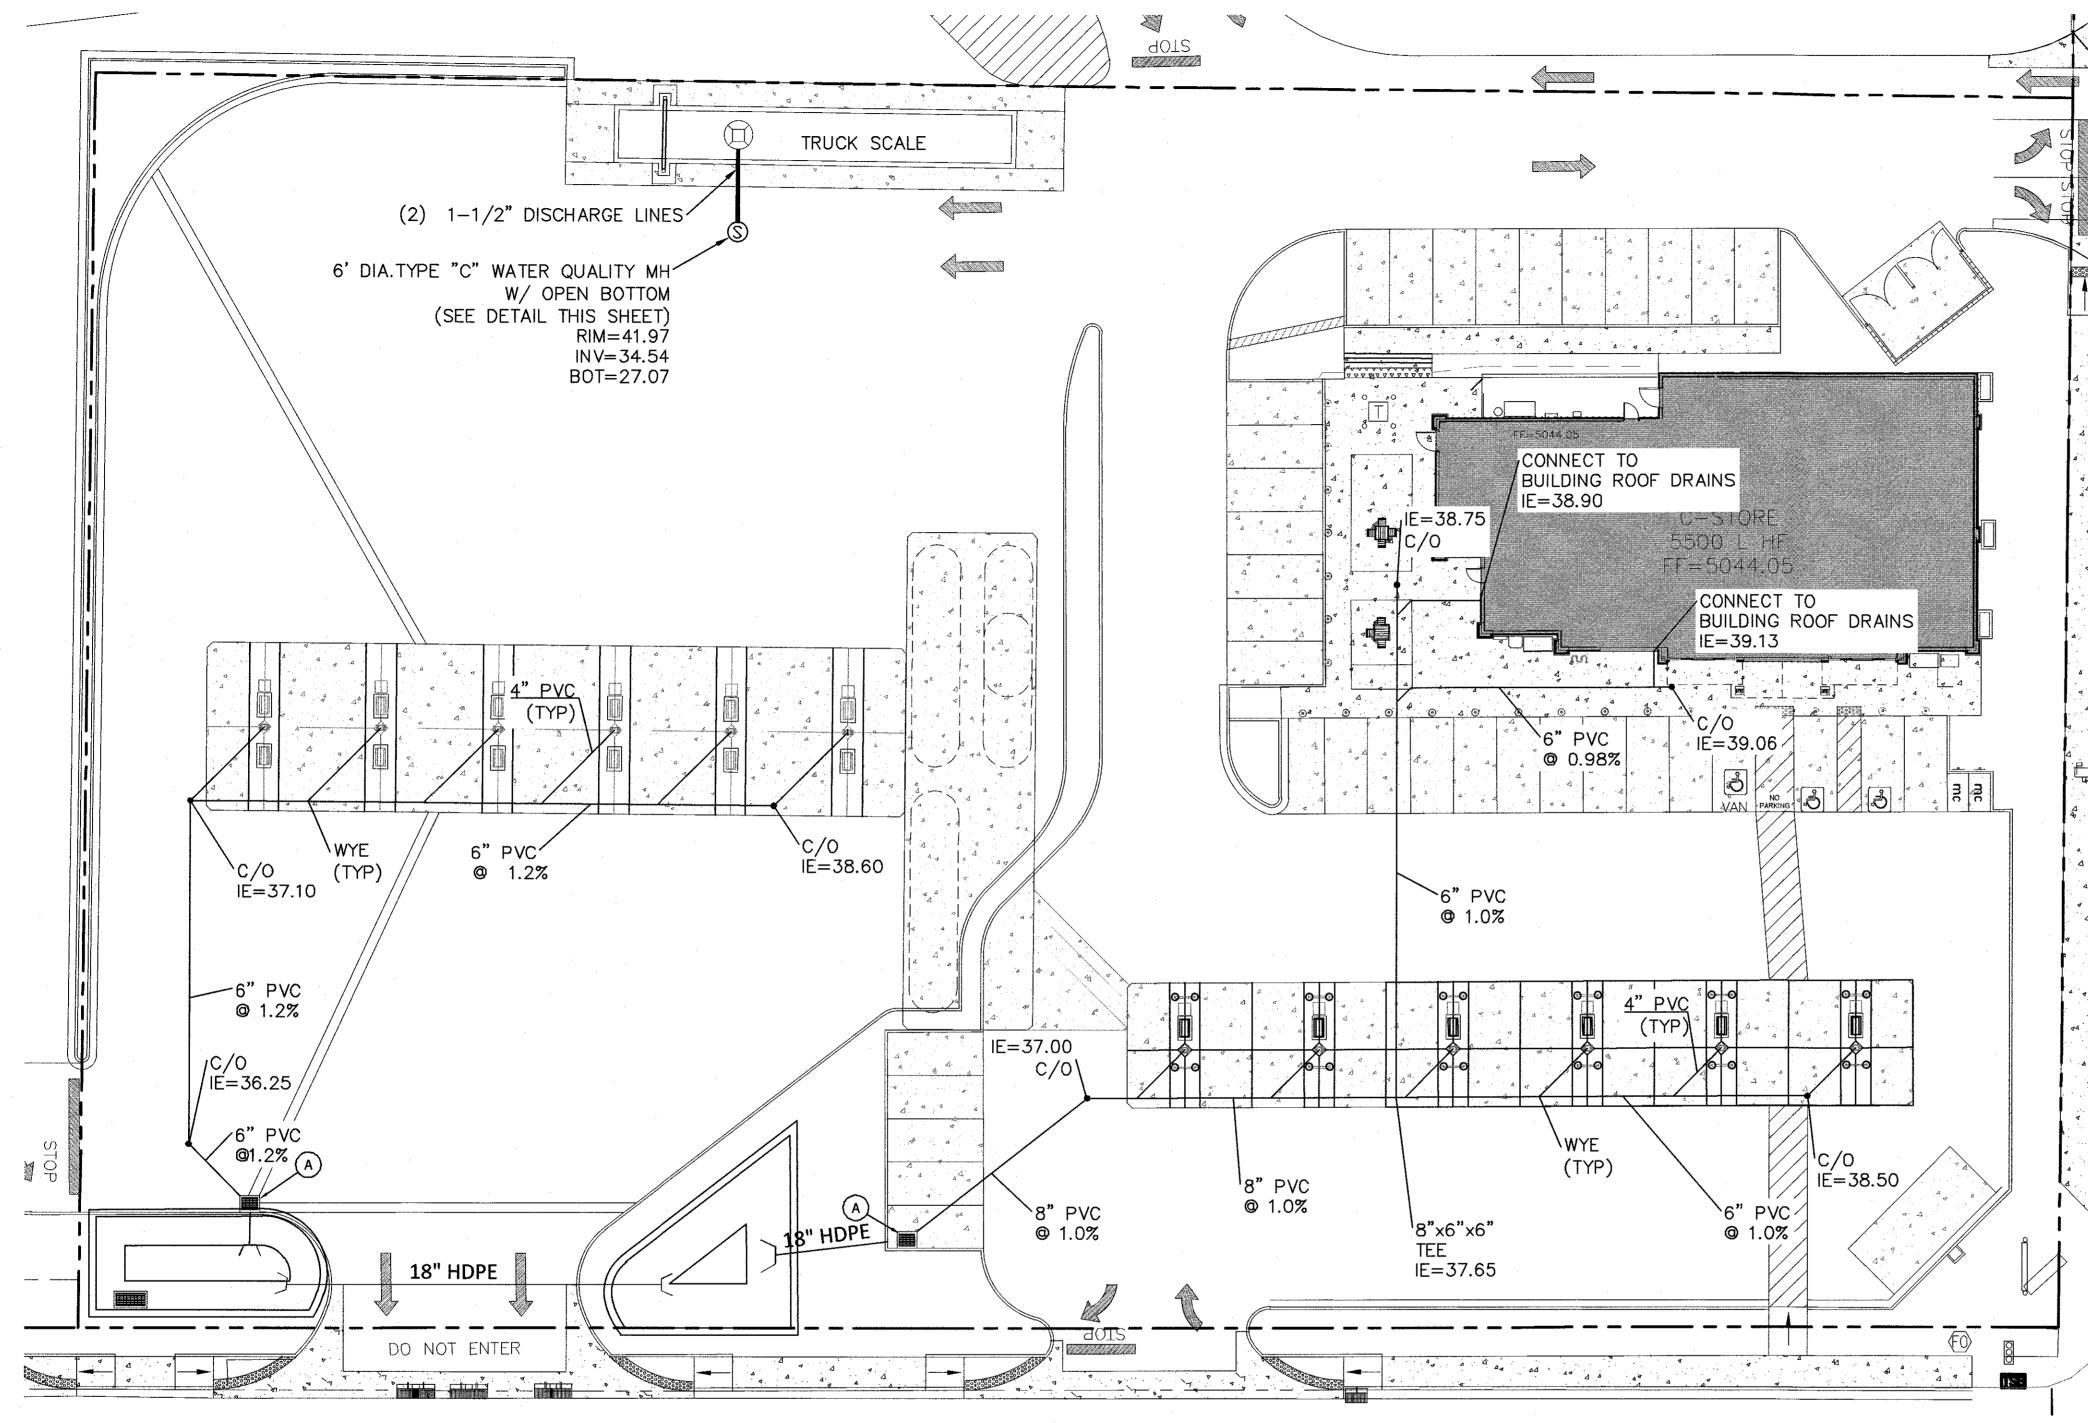

CAUTION:


ALL EXISTING UTILITIES SHOWN WERE OBTAINED FROM RESEARCH, AS-BUILTS, SURVEYS OR INFORMATION PROVIDED BY OTHERS. IT SHALL BE THE SOLE RESPONSIBILITY OF THE CONTRACTOR TO CONDUCT ALL NECESSARY FIELD INVESTIGATIONS PRIOR TO AND INCLUDING ANY EXCAVATION, TO DETERMINE THE ACTUAL LOCATION OF UTILITIES AND OTHER IMPROVEMENTS, PRIOR TO STARTING THE WORK. ANY CHANGES FROM THIS PLAN SHALL BE COORDINATED WITH AND APPROVED BY THE ENGINEER.


NOTICE TO CONTRACTORS

- 1. ALL WORK DETAILED ON THESE PLANS TO BE PERFORMED, EXCEPT AS OTHERWISE STATED OR PROVIDED HERON, SHALL BE CONSTRUCTED IN ACCORDANCE WITH CITY OF ALBUQUERQUE INTERIM STANDARD SPECIFICATIONS FOR PUBLIC WORKS CONSTRUCTION, 1985.
- 2. TWO WORKING DAYS PRIOR TO ANY EXCAVATION, CONTRACTOR MUST CONTACT LINE LOCATING SERVICE, 765-1234, FOR LOCATION OF EXISTING UTILITIES.
- 3. PRIOR TO CONSTRUCTION, THE CONTRACTOR SHALL EXCAVATE AND VERIFY THE HORIZONTAL AND VERTICAL LOCATIONS OF ALL CONNECTIONS. SHOULD A CONFLICT EXIST, THE CONTRACTOR SHALL NOTIFY THE ENGINEER SO THAT THE CONFLICT CAN BE RESOLVED WITH A MINIMUM AMOUNT OF DELAY.
- 4. BACKFILL COMPACTION SHALL BE ACCORDING TO TRAFFIC/STREET USE.
- 5. MAINTENANCE OF THESE FACILITIES SHALL BE THE RESPONSIBILITY OF THE OWNER OF THE PROPERTY SERVED. 7. WORK ON ARTERIAL STREETS SHALL BE PERFORMED ON A 24-HOUR BASIS.


EROSION CONTROL NOTES:

- 1. CONTRACTOR IS RESPONSIBLE FOR MAINTAINING RUN-OFF ON SITE DURING
- 2. CONTRACTOR IS RESPONSIBLE FOR CLEANING ALL SEDIMENT THAT GETS INTO EXISTING RIGHT-OF-WAY.
- 3. REPAIR OF DAMAGED FACILITIES AND CLEANUP OF SEDIMENT ACCUMULATIONS ON ADJACENT PROPERTIES AND IN PUBLIC FACILITIES IS THE RESPONSIBILITY OF THE CONTRACTOR.
- 4. ALL EXPOSED EARTH SURFACES MUST BE PROTECTED FROM WIND AND WATER EROSION PRIOR TO FINAL (CITY) ACCEPTANCE OF ANY PROJECT.

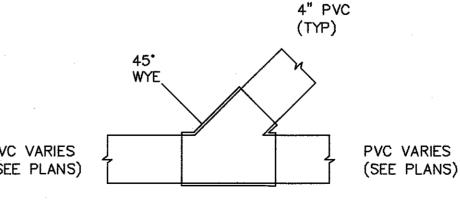

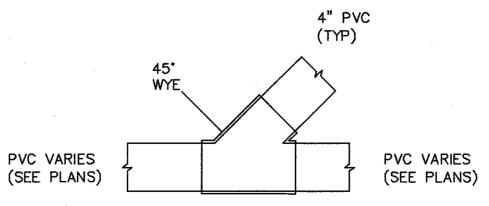

WYE TYPICAL NOT TO SCALE

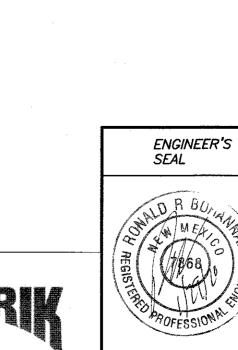

ENGINEER'S SEAL	
R BUTTO OF REGISTERATION OF RESISTERATION RESISTERATION OF RESISTERATION OF REGISTERATION O	F
RONALD R. BOHANNAN P.E. #7868	

	MAVERIK UNIVERSITY &	
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	T 5571 MIDWAY ALBUQUERO (505)	

PARK PLACE NE QUE, NM 87109 858-3100 www.tierrawestllc.com

DRAWN BY MENAUL 9/3/2019 DRM PLAN 2018062-C2-GRB SHEET # C4

2018062

---- RIGHT-OF-WAY 5010——— CONTOUR MAJOR CONTOUR MINOR SPOT ELEVATION x 5048.25 FLOW ARROW — — EXISTING CURB & GUTTER EXISTING BOUNDARY LINE GRAPHIC SCALE EXISTING CONTOUR MAJOR EXISTING CONTOUR MINOR **EXISTING SPOT ELEVATION** x 5048.25 SCALE: 1"=20' 12"x12" CATCH BASIN (NDS OR EQUAL) DROP INLET CURB INLET

MAX. DEPTH FROM
TOP OF ECCENTRIC
CONE TO RIM IS 24"

6' DIA. PRECAST

MANHOLE

4.5'x4.5' BLOCK____

COMPACTED 3/4" CRUSHED/WASHED

WATER QUALITY MANHOLE

LEGEND

MANHOLE SHALL BE CONSTRUCTED TO BE ACCESSIBLE BY VAC TRUCK FOR CLEANING AND MAINTENANCE.

BOTTOM OF MANHOLE

MANHOLE BASE

PER PLAN

CURB & GUTTER

---- EASEMENT

BOUNDARY LINE

STORM MANHOLE FRAME AND COVER RIM=PER PLAN

PAVEMENT -

STEPS TO— BE INSTALLED


(2) 1-1/2" DRAIN LINES-INV (IN)=PER PLAN


6" GROUT FILLET \
AROUND BASE


PLACE FILTER FABRIC AROUND TOP AND SIDES OF GRAVEL


5'x5' CONCRETE-PAD AROUND MANHOLE

KEYED NOTE: (A) WATER QUALITY INLET W/ BIOSNOUT - SEE DETAIL SHEET C11

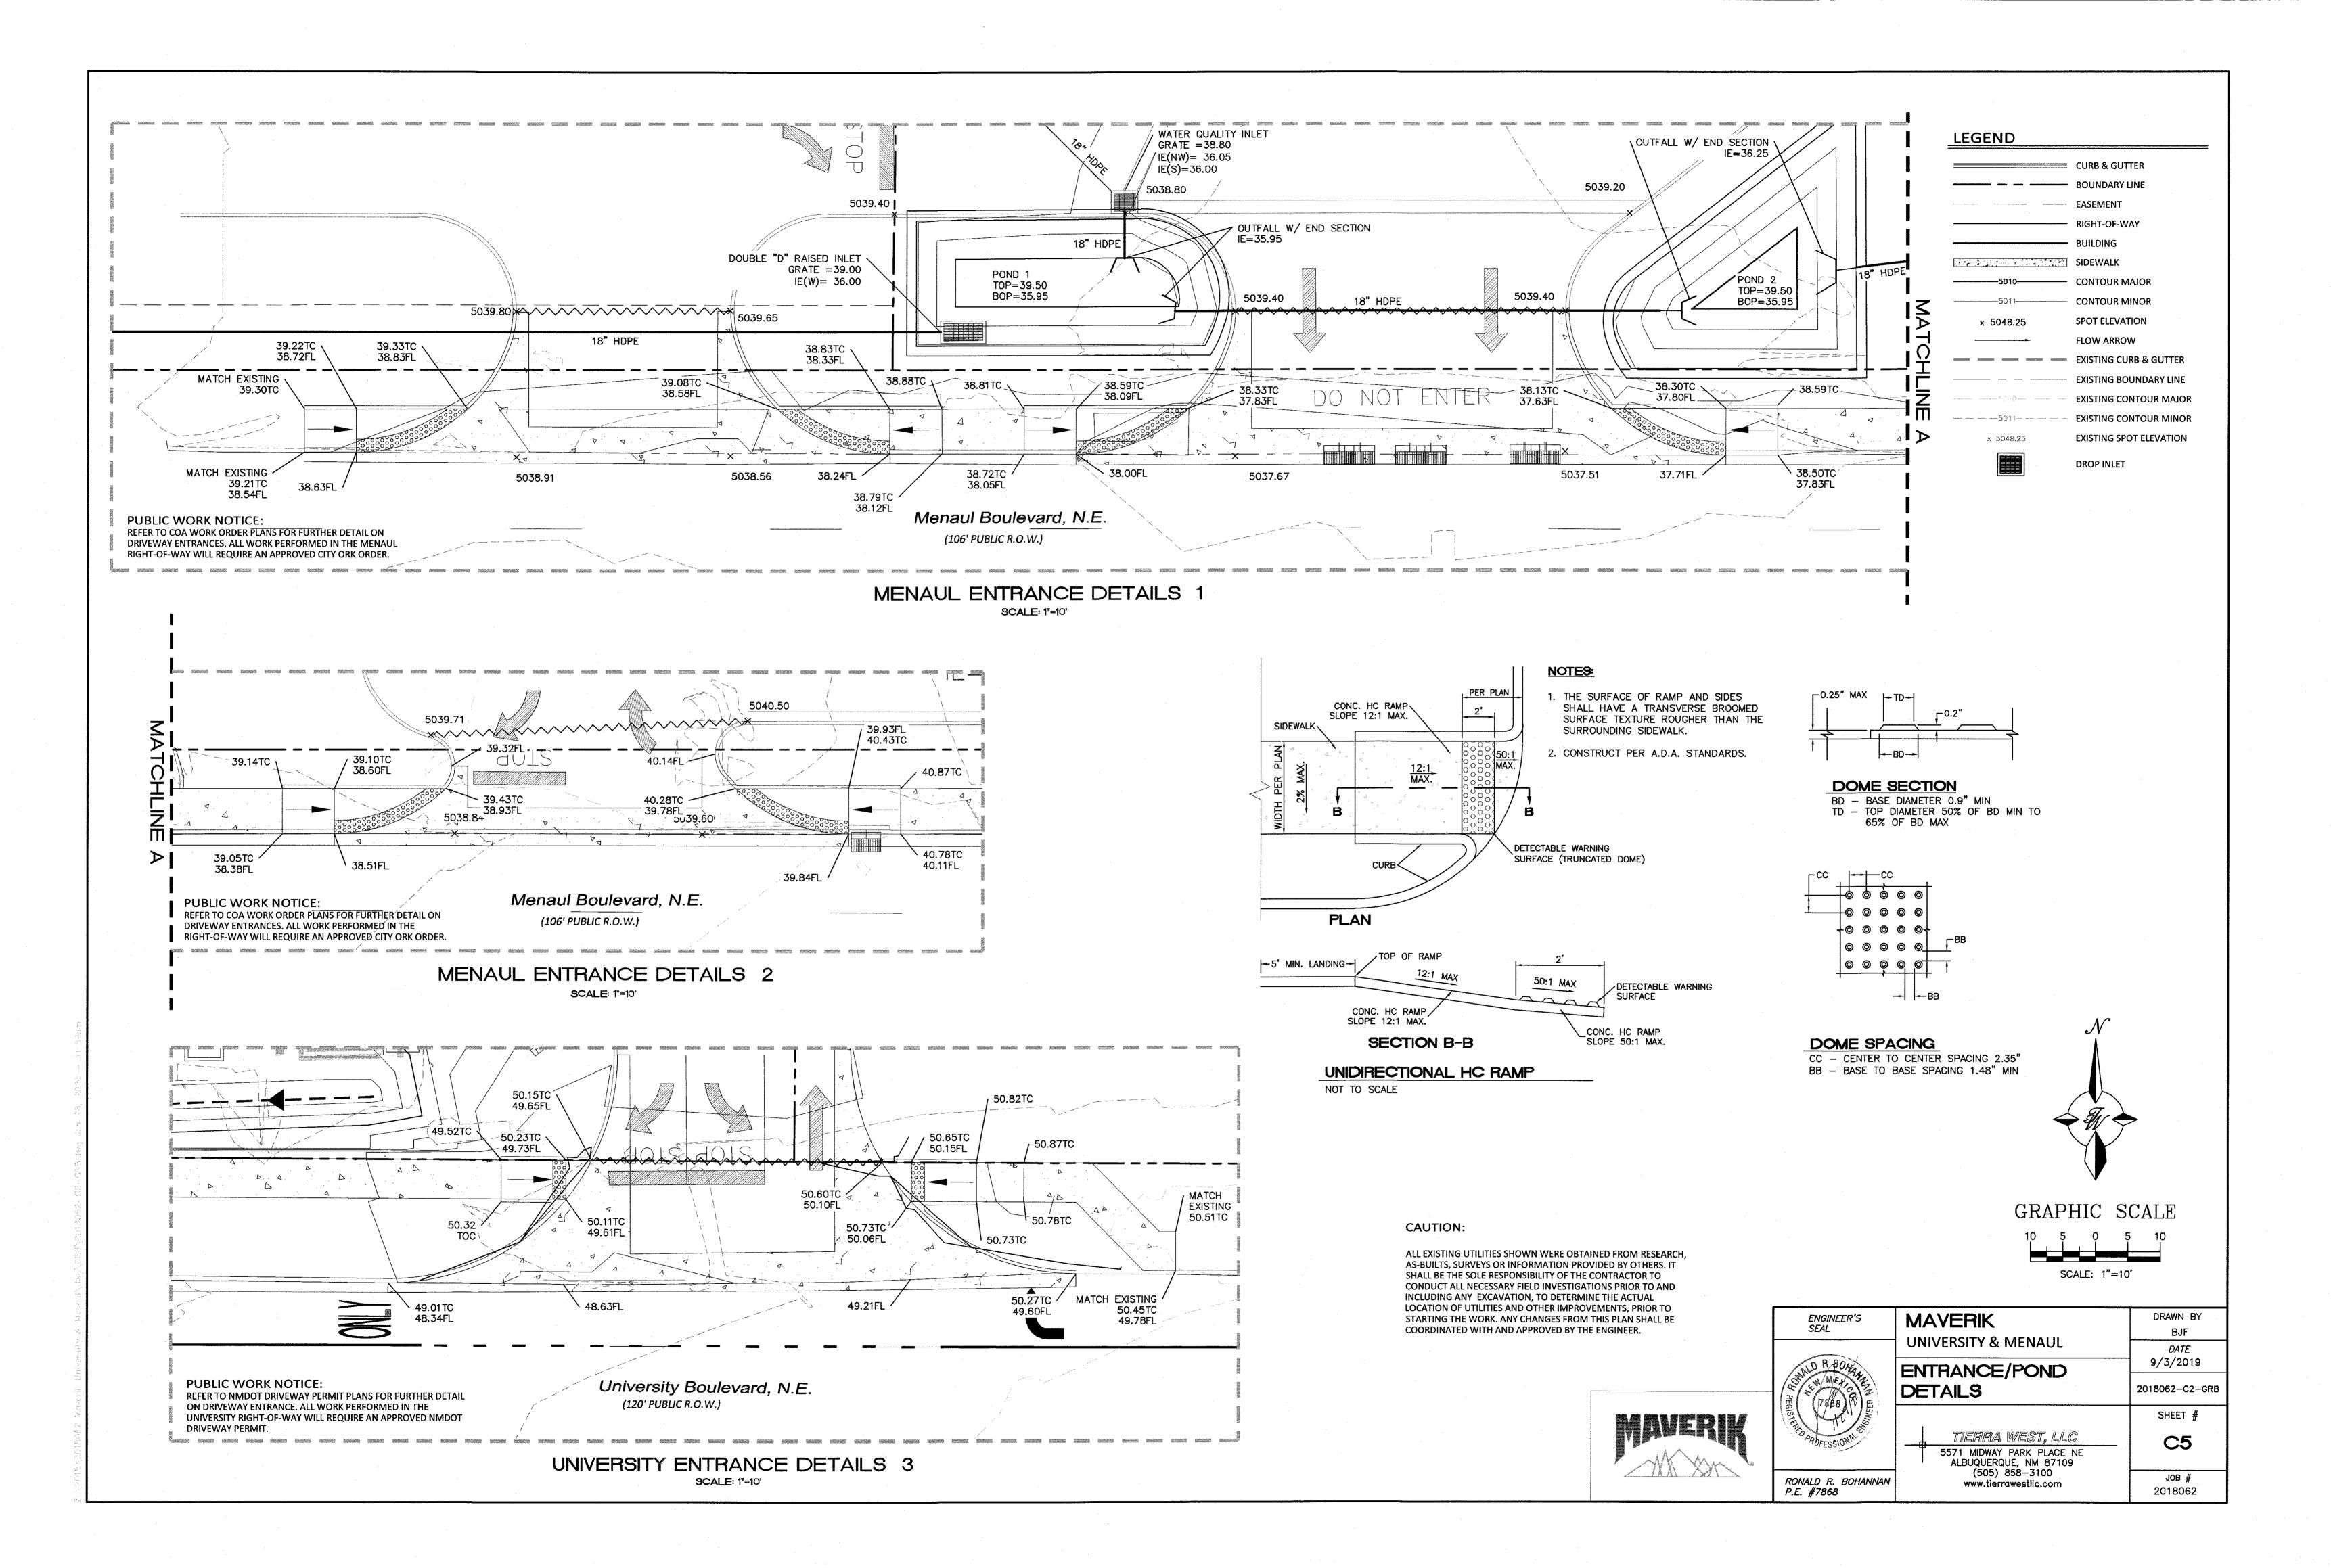

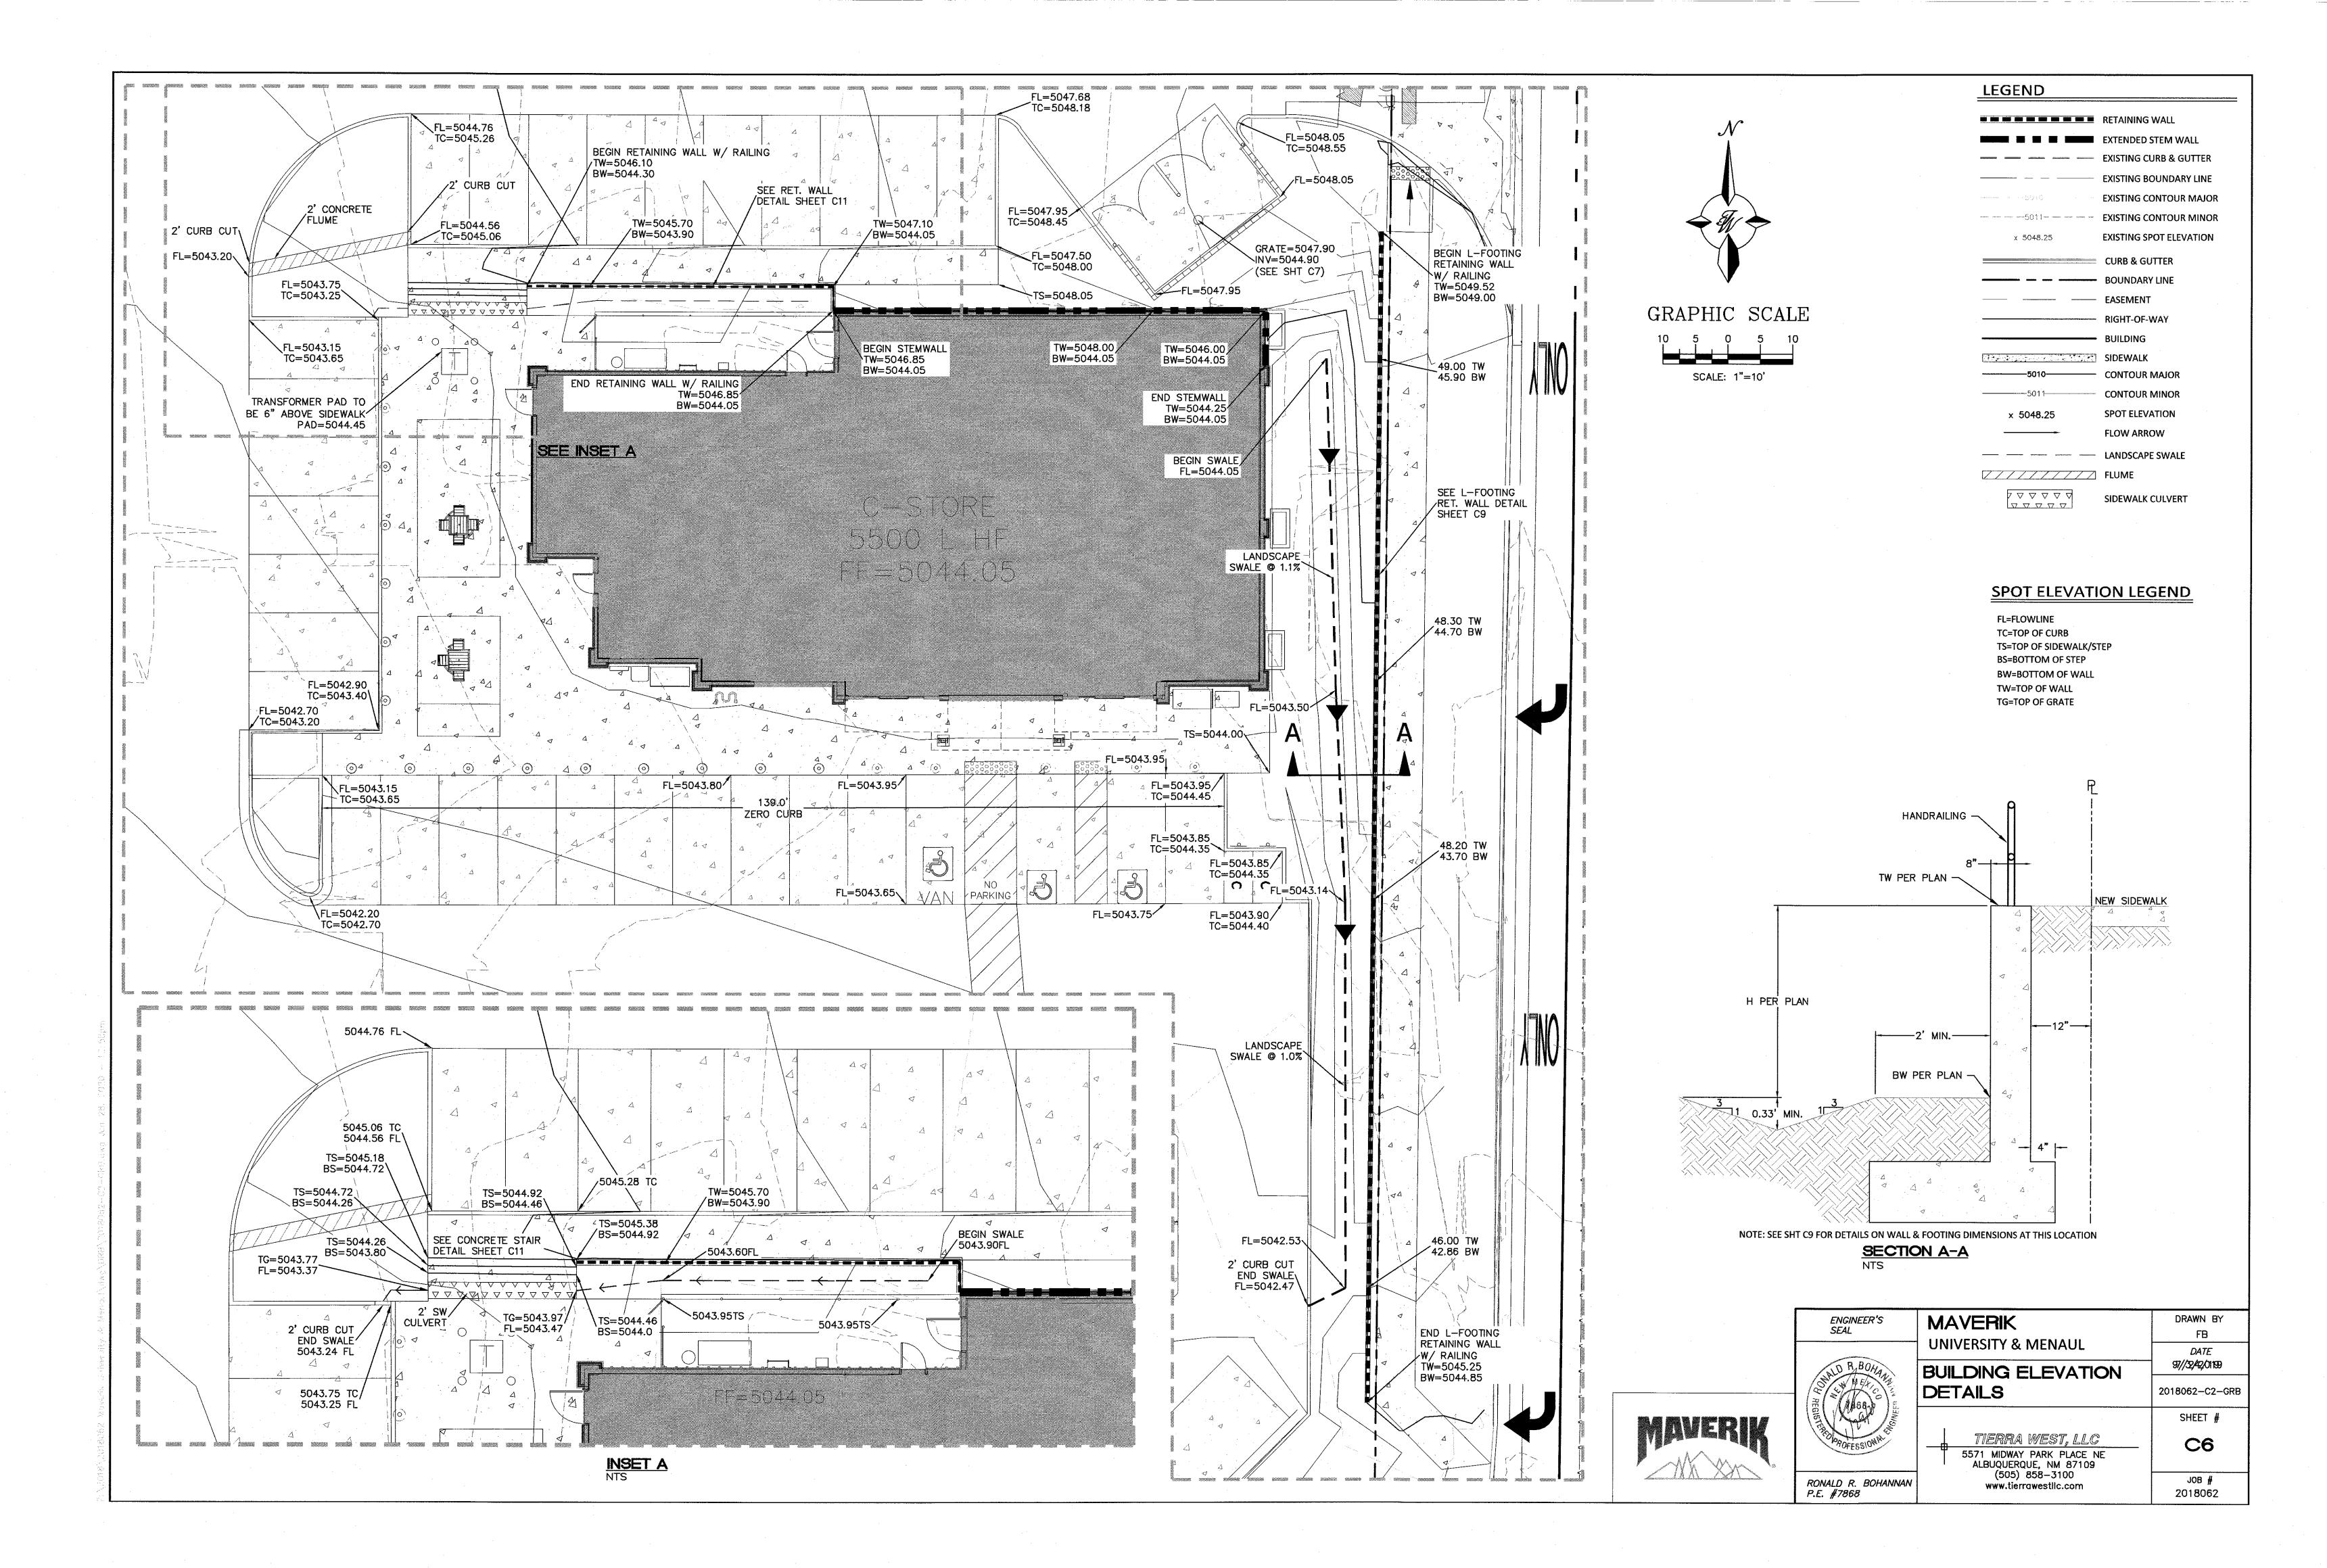


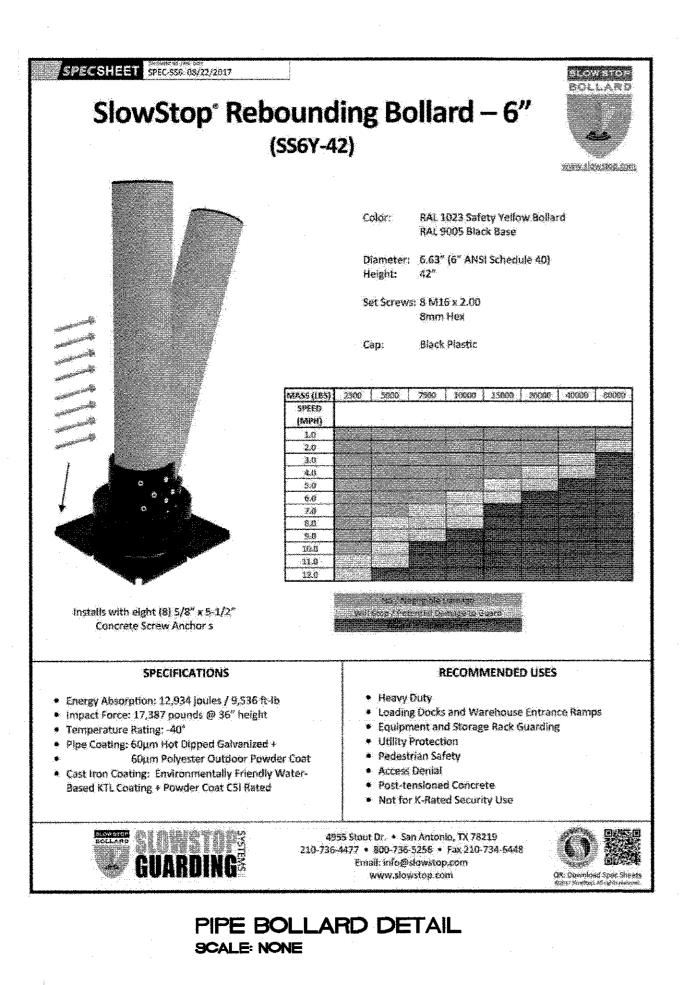

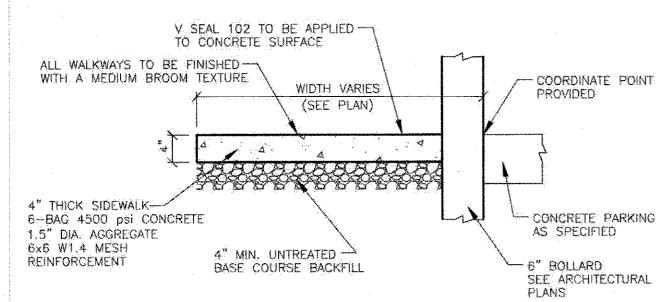

(REFER TO THE SITE SPECIFIC GEOTECHNICAL REPORT; GEOTECHNICAL REPORT TO GOVERN & CONTROL.) CONCRETE SIDEWALK DETAIL

SCALE: NONE

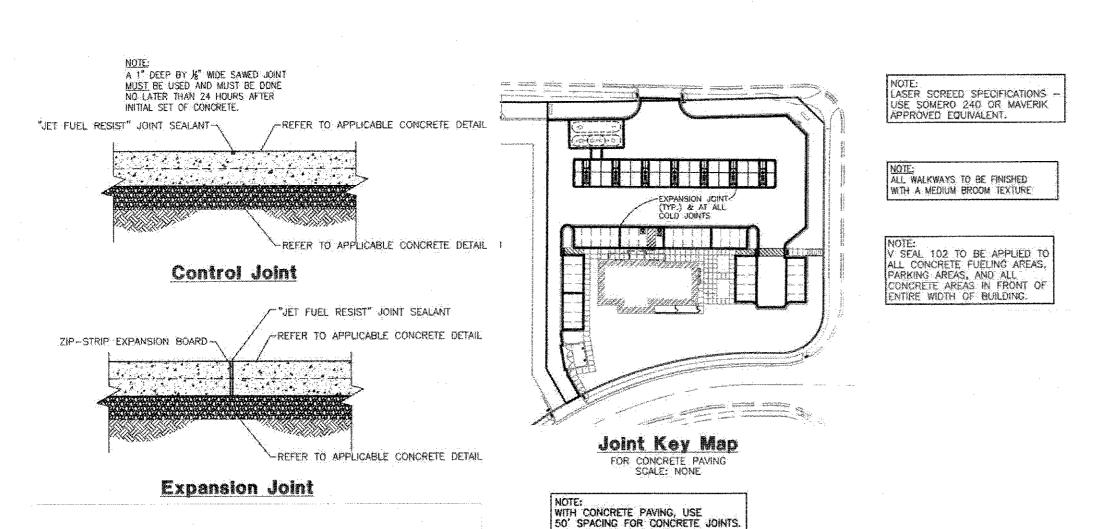

4"DIAMETER "U' BOLLARD PAINTED (COLOR: P-4) AND SET AND FILLED WITH CONCRETE BY GENERAL CONTRACTOR. EXTEND 3'-6" ABOVE FINISH SLAB OR MAVERIK BUILDING GRADE. CONSTRUCTION, CONTRACTION, ISOLATION, OR DOWEL JOINTS. SEE SPECIFICATIONS. PROVIDE "JET FUEL RESISTANT" JOINT SEALANT. SEE SPECIFICATIONS. - BOLLARD TO BE SET IN CONCRETE. SLOPE TOP OF CONCRETE AWAY FROM 2% MA . TYP. SLOPE 1/4 SLOPE 1/4"5 PER FOOT \longrightarrow

> - 6" RAISED CONCRETE ISLAND WITH TOOLED EDGES AND CORNERS $-5'-0" \times 3'-0"$

SCALE: NONE

HOOP BOLLARD DETAIL

CONCRETE ISLAND (NO METAL


FORM - VERIFY SIZE WITH


DISPENSER MANUF.).


GENERAL NOTES:

- 1. ALL CONCRETE IS TO BE 3000 PSI @ 28 DAYS. 2. MINIMUM COMPACTION UNDER FOOTINGS IS TO BE 95% PER ASTM. D 1557 FOR A DEPTH OF 12" MOISTURE CONTENT
- IS TO BE \pm 2.0%. 3. BACK FILL AGAINST WALLS IS TO BE HAND-PLACED AND
- COMPACTED. 4. ALL BARS ARE TO BE GRADE 60, ASTM 615.
- 5. TRUSS TYPE DUR-O-WALL EVERY OTHER COURSE. 6. USE EITHER KEYED EXPANSION JOINTS ON 20' CENTERS OR PILASTERS EVERY 12'.
- 7. 30 BAR DIAMETER LAPS TYPICAL. 8. DUR-O-WAL HORIZONTAL JOINT REINFORCEMENT 16" O.C.
- 9. OWNER TO SELECT MASONRY COLOR AND/OR FINISH

L-FOOTING RETAINING WALL DETAIL

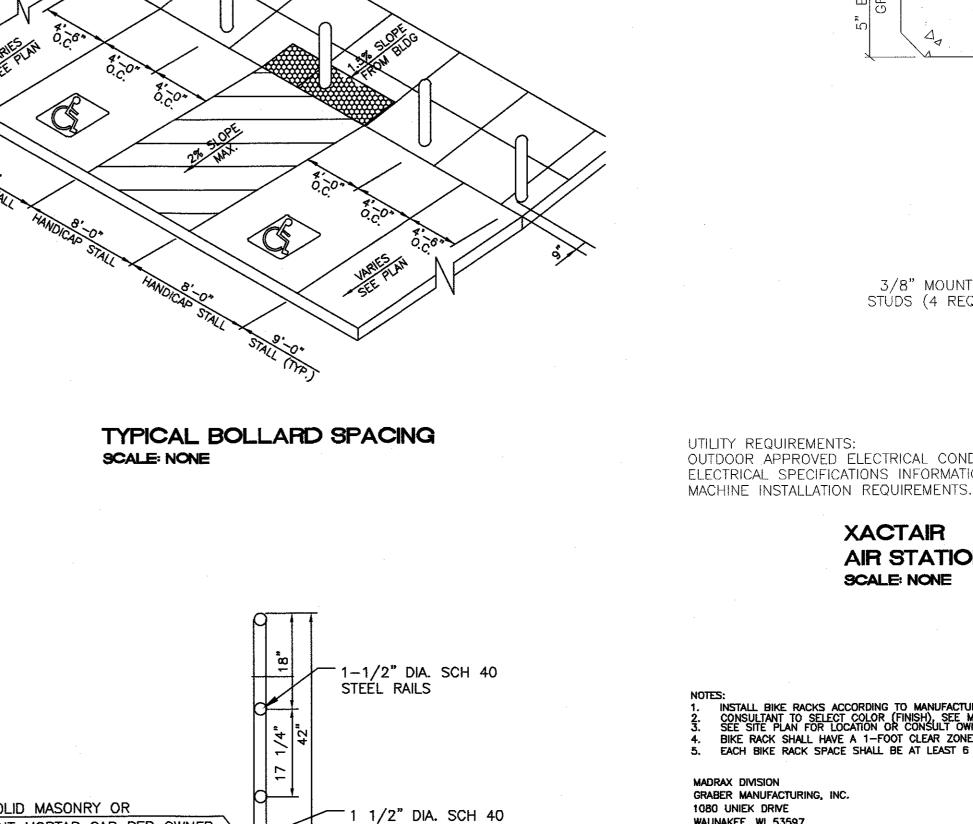


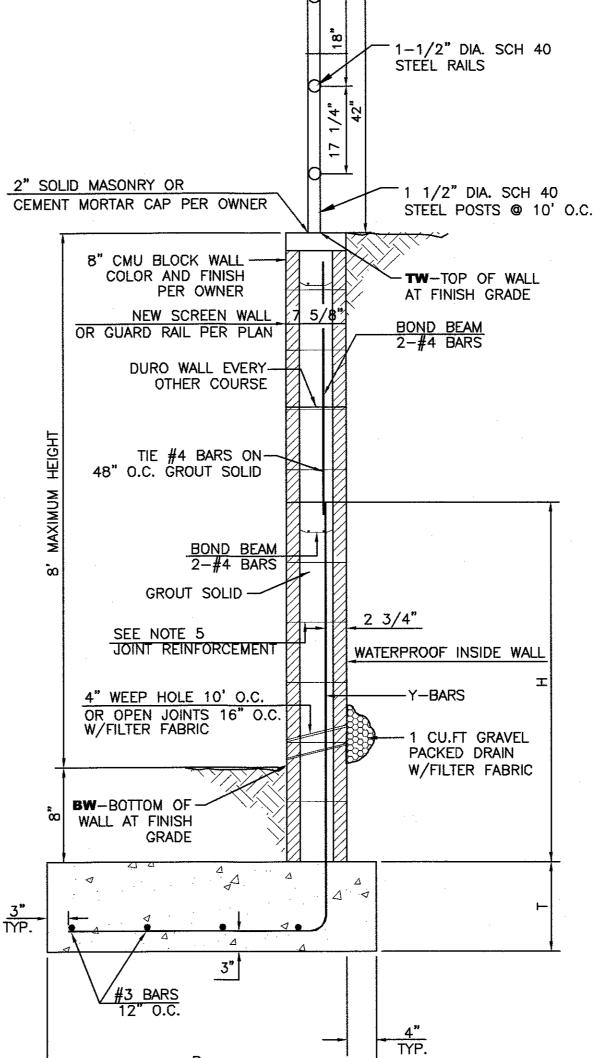

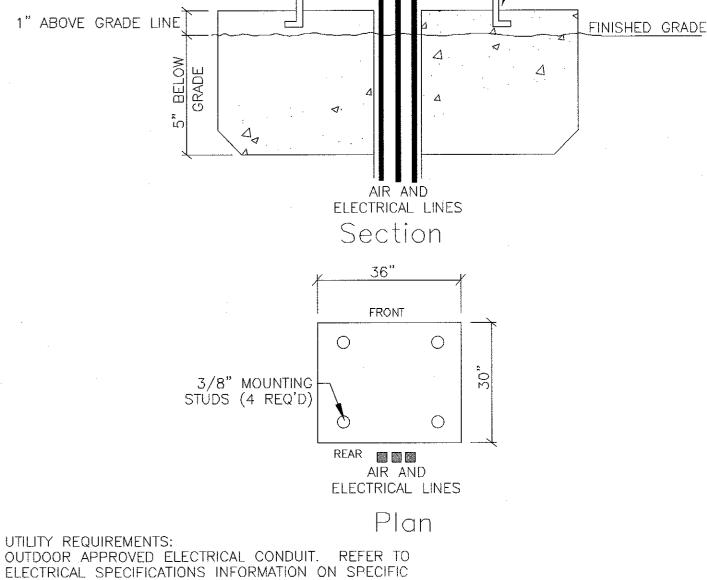


-3/8" MOUNTING STUDS (4 REQ'D)

XACTAIR AIR STATION FOUNDATION SCALE: NONE

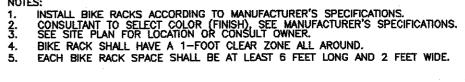

MADRAX DIVISION
GRABER MANUFACTURING, INC. 1080 UNIEK DRIVE WAUNAKEE, WI 53597 P(800) 448-7931, P(608) 849-1080, F(608) 849-1081 WWW.MADRAX.COM, E-MAIL: SALES@MADRAX.COM

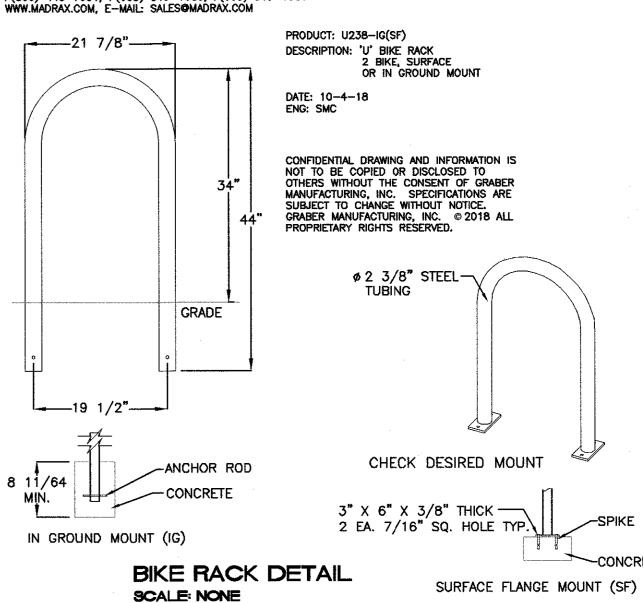

ENGINEER'S SEAL	MAVERIK	DRAWN BY DY
RONALD R. BOHANNAN P.E. #7868	UNIVERSITY & MENAUL	<i>DATE</i> 9/3/2019
	CONSTRUCTION DETAIL	3/0/2013
	2	2018062-C8-DETAILS
		SHEET #
	TIERRA WEST, LLC 5571 MIDWAY PARK PLACE NE ALBUQUERQUE, NM 87109	C9
	(505) 858-3100 www.tierrawestllc.com	JOB # 2018062





