CITY OF ALBUQUERQUE

*Planning Department* Alan Varela, Director



Mayor Timothy M. Keller

September 12, 2024

Ubaldo Muñoz Jeebs & Zuzu, LLC 5924 Anheim NE Suite A Albuquerque, NM 87113

ubaldo@jeebsandzuzu.com

## Re: New Contractor Yard w/ metal building 2010 Claremont NE Traffic Circulation Layout Engineer's Stamp Dated 9-5-24 (H15D004A)

Dear Muñoz,

The TCL submittal received 9-10-2024 is approved for Building Permit by Transportation. A copy of the stamped and signed plan will be needed for each of the building permit plans. Please keep the original to be used for certification of the site for final C.O. for Transportation.

When the site construction is completed and an inspection for Certificate of Occupancy (C.O.) is requested, use the original City stamped approved TCL for certification. Redline any minor changes and adjustments that were made in the field. A NM registered architect or engineer must stamp, sign, and date the certification TCL along with indicating that the development was built in "substantial compliance" with the TCL. Submit this certification, the TCL, and a completed Drainage and Transportation Information Sheet to the PLNDRS@cabq.gov for log in and evaluation by Transportation.

WWW.cabq.gov Once verification of certification is completed and approved, notification will be made to Building Safety to issue Final C.O. To confirm that a final C.O. has been issued, call Building Safety at 924-3690.

Sincerely,

Sertil A. Kanbar

Sertil Kanbar, PhD,PE,CFM Sr. Engineer, Planning Dept. Development Review Services

C: CO Clerk, File



# City of Albuquerque


Planning Department Development & Building Services Division DRAINAGE AND TRANSPORTATION INFORMATION SHEET (REV 11/2018)


Project Title: <u>New Contractor Yard w/ m</u>	etal building Building	Permit #: Hydrology File #:
DRB#:	EPC#:	Work Order#:
		EVELOPMENT AREA (BEING COMPRISED OF PARCEL B-1 MENAUL DEVELOPMENT AREA) CONT .6874 AC
City Address: 2010 Claremont Ave. NE	Albuquerque NM 8710	7
		Contact: Ubaldo Muñoz
Address: 5924 Anaheim Ave. NE Suite		
Phone#: <u>505-797-1318</u>	Fax#:	E-mail: ubaldo@jeebsandzuzu.com
Owner: Juan Carlos Garcia		Contact: Ubaldo Muñoz
Address: 2010 Claremont Ave. NE Albu		
Phone#: <u>505-797-1318</u>	Fax#:	E-mail: ubaldo@jeebsandzuzu.com
		RESIDENCE DRB SITE ADMIN SITE
IS THIS A RESUBMITTAL?: X	Yes	No
DEPARTMENT: X TRAFFIC/ TH	RANSPORTATION	HYDROLOGY/ DRAINAGE
Check all that Apply: TYPE OF SUBMITTAL: ENGINEER/ARCHITECT CERTIFICATION PAD CERTIFICATION CONCEPTUAL G & D PLAN CONCEPTUAL G & D PLAN GRADING PLAN DRAINAGE MASTER PLAN DRAINAGE MASTER PLAN DRAINAGE REPORT FLOODPLAIN DEVELOPMENT PERMIT APPLIC ELEVATION CERTIFICATE CLOMR/LOMR X TRAFFIC CIRCULATION LAYOUT (TCL) TRAFFIC IMPACT STUDY (TIS) OTHER (SPECIFY)		<b>TYPE OF APPROVAL/ACCEPTANCE SOUGHT:</b> ×  BUILDING PERMIT APPROVAL   CERTIFICATE OF OCCUPANCY    PRELIMINARY PLAT APPROVAL   SITE PLAN FOR SUB'D APPROVAL   SITE PLAN FOR BLDG. PERMIT APPROVAL   SITE PLAN FOR BLDG. PERMIT APPROVAL   SITE PLAN FOR BLDG. PERMIT APPROVAL   SIA/ RELEASE OF FINANCIAL GUARANTEE   GRADING PERMIT APPROVAL   GRADING PERMIT APPROVAL   GRADING/ PAD CERTIFICATION   WORK ORDER APPROVAL   CLOMR/LOMR   FLOODPLAIN DEVELOPMENT PERMIT


DATE SUBMITTED: 9-5-2024 By: U

\_\_\_\_\_By: <u>Ubaldo Muñ</u>oz


ELECTRONIC SUBMITTAL RECEIVED:

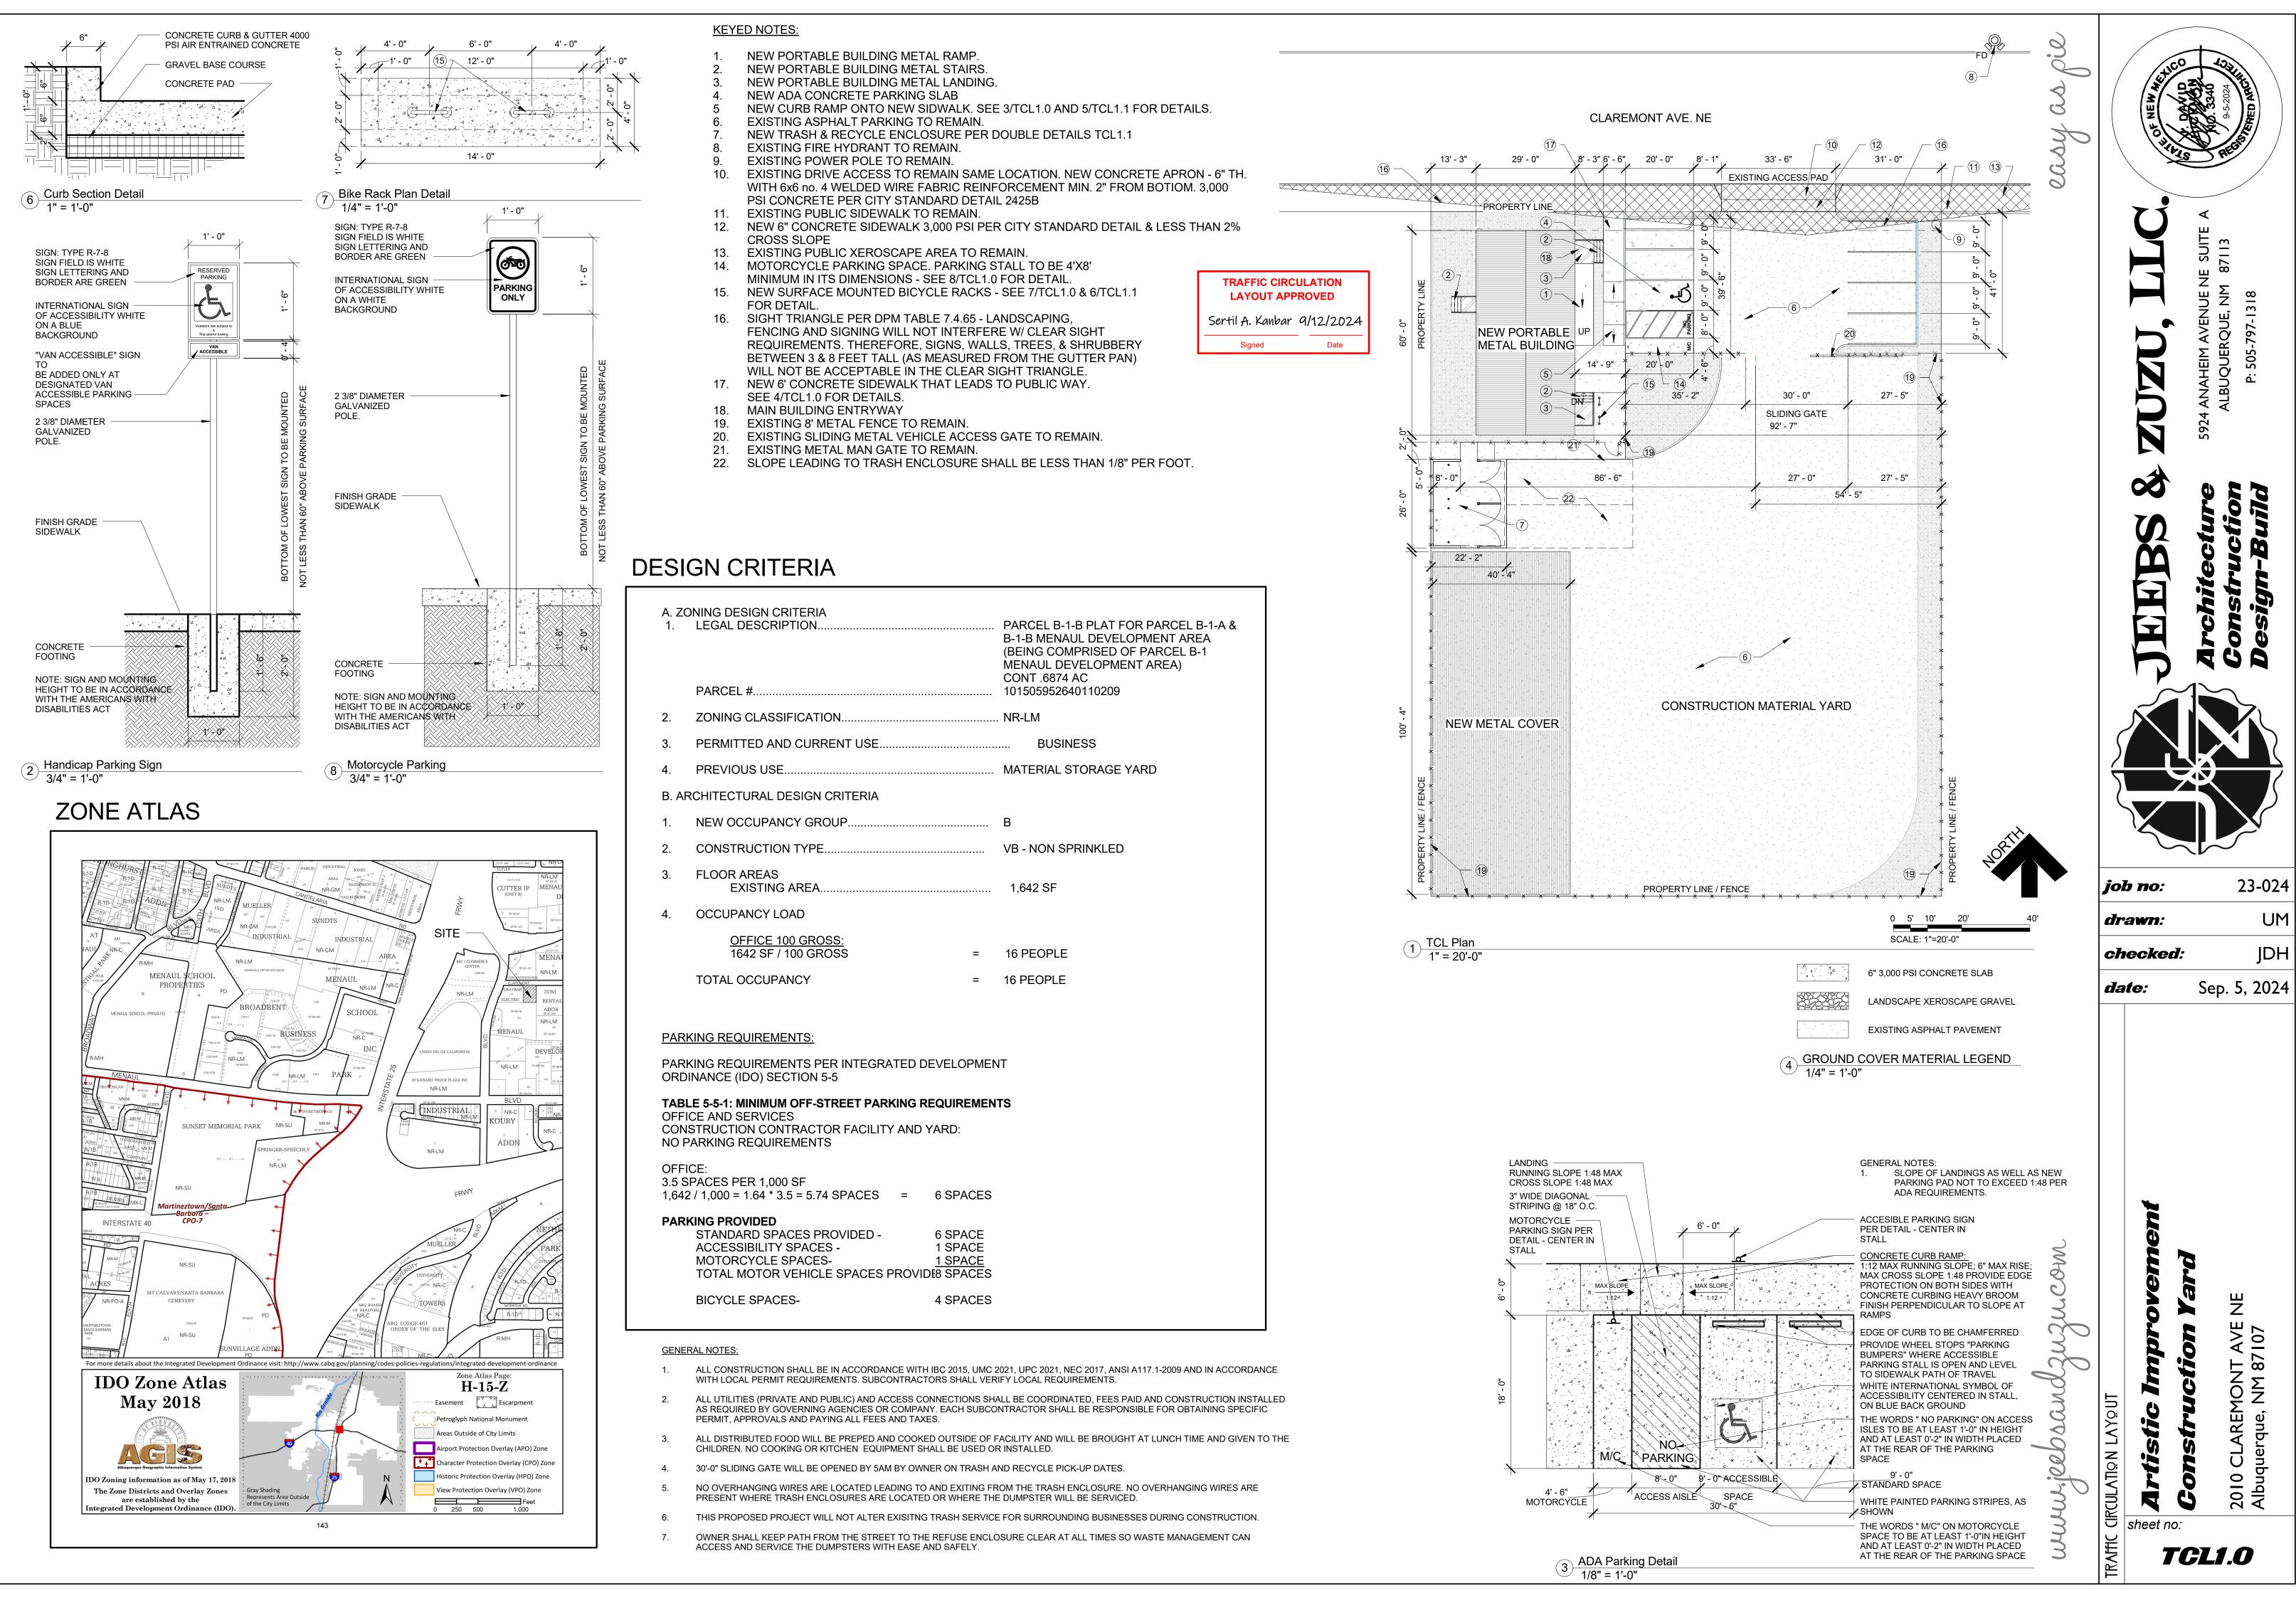

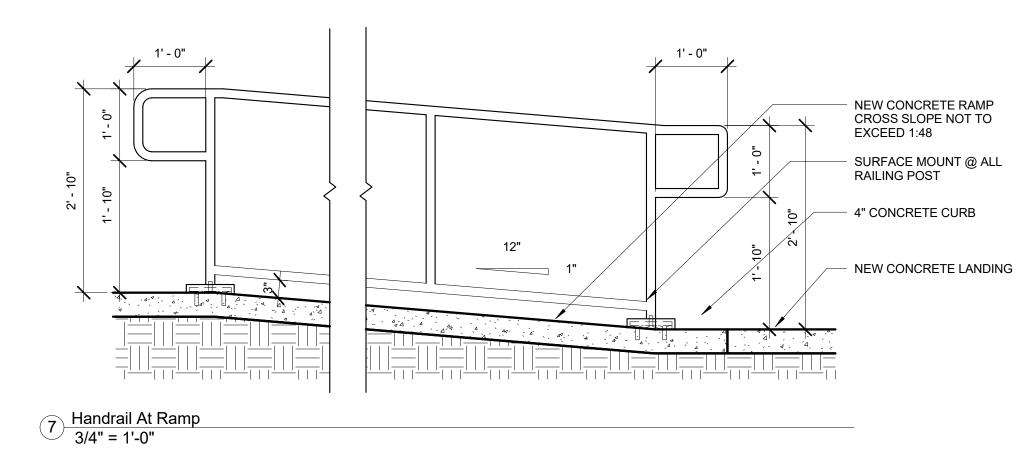


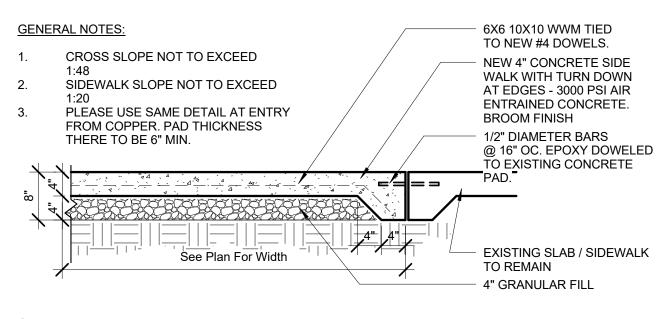



8 Sidewalk Detail 3/4" = 1'-0"

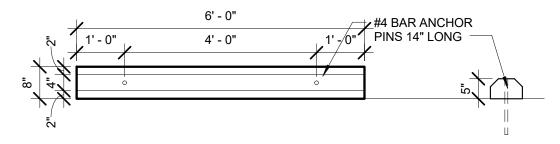


10 Concrete Bumper Detail

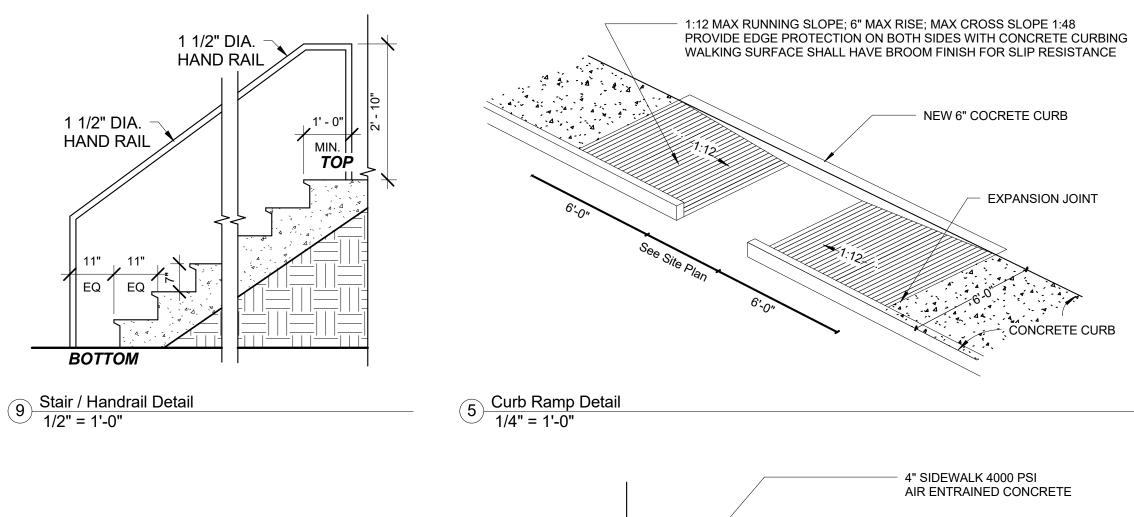


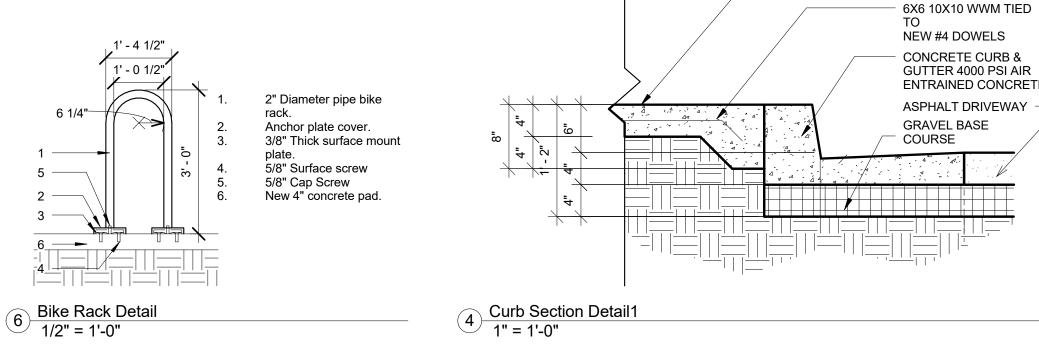

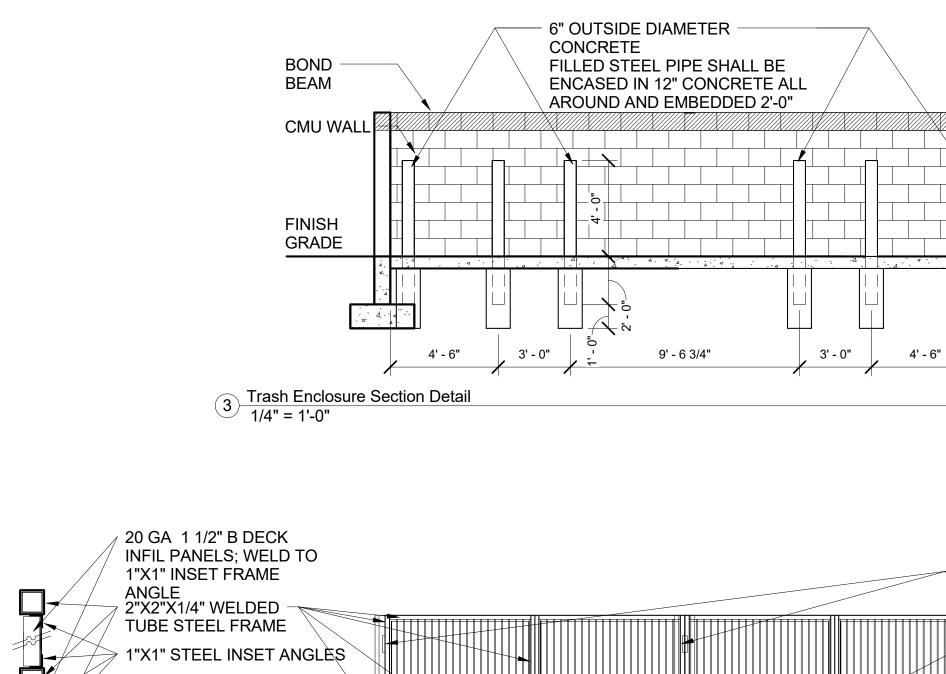

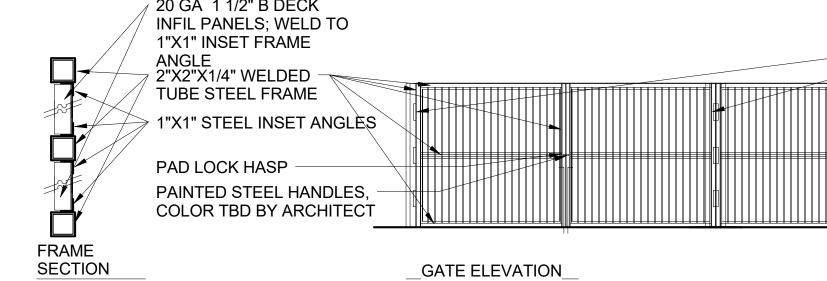

1 Trash Enclosure (Metal) Elevation Detail 1/4" = 1'-0"

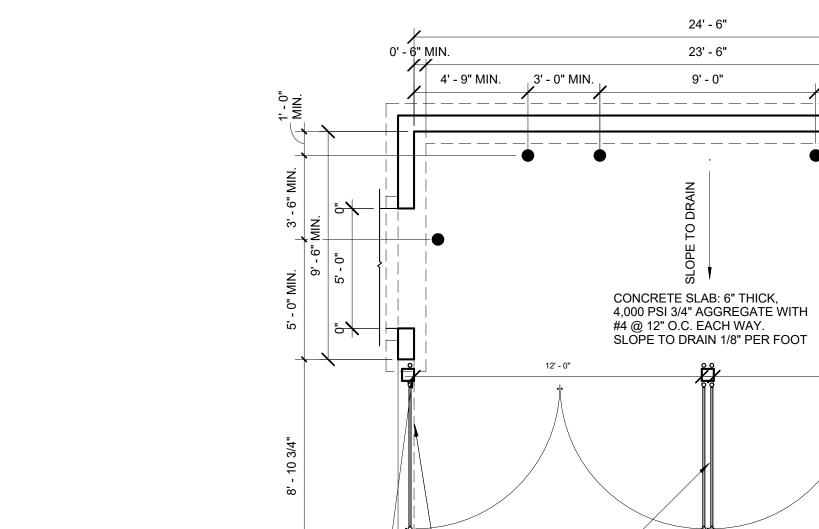

OPEN AREA, PAINT COLOR TBD BY

ARCHITECT

2 Double Trash Enclosure (Metal) Plan Detail 1/4" = 1'-0"

NEW 6" COCRETE CURB

. 44 . CONCRETE CURB

EXPANSION JOINT

4" SIDEWALK 4000 PSI AIR ENTRAINED CONCRETE

NEW #4 DOWELS CONCRETE CURB & GUTTER 4000 PSI AIR ENTRAINED CONCRETE

6" STEEL GATE — POST PAINT TBD BY ARCHITECT

12' - 0" \_\_\_\_\_ 14 GA. PERFORATED ~ STEEL PLATE OVER STEEL BRACING, 20%

 $\bullet$ 

APRON: 6" THICK 4,000 PSI 3/4" AGREGATE WITH #4 @ 12" O.C. EACH 12'-0" x 8'-0" WITH 1/2" EXPANSION JOINT OVER 6" COMPACTED AGGREGATE BASE.

Die **S** 24 Ca E SUIT 87113 **TRAFFIC CIRCULATION** LAYOUT APPROVED NM -797-1318 Sertil A. Kanbar 9/12/2024 QUE, - **F** ¥ Signed Date 505 ğ <u>ن</u>ه AN/ ALBU N ŝ S 5 RUA - CMU WALL HEAVY DUTY HINGES SET (2) GATE LOCK DEVICES W/ INTEGRAL FLUSH BOLT AND PAD LOCK CAST STEEL SLEEVE IN CONC FOR FLUSH BOLT 23-024 **job no**: - 6" STEEL GATE POST PAINT TBD BY ARCHITECT UM drawn: NOTE: All Metal components, Including gate, hardware, handles, frame, angles, and inset panels shall be painted JDH checked: Sep. 5, 2024 date: REAR BOLLARDS ARE TO BE 12" FROM CENTER OF BOLLARD TO WALL 0' - 6"/MIN. 3' - 0" MIN 4' - 9" MIN SIDE BOLLARDS ARE TO BE 6" FROM CENTER OF BOLLARD TO WALL LANDING: SLOPES NOT TO EXCEED 1:48 SLOPE IN ALL DIRECTIONS OF TRAVEL 5' - 6" MIN. A A A A A LEVEL LANDING MO  $\mathbf{O}$ ШZ NEW 6 " CURB 2010 CLAREMONT AVE Albuquerque, NM 87107  $\vec{\mathcal{D}}$ 3'-0" MIN 14 GA. PERFORATED STEEL PLATE PEDESTRIAN ction 3 n 1:12 CURB RAMP DETAILS duu GATE rjeebsand: CONCRETE CURB RAMP: 1:12 MAX RUNNING SLOPE; 6" MAX RISE; MAX CROSS SLOPE 1:48 PROVIDE EGE PROTECTION ON BOTH SIDES WITH CONCRETE CURBING HEAVY BROOM FINISH CIRCULATION LAYOUT 0 St PERPENDICULAR TO SLOPE AT DRILL HOLES IN PAD RAMPS. FOR GATE PIN NEW SIDEWALK - SEE SITE PLAN DRILL HOLES IN APRON FOR GATE PIN mmm  $\mathbf{C}$ sheet no:

**TCL1.1** 

TRAFFIC