

Vicinity Map Scale: 1"=750'

H-15


Design Data

TRACT A-1

LANDS OF RAY KAEHR
BERNALILLO COUNTY,
ALBUQUERQUE, NM LEGAL DESCRIPTION H-15-Z ZONE ATLAS PAGE: APPLICABLE BUILDING CODE: IBC-2003 SEISMIC DESIGN CATAGORY WIND DESIGN SPEED (3-SECOND GUST): TYPE OF CONSTRUCTION NUMBER OF STORIES: TOTAL BUILDING AREA: 8,250 SQ. FT. OCCUPANCY GROUPS: MIXED - UNSEPARATED GROUP F-1 (FACTORY & INDUSTRIAL): 7,788 SQ. FT. GROUP B (OFFICE): 462 SQ. FT. ALLOWABLE BUILDING AREA: IBC TABLE 503 GROUP F-1: GROUP B: 15,500 SQ. FT. 23,000 SQ. FT. OCCUPANT LOAD: IBC TABLE 1004.1.2 OFFICE: 462/100 = SHOP: 7,788/100 = 5 OCC. 78 OCC. 83 OCC. TOTAL OCCUPANT LOAD: TWO EXITS REQUIRED: TWO EXITS PROVIDED PLUMBING SYSTEMS: IBC TABLE 2902.1 WATER CLOSETS REQ'D: (FACTORY 1/100) + (OFFICE 1/25) =WATER CLOSETS PROVIDED: LAVATORIES REQ'D: (FACTORY 1/100) + (OFFICE 1/40) =LAVATORIES PROVIDED: DRINKING FOUNTAIN REQ'D: (FACTORY 1/400) + (OFFICE 1/100) = DRINKING FOUNTAIN PROVIDED: SERVICE SINK REQ'D: SERVICE SINK PROVIDED REQUIRED OFF-STREET PARKING: 7,788/1,000 + 462/200 =10 SPACES OFF-STREET PARKING PROVIDED: 10 SPACES

ONE HC SPACE DESIGNATED VAN ACCESSIBLE

3" MINIMUM THICKNESS ASPHALT PAVEMENT OVER 6"
AGGREGATE BASE COURSE OVER SUBGRADE COMPACTED TO
95 PERCENT OF PROCTOR DENSITY.

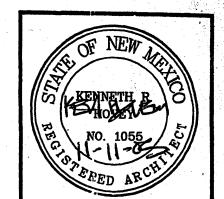

Finishing Metal 2 Plating

Kaehr

言 A

JOB I	VO :	0	512				
DATE:	9	NO	VEM	BER	2	005	j .
	•	R	EVIS	ONS	-		
						· .	· · ·
·							
		·					
				÷			

SHEET NO.

EROSION CONTROL MEASURES

- 1. THE CONTRACTOR SHALL BE HELD RESPONSIBLE FOR MANAGEMENT OF STORM RUN-OFF DURING CONSTRUCTION, HE SHALL ASSURE THAT THE FOLLOWING MEASURES ARE
- A) ADJACENT PROPERTY SHALL BE PROTECTED AT ALL TIMES BY TEMPORARY BERMS, DIKES, SWALES, AND OTHER TEMPORARY GRADING AS REQUIRED TO PREVENT STORM RUN-OFF FROM LEAVING THE SITE AND ENTERING ADJACENT PROPERTY.
- B) ADJACENT PUBLIC RIGHT-OF-WAY SHALL BE PROTECTED AT ALL TIMES FROM STORM WATER RUN-OFF FROM THE SITE. NO SEDIMENT BEARING WATER SHALL BE PERMITTED TO ENTER THE PUBLIC STREETS.
- 2. THE CONTRACTOR SHALL IMMEDIATELY AND THOROUGHLY REMOVE ANY OR ALL SEDIMENT WITHIN THE PUBLIC STREETS THAT HAVE BEEN ERODED FROM THE SITE AND DEPOSITED THERE.

GRADING/DRAINAGE PLAN

THE FOLLOWING ITEMS CONCERNING (1425 CANDELARIA ROAD N.E.)
TRACT A1 LAND OF KAEHR-RAY J, CITY OF ALBUQUERQUE, NEW MEXICO ARE CONTAINED HEREON:

EXISTING CONDITIONS

AS SHOWN BY THE VICINITY MAP, THE SITE CONTAINS 0.8224 ACRES MORE OR LESS. THE SITE IS LOCATED JUST WEST OF 1-25 ON THE NORTH SIDE OF CANDELARIA ROAD N.E. THE SITE IS VACANT AND SLOPES FROM WEST TO EAST. NO OFF-SITE FLOWS ENTER THE SITE FROM THE WEST; FULLY DEVELOPED PARCELS CONTAIN THEIR OWN RUN-OFF (SEE ATTACHED ORTO-TOPO MAP). ACCORDING TO THE FLOOD INSURANCE RATE MAPS, PANEL 0332E, REVISED NOVEMBER 19, 2003, THIS SITE IS NOT LOCATED WITHIN A DESIGNATED FLOOD ZONE NOR DOES IT CONTRIBUTE TO ANY DOWNSTREAM FLOODING.

PROPOSED CONDITIONS

AS SHOWN BY THE GRADING/DRAINAGE PLAN, THE PROJECT WILL CONSIST OF AN 8,250 SQ. FT. METAL BUILDING ALONG WITH PAVED PARKING AND ASSOCIATED LANDSCAPED AREAS. THE SITE HAS BEEN DESIGNED TO DRAIN WEST AND SOUTH ALONG THE EXISTING 30' ACCESS AND DRAINAGE ESAEMENT. ALL THE ROOF RUN-OFF WILL BE DIRECTED TO DOWNSPOUTS ON THE EAST SIDE OF THE BUILDING. THE RUN-OFF WILL TRAVEL SOUTH ALONG THE 30' EASEMENT AND ONTO CANDELARIA ROAD N.E. THE CALCULATIONS CONTAINE HEREON; ANALYZE BOTH THE EXISTING AND DEVELOPED CONDITIONS FOR THE 100-YEAR, 6-HOUR RAINFALL EVENT. THE PROCEDURE FOR 40-ACRES AND SMALLER BASINS, AS SET FORTH IN THE REVISION OF SECTION 22.2, HYDROLOGY OF THE DEVELOPMENT PROCESS MANUEL VOLUME II, DESIGN CRITERIA DATED 1997, HAS BEEN USED TO QUANTIFY THE PEAK RATE OF DISCHARGE AND VOLUME GENERATED.

PROJECT AREA = 0.82241 ac. KAEHR PLATING & METAL FINISHING ZONE 2 PRECIPITATION: 360 = 2.35 in. 1440 = 2.75 in.10 day = 3.95 in.

EXCESS PRECIPITATION:

TREATMENT A 0.53 in. 1.56 cfs/ac. TREATMENT B 0.78 in. 2.28 cfs/ac. TREATMENT C 1.13 in. 3.14 cfs/ac. TREATMENT D 2.12 in. 4.70 cfs/ac.

PROPOSED CONDITIONS: TREATMENT A O dc. O dc. TREATMENT B 0 ac. 0.09495 ac. TREATMENT C 0.82241 ac. 0.18203 ac. TREATMENT D 0 ac. 0.54543 ac.

EXISTING EXCESS PRECIPITATION:

Weighted E = (0.53)x(0.00)+(0.78)x(0.00)+(1.13)x(0.82)+(2.12)x(0.00)/0.82 ac. = 1.13 in. V100-360 = (1.13)x(0.82)/12 = 0.077444 ac-ft = 3373 cf

EXISTING PEAK DISCHARGE:

EXISTING CONDITIONS:

Q100 = (1.56)x(0.00) + (2.28)x(0.00) + (3.14)x(0.82) + (4.70)x(0.00) = 2.58 cfsPROPOSED EXCESS PRECIPITATION:

Weighted E = (0.53)x(0.00)+(0.78)x(0.09)+(1.13)x(0.18)+(2.12)x(0.55)/0.82 ac. = 1.75 in.

V100-360 = (1.75)x(0.82)/12.0 = 0.119672 ac-ft = 5213 cf

V100-1440 = (0.12)+(0.55)x(2.75-2.35)/12 = 0.137853 ac-ft = 6005 cf


V100-10day = (0.12)+(0.55)x(3.95-2.35)/12 = 0.192396 ac-ft = 8381 cf

PROPOSED PEAK DISCHARGE:

Q100 = (1.56)x(0.00) + (2.28)x(0.09) + (3.14)x(0.18) + (4.70)x(0.55) = 3.36 CFS cfs

BENCHMARK:

ELEVATIONS ARE BASED ON CITY OF ALBUQUERQUE STATION No. "9-H15", HAVING AN ELEVATION OF 5034.93 ON THE MEDIAN ON CANDELAREA RD NE

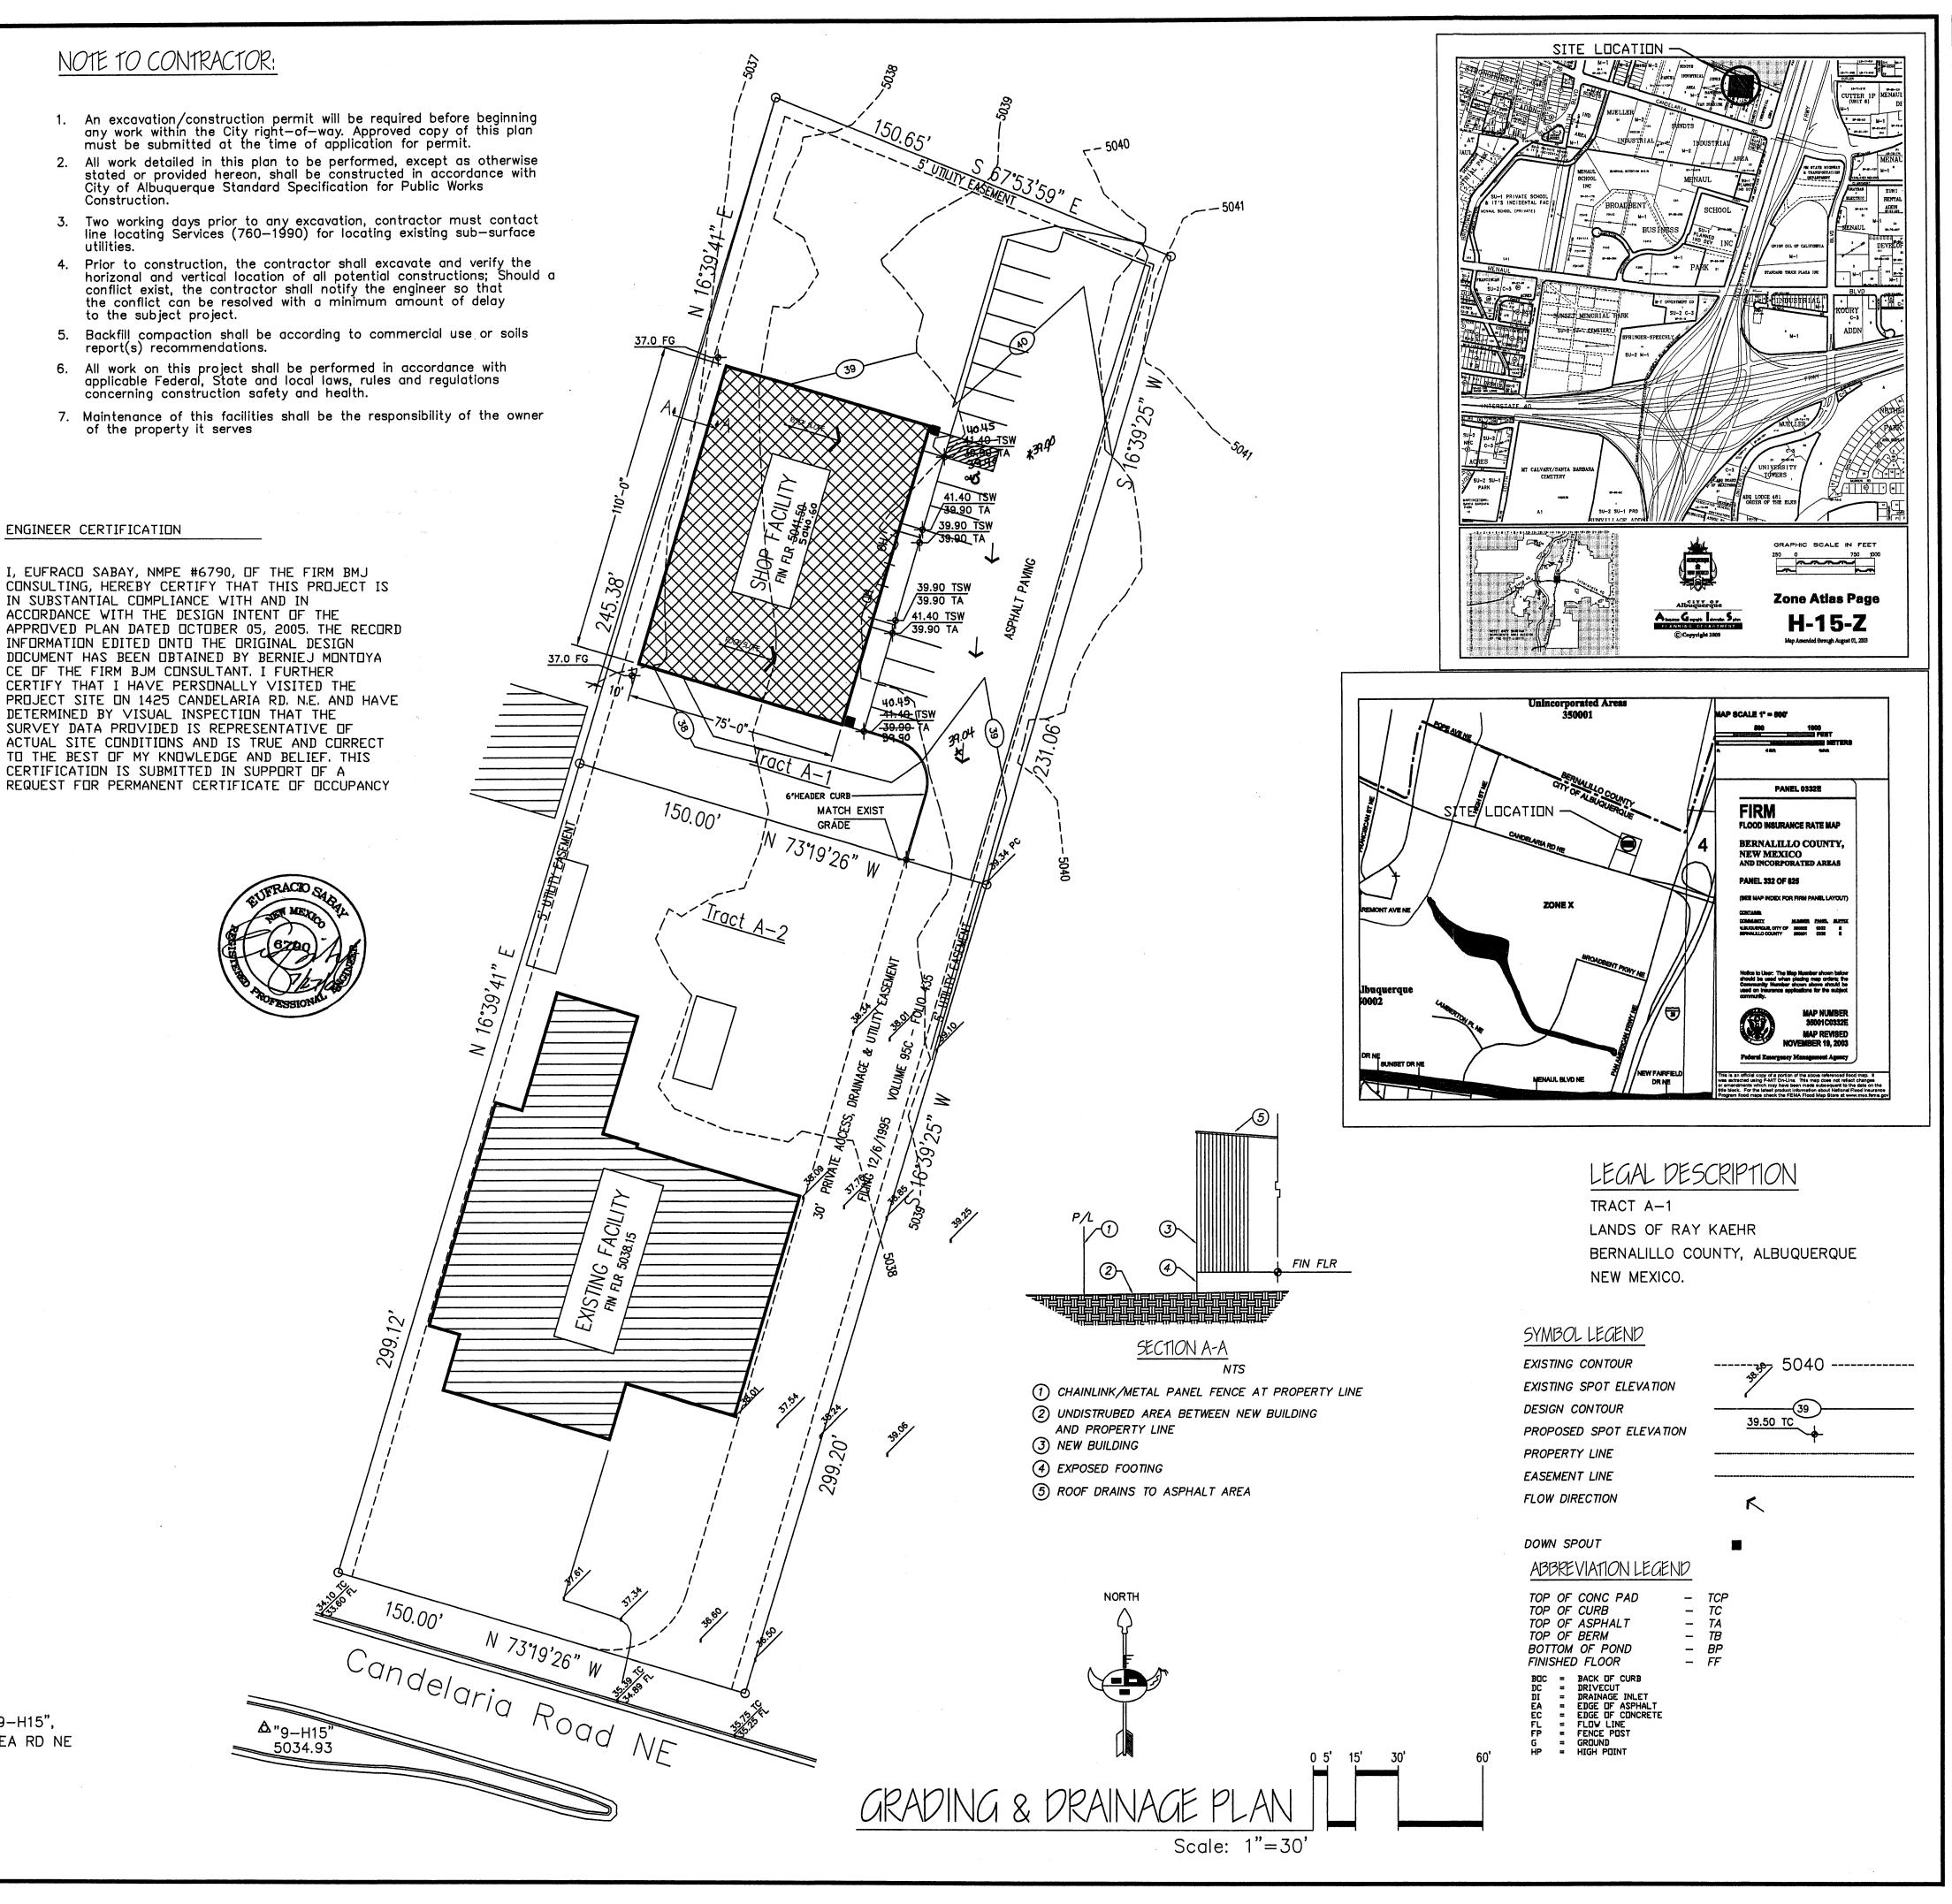

XXXXXX

JUNE 2005

REVISIONS


10-4-2005

Rd

SHEET NO.

SUBDIVISION DATA / NOTES

- 1. PLAT WAS COMPILED USING EXISTING RECORD DATA & ACTUAL FIELD SURVEY.
- 2. ALL CORNERS IDENTIFIED AS "SET" ARE SET WITH A #4 REBAR W/CAP STAMPED "LS 6446".
- BEARINGS BASED ON NEW MEXICO STATE PLANE GRID BEARINGS, CENTRAL ZONE.
- 4. DISTANCES ARE GROUND DISTANCES.
- 5. PLAT SHOWS ALL EASEMENTS OF RECORD.
- GROSS ACREAGE: 0.9002 ACRES
- 7. NUMBER OF EXISTING TRACTS/LOTS: 1
- 8. NUMBER OF TRACTS/LOTS CREATED: 2
- BEARINGS AND DISTANCES IN PARENTHESIS (). ARE PER SAID " SUMMARY PLAT OF TRACT A. LAND OF RAY J. KAEHR".
- 10. BEARINGS/DISTANCES IN BRACKETS < > PER ADJOINING REFERENCED PLATS OF RECORD.
- 11. THE BO ACCESS, DRAINAGE & UTILITY EASEMENT IS FOR THE BENEFIT AND USE BY AND FOR THE OWNER(S) OF TRACTS A -1 & A -2 AND IS TO BE HE HAINTAINED BY SAIL OWNER(S).

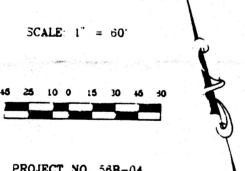

PROJECT NO. 56B-04 PLOT DATE: 8/7/95 CREATED BY DJFK.

DISCLOSURE STATEMENT:

THE PURPOSE OF THIS REPLAT IS TO CREATE TWO (2) LOTS FROM ONE (1) EXISTING TRACT OF LAND AND GRANT A 30' PRIVATE ACCESS & UTILITY EASEMENT.

THIS IS TO CERTIEY THAT TAXES ARE CURRENT & PAID ON UPC#: 1-015-059-24-7506-106-02

Prior to development, City of Albuquerque Water and Sanitary Sewer Service to /ract A-/ must be verified and coordinated with the Public Works Department, City of Albuquerque, via a request for a water and sanitary sewer availability statement

LEGAL DESCRIPTION:

TRACT LETTERED " A " OF THE " SUMMARY PLAT OF TRACT A, LAND OF RAY J. KAEHR ", THE SAME AS IS SHOWN AND DESIGNATED ON SAID PLAT THEREOF, FILED IN THE OFFICE OF THE COUNTY CLERK OF BERNALILLO COUNTY, NEW MEXICO ON OCTOBER 4, 1979 IN VOLUME B17, FOLIO 19.

State of New Mexico ; 55 County of Bernalilic This instrument was filed for record on

A PLAT OF

TRACTS A-1 & A-2LANDS of RAY KAEHR

SITUATE WITHIN SECTION 4, T 10 N, R 3 E, N.M.P.M. CITY OF ALBUQUERQUE, NEW MEXICO

JUNE 1995

T R A C T A LANDS OF JIM D. CHAVEZ 6 / 7 / 7 9 C 1 5 - 2 1 (S 68 00'30" E)	STATION: KOAT TVIT X = 440,206.79 Y = 1,533,471.33 DELTA ALPHA = - 0'16'56" NEW MEXICO STATE PLANE COORDINATE SYSTEM CENTRAL ZONE NAD 1927 SET

Y 10/4/79 B17-19	
	The second second
X	
ν / / / / / / / / / / / / / / / / /	
\supset $TRACT$ $/$	
	01 Z
	0
0 201 ac. /1	F 0
<pre></pre>	0 - 0
/ 1186	> 40
	1
N 231026 W	Ω Ι
O) - O) SET 150.00' / SET	ω ς
- z - 0	D 0
	(V)
8 w / d	
4 α Ω ω / I ½	N
u o ° ≙a l /	-
\ \ \ \ \ \ \ \ \ \ \ \ \ \ \ \ \ \ \	- 7
7 S S S S S S S S S S S S S S S S S S S	_ x ,
TRACT	· ·
S S S S S S S S S S S S S S S S S S S	1

6 J 1.0301 ac. 0.8202 ac. net N 73'19'26" W 150.00' (N 73'20' W) S 1403'06" W_ 1425 CANDELARIA ROAD (106' R.O.W.)

> STATION: 9-H15 X = 387,015.74Y = 1.497.331.15GROUND TO GRID = 0.9996738 DELTA ALPHA = - 0'13'02" NEW MEXICO STATE PLANE COORDINATE SYSTEM CENTRAL ZONE NAD 1927

FREE CONSENT

THE UNDERSIGNED OWNER(S) AND PROPRIETOR(S) OF THE PROPERTY DESCRIBED HEREON DO HEREBY CONSENT TO THE PLATTING OF SAID PROPERTY AS SHOWN HEREON AND THE SAME IS WITH THE FREE CONSENT AND IN ACCORDANCE WITH THEIR DESIRES AND DO HEREBY REPRESENT THAT THE UNDERSIGNED INDIVIDUALS ARE AUTHORIZED TO SO ACT AND DO HEREBY GRANT A 30' PRIVATE ACCESS & UTILITY EASEMENT AS SHOWN

, , ,	
OWNER(S) SIGNATURE:	
OWNER(S) PRINT NAME: Rorald W. Kzehr	6 8,75
OWNER(S) PRINT NAME: 10 FIRE W. 57811	
ADDRESS: 1425 Candelaria NE, ALBUAUERQUE,	UM 87:07
TRACT: A-	1. A-2.
BY:	7
, , ,	JAL BEAL
STATE OF NEW MEXICO)	i ourne
).SS	5 1 1 1 1 1 1 1 1 1 1 1 1 1 1 1 1 1 1 1
COUNTY OF BERNALILLO)	COX 3H W3.
My Commission Extends	k}
THIS INSTRUMENT WAS ACKNOWLEDGED BEFORE ME THIS	DAY OF
June	
1995.	
\a.	
MY COMMISSION EXPIRES:	1
CCTOBER 1ST 1997 Sanal Lames	
Leioner Juli _ warak /- mai	- C)
NOTARY DURING	_

	PUBLIC
NOTARI	FOBILE
58-95-270	
APPROVALS:	DRB NO. 95-283
Jan 1) Ceopie	11-15-55
CITY ENGINEER ILL	DATE
that the .	061355
CITY SURVEYOR	DATE
Thehad but	7.25.95
TRAFFIC ENGINEERING	DATE
- ByHishert	7-25-15
PARKS AND GENERAL SERVICE	11-15-15
A.MA.F.C.A.	DATE
REAL PROPERTY DIVISION ROBULT W. KM	1-25-95
UTILITY DEVELOPMENT DIVISION	DATE
1 Grad Cland	11-21-75
CIT PLANNER, ALBUQUERQUE PLANNING DIV	ISION DE COPE UV
	. OCT 0 5 2005
SURVEYOR'S CERTIFICATION	HYDROLOGY SEC
CENTER CATION	LITTUROLOGY SE

SURVEYOR'S

I, FRANKLIN E. WILSON, A REGISTERED PROFESSIONAL LAND SURVEYOR UNDER THE LAWS OF THE STATE OF NEW MEXICO, DO HEREBY CERTIFY THAT THIS PLAT WAS PREPARED BY ME OR UNDER MY SUPERVISION. MEETS THE MINIMUM REQUIREMENTS OF MONUMENTATION AND SURVEYS OF THE ALBUQUERQUE SUBDIVISION ORDINANCE, AND THAT IT IS THE AND CORRECT TO THE BEST OF MY KNOWLEDGE AND BELLET.

FRANKLIN E. WILSON, N M.L.S. NO. 6446




SOUTHWEST SURVEYING CO., INC.

333 LOMAS BLVD. N.E. ALBUQUERQUE, NEW MEXICO 87102

PHONE: (505) 247-4444 FAX: (505) 242-8069

DATE



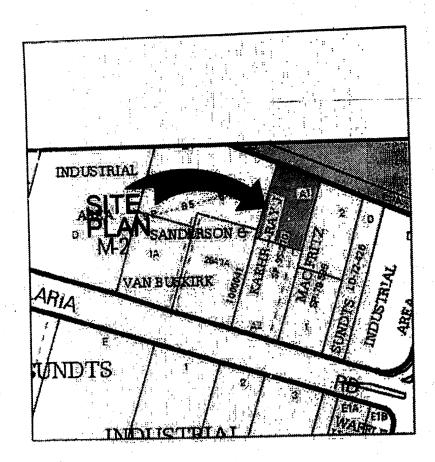

Enlarged Vicinity Map

N.T.S.

Zono Ailos Page: H-15-Zi Map amended through: 234/2010

Zone Map HANDICAPPED N.T.S. PARKING ONLY VAN ACCESSIBLE 1:12 MAX SLOPE 1:12 MAX. SLOPE RAISED CONCRETE WALK FACE OF 5" HIGH CONCRETE APRON

Existing Handicap Sign
Not to Scale

3/4" CHAMFER-

UNPAVED AREA-


Header Curb Detail

Paving Edge Detail
Scale: 1"-1"-0"

(2) #4 REBAR CONT.

-#4 TIES AT 32" O.C.

Existing Handicap Ramp
Scale 1/2"-1'-0"

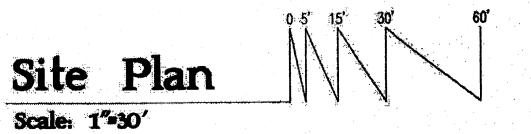

EXISTING S CONC SIDEWALK N 7319'26" N

Candelaria Road NE

PLATING FACILITY

ALL WHEELCHAIR RAMPS LOCATED WITHIN THE PUBLIC RIGHT OF WAY MUST HAVE TRUNCATED DOMES.

Public Infrastructure shown on these plans for information only and not part of approval. Separate DRC/Permit approval and Work Order required.

TRAFFIC CIRCULATION LAYOUT APPROVED

SE SE PONDERCONT FACILITY

Design Data

10	LEGAL DESCRIPTION:	TRACT A-1
(2 TIERS HIGH) ER CURB	LANDS BER	OF RAY KAEHR NALILLO COUNTY,
APNEW A	AL MARKET AND ALL MAR	BUQUERQUE, NM
NEW GONCRETE EDGE S	ADDRESS: 1441 CAND STRIP	ELARIA ROAD NE RQUE, NM 87107
45-0°	CURRENT ZONING:	M-2
	ZONE ATLAS PAGE:	H-15-Z
ENST. PP. OHE.	APPLICABLE BUILDING CODE:	IBC-2006
	SEISMIC DESIGN CATAGORY:	<u>D</u>
	WIND DESIGN SPEED (3-SECOND GUST):	90 MPH
	EXPOSURE:	В
	TYPE OF CONSTRUCTION:	<u>II—B</u>
THE GATE WILL BE OPENED	FIRE SPRINKLERED:	NO NO
AT THE BEGINNING OF BUSINESS EACH DAY AND WILL REMAIN OPEN UNTIL	NUMBER OF STORIES:	ONE
THE CLOSE OF BUSINESS.	BUILDING FLOOR AREAS:	
6" MDE EMST. LANDSCAPE ROCK	EXISTING: BUILDING:	8,250 SQ, FT.
	PROPOSED ADDITION:	4,125 SQ. FT.
PP / VSCON	BUILDING AREA: STORAGE MEZZANINE:	550 SQ. FT.
13	UNENCLOSED COVERED MECH. EQUIP .:	
LENS)	TOTAL FIRE AREA (IBC SEC. 702):	
6 30		- UNSEPARATED
MOTOFCY AR PARKING 6161	EXISTING BUILDING: GROUP F=1 (FACTORY & INDUSTRIAL) GROUP B (OFFICE): PROPOSED ADDITION:	7,788 SQ. FT. 462 SQ. FT.
	GROUP F-1 (FACTORY & INDUSTRIAL)	1,295 SQ. FT.
	GROUP F-1 (COVERED MECH. EQUIP.)	533 SQ. FT. 2,830 SQ. FT.
	GROUP S -1 (STORAGE): GROUP S-1 (STORAGE MEZZANINE):	550 SQ. FT.
	TOTAL EXISTING & PROPOSED:	13,478 SQ. FT.
	ALLOWABLE BUILDING AREA:	IBC TABLE 503
	GROUP F-1: GROUP S-1:	15,500 SQ, FT. 17,500 SQ, FT. 23,000 SQ, FT.
	GROUP B: OCCUPANT LOAD:	C TABLE 1004.1.2
	EXISTING BUILDING:	estation of the second
	OFFICE: 462/100 =	5 OCC.
	SHOP: 7,788/100 = TOTAL EXISTING BUILDING:	78 OCC. 83 OCC.
	PROPOSED ADDITION:	
	SHOP: 1,295/100 = STORAGE: 2,830+550/500 =	13 OCC. 7 OCC.
	TOTAL PROPOSED ADDITION:	20 OCC.
	TOTAL OCCUPANT LOAD EXISTING & PR	OPOSED: 103 OCC.
	TWO EXITS REQUIRED FOR ADDITION:	NO
	PLUMBING SYSTEMS:	IBC TABLE 2902.1
LOCATED T OF WAY	OCCUPANT LOAD 103; ASSUME EQUAL BETWEEN GENDERS = 52 MEN & 52 V	VOMEN
DOMES.	SEPARATE FACILITIES ARE REQUIRED FO WATER CLOSETS REQ'D:	n CAUN GENEER
	(FACTORY 91/100)+(STORAGE 7/100)+(OFFICE WATER CLOSETS PROVIDED:	E 5/25) = 2 2
nown mation proval.	LAVATORIES REQ'D: (FACTORY 91/100)+(STORAGE 7/100)+(OFFICE LAVATORIES PROVIDED:	OE 5/40) = 2 2
pproval pired.	DRINKING FOUNTAIN REQ'D: (FACTORY 91/400)+(STORAGE 7/1000)+(OFF	
	DRINKING FOUNTAIN PROVIDED: SERVICE SINK REQ'D: SERVICE SINK PROVIDED	1
UT	REQUIRED OFF-STREET PARKINGS	
	(2,830+550/2000)+(7,788+1,295/1,000)+(462	
te l	OFF-STREET PARKING PROVIDED:	13 SPACES
	REQUIRED PARKING TO BE DESIGNATED HC ONE HC SPACE DESIGNATED VAN ACCES	ACCESSIBLE: 0\0 SIBLE
	HC ACCESSIBLE PARKING PROVIDED:	SIRIF

ONE HC SPACE DESIGNATED VAN ACCESSIBLE

ASPHALT DESIGN:

3" MINIMUM THICKNESS ASPHALT PAVEMENT OVER 6"

AGGREGATE BASE COURSE OVER SUBGRADE COMPACTED TO

95 PERCENT OF PROCTOR DENSITY.

RECEIVED

SEP 27 2010

HYDROLOGY SECTION

HYDROLDAY &
TRAFIC


Shop

2 Addition

量り異 画画


J08	0512	
DATE	20 AUGUST 2010	
	REVISIONS	
, M. 100, 100		

SHEET NO.

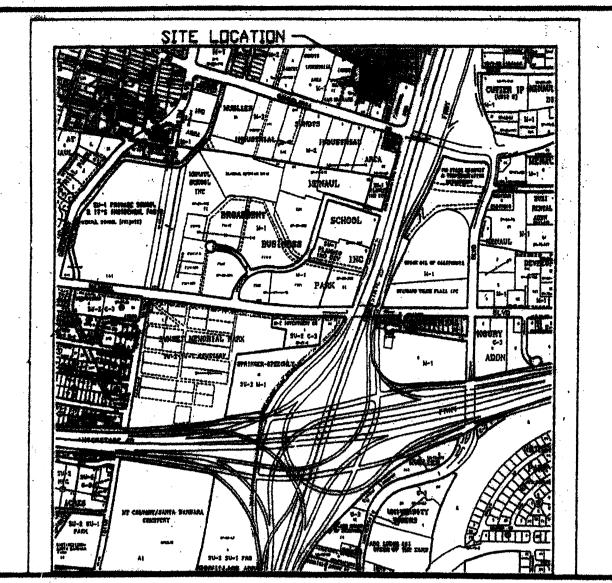

VICINITY MAP

GRAPHIC SCALE IN FEET

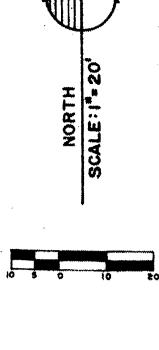

LOCATION MAP

EROSION CONTROL MEASURES:

THE CONTRACTOR SHALL BE HELD RESPONSIBLE FOR MANAGEMENT OF STORM RUNOFF DURING CONSTRUCTION; HE SHALL ENSURE THAT THE FOLLOWING MEASURES ARE TAKEN

- ADJACENT PROPERTY SHALL BE PROTECTED AT ALL TIMES BY CONSTRUCTION OF BERMS, DEKES, SWALES, FONDS, AND OTHER TEMPORARY GRADING AS REQUIRED TO PREVENT STORM RUNOFF FROM LEAVING THE SUBJECT SITE AND ENTERING ADJACENT PROPERTIES.
- 2) ADJACENT PUBLIC RIGHT-OF-WAYS SHALL BE PROTECTED AT ALL TIMES FROM STORM WATER RUNOFF FROM THE SUBJECT SITE. NO SEDIMENT BEARING WATER SHALL BE PERMITTED TO ENTER PUBLIC STREET RIGHT-OF-WAYS.
- 3) THE CONTRACTOR SHALL IMMEDIATELY AND THOROUGHLY REMOVE ANY AND ALL SEDIMENT FROM PUBLIC STREETS THAT HAS BEEN ERODED FROM THE SUBJECT SITE AND DEPOSITED THERBON.

CONSTRUCTION NOTES:

- TWO (2) WORKING DAYS PRIOR TO ANY EXCAVATION, CONTRACTOR MUST CONTACT LINE LOCATING SERVICE AT 260-1990 FOR THE ACTUAL FIELD LOCATION OF THE EXISTING SURFACE OF SUB-SURFACE UTILITIES.
- 2) PRIOR TO CONSTRUCTION, THE CONTRACTOR SHALL EXCAVATE AND VERIFY THE HORIZONTAL AND VERTICAL LOCATION(S) OF ALL POTENTIAL OBSTRUCTIONS; SHOULD A CONFLICT EXIST, THE CONTRACTOR SHALL NOTIFY THE ENGINEER SO THAT THE CONFLICT CAN BE RESOLVED WITH A MINIMUM OF DELAY.
- 3) ALL WORK ON THIS PROJECT SHALL BE PERFORMED IN ACCORDANCE WITH ALL APPLICABLE FEDERAL, STATE, AND LOCAL LAWS, RULES AND REGULATIONS CONCERNING CONSTRUCTION SAFETY AND HEALTH.
- 4) ALL CONSTRUCTION WITHIN PUBLIC STREET RIGHT-OF-WAY(S) SHALL BE PERFORMED IN ACCORDANCE WITH APPLICABLE CITY OF ALBUQUERQUE/BERNALELLO COUNTY STANDARDS AND PROCEDURES.

GENERAL NOTE


 NO PERDMETER BOUNDARY CORNERS HAVE BEEN FIELD ESTABLISHED PER THIS SURVEY OF THE SUBJECT PROPERTY.


2) NO SEARCH HAS BEEN MADE FOR BASEMENTS OF RECORD OTHER THAN

LEGENDA

TOP OF CURB ELEVATION = T.C. = 40.25 CURB FLOWLINE ELEVATION = 1E = 40.00

PROPOSED SPOT ELEVATION = 4 - 3985

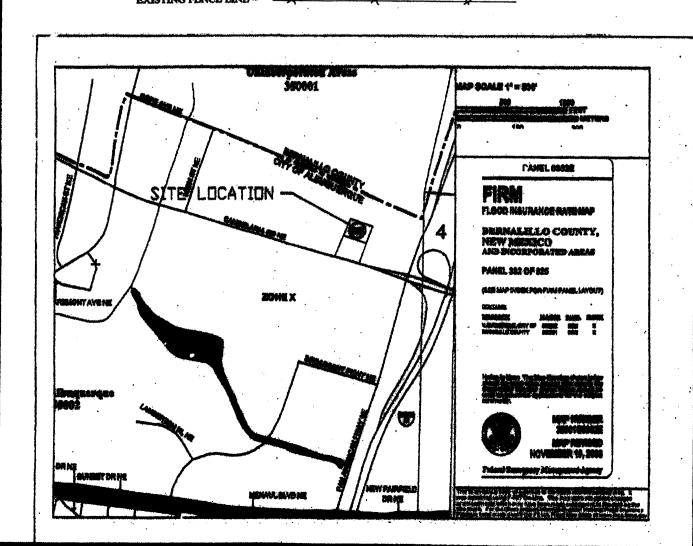

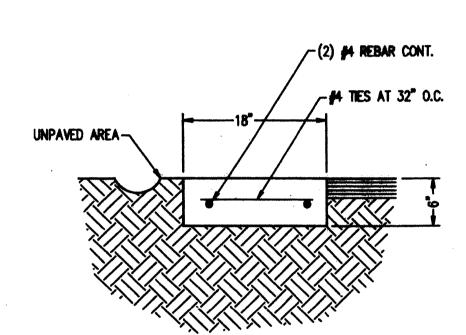

Benchmark:

Legal Description:

Lands of Ray Kaehr

Bernalillo County, Albuquerque

Tract A-1

New Mexico.

5034.93 on the median on Candelaria Rd. NE.

Elevations are based on City of Albuquerque Station No. "9-H15", having an elevation of


Paving Edge Detail A/C.1
Scale: 1"-1'-0"

DRAINAGE CERTIFICATION (AS-BUILT):


I, LEVI J. VALDEZ, N.M.P.E. 5693, DO HEREBY CERTIFY THAT THE "AS-BUILT" IMPROVEMENTS OF THE SUBJECT PROJECT AS SHOWN ON THE PLAN HEREON HAVE BEEN GRADED AND WILL DRAIN IN "SUBSTANTIAL COMPLIANCE" IN ACCORDANCE WITH THE DESIGN INTENT OF SAID PLAN SUBMITTED TO CITY OF ALBUQUERQUE HYDROLOGY DEPARTMENT WITH ENGINEER'S STAMP DATED 08-18-10.

THE RECORD INFORMATION EDITED ONTO THE ORIGINAL DESIGN DOCUMENT HAS BEEN OBTAINED BY ALTHOUS HARRIS, N.M.P.L.S. NO. //4G3, OF THE FIRM HARRIS SURVEYING, INC.; I FURTHER CERTIFY THAT I HAVE PERSONALLY VISITED THE PROJECT SITE ON ALON. 19, 2008, AND HAVE DETERMINED BY VISUAL INSPECTION THAT THE SURVEY DATA PROVIDED IS REPRESENTATIVE OF ACTUAL SITE CONDITIONS AND IS TRUE AND CORRECT TO THE BEST OF MY KNOWLEDGE AND BELIEF. THIS CERTIFICATION IS SUBMITTED IN SUPPORT OF A REQUEST FOR A PERMANENT CERTIFICATION OF OCCUPANCY.

THE RECORD INFORMATION PRESENTED HEREON IS NOT NECESSARILY COMPLETE AND INTENDED ONLY TO VERIFY SUBSTANTIAL COMPLIANCE OF THE GRADING AND DRAINAGE ASPECTS OF THIS PROJECT. THOSE RELYING ON THIS RECORD DOCUMENT ARE ADVISED TO OBTAIN INDEPENDENT VERIFICATION OF ITS ACCURACY BEFORE USING IT FOR ANY OTHER PURPOSE.

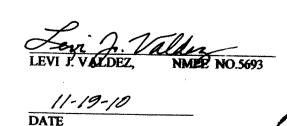

LIOTE: "LS-BUILT" ELEVATIONS SHOKIN THUS (392)

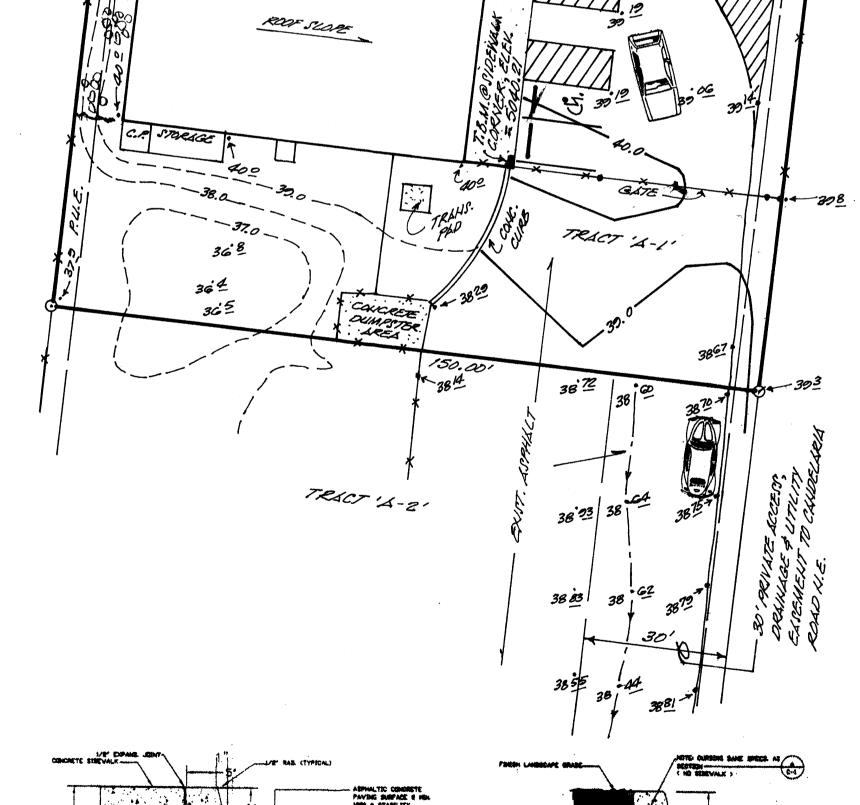

ROOF SLOPE

EXISTING BUILDING

F.F. = 5040.27


- 3990


A.1 PRECIPITATION ZONES

Bernalillo County's four precipitation zones are indicated in TABLE A-1 and on FEGURE A-1.

TAB	LE A-1. PRECIPITATION ZONES
ZONE	LOCATION
1	West of the Lio Grande
2	Between the Rio Grande and San Mattee
3	Between Sen Mistee and Subank, North of Interstate 40; and between Sen Mistee and the Rast boundary of Range Seet; South of Interstate 40
4	Bast of Buhank, North of Interstate 40; and East of the Hast boundary of Range 4 East, South of Interstate 40

TABLE A-10. 1	TABLE A-10. PEAK INTENSITY (INVER at t-0.2 hour)					
Zone	Intensity	100-YR (2-YR, 10-YR)				
1	4.70 (1.84, 3.14)					
Ø	5.05 (2.04, 3.41)					
3	5.38 (2.21, 3.65)					
4	5.61 (2.34, 3.83)					

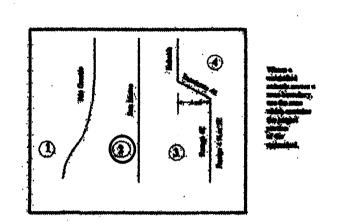

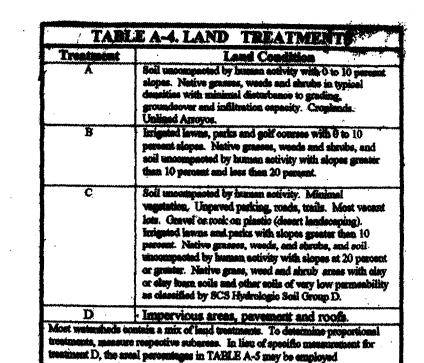

Zone	E A-9. PEAK DISCHARGE (cfs/acre) Tventument 100-YR (2-YR, 10-TR)				
	A	B	C	D	
1	1.29	2.03	2.87	4.37	
	(0.00, 0.24)	(0.33, 0.76)	(0.47, 1.49)	(1.69, 2.89)	
3	1.56	2.28	3.14	4.70	
	(0.00, 0.38)	(0.08, 0.95)	(0.60, 1.71)	1.86, 3.14)	
3	1.\$7	2.60	3.45	5.02	
	(0.00, 0.58)	(0.21, 1.19)	(0.78, 2.009)	(2.04, 3.39)	
4	2.20	2.92	3.73	5.25	
	(0.03, 0.87)	(0.38, 1.45)	(1.00, 2.26)	(2.17, 3.57)	

Drainage Comments:

As shown on the Vicinity Map hereon, the subject site is located on the North side of Candelaria Road N.E. between I-25 and Edith Blvd. N.E., in the City of Albuquerque, Bernalillo County, New Mexico, (Zone Atlas Map H-15).

The subject site, 1.) is partially developed with an existing building and associated improvements and is to have a proposed 55'x 75' (4,125.0 sq. ft.) building addition and associated improvements constructed thereon, 2.) is to have the existing and developed flows directed to the asphalt paved parking area and continue to have said run-off flow through an existing 30' Private Access, Drainage, and Utility Easement within the easterly portion of Tract A-2 (immediately south of and adjacent to our subject site), and into Candelaria Road N.E., 3.) does not lie within a designated floodplain, (F.E.M.A. Panel 0332E, Revised November 19, 2003)., 4.) does not accept off site flows from adjacent properties; however, does direct flows thru aforementioned Tract A-2.

Drainage Calculations

Per Section 22.2, Hydrology of the Development Process Manual, Volume 2, Design Criteria for the City of Albuquerque, Bernalillo County, New Mexico.

Site Area: 0.82 Acres

Precipitation Zone: Two (2)


Peak Intensity: IN./HR. at Tc = Twelve (12) Minutes, (100-YR. / 6 HR.) = 5.05

Existing Conditions:

IREAIMENI	AREA/ACRES		FACTOR		<u>CFS</u>	
\mathbf{c}	0.38	X	3.14	==	1.19	
D	0.44	X	4.70	Marie Control	2.07	
"Qp" = 3.26 CFS			•			
Proposed Conditio	DS:					
TREATMENT	AREA/ACRES		FACTOR		<u>CFS</u>	
C	0.19	X	3.14	STATE OF THE PARTY	0.60	
D	0.63	\mathbf{X}_{\perp}	4.70	XX	2.96	
" Qp " = $3.56 CFS$			ست میمانید ب _ا و ا	g man	a a garage management of the same of the s	
*INCREASE = 0.30	CFS					
,						

NOV 2 2 2010

"ENGINEER'S CERTIFICATION"

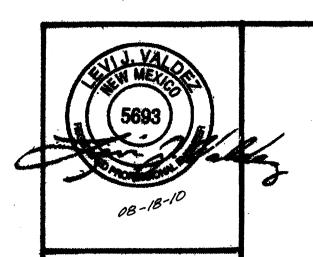

the second of th

A G" COMPACTED AGGREGATE BASE

B - CONCRETE PARKING BUMPERS

COURSE OVER 6" COMPLETED SUB-

PER "LRCHITECTS SITE PLAN".

GRADE TO 95% MIN. DENSITY.

WOTES:

A PROPOSED
GRADING AND DRAINAGE PLAN
FOR

THE PAINT SHOP

(1441 CANDELARIA ROAD N.E.)
ALBUQUERQUE, NEW MEXICO
AUGUST, 2010
(NOVEMBER, 2010)