TALOS LOG NO.: 2005 30 3572 SU-2 C-NSET MEMORIAL PARK

H-15

1"=750'±

## VICINITY MAP

## SUBDIVISION DATA / NOTES

Total Number of Existing Tracts: 1

SU-2-SU-1 CEMETERY

- Total Number of TRACTS created: 5
- Gross Subdivision Acreage: 7.977
- Total Mileage of Full Width Streets Created: 0.00
- Bearings are New Mexico State Plane Grid Bearings (Central Zone).
- Distances are ground distances.
- Bearings and distances in parenthesis are record.
- Basis of boundary are the following plats of record entitled: "BROADBENT BUSINESS PARK", (08-15-86, C31-74) "BROADBENT BUSINESS PARK", (11-20-90, 90C-285) all being records of Bernalillo County, New Mexico.
- 9. Date of Survey: June 2005
- 10. Title Report: None provided.
- 11. Address of Property: None provided.
- 12. City Standard Utility Note II: City of Albuquerque Water and Sanitary Sewer Service to SUBJECT PROPERTY must be verified and coordinated with the Albuquerque Bernalillo County Water Utility Authority, City of Albuquerque."
- 13. ZONING: M−1

## PUBLIC UTILITY EASEMENTS

PUBLIC UTILITY EASEMENTS SHOWN ON THIS PLAT ARE GRANTED FOR THE COMMON AND JOINT USE OF:

- THE PUBLIC SERVICE CO. OF NM--ELECTRIC SERVICES DIVISION FOR THE INSTALLATION, MAINTENANCE, AND SERVICE OF UNDERGROUND/OVERHEAD ELECTRICAL LINES, COMMUNICATION LINES, TRANSFORMERS, AND ANY OTHER EQUIPMENT, FIXTURES, STRUCTURES, AND RELATED FACILITIES REASONABLY NECESSARY TO PROVIDE ELECTRICAL SERVICE.
- 2. QWEST FOR THE INSTALLATION, MAINTENANCE AND SERVICE OF ALL BURIED COMMUNICATION LINES AND OTHER RELATED EQUIPMENT AND FACILITIES REASONABLY NECESSARY TO PROVIDE COMMUNICATION SERVICES, INCLUDING BUT NOT LIMITED TO ABOVE GROUND PEDESTALS AND CLOSURES.



P.O. BOX 30701, ALBQ., N.M. 87190 505-884-1990

1456PT1.DWGrfh

08/17/05

#### LEGAL DESCRIPTION

A tract of land situate within Section 9, Township 10 North, Range 3 East, New Mexico Principal Meridian, City of Albuquerque, Bernalillo County, New Mexico being all of TRACT F-2A1-D, BROADBENT BUSINESS PARK as the same is shown and designated on said plat filed for record in the office of the County Clerk of Bernalillo County, New Mexico on November 20, 1990 in Volume 90C, Folio 285 and containing 7.9766 acres more or less.

\* PROJECTED

#### DISCLOSURE STATEMENT

The intent of this plat is to subdivide Tract F-2A1-D into five (5) TRACTS and to grant those easements necessary to support said



**PLAT** TRACTS F-2A1-D-1, F-2A1-D-2, F-2A1-D-3, F-2A1-D-4, & F-2A1-D-5

BROADBENT BUSINESS PARK MITHIN THE TOWN OF ALBUQUEROUE PROJECTED SECTION 9, T. 10 N, R. 3 E., NMPM

CITY OF ALBUQUERQUE BERNALILLO COUNTY. NEW MEXICO

**AUGUST 2005** 

## FREE CONSENT AND DEDICATION

The subdivision shown hereon is with the free consent and in accordance with the desires of the undersigned Owner(s) and/or Proprietor(s) thereof and said Owner(s) and/or Proprietor(s) do hereby consent to all of the foregoing and said owners warrant that they hold among them complete and indefeasible title in fee simple to the land subdivided, and do hereby certify that this subdivision is their free act and

## EXISTING EASEMENTS

- 1) RECIPROCAL ACCESS, UTILITY, DRAINAGE, IRRIGATION, AND LANDSCAPING EASEMENT (ALL OF TRACT F-2A1-D) (05-06-86, BK.MISC. 348A, PGS. 525-533)
- 2 EXISTING 10' UTILITY EASEMENT (08-15-86, C31-74)
- 3 EXISTING 10' X 10' PUBLIC WATERLINE EASEMENT (11-20-90, 90C-285)
- 4 EXISTING 20' PUBLIC WATERLINE EASEMENT (11-20-90, 90C-285)
- 5 EXISTING 35' PRIVATE DRAINAGE EASEMENT, TO BENEFIT TRACT F-2A1-C AND F-2A1-D. MAINTENANCE IS THE RESPONSIBILITY OF TRACT F-2A1-D WITH TRACT F-2A1-C REIMBURSING TRACT F-2A1-D FOR 50% OF ALL COSTS INCURRED FOR SAID MAINTENANCE (10-20-90)
- (6) EXISTING 20' C.O.A. SEWER EASEMENT (02-26-65, BK. 769, PGS. 346-348)
- TEXISTING 20' WATERLINE EASEMENT (08-15-86, C31-74)
- 8 EXISTING 80' DRAINAGE EASEMENT (05-23-79, D9-129)

SEE SHEET 2 FOR PROPOSED EASEMENTS.



THIS IS TO CERTIFY HAT TAXES HE CURRENT AND PAID ON UPC # 101505922634910343

Walter Wisznia

**APPROVALS** 

Utility Approvals

DRB PROJECT NO. 1000/16

APPLICATION NO. 05 DRB-01385

(5A) EXISTING 35' NON-EXCLUSIVE ACCESS, UTILITY & DRAINAGE EASEMENT FOR THE USE OF CITY SURVEYOF TRACT F-2A1-C & TRACT F-2A1-D. MAINTANCE IS THE RESPONSIBILITY OF TRACT F-2A1-D WITH TRACT F-2A1-C REIMBURSING TRACT F-2A1-D FOR 50% OF ALL COST REAL PROPERTY DIVISION INCURRED FOR SAID MAINTENANCE. (11-27-90; BK 9019, PG 347-354). ENVIRONMENTAL HEALTH DEPARTMENT


(5B) MAINTENANCE OF EXISTING EASEMENT (5 & (5A) IS BEING REDEFINED BY THIS PLAT AS BEING TRAFFIC ENGINEERING, TRANSPORTATION DIVISION CREATED HEREON WHICH BENEFITS FROM THE USE OF THE EASEMENT: BEING FURTHER IDENTIFIED AS TRACT F-2A1-D-1 & TRACT ALBUQUERQUE FRALILLO COUNTY WATER UTILITY AUTHOR F-2A1-D-2 WITH EXISTING TRACT F-2A1-C REIMBURSING TRACT F-2A1-D-1 & TRACT F-2A1-D-2 FOR 50% OF ALL COST INCURREDARKS AND RECREATION DEPARTMENT FOR SAID MAINTENANCE.

DRB CHAIRPERSON, PLANNING DEPARTMENT

VAIL
8-29-05 DATE 11/02/05 DATE 11/02/05 DATE
11-2-05 DATE
11/2/05 DATE 11-2-05

#### SURVEYOR'S CERTIFICATION

"I, Timothy Aldrich, a duly qualified Registered Professional Land Surveyor under the laws of the State of New Mexico, do hereby certify that this plat and description were prepared by me or under my supervision, shows all easements as shown on the plat of record or made known to me by the owners and/or proprietors of the subdivision shown hereon, utility companies and other parties expressing an interest and meets the minimum requirements for monumentation and surveys of the Albuquerque Subdivision Ordinance, and further meets the Minimum Standards for Land Surveying in the State of New Mexico (Effective November 1, 1989 and revisions effective December 25, 1991, February 2, 1994 and October 2000), and is true and correct to the best of my knowledge and belief".

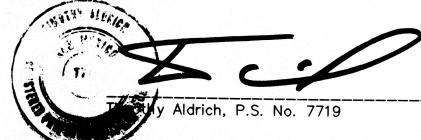

OWNER(S) 57Mm EXELLER OF THE GOTHE

WALTER WISZNIA, DECEASED

MARCEL WISZNIA. A MARRIED MAN AS HIS SOLE AND SEPARATE PROPERTY


## **ACKNOWLEDGMENT**

STATE OF Louisiana COUNTY OF Orleans Parish \ SS

This instrument was acknowledged before me on  $\frac{AUCU_0 - \lambda 3}{2}$ 2005, by Marcel Wisznia, A married man as his sole and separate property and acting as Executive for WALTER WISZNIA, DECEASED.

My Commission Expires: For hirk Notary Public BARNO SURA 807 PERDIDO STREET STE 401 17

Non CALEANS 64 70118

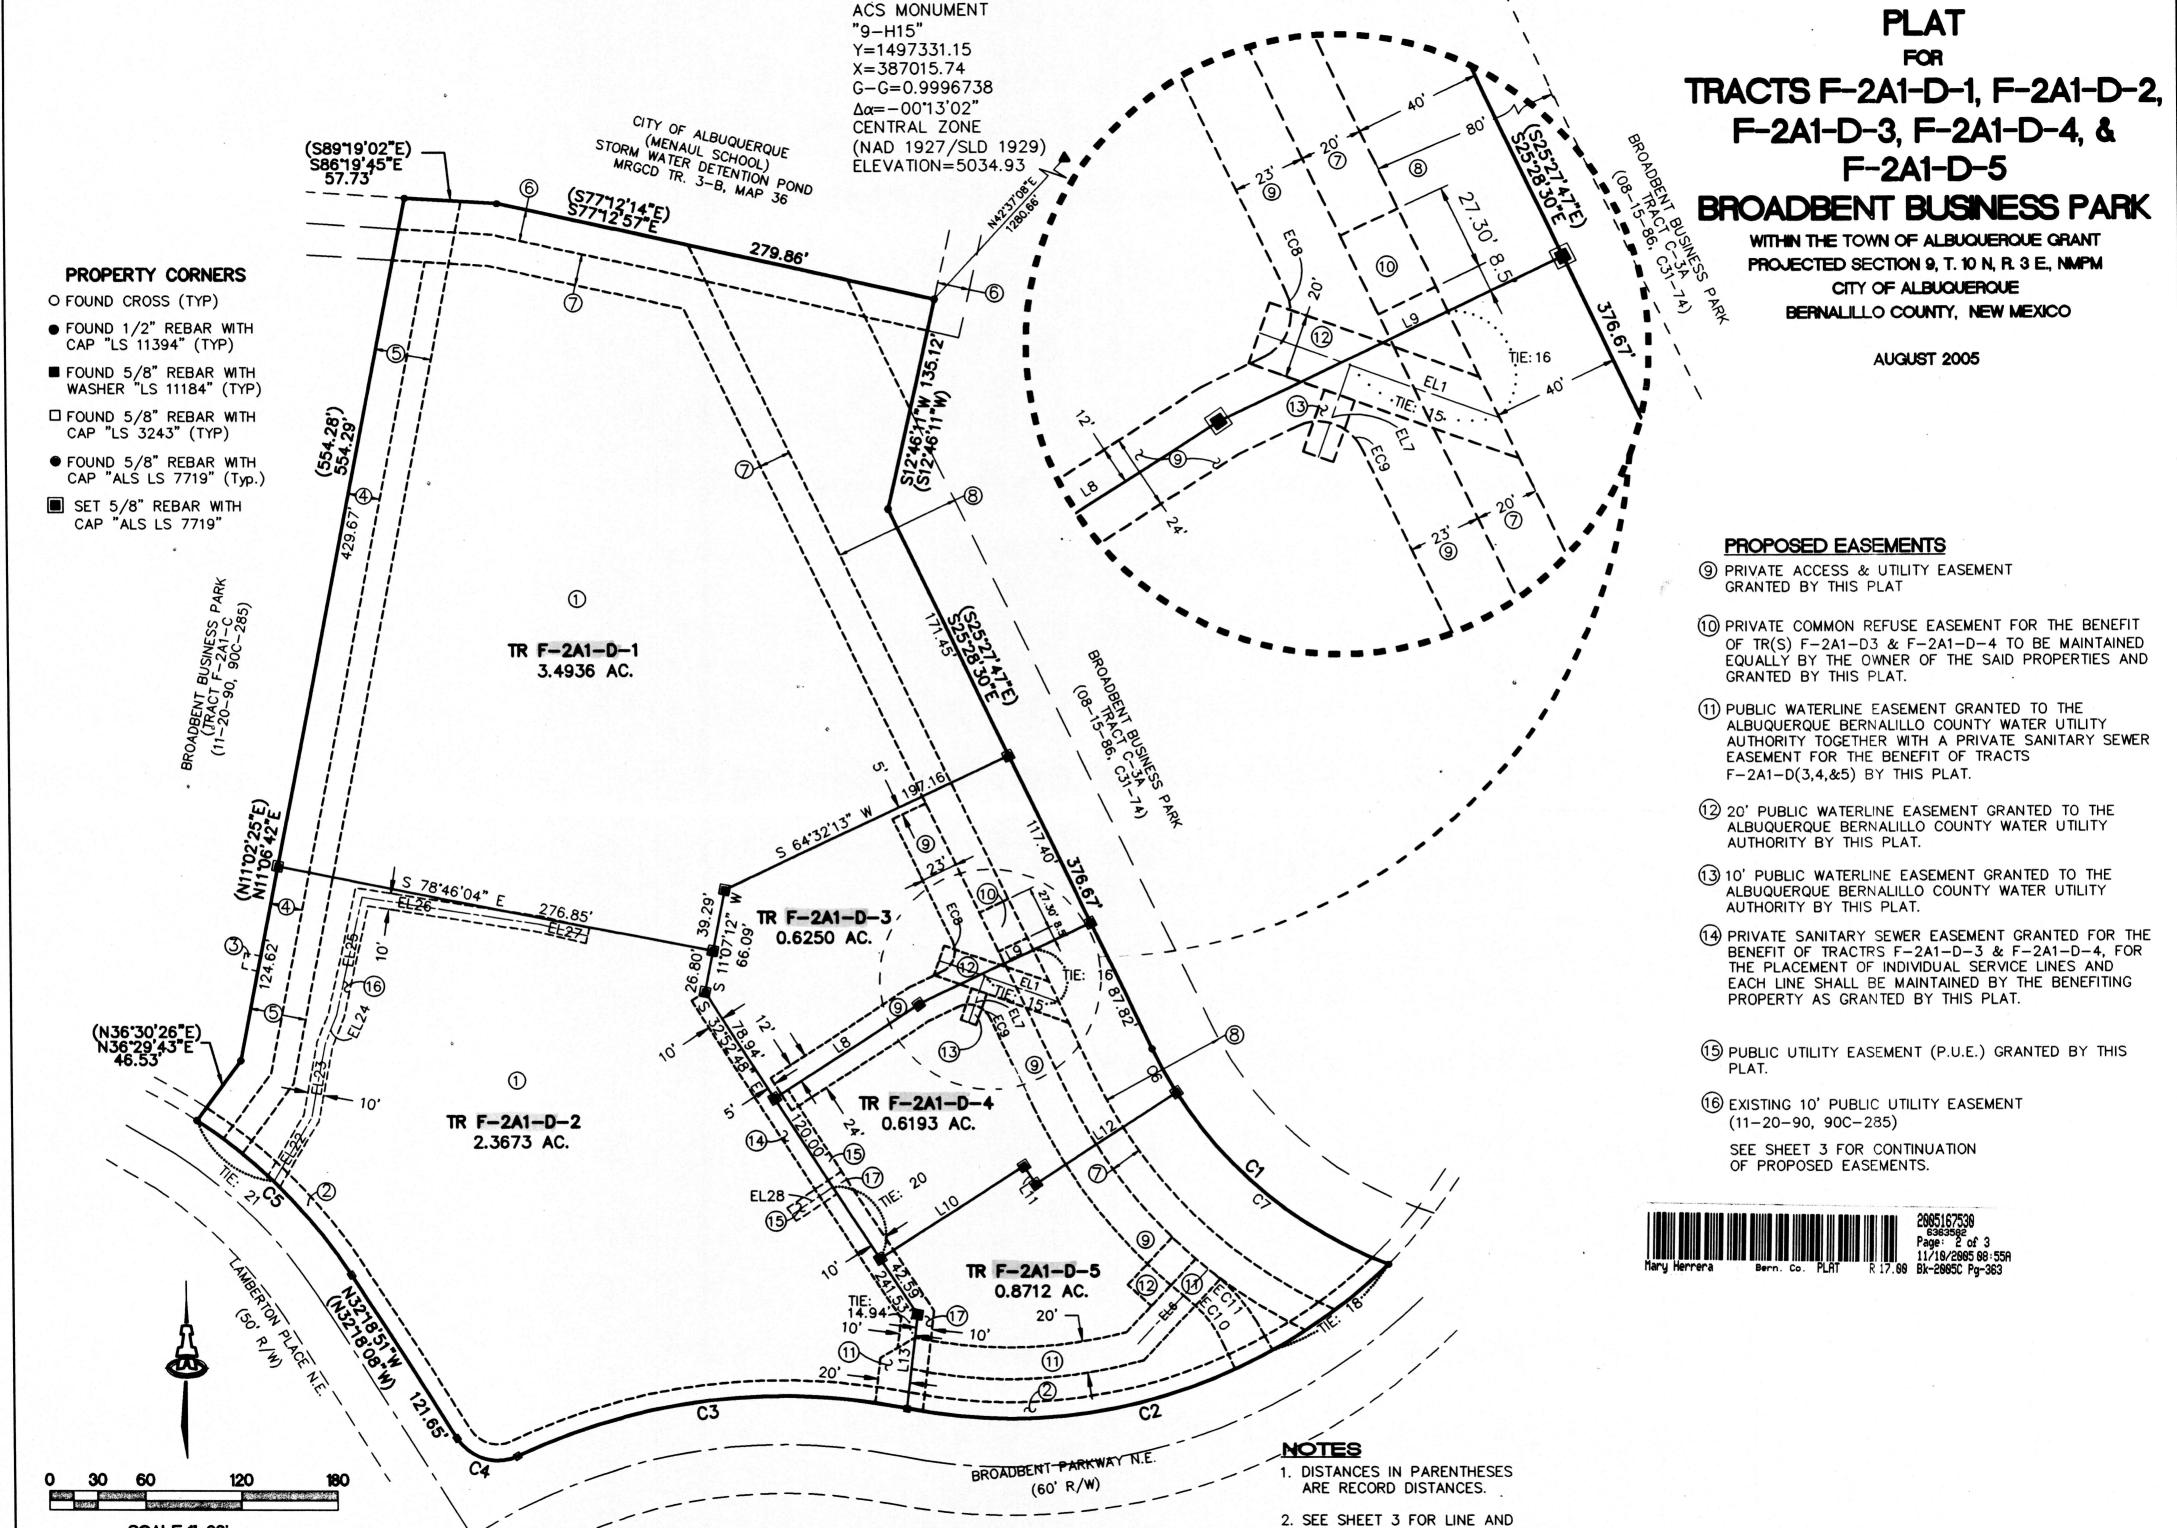


CURVE TABLES.


SCALE 1'-60'

09/12/05

1456PT1.DWGrfh

SHEET 2 OF 3

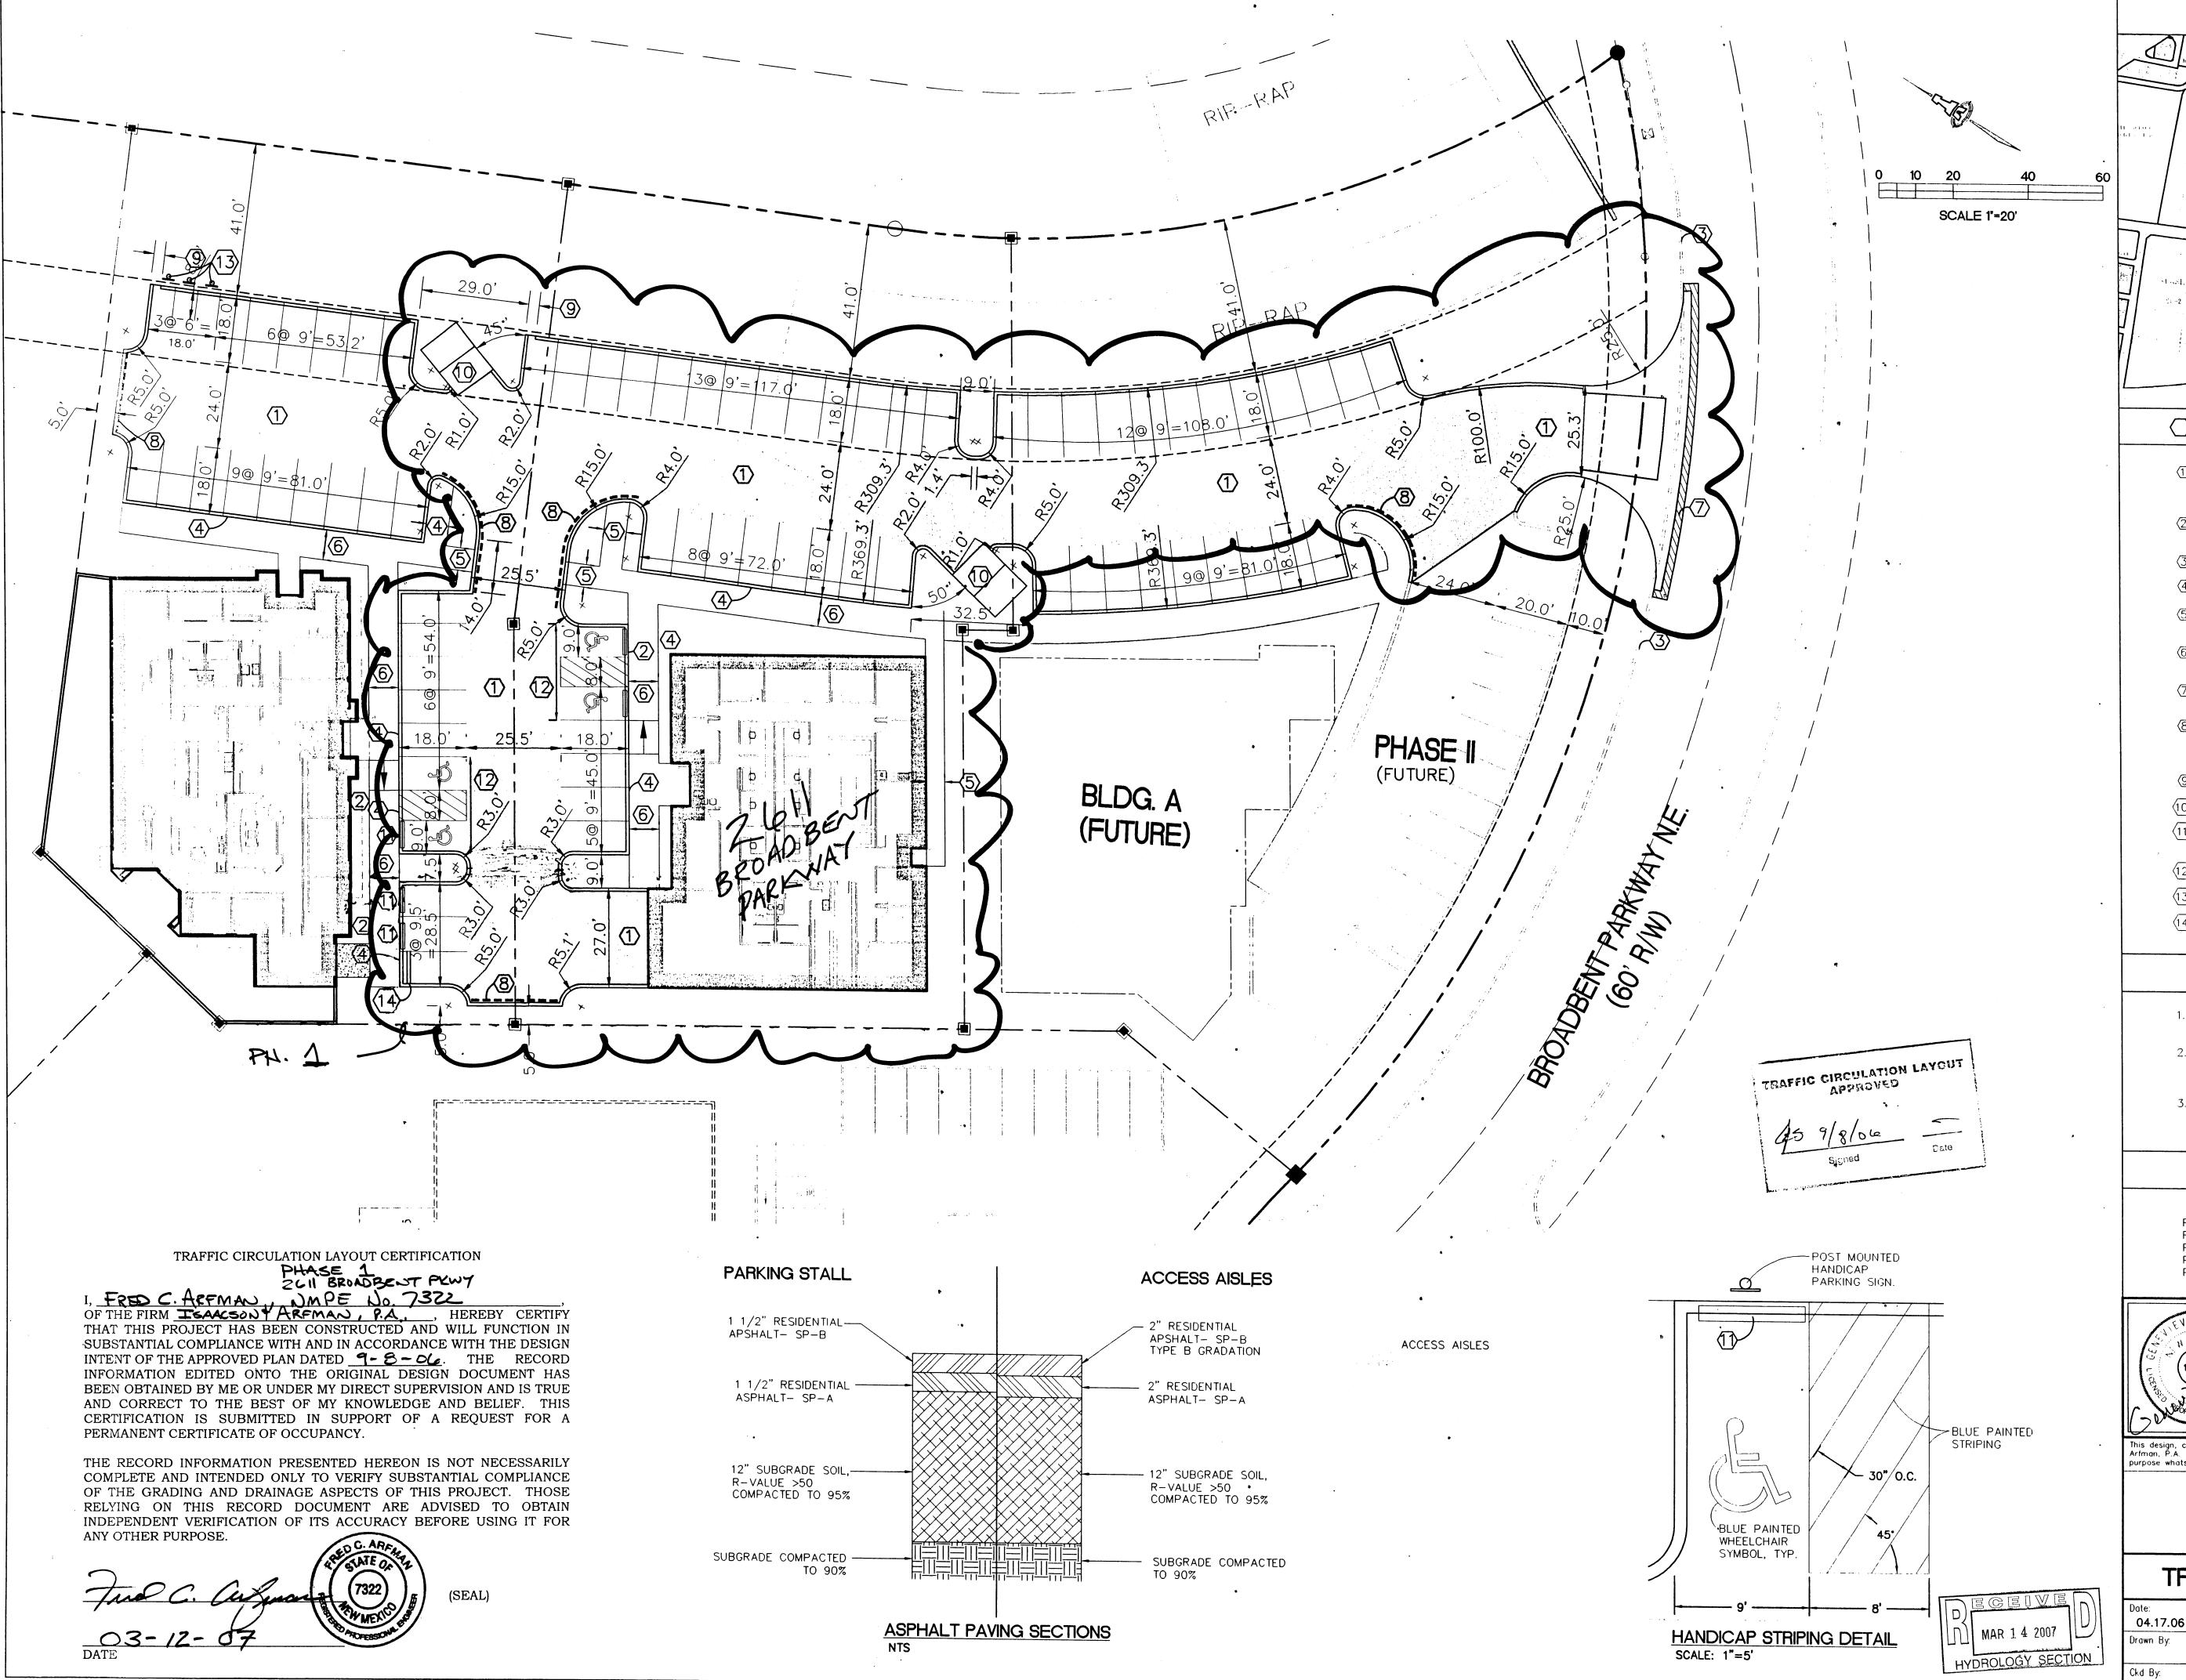

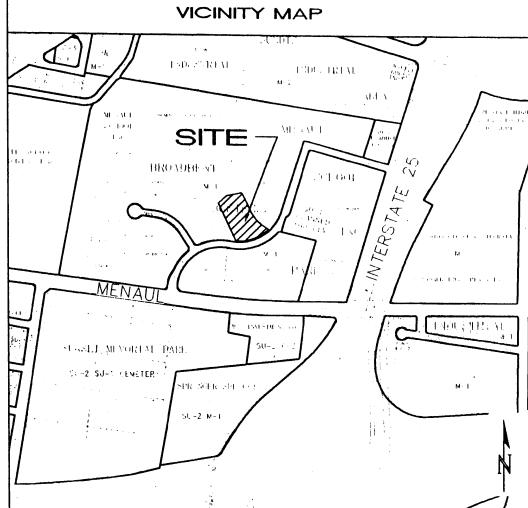

## KEYED CONSTRUCTION NOTES

- 1) ASPHALT PAVING PER SECTION, THIS SHEET. REMOVE & DISPOSE OF EXISTING PAVING & CURB/GUTTER UNLESS OTHERWISE NOTED.
- (2) TOP OF ASPHALT TO MATCH TOP OF PCC SIDEWALK GRADE.
- ③ PCC CURB/GUTTER TO REMAIN IN PLACE.
- 4 MONOLITHIC CURB PLACE W/ PCC SIDEWALK.
- (5) 6' WIDE 4" THICK PCC SIDEWALK PER COA STD DWG #2430.
- 6 8' WIDE, 4" THICK PCC SIDEWALK PER COA STD DWG #2430.
- (7) SAW-CUT EXISTING ASPHALT AT LIMITS OF NEW PAVING.
- © CURB PAINTED RED WITH SAFETY WHITE LETTERING "FIRE LANE-NO PARKING" AT 12'-0" O.C.
- ② 2" CURB OPENING.
- (10) GARBAGE ENCLOSURE.
- 6' PCC WHEEL STOP (TYP ALONG FRONT OF BUILDING ONLY).
- (12) HANDICAP STRIPING PER DETAIL ON THIS SHEET
- (13) POST MOUNTED MOTORCICLE PARKING SIGN
- $\langle 14 \rangle$  12" WIDE PAINTED STOP BAR (SAFETY WHITE)

## GENERAL NOTES:

- 1. SEE SHEET **C-1** FOR CURB & PAVING GRADES.
- ALL PROPOSED CURB & GUTTER SHALL BE MEDIAN CURB PER COA STD DWG #2415A UNLESS OTHERWISE NOTED.
- 3. ALL STRIPING SHALL BE. 4" WIDE PAINTED STRIPING (SAFTEY WHITE) UNLESS OTHERWISE NOTED.

## PARKING INFORMATION:

FLOOR AREA: 12422.54 SF REQUIRED PARKING: 63 SPACES REQUIRED HANDICAP PARKING: 4 SPACES PROPOSED PARKING: 73 SPACES TOTAL PROPOSED MOTORCYCLE PARKING: 3 SPACES



ISAACSON & ARFMAN, P.A.
Consulting Engineering Associates

128 Monroe Street N.E.

Albuquerque, New Mexico 87108

Ph. 505-268-8828 Fax. 505-268-2632


1485TCP.DWGdlp 08.22.06

This design, calculations, and concepts are owned by and remain the property of Isaacson & Arfman, P.A. and no part thereof shall be utilized by any person, firm or corporation for any purpose whatsoever except with the written permission of Isaacson & Arfman, P.A. ©

# BROADBENT CONSULTANTS OFFICE PARK Isaacson & Arfman, P.A.

# TRAFFIC CIRCULATION PLAN

Date:	110.	TOTION	Date	Job No.
04.17.06				1485
Drawn By:	1			
0110	1			
Ckd By:				SH. OF
				31. G

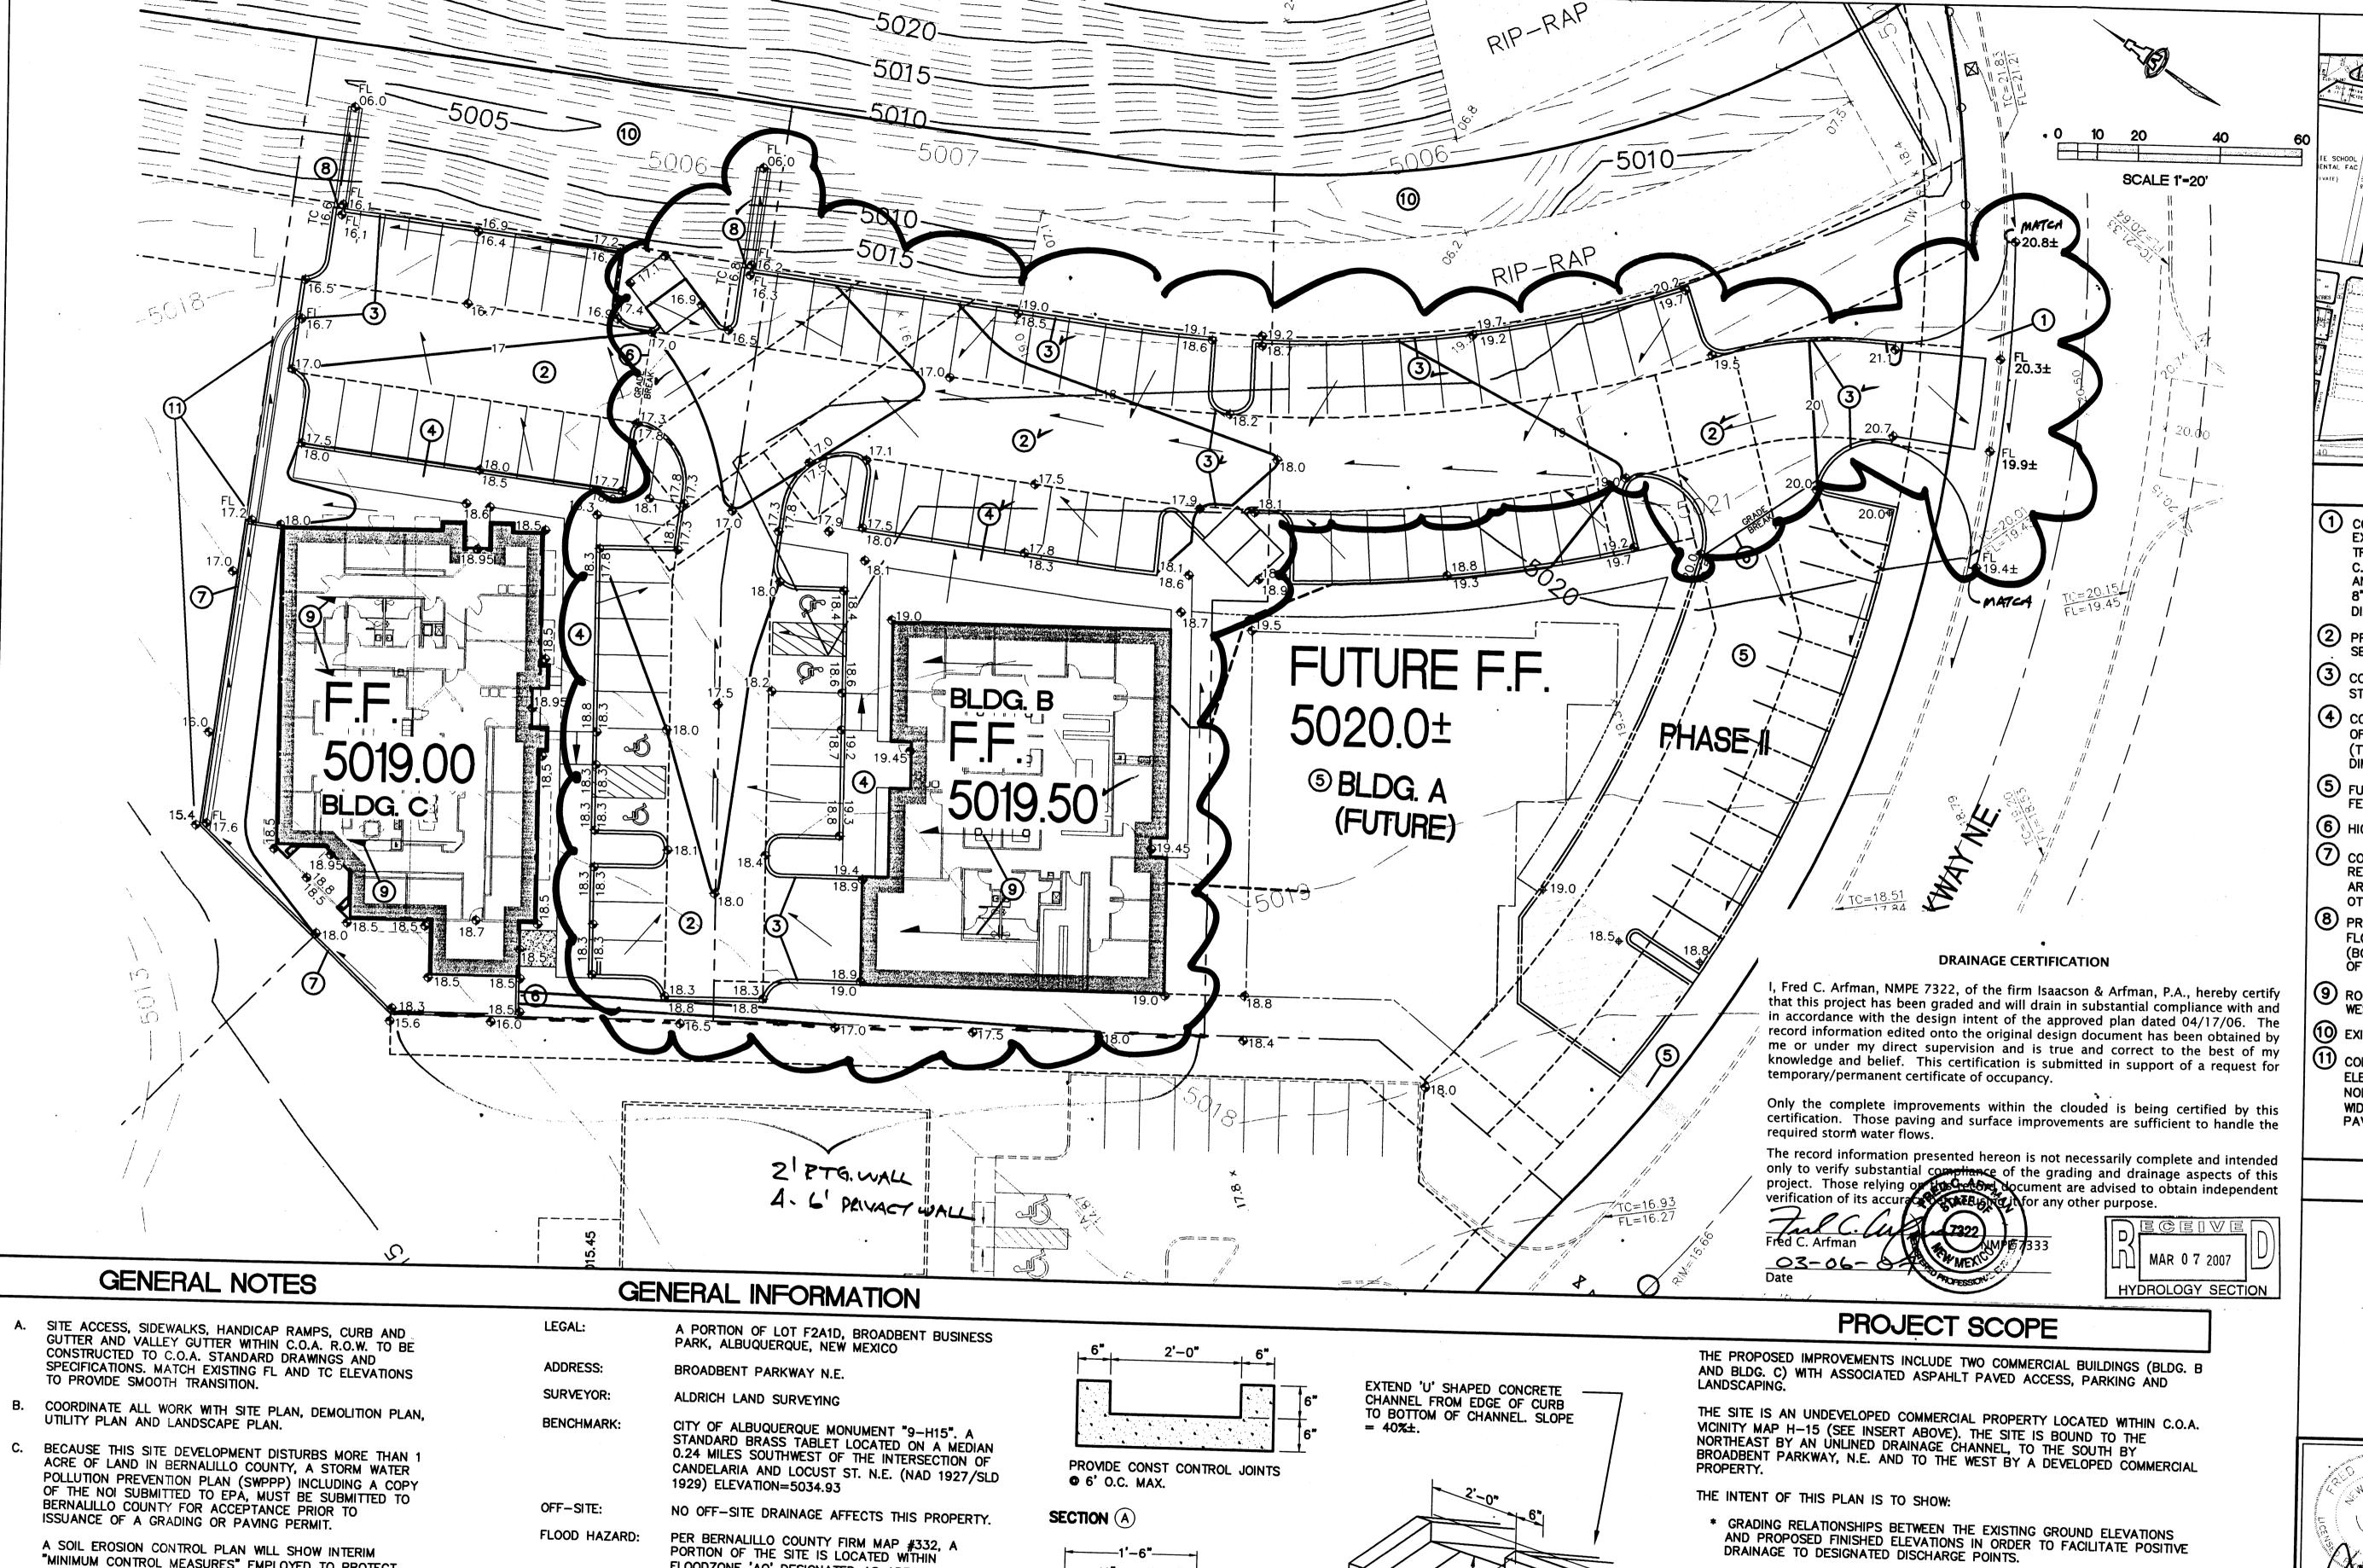

A. SITE ACCESS, SIDEWALKS, HANDICAP RAMPS, CURB AND

B. COORDINATE ALL WORK WITH SITE PLAN, DEMOLITION PLAN,

"MINIMUM CONTROL MEASURES" EMPLOYED TO PROTECT STORM WATER AND OTHER WATER RUNOFF QUALITY DURING CONSTRICTION USING "BEST MANAGEMENT PRACTICES". THE SOIL EROSION CONTROL PLAN WILL INCLUDE THE RUSLE 1.06 ANALYSIS OR OTHER APPROPRIATE ANALYSIS AND NEEDS TO BE INCLUDED WITH

CONTRACTOR TO PROVIDE THIS INFORMATION AND PAY ALL APPLICABLE APPLICATION AND PERMIT FEES TO OBTAIN GRADING / PAVING PERMITS.

GRADES SHOWN WITHIN LANDSCAPED AND PONDING AREAS INDICATE TOP OF LANDSCAPE MATERIAL. SUBGRADE TO BE GRADED TO ELEVATION SHOWN MINUS LANDSCAPE MATERIAL THICKNESS.

FLOODZONE 'AO' DESIGNATED AS AREAS WITH FLOOD DEPTHS OF 1 TO 3 FEET (USUALLY SHEET FLOW ON SLOPING TERRAIN; AVERAGE DEPTH DETERMINED TO BE 1'), THIS FLOODZONE IS CONTAINED WITHIN A 10'+ DEEP GRADED CHANNEL ALONG THE NORTHEAST PROPERTY LINE.

EROSION CONTROL: THE CONTRACTOR IS RESPONSIBLE FOR RETAINING ON-SITE ALL SEDIMENT GENERATED DURING CONSTRUCTION BY MEANS OF TEMPORARY EARTH BERMS OR SILT FENCES AT THE LOW POINTS ON THE WEST AND NORTH PROPERTY LINES.

—11"——I I—6"— 3/4"R BEYOND EXPANSION JOINT EDGES SHOULD BE 5" X 8" X 4' WDE REMOVED WITH 3/8" SECTION (B) URNED DOWN EDGE EDGING TOOL AT RUNDOWNS. CURB OPENING TRANSITION TO PASS SITE DISCHARGE TO EXISTING CHANNEL TWO LOCATIONS AS NOTED

\* THE EXTENT OF PROPOSED SITE IMPROVEMENTS, INCLUDING BUILDINGS, WALKS AND PAVEMENT.


THE FLOW RATE/VOLUME OF RAINFALL RUNOFF ACROSS OR AROUND THESE IMPROVEMENTS AND METHODS OF HANDLING THESE FLOWS TO MEET CITY OF ALBUQUERQUE REQUIREMENTS FOR DRAINAGE MANAGEMENT.

\* THE RELATIONSHIP OF ON-SITE IMPROVEMENTS WITH EXISTING NEIGHBORING PROPERTY TO INSURE AN ORDERLY TRANSITION BETWEEN PROPOSED AND SURROUNDING GRADES.

## DRAINAGE PLAN CONCEPT:

N.T.S.

THE OVERALL PROPERTY IS DIVIDED INTO FIVE SEPARATE SUB-BASINS. SUB-BASIN 1 (THE EXISTING CHANNEL) WILL NOT BE DISTURBED DURING DEVELOPMENT OTHER THAN TO PASS CONCENTRATED FLOW FROM SUB-BASINS 2. 3 AND 4 WHICH SURFACE DRAIN TO PROPOSED CURB OPENINGS AS SHOWN. SUB-BASIN 5 (FUTURE) WILL DISCHARGE TO BROADBENT PARKWAY N.E. SEE SUPPLEMENTAL INFORMATION PACKET FOR CALCULATIONS.

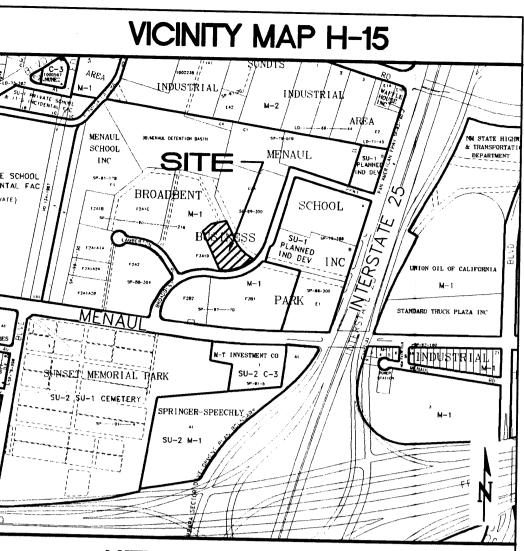


## **KEYED NOTES**

- 1 CONSTRUCT SITE ENTRANCE PER C.O.A. STANDARDS. MATCH EXISTING FLOWLINE ELEVATIONS TO PROVIDE A SMOOTH RIDING TRANSITION. CONSTRUCT CONCRETE VALLEY GUTTER (PER C.O.A. STD. DWG. 2426) MATCHING EXISTING TOP OF CURB AND FLOWLINE ELEVATIONS. TRANSITION CURB HEIGHT FROM 8" TO 6" OVER LENGTH OF RADIUS. SEE ARCHITECTURAL FOR DIMENSIONS / DETAILS / DEMOLITION OF EXISTING CURBS.
- PROPOSED ASPHALT PAYING. SEE ARCHITECTURAL FOR SECTIONS, PARKING LAYOUT, DIMENSIONS, STRIPING, ETC.
- 3 CONSTRUCT 6" HIGH MEDIAN CURB AND GUTTER PER C.O.A. STD. DWG. 2415 (TYPICAL) UNLESS NOTED OTHERWISE.
- (4) CONSTRUCT TURNED DOWN CONCRETE WALK THIS AREA. TOP OF WALK TO BE 6" ABOVE TOP OF ADJACENT PAVEMENT (TYPICAL). SEE ARCHITECTURAL FOR RAMP LOCATIONS / DIMENSIONS AND ADDITIONAL INFORMATION.
- 5 FUTURE PHASE BLDG. / ACCESS / PARKING / DRAINAGE FEATURES N.I.C.
- 6 HIGH POINT THIS AREA.
- CONSTRUCT PRIVACY WALLS WITH UP TO 24" EARTH RETENTION TO ACHIEVE GRADE DIFFERENCES SHOWN. SEE ARCHITECTURAL FOR ADDITIONAL INFORMATION (DESIGN BY
- 8 PROVIDE 2' WIDE OPENING IN CURB TO PASS DEVELOPED FLOW TO CHANNEL (TWO LOCATIONS). CONSTRUCT 2' WIDE (BOTTOM WIDTH) 'U' SHAPED CONCRETE CHANNEL FROM EDGE OF CURB TO CHANNEL BOTTOM. SEE DETAIL THIS SHEET.
- 9 ROOF FLOW THIS BLDG. TO BE COLLECTED AND RELEASED TO WEST SIDE LANDSCAPED AREA.
- (10) EXISTING DRAINAGE CHANNEL
- 11 CONSTRUCT 2' WIDE CONCRETE SWALE AT FLOWLINE ELEVATIONS SHOWN. PROVIDE 2' WIDE X 6" HIGH OPENING IN NORTH WALL TO PASS FLOW TO PROPOSED 2' WIDE (BOTTOM WIDTH) 'U' SHAPED CONCRETE CHANNEL TO DELIVER FLOW TO PAVEMENT.

# LEGEND

SIDEWALK, CURB and GUTTER, ETC. (EXISTING, PROPOSED) EXISTING SPOT ELEVATION + 93.7 \_\_\_\_5093 ----EXISTING CONTOUR PROPOSED SPOT ELEVATION **♦** 54.5 PROPOSED CONTOUR FLOW LINE FINISHED FLOOR PROPOSED FIRE HYDRANT

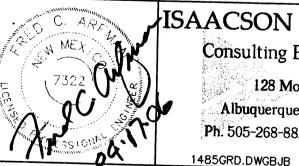

ISAACSON & ARFMAN, P.A. Consulting Engineering Associates

128 Monroe Street N.E. Albuquerque, New Mexico 87108 Ph. 505-268-8828 Fax. 505-268-2632

This design, calculations, and concepts are owned by and remain the property of Isaacson & Arfman, P.A. and no part thereof shall be utilized by any person, firm or corporation for any purpose whatsoever except with the written permission of Isaacson & Arfman, P.A. ©

## BROADBENT CONSULTANTS OFFICE PARK isaacson & Ariman, P.A.

GRADING & DRAINAGE PLAN

Job No. 1485 04.17.06 Drawn By: BJB Ckd By: FCA SH OF

