

GENERAL NOTES:

1: ADD TO SPOT ELEVATIONS TO SHOW TRUE ELEVATION.

2: CONTOUR INTERVAL IS ONE (1) FOOT.

3: ELEVATIONS ARE BASED ON CITY OF ALBUQUERQUE CONTROL STATION MON-9-H15

HAVING AN ELEVATION OF 5037.70 FEET ABOVE SEA LEVEL.

4: UTILITIES SHOWN HEREON ARE IN THEIR APPROXIMATE LOCATION BASED ONLY ON ABOVE GROUND EVIDENCE FOUND IN THE FIELD AND AS-BUILT

INFORMATION PROVIDED BY THE CLIENT. UTILITIES SHOWN HEREON, WHETHER

INDICATED AS ABANDONED OR NOT, SHALL BE VERIFIED BY OTHERS FOR EXACT LOCATION AND/ OR DEPTH PRIOR TO EXCAVATION OR DESIGN CON-SIDERATIONS.

5: THIS IS NOT A BOUNDARY SURVEY, BEARINGS ARE ASSUMED, DISTANCES AND FOUND PROPERTY CORNERS ARE FOR INFORMATIONAL PURPOSES ONLY.

6: SLOPES ARE AT 3:1 MAXIMUM. 7: INLET & SIDEWALK CULVERT CONSTRUCTION TO BE DONE UNDER THE CITY WORK ORDER.

8: ALLEY GUTTER ON-SITE TO BE BUILT BASED ON CITY STD 2415A.

EROSION CONTROL PLAN AND POLLUTION PREVENTION NOTES

CONTRACTOR IS RESPONSIBLE FOR OBTAINING A TOPSOIL DISTURBANCE PERMIT PRIOR TO BEGINNING WORK.

2. CONTRACTOR IS RESPONSIBLE FOR CLEANING ALL SEDIMENT OUT OF EXISTING RIGHT-OF-WAY.


3. CONTRACTOR IS RESPONSIBLE FOR MAINTAINING ALL STORM

RUNOFF ON SITE. 4. REPAIR OF DAMAGED FACILITIES AND CLEAN-UP OF SEDIMENT

ACCUMULATION ON ADJACENT PROPERTIES AND IN PUBLIC FACILITIES IS THE RESPONSIBILITY OF THE CONTRACTOR.


5. ALL EXPOSED EARTH SURFACES MUST BE PROTECTED FROM WIND AND WATER EROSION PRIOR TO FINAL ACCEPTANCE OF ANY

6. ALL THE DISTURBED AREAS MUST BE REVEGETATED.

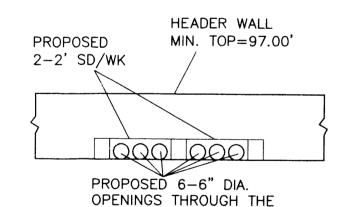

SECTION A-A

HEADERWALL (INV.=94.87)

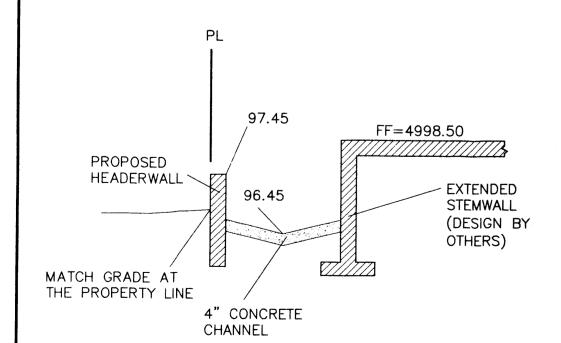

SECTION B-B

NOTICE TO CONTRACTORS 1. AN EXCAVATION/CONSTRUCTION PERMIT WILL BE REQUIRED BEFORE BEGINNING ANY WORK WITHIN CITY RIGHT-OF-WAY.


2. ALL WORK DETAILED ON THESE PLANS TO BE PERFORMED, EXCEPT AS OTHERWISE STATED OR PROVIDED HEREON, SHALL BE CONSTRUCTED IN ACCORDANCE WITH CITY OF ALBUQUERQUE INTERIM STANDARD SPECIFICATIONS FOR PUBLIC WORKS CONSTRUCTION.


3. TWO WORKING DAYS PRIOR TO ANY EXCAVATION, CONTRACTOR MUST CONTACT LINE LOCATING SERVICE, 765-1234, FOR LOCATION OF EXISTING UTILITIES.

4. PRIOR TO CONSTRUCTION, THE CONTRACTOR SHALL EXCAVATE AND VERIFY THE HORIZONTAL AND VERTICAL LOCATIONS OF ALL CONSTRUCTIONS. SHOULD A CONFLICT EXIST, THE CONTRACTOR SHALL NOTIFY THE ENGINEER SO THAT THE CONFLICT CAN BE RESOLVED WITH A MINIMUM AMOUNT OF DELAY.

5. BACKFILL COMPACTION SHALL BE ACCORDING TO TRAFFIC/STREET USE. 6. MAINTENANCE OF THESE FACILITIES SHALL BE THE RESPONSIBILITY OF THE OWNER OF THE PROPERTY SERVED.

7. WORK ON ARTERIAL STREETS SHALL BE PERFORMED ON A 24-HOUR BASIS.

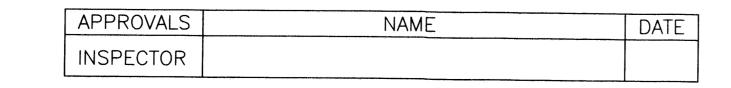

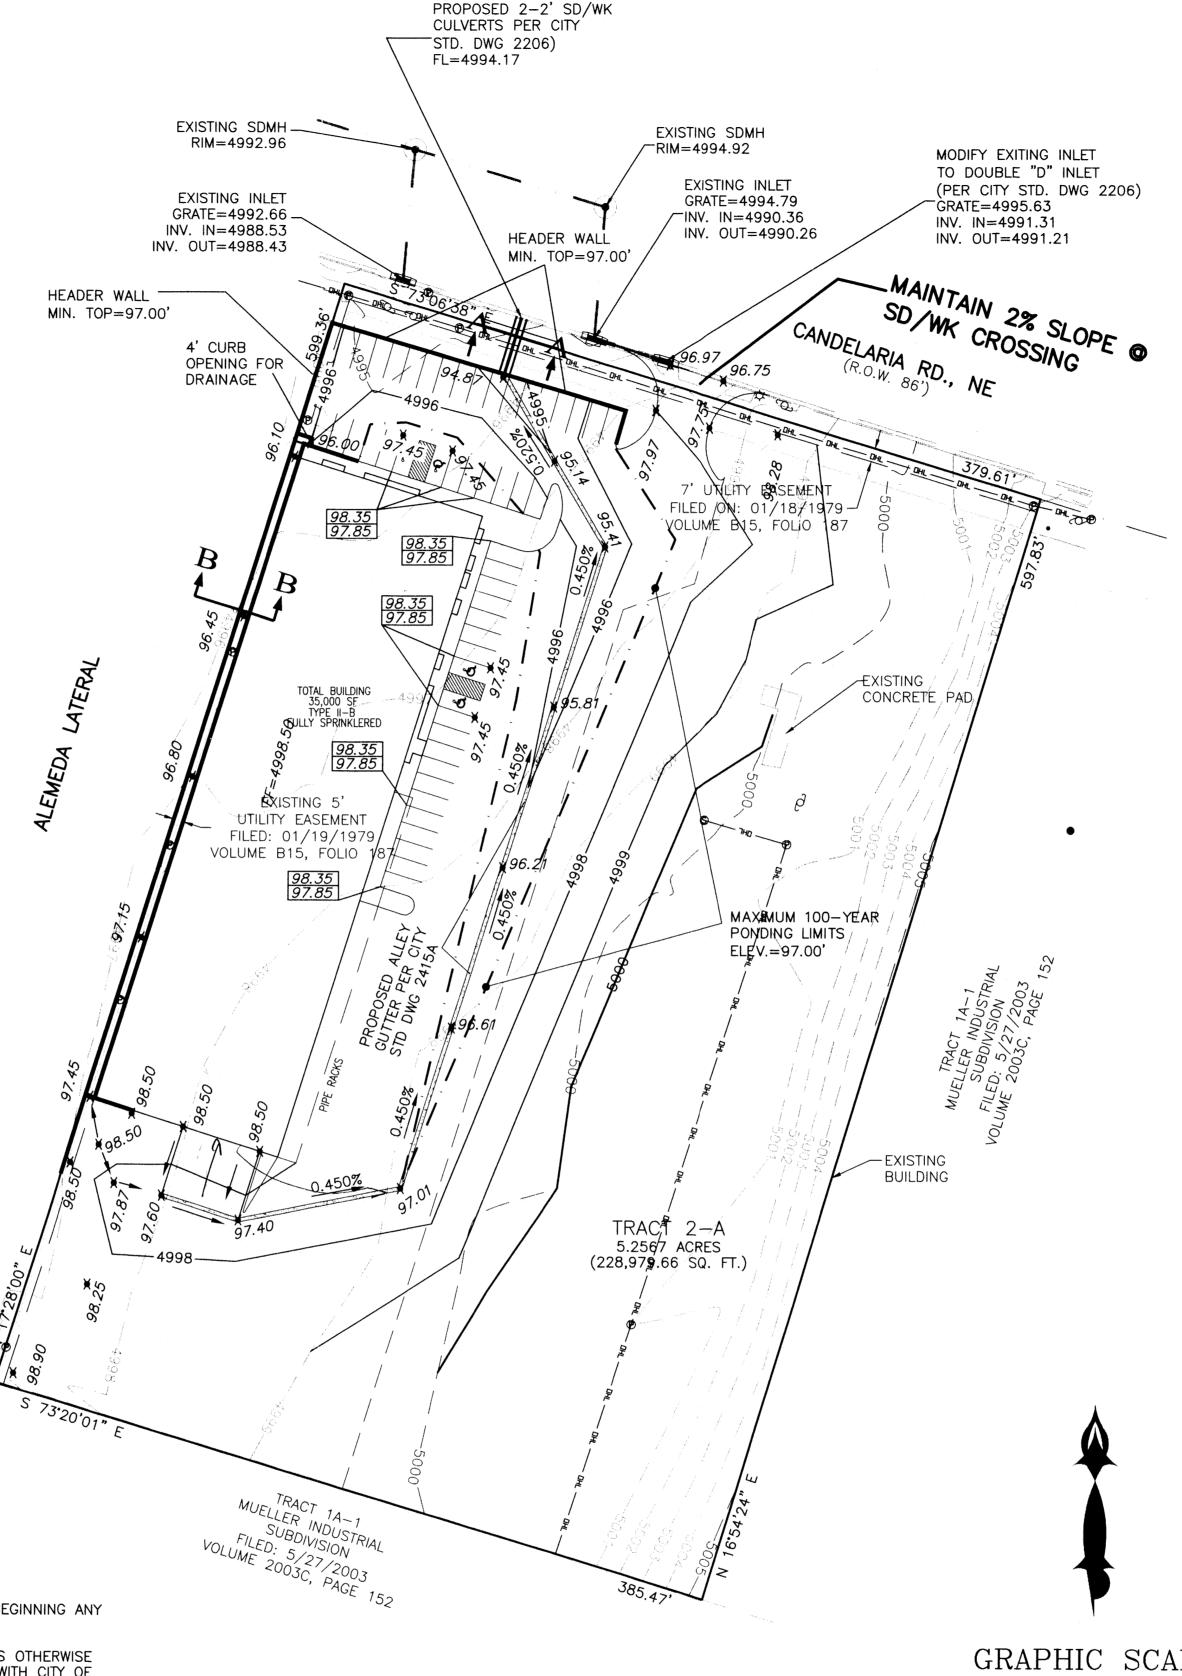




SCALE: 1"=50'

ROUGH GRADING APPROVAL

DATE

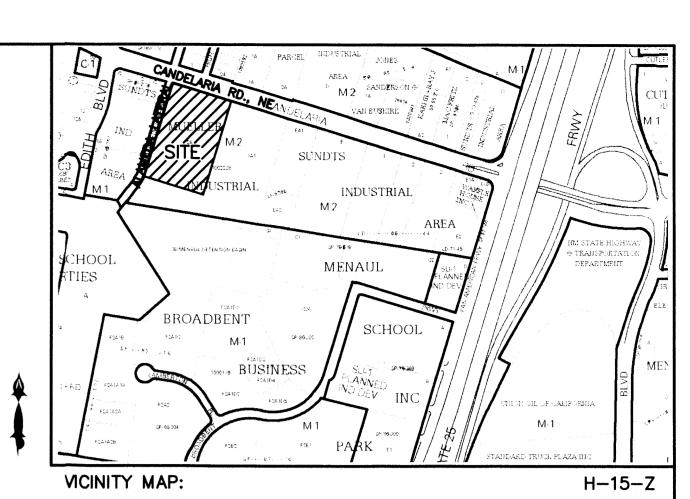

LEGAL DESCRIPTION:

TRACT 2-A OF MUELLER INDUSTRIAL SUBDIVISION CONTAINING 228,979.66 SQUARE FEET (5.2567 ACRES) MORE OR LESS.

ZONED M-2

ADDRESS:

600 CANDELARIA RD. NE

LEGEND

	EXISTING SAS MANHOLE		
	EXISTING SD MANHOLE		
୍ର	EXISTING METER		
\sim	EXISTING VALVE W/BOX		
\odot	EXISTING FIRE HYDRANT		
	EXISTING AIR RELEASE VALVE		
	EXISTING REDUCER		
EX. 8" SAS	EXISTING SANITARY SEWER LINE		
EX. 16" WL	EXISTING WATER LINE		
	EXISTING CURB & GUTTER		
	PROPOSED CURB & GUTTER		
5000	EXISTING CONTOUR (MAJOR)		
4999	EXISTING CONTOUR (MINOR)		
	BOUNDARY LINE		
	EASEMENT		
	LIMITS OF TOP OF EXISTING SLOPE		
	PROPOSED SIDEWALK		
<i>TC</i>	PROPOSED GRADE		

TOP OF RETAINING WALL TOP OF FOOTING

¥ 70.28

 \times 5265.16

TOP OF FOOTING EXISTING DROP INLET EXISTING STREET LIGHT


EXISTING GRADE

PROPOSED SPOT ELEVATION

PROPOSED EXTENDED STEM WALL

TOP OF EXTENDED STEM WALL


EXISTING ANCHER EXISTING POWER POLE EXISTING SERVICE POLE

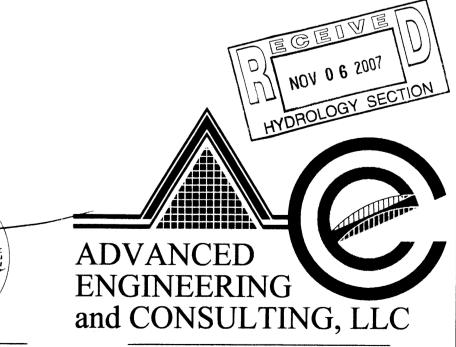

SHAHAB BIAZAR P.E. #13479

4416 ANAHEIM AVE., NE ALBUQUERQUE, NEW MEXICO 87113

	DOC SAVAGE SUPPLY GRADING AND DRAINAGE PLAN					
	DRAWING:	DRAWN BY:	DATE:	SHEET#		
7	200712-GR.DWG	SBB/JT	10-22-2007	1 OF 1		

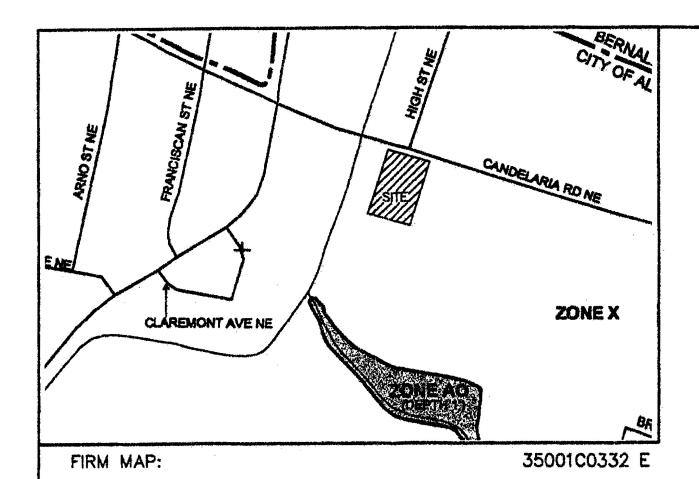

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OF THE PROPERTY SERVED.

APPROVALS

INSPECTOR

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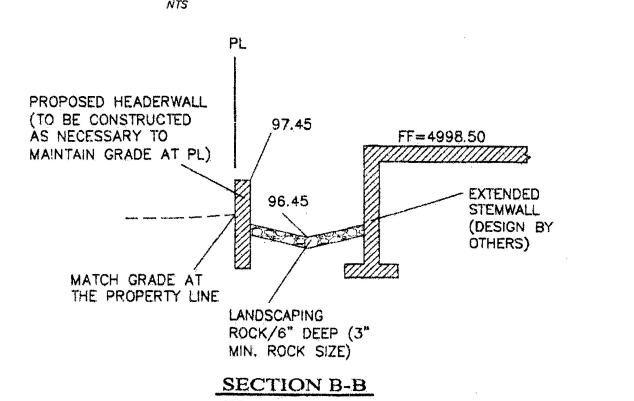
NOTICE TO CONTRACTORS


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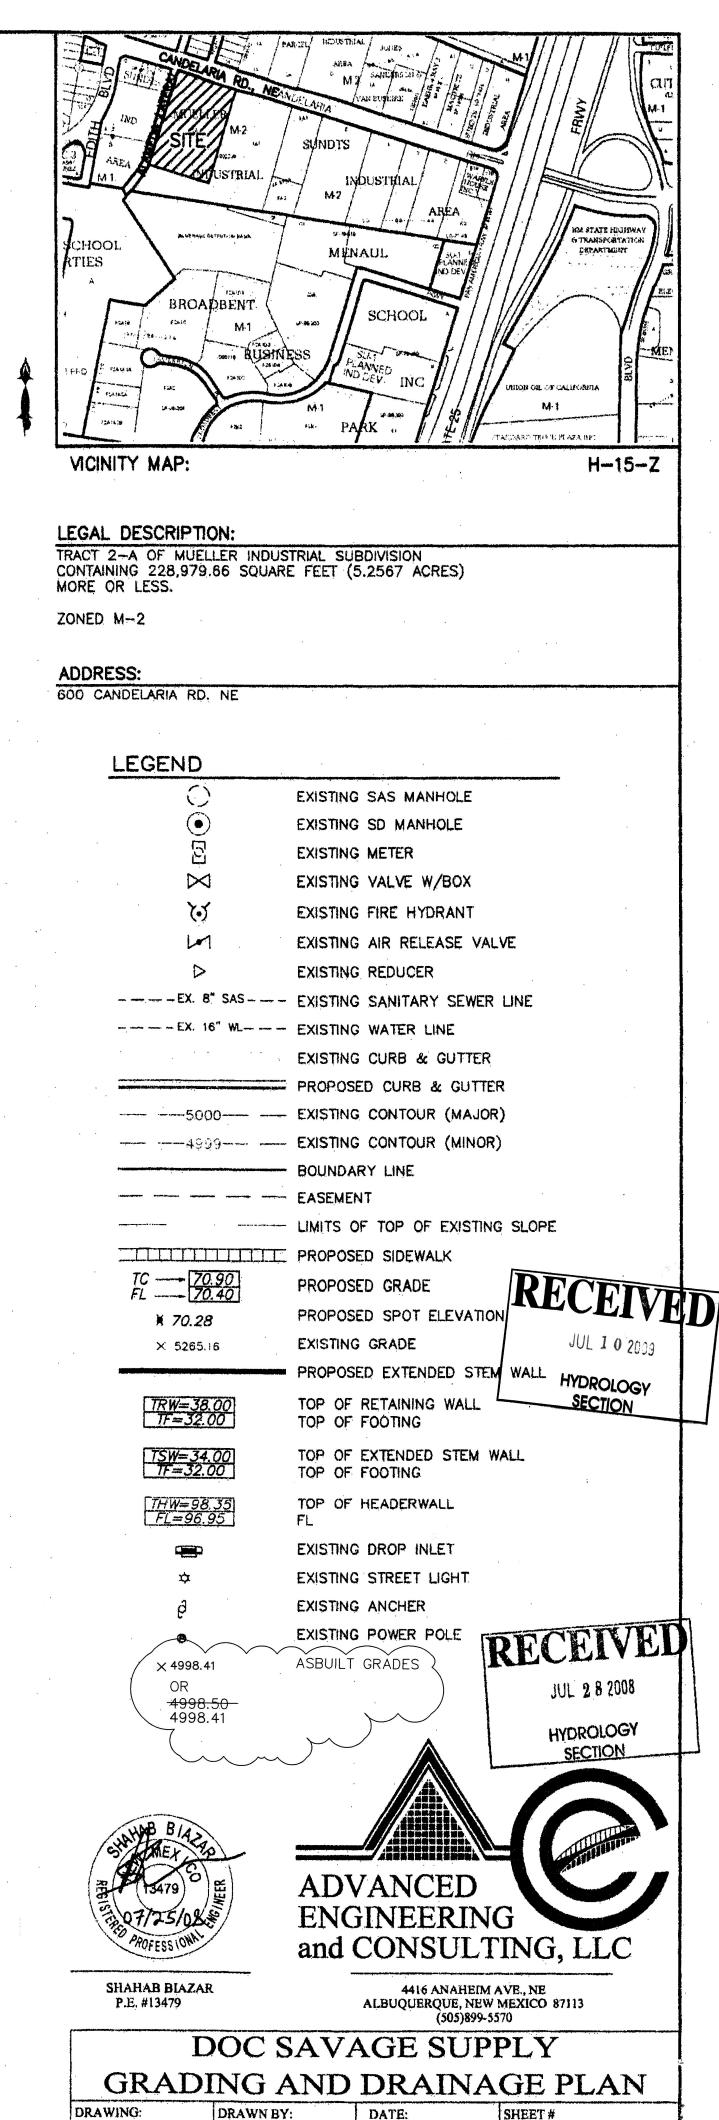
NAME

DATE

PROPOSED 2-2' SD/WK PROPOSE OPENING HEADERN	HEADER WALL. MIN. TOP=97.00' D 66" DIA. S THROUGH THE PALL (INV/-94.87)	2 Proposed 12" > Opening W/ Grite	03/10/07
SEC	TION A-A		





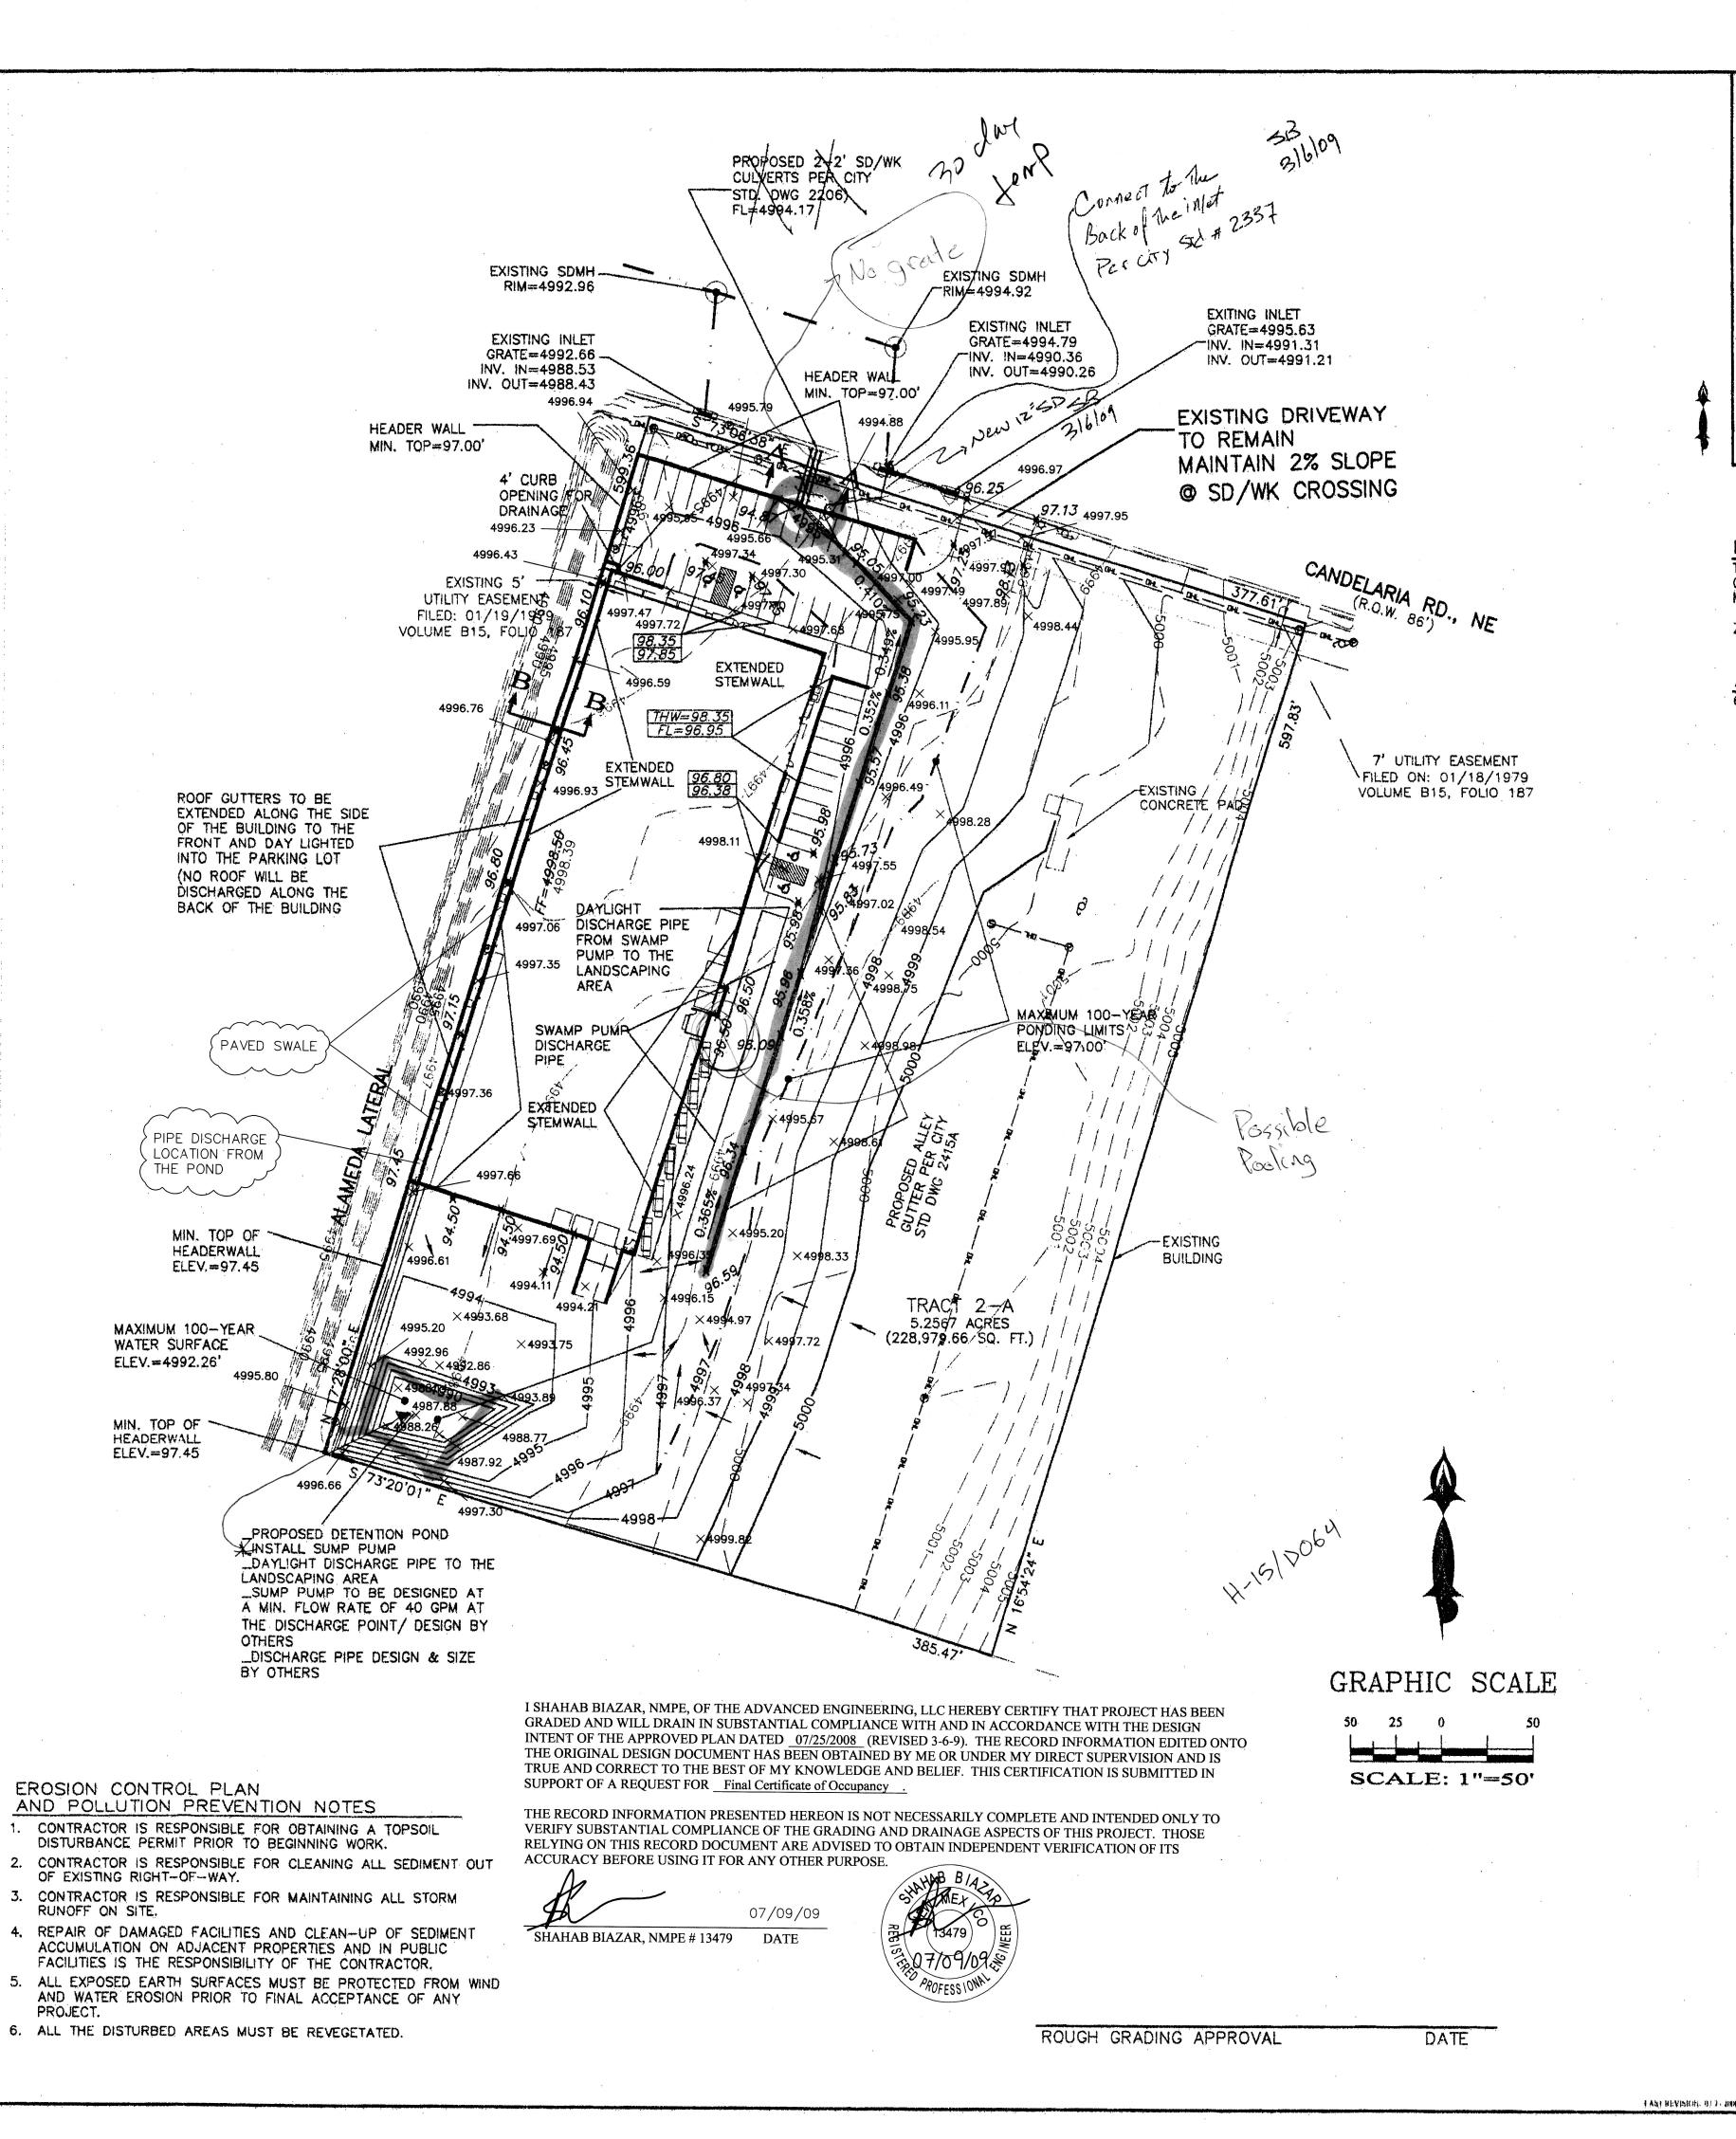

200712-GR.DWG

SBB/JT

10-22-2007

1 OF 1