# **ADMINISTRATIVE AMENDMENT**

FILE #: SI-2023-01718 PROJECT #: PR-2019-002677

Modifications to approved site plan phasing, building elevations, and landscaping;

Outdoor patio (3,888 sf) north of the retail use changed to phase 2; Removal of patic

Elevation modifications to NW corner of American Home retail pad: Glazing removed

Landscape plan modified to accommodate site changes. All changes compliant with

No changes to site access, circulation, or parking.

Digitally signed by James M.


Aranda

Date: 2023.12.04 10:46:16 -07'00'

12/4/2023

**APPROVED BY** 


**DATE** 

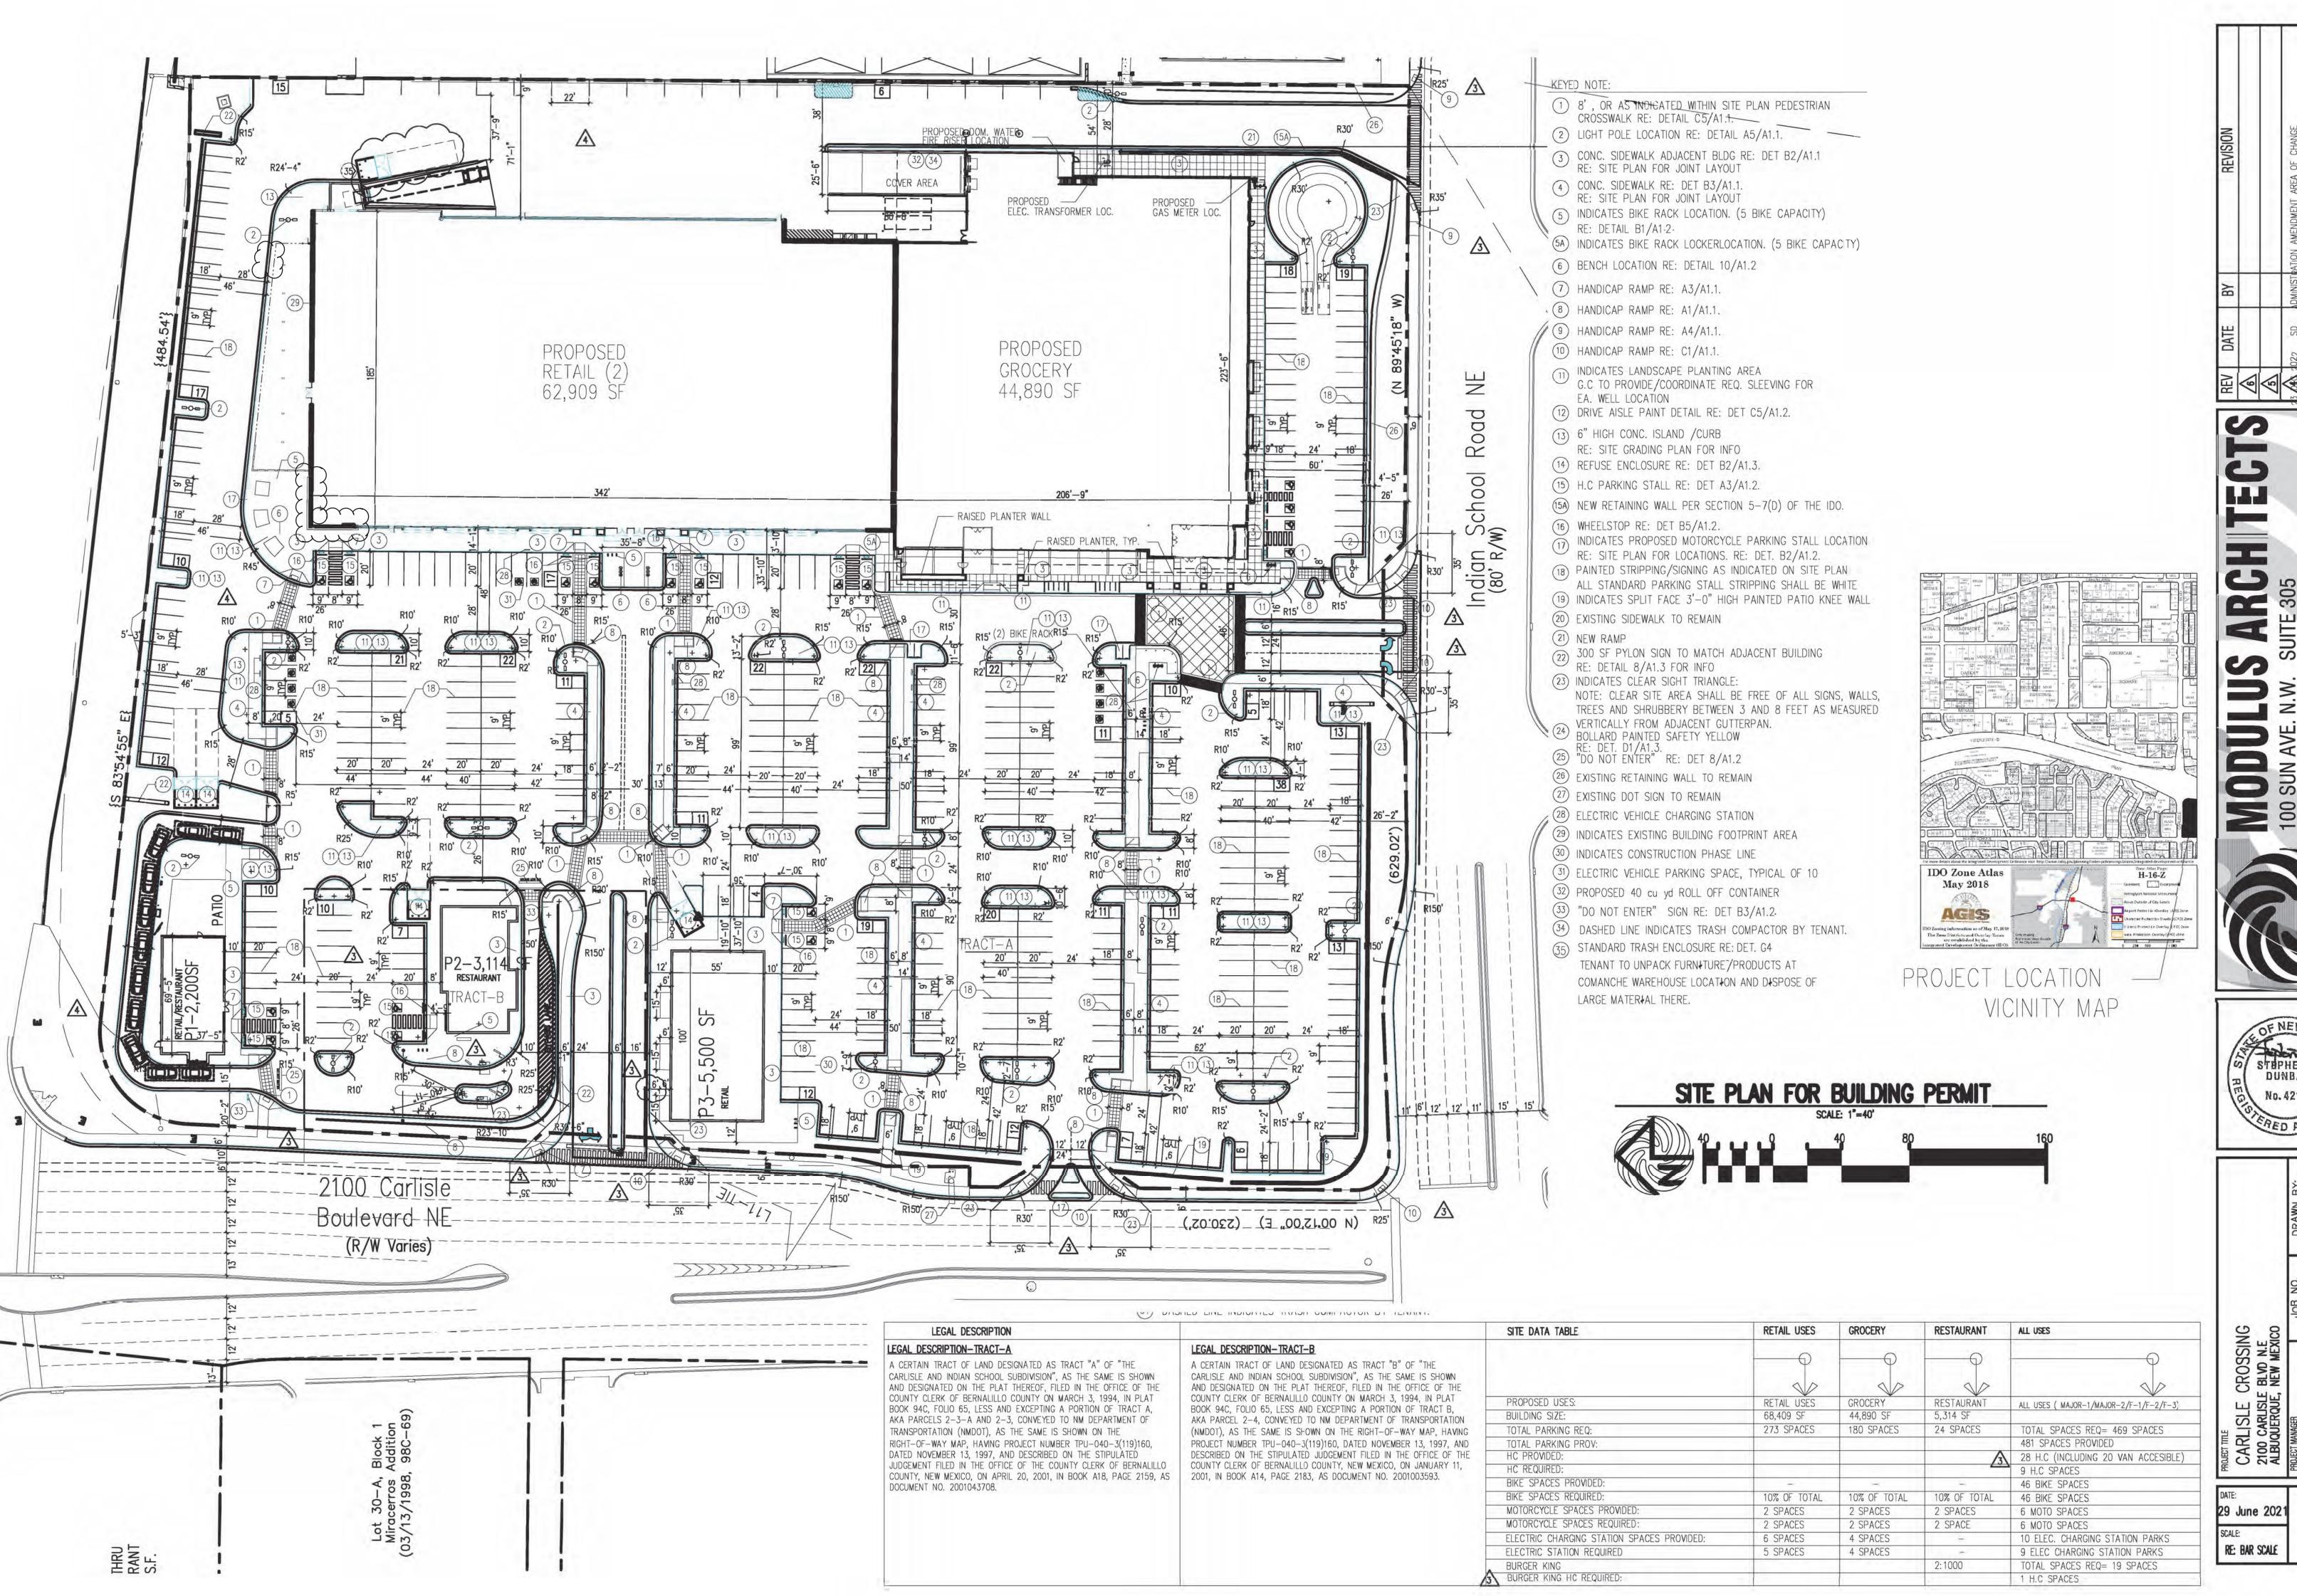



JITE 305 JEXICO 87109 FAX (505) (





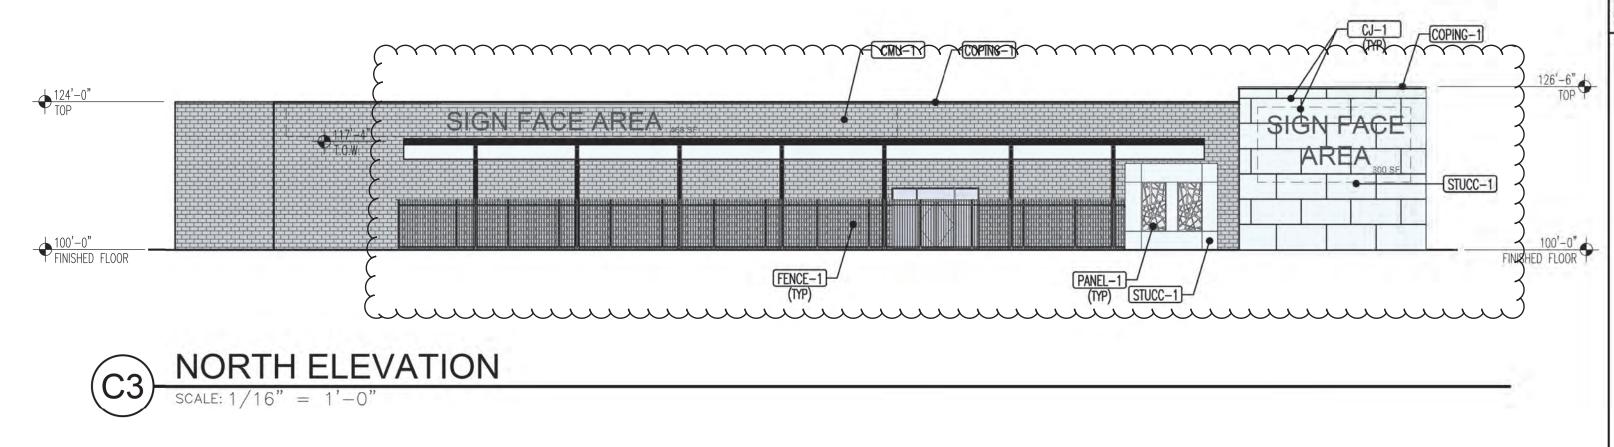

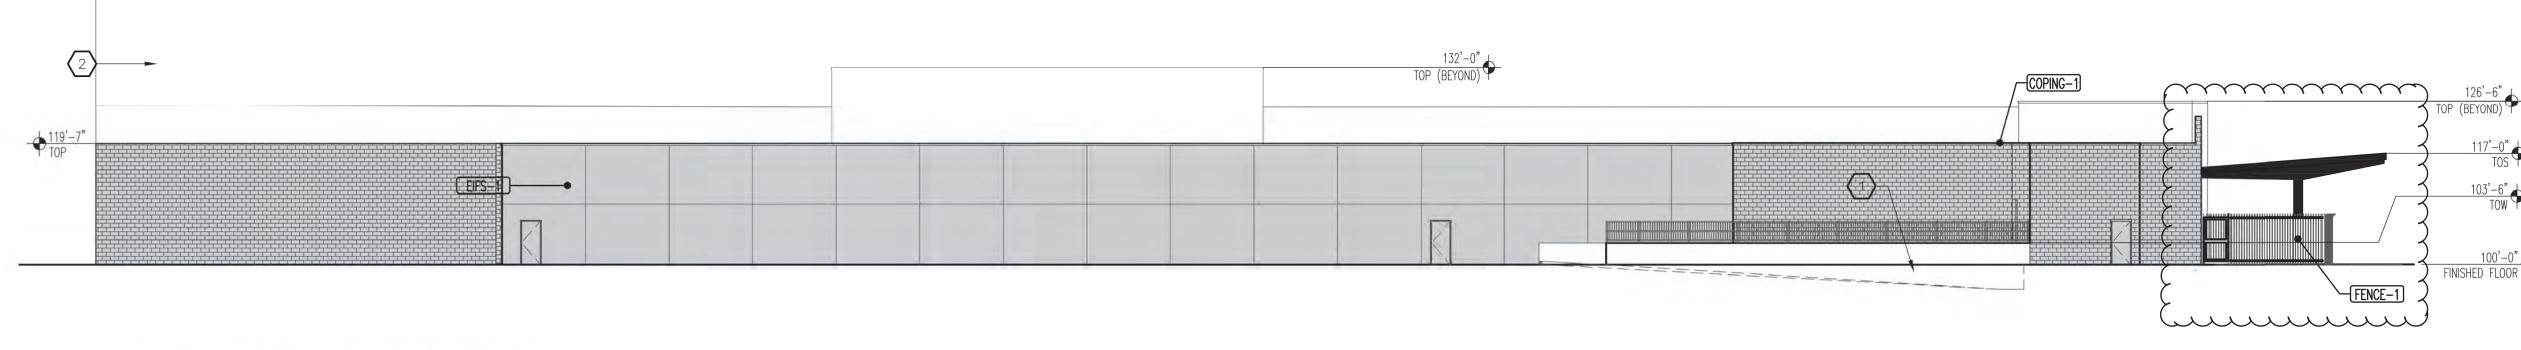

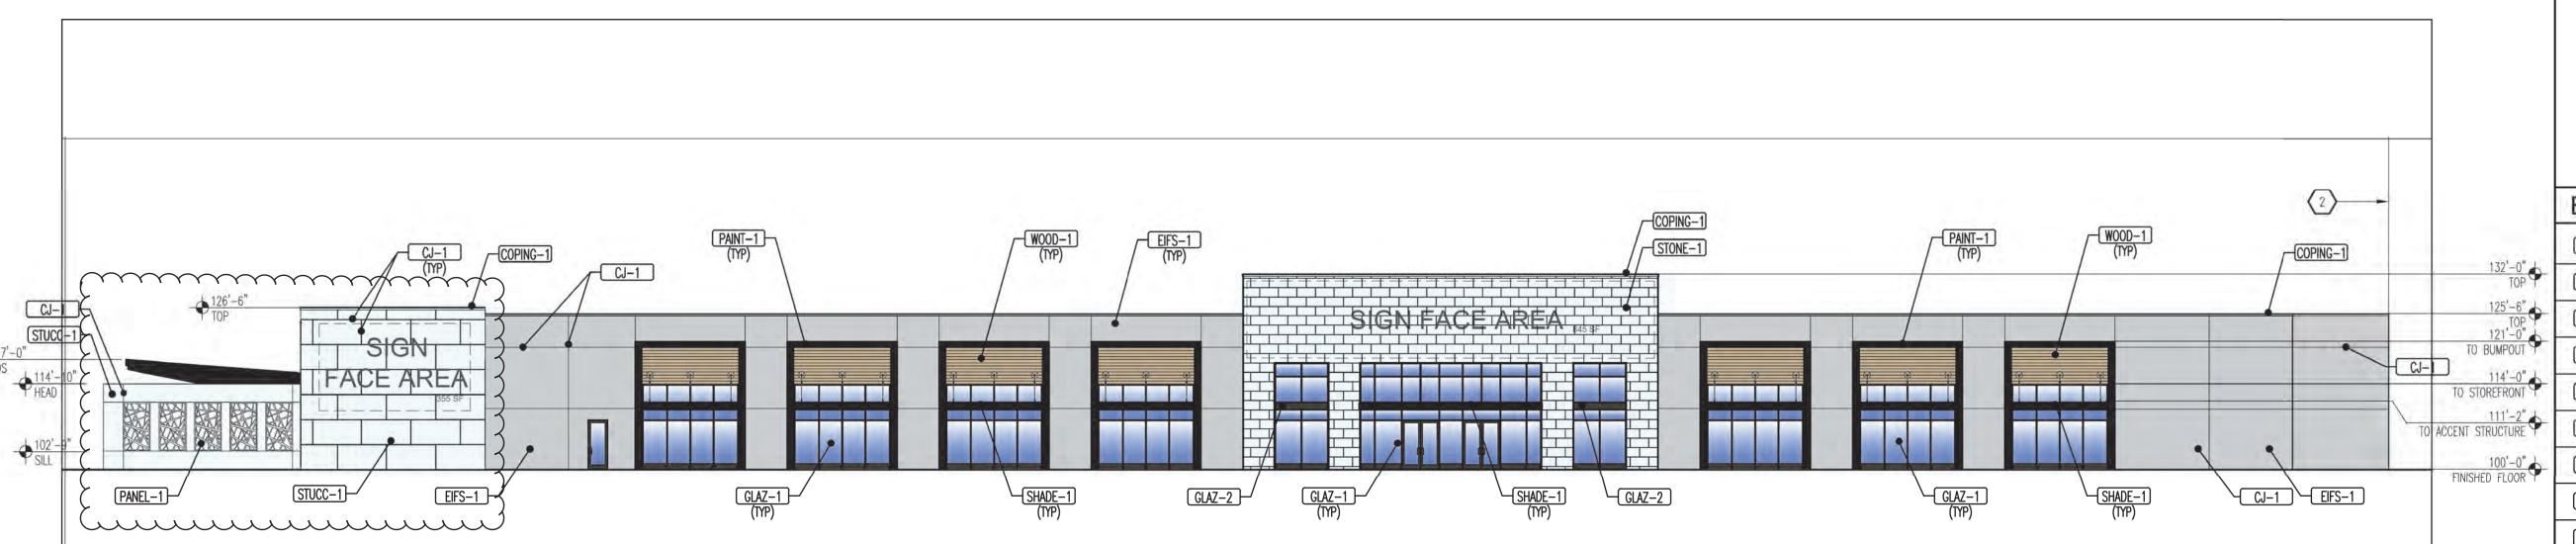


WEST ELEVATION

SCALE: 1/16" = 1'-0"

		RIES SHEETS APPLY TO THE ENTIRE SET OF DRAWINGS. ED ELEVATIONS ARE BASED ON A FINISHED FLOOR OF 100'-0".					
			REVISION				
			DATE RV	+		<u> </u>	
	⟨ KE⟩	/ED NOTES		3		$\Box$	
-6" TOP  1-0"  ND)  1-0"  TOS  1-6"  TOW  TOW  FLOOR	1. LOADING 2. LINE INDI	DOCK CATES ADJACENT BUILDING.	NEW	MODULUS ARCHITECTS	7	ALBUQUERQUE, NEW MEXICO 87113	PHONE (505) 338-1499 FAX (505) 338-1498
2'-0" TOP TOP POUT POUT POUT PURE PUBLICATION TOP LOOK	EXTEI  EIFS-1  FENCE-1  WOOD-1  STUCC-1  GLAZ-1  GLAZ-2  SHADE-1	EXTERIOR INSULATED FINISH SYSTEM COLOR - SHERWIN WILLIAMS SW#7662 EVENING SHADOW  FENCE COLOR- TO BE DETERMINED BY OWNER  LONGBOARD PRODUCTS EXTRUDED ALUMINUM TONGUE & GROOVE PLAN CLADDING- DARK NATIONAL WALNUT 2-COAT STUCCO SYSTEM COLOR- SHERWIN WILLIAMS SW#7005 PURE WHITE ALUMINUM STOREFRONT SYSTEM WITH CLEAR LOW-E GLASS FRAME COLOR: ANODIZED BRONZE  SPANDREL GLASS  2×14 TS ACCENT STRUCTURE: PAINT FINISH COLOR - SHERWIN WILLIAMS SW#6258 TRICON BLACK		MERCHANT STORE 2100 CARLISLE BLVD. NE	ACC, INCH MICAICO OVI	PR-2019-002677	SHEET TITE ELEVATIONS
LUUR T	CJ-1  PANEL-1  PAINT-1  CMU-1	1/2" ALUMINUM REVEAL SCHLUTER EXTRUDED ALUMINUM REVEAL 1/4" THICK GALVANIZED SCREENING PANEL PARASOLEIL PANEL SCREEN SYSTEM, GOTHAM PATTERN; OR APPROVED EQUAL PAINT FINISH COLOR — SHERWIN WILLIAMS SW#6258 TRICORN BLACK EXISTING CMU	- Ⅱ	TE: ) Dec 202	22	Devin Nguyen	
	CMU-2	PAINT COLOR - SHERWIN WILLIAMS SW#7662 EVENING SHADOW  CMU PAINT COLOR - SHERWIN WILLIAMS SW#7662 EVENING SHADOW		ale: <b>AS NOTED</b>		of-	<b>∪</b> Ι

GENERAL NOTES

A. "G" SERIES SHEETS APPLY TO THE ENTIRE SET OF DRAWINGS.

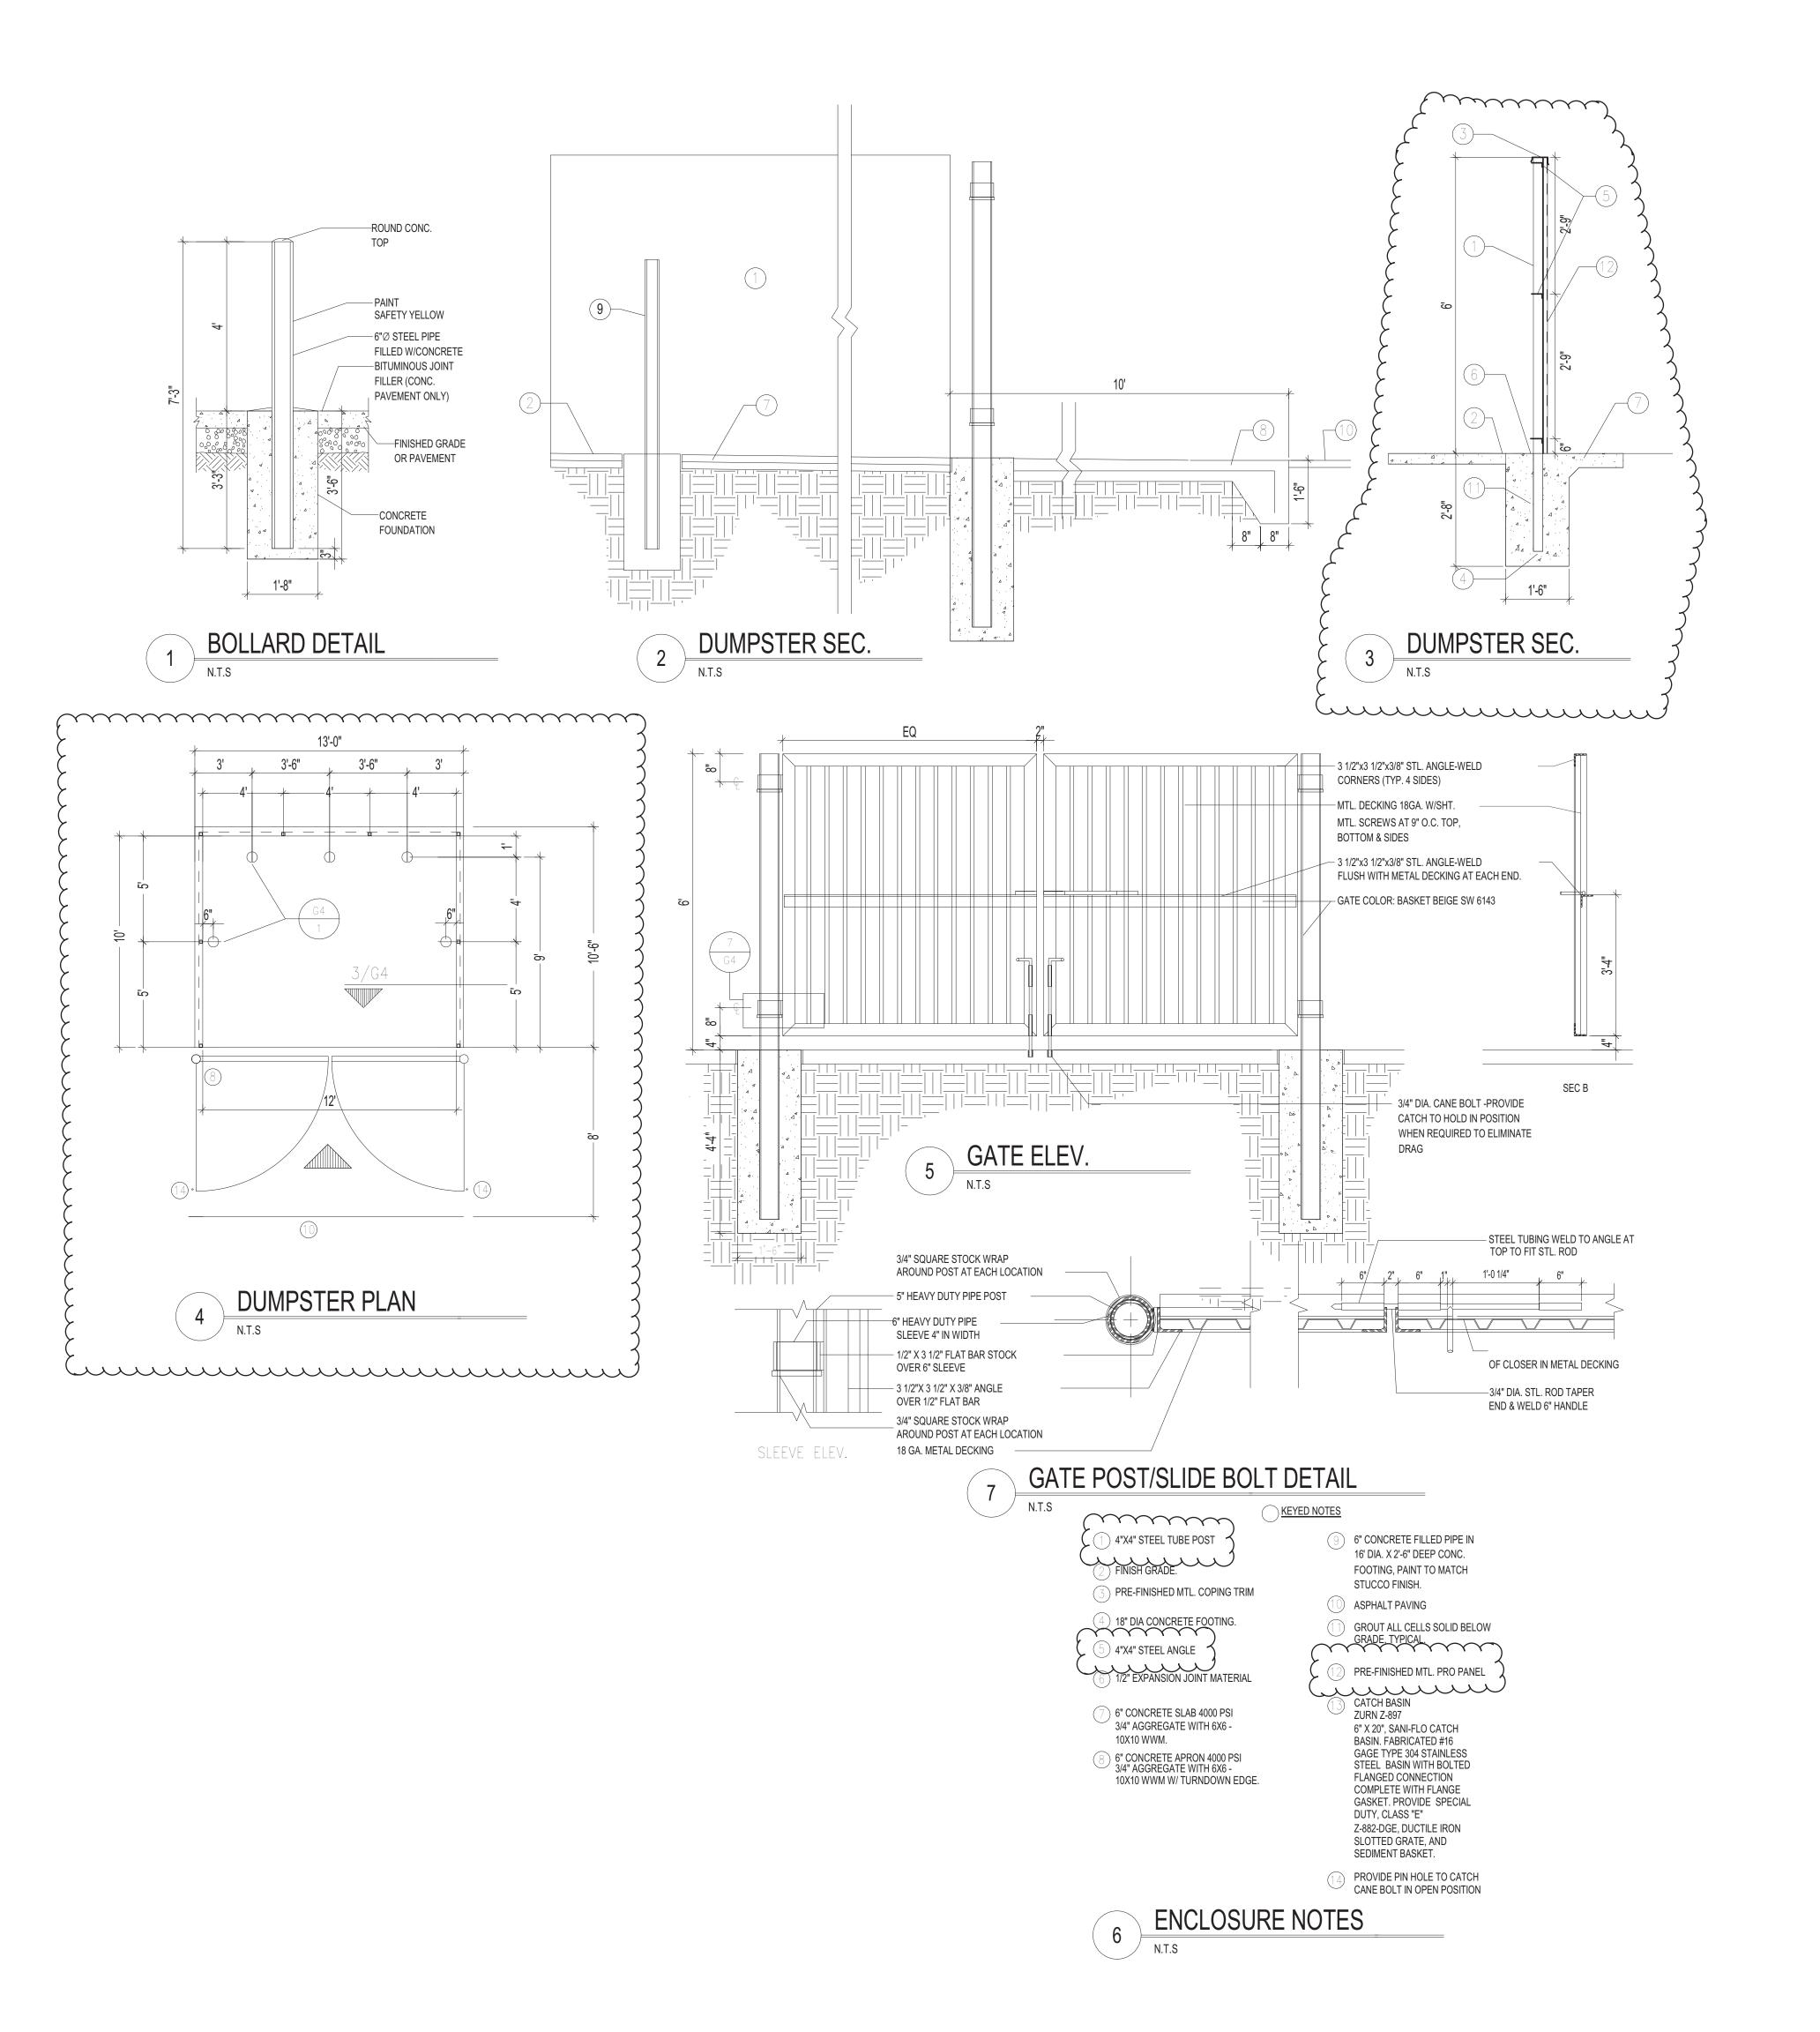

# CONSTRUC


URNITURE HOM DATE

SCALE:

STEPHENA. DUNBAN

**DETAIL** LYPIC.

SITE Issue Date

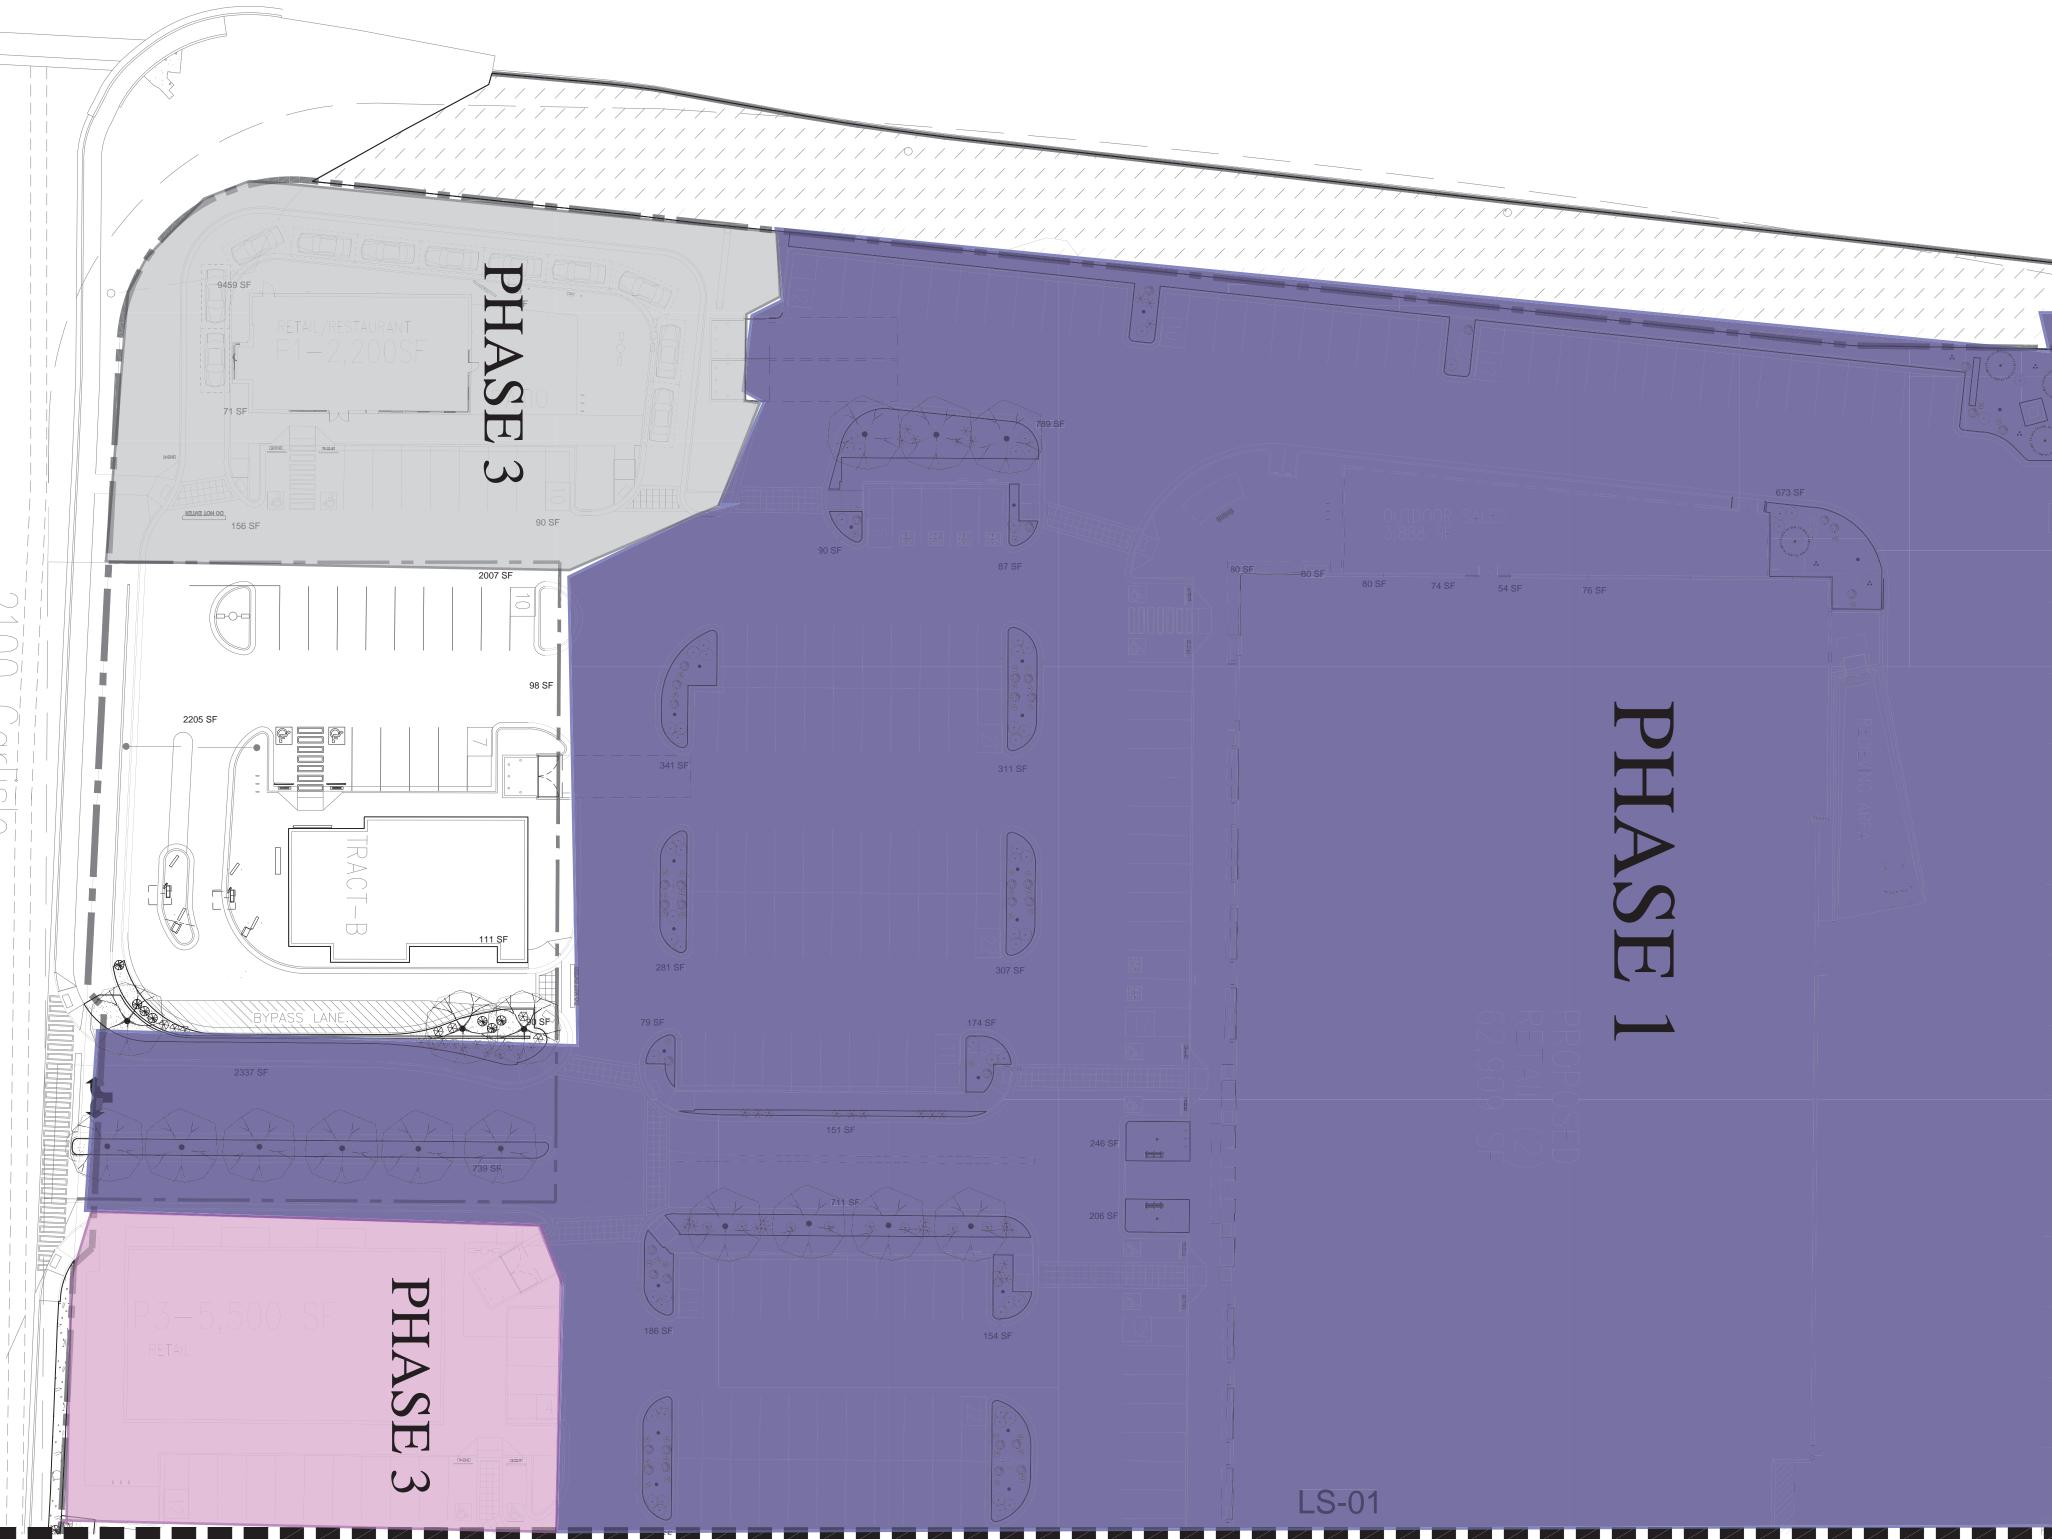

### GENERAL NOTES

1. MAINTENANCE OF THE LANDSCAPE AND IRRIGATION PROVIDED BY THE PROPERTY OWNER.

2. LANDSCAPE AREAS SHALL BE DEPRESSED TO PROVIDE POSITIVE DRAINAGE FOR SITE RUN OFF. SEE CIVIL DRAWINGS FOR DRAINAGE INFORMATION AND PLACEMENT OF CURB CUTS.

3. THE LANDSCAPE PLAN IS DESIGNED TO MEET ALL CITY OF ALBUQUERQUE, AND IDO REQUIREMENTS.

4. PLANT MATERIALS AND SIGNING WILL NOT INTERFERE WITH CLEAR SIGHT REQUIREMENTS. THEREFORE SIGNS, WALLS, TREES, AND SHRUBBERY BETWEEN 3 AND 8 FEET TALL (AS MEASURED FROM THE GUTTER PAN) ARE NOT ACCEPTABLE IN 'CLEAR SIGHT' AREAS.

5. THE LANDSCAPE PLAN IS DESIGNED TO COMPLY WITH THE GENERAL IDO LANDSCAPING REGULATIONS(section 14-16-5-6) INCLUDING PROVISION OF A MINIMUM OF 75% LIVE GROUND COVERAGE, MEASURED AT MATURITY, OF ALL REQUIRED LANDSCAPE AREAS, AND A MINIMUM OF 25% REQUIRED VEGETATIVE COVERAGE OF GROUND LEVEL PLANTS. 5-6(C)(4)(h) SHADE TREES ARE TO BE PLANTED APPROXIMATELY 25' O.C. ALONG ALL REQUIRED PEDESTRIAN

WALKWAYS. 5-6(C)(5) IN REGARDS TO A MAXIMUM OF 75% OF GRAVEL OF ANY OUTDOOR SPACE AND ORGANIC MULCH SUCH AS BARK MULCH SURROUNDING VEGETATION ROOT BALLS AND BENEATH THE ENTIRE TREE CANOPY OR DRIPLINE.

# PLANTINGS NOTES

1. THE LANDSCAPE DESIGN SHALL COMPLY WITH THE CITY OF ALBUQUERQUE WASTE WATER CONSERVATION, LANDSCAPE, IDO, AND WATER WASTE ORDINANCE..

2. THERE IS NO NEW TURF USED IN THE DESIGN OF THE LANDSCAPE. 3.THE R.O.W. (WHEN DEDICATED TO THE PUBLIC) SHALL BE MAINTAINED BY THE PROPERTY OWNER. THE PLAN SHALL FOLLOW THE COA DESIGN GUIDELINES FOR STREET TREES UNLESS OBSTRUCTED BY UTILITY EASEMENTS. 4. ALL LANDSCAPE AREAS SHALL BE COVERED WITH MULCH. USE GRAVEL MULCH AT 3" DEPTH OVER FILTER FABRIC.

5. WHERE MULCH IS ADJACENT TO THE CONCRETE, FINISH GRADE OF MULCH SHALL BE APPROXIMATELY 1/2" BELOW THE TOP OF CONCRETE.

# SITE DATA

\_\_\_\_419,918.4 SF GROSS LOT AREA (4.03 ACRES) LESS BUILDING(S) \_\_\_\_\_107,799 SF NET LOT AREA 312,119.4 SF REQUIRED LANDSCAPE <u>46,818</u> SF 15% OF NET LOT AREA

<u>34,639</u> SF PROPOSED LANDSCAPE PROPOSED OFFSITE LANDSCAPE \_\_\_\_\_924 SF \_\_\_\_\_18,084 SF ROW EXISTING LANDSCAPE \_\_\_\_53,647 SF TOTAL PROPOSED LANDSCAPE PERCENT OF NET LOT AREA


REQUIRED STREET TREES PROVIDED/EXISTING AT 25' O.C. SPACING ALONG STREET 34 REQUIRED PARKING LOT TREES PROVIDED AT 1 PER 10 SPACES (430 SPACES/10) 108\*\* TOTAL REQUIRED TREES: 77 TOTAL PROVIDED TREES: 142

\*\*(tree provided per parking space quantity is due to IDO ordinance to provide 1 shade tree 25' O.C. along any pedestrian walkway)

REQUIRED LANDSCAPE COVERAGE

75% LIVE VEGETATIVE MATERIAL (46,818 SF REQUIRED LANDSCAPE X 75%) 35,114 SF MIN. PROVIDED GROUNDCOVER COVERAGE 35,170 SF (EXCLUDES EXISTING ROW LANDSCAPE) (1,436 SF) PERCENT GROUNDCOVER COVERAGE OF REQUIRED LANDSCAPE AREAS 75%

LS-02

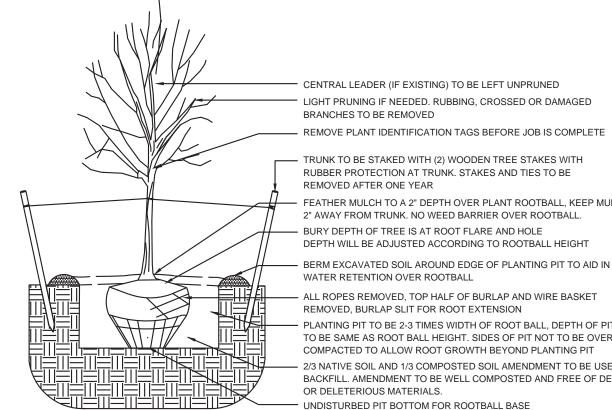

TREE PLANTING DETAIL

TRUNK TO BE STAKED WITH (2) WOODEN TREE STAKES WITH RUBBER PROTECTION AT TRUNK. STAKES AND TIES TO BE FEATHER MULCH TO A 2" DEPTH OVER PLANT ROOTBALL, KEEP MULCH 2" AWAY FROM TRUNK. NO WEED BARRIER OVER ROOTBALL. - BURY DEPTH OF TREE IS AT ROOT FLARE AND HOLE DEPTH WILL BE ADJUSTED ACCORDING TO ROOTBALL HEIGHT - BERM EXCAVATED SOIL AROUND EDGE OF PLANTING PIT TO AID IN WATER RETENTION OVER ROOTBALL – ALL ROPES REMOVED, TOP HALF OF BURLAP AND WIRE BASKET

REMOVED, BURLAP SLIT FOR ROOT EXTENSION PLANTING PIT TO BE 2-3 TIMES WIDTH OF ROOT BALL, DEPTH OF PIT TO BE SAME AS ROOT BALL HEIGHT. SIDES OF PIT NOT TO BE OVERLY COMPACTED TO ALLOW ROOT GROWTH BEYOND PLANTING PIT - 2/3 NATIVE SOIL AND 1/3 COMPOSTED SOIL AMENDMENT TO BE USED AS BACKFILL. AMENDMENT TO BE WELL COMPOSTED AND FREE OF DEBRIS OR DELETERIOUS MATERIALS. — UNDISTURBED PIT BOTTOM FOR ROOTBALL BASE

# PLANT SCHEDULE SITE 01.10.2022

	PLANT SCHEDULE	01.10.2022		
	DECIDUOUS TREES	QTY	BOTANICAL / COMMON NAME	SIZE
		8	CHILOPSIS LINEARIS / DESERT WILLOW	15 gal
		22	PISTACIA CHINENSIS / CHINESE PISTACHE	2" B&B
		54	PYRUS CALLERYANA `CLEVELAND SELECT` / CLEVELAND SELECT PEAR	2" B&B
		41	ULMUS CHINENSIS 'ALLEE' / ALLEE ELM	2" B&B
***		10	VITEX AGNUS-CASTUS / CHASTE TREE	15 gal
	EVERGREEN TREES	QTY	BOTANICAL / COMMON NAME	SIZE
	April 1 Mark	7	PINUS LEUCODERMIS / BOSNIAN PINE	6`
	DESERT ACCENTS	QTY	BOTANICAL / COMMON NAME	SIZE
	( <u>.</u> )	70	HESPERALOE PARVIFLORA / RED YUCCA	5 GAL
	<b>(</b> ♣)	14	NOLINA MICROCARPA / BEARGRASS	5 GAL
	GRASSES	QTY	BOTANICAL / COMMON NAME	SIZE
		137	CALAMAGROSTIS X ACUTIFLORA `KARL FOERSTER` / FEATHER REED GRASS	1 GAL
	VINE/ESPALIER	QTY	BOTANICAL / COMMON NAME	SIZE
•	J.	36	LONICERA JAPONICA 'HALLIANA' / HALLS HONEYSUCKLE FLOWERING VINE	1 GAL
<b>)</b>	ECIDUOUS SHRUBS	QTY	BOTANICAL / COMMON NAME	SIZE
<b>)</b>		117	CARYOPTERIS X CLANDONENSIS `DARK KNIGHT` / BLUE MIST SPIREA	1 GAL
Ì		153	RHUS AROMATICA `GRO-LOW` / GRO-LOW FRAGRANT SUMAC	5 GAL
(	RGREEN SHRUBS	QTY	BOTANICAL / COMMON NAME	SIZE
		89	BACCHARIS X 'STARN' / STARN COYOTE BRUSH	5 GAL

MATERIAL SCHEDULE

Amaretto 5/8"-1 1/4" Gravel 3" Depth over Filter Fabric (landscape area in ROW)

Amaretto 5/8 - 1 1/4" Gravel 3" Depth over Filter Fabric

2-4" Mountainair Blush Cobble 4" Depth over Filter Fabric

DOT EXISTING - GRAVEL AND LANDSCAPE

21( Albuqu

www.yellowstonelandscape.com PO Box 10597


Albuquerque, NM 87184 505.898.9615 design@yellowstonelandscape.com


Date: 01/06/2023

Revisions:

Drawn by: HA

Reviewed by: <u>CM</u>

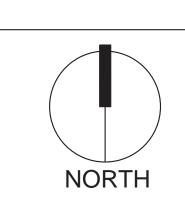

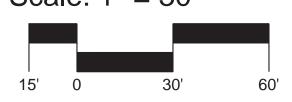

Sheet Title:

REMOVE PLANT IDENTIFICATION TAGS BEFORE JOB IS COMPLETE

SET SHRUB ON UNDISTURBED PIT BOTTOM PLUMB AND STRAIGHT

BERM REMOVED SOIL AT EDGE OF PLANTING PIT TO AID IN

IF EXCESSIVE ROOTS ARE PRESENT ON ROOTBALL SCORE THE

SIDES OF ROOTBALL TO DISCOURAGE ROOT CIRCLING

WATER RETENTION OVER ROOTBALL

OR DELETERIOUS MATERIALS.

FEATHER MULCH TO A 2" DEPTH OVER PLANT ROOTBALL, KEEP MULCH

2" AWAY FROM CENTER OF SHRUB. NO WEED BARRIER OVER ROOTBALL.

2/3 NATIVE SOIL AND 1/3 COMPOSTED SOIL AMENDMENT TO BE USED AS


BACKFILL. AMENDMENT TO BE WELL COMPOSTED AND FREE OF DEBRIS

Landscape Plan

Sheet Number:

SHRUB PLANTING DETAIL

CONTAINER DIA. +12"

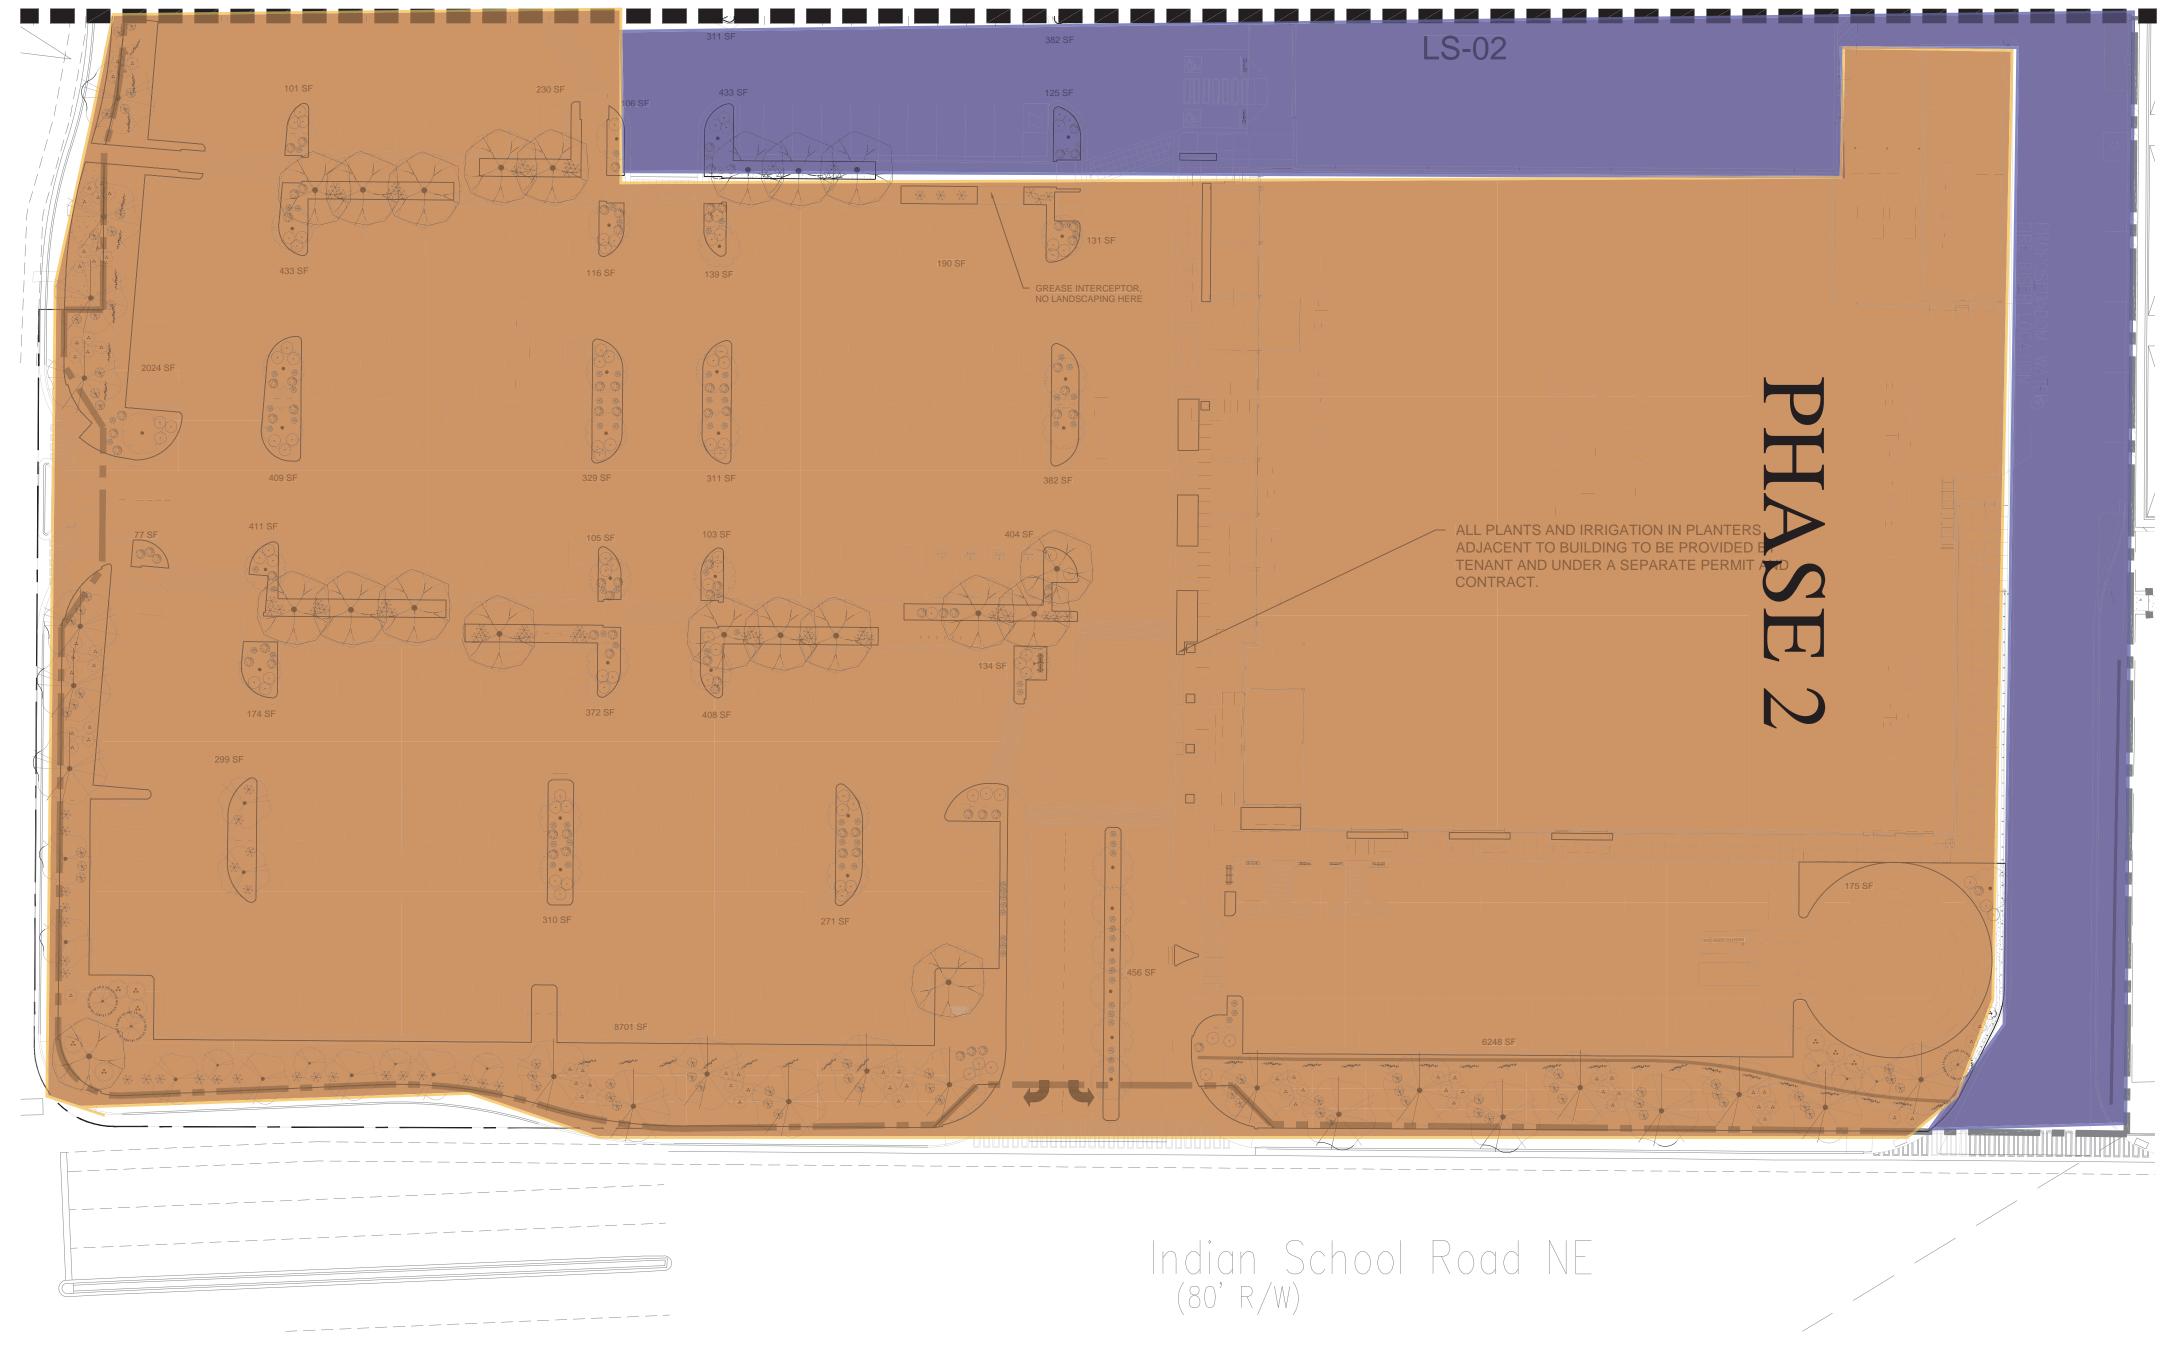

		I LANT GOTTLEGEL	- 0116	01.10.2022	
		DECIDUOUS TREES	QTY	BOTANICAL / COMMON NAME	SIZE
,	<del>(</del>		8	CHILOPSIS LINEARIS / DESERT WILLOW	15 gal
-			22	PISTACIA CHINENSIS / CHINESE PISTACHE	2" B&E
١			54	PYRUS CALLERYANA `CLEVELAND SELECT` / CLEVELAND SELECT PEAR	2" B&E
			41	ULMUS CHINENSIS 'ALLEE' / ALLEE ELM	2" B&E
	-		10	VITEX AGNUS-CASTUS / CHASTE TREE	15 gal
-		EVERGREEN TREES	QTY	BOTANICAL / COMMON NAME	SIZE
-		The state of the s	7	PINUS LEUCODERMIS / BOSNIAN PINE	6`
		DESERT ACCENTS	QTY	BOTANICAL / COMMON NAME	SIZE
			70	HESPERALOE PARVIFLORA / RED YUCCA	5 GAL
/			14	NOLINA MICROCARPA / BEARGRASS	5 GAL
		GRASSES	QTY	BOTANICAL / COMMON NAME	SIZE
			137	CALAMAGROSTIS X ACUTIFLORA `KARL FOERSTER` / FEATHER REED GRASS	1 GAL
		VINE/ESPALIER	QTY	BOTANICAL / COMMON NAME	SIZE
		- magalligate for	36	LONICERA JAPONICA `HALLIANA` / HALLS HONEYSUCKLE FLOWERING VINE	1 GAL
		DECIDUOUS SHRUBS	QTY	BOTANICAL / COMMON NAME	SIZE
			117	CARYOPTERIS X CLANDONENSIS `DARK KNIGHT` / BLUE MIST SPIREA	1 GAL
		$\odot$	153	RHUS AROMATICA `GRO-LOW` / GRO-LOW FRAGRANT SUMAC	5 GAL
		EVERGREEN SHRUBS	QTY	BOTANICAL / COMMON NAME	SIZE
			89	BACCHARIS X 'STARN' / STARN COYOTE BRUSH	5 GAL
		$\bigotimes$	150	ROSMARINUS OFFICINALIS / ROSEMARY	1 GAL

### MATERIAL SCHEDULE

Amaretto 5/8"-1 1/4" Gravel 3" Depth over Filter Fabric (landscape area in ROW)

> Amaretto 5/8 - 1 1/4" Gravel 3" Depth over Filter Fabric

PLANT SCHEDULE SITE 01.10.2022

2-4" Mountainair Blush Cobble 4" Depth over Filter Fabric

DOT EXISTING - GRAVEL AND LANDSCAPE

### GENERAL NOTES

1. MAINTENANCE OF THE LANDSCAPE AND IRRIGATION PROVIDED BY THE PROPERTY OWNER.

2. LANDSCAPE AREAS SHALL BE DEPRESSED TO PROVIDE POSITIVE DRAINAGE FOR SITE RUN OFF. SEE CIVIL DRAWINGS FOR DRAINAGE INFORMATION AND PLACEMENT OF CURB CUTS.

3. THE LANDSCAPE PLAN IS DESIGNED TO MEET ALL CITY OF ALBUQUERQUE, AND IDO REQUIREMENTS.

4. PLANT MATERIALS AND SIGNING WILL NOT INTERFERE WITH CLEAR SIGHT REQUIREMENTS. THEREFORE SIGNS, WALLS, TREES, AND SHRUBBERY BETWEEN 3 AND 8 FEET TALL (AS MEASURED FROM THE GUTTER PAN) ARE NOT

ACCEPTABLE IN 'CLEAR SIGHT' AREAS. 5. THE LANDSCAPE PLAN IS DESIGNED TO COMPLY WITH THE GENERAL IDO LANDSCAPING REGULATIONS(section 14-16-5-6) INCLUDING PROVISION OF A MINIMUM OF 75% LIVE GROUND COVERAGE, MEASURED AT MATURITY, OF ALL REQUIRED LANDSCAPE AREAS, AND A MINIMUM OF 25% REQUIRED VEGETATIVE COVERAGE OF GROUND LEVEL PLANTS. 5-6(C)(4)(h) SHADE TREES ARE TO BE PLANTED APPROXIMATELY 25' O.C. ALONG ALL REQUIRED PEDESTRIAN WALKWAYS.

5-6(C)(5) IN REGARDS TO A MAXIMUM OF 75% OF GRAVEL OF ANY OUTDOOR SPACE AND ORGANIC MULCH SUCH AS BARK MULCH SURROUNDING VEGETATION ROOT BALLS AND BENEATH THE ENTIRE TREE CANOPY OR DRIPLINE.

# PLANTINGS NOTES

1. THE LANDSCAPE DESIGN SHALL COMPLY WITH THE CITY OF ALBUQUERQUE WASTE WATER CONSERVATION, LANDSCAPE, IDO, AND WATER WASTE ORDINANCE..

2. THERE IS NO NEW TURF USED IN THE DESIGN OF THE LANDSCAPE. 3.THE R.O.W. (WHEN DEDICATED TO THE PUBLIC) SHALL BE MAINTAINED BY THE PROPERTY OWNER. THE PLAN SHALL FOLLOW THE COA DESIGN GUIDELINES FOR STREET TREES UNLESS OBSTRUCTED BY UTILITY EASEMENTS. 4. ALL LANDSCAPE AREAS SHALL BE COVERED WITH MULCH. USE GRAVEL MULCH AT 3" DEPTH OVER FILTER FABRIC.

5. WHERE MULCH IS ADJACENT TO THE CONCRETE, FINISH GRADE OF MULCH SHALL BE APPROXIMATELY 1/2" BELOW THE TOP OF CONCRETE.

# SITE DATA

ROW EXISTING LANDSCAPE

TOTAL PROPOSED LANDSCAPE

PERCENT OF NET LOT AREA

<u>419,918.4</u> SF GROSS LOT AREA (4.03 ACRES) LESS BUILDING(S) 107,799 SF NET LOT AREA 312,119.4 SF REQUIRED LANDSCAPE 15% OF NET LOT AREA <u>46,818</u> SF \_\_\_\_34,639 SF PROPOSED LANDSCAPE PROPOSED OFFSITE LANDSCAPE <u>924</u> SF

REQUIRED STREET TREES PROVIDED/EXISTING AT 25' O.C. SPACING ALONG STREET 34 REQUIRED PARKING LOT TREES PROVIDED AT 1 PER 10 SPACES (430 SPACES/10) 108\*\* TOTAL REQUIRED TREES: 77


\_\_\_\_\_18,084 SF

\_\_\_\_53,647 SF

TOTAL PROVIDED TREES: 142 \*\*(tree provided per parking space quantity is due to IDO ordinance to provide 1 shade tree 25' O.C. along any pedestrian walkway)

### REQUIRED LANDSCAPE COVERAGE

75% LIVE VEGETATIVE MATERIAL (46,818 SF REQUIRED LANDSCAPE X 75%) 35,114 SF MIN. PROVIDED GROUNDCOVER COVERAGE 35,170 SF (EXCLUDES EXISTING ROW LANDSCAPE) (1,436 SF) PERCENT GROUNDCOVER COVERAGE OF REQUIRED LANDSCAPE AREAS 75%

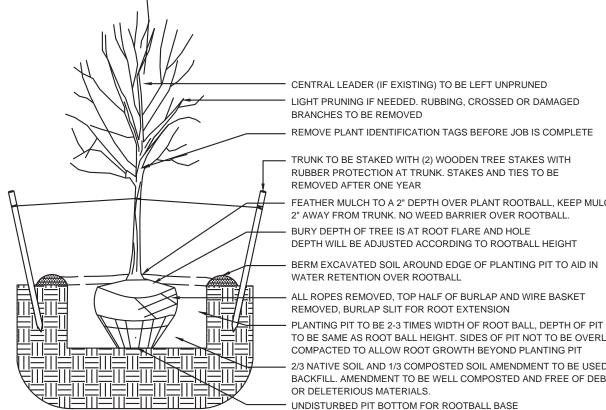

CENTRAL LEADER (IF EXISTING) TO BE LEFT UNPRUNED LIGHT PRUNING IF NEEDED. RUBBING, CROSSED OR DAMAGED BRANCHES TO BE REMOVED - REMOVE PLANT IDENTIFICATION TAGS BEFORE JOB IS COMPLETE


## - TRUNK TO BE STAKED WITH (2) WOODEN TREE STAKES WITH

RUBBER PROTECTION AT TRUNK. STAKES AND TIES TO BE REMOVED AFTER ONE YEAR FEATHER MULCH TO A 2" DEPTH OVER PLANT ROOTBALL, KEEP MULCH 2" AWAY FROM TRUNK. NO WEED BARRIER OVER ROOTBALL. - BURY DEPTH OF TREE IS AT ROOT FLARE AND HOLE DEPTH WILL BE ADJUSTED ACCORDING TO ROOTBALL HEIGHT

WATER RETENTION OVER ROOTBALL - ALL ROPES REMOVED, TOP HALF OF BURLAP AND WIRE BASKET REMOVED. BURLAP SLIT FOR ROOT EXTENSION PLANTING PIT TO BE 2-3 TIMES WIDTH OF ROOT BALL, DEPTH OF PIT

TO BE SAME AS ROOT BALL HEIGHT. SIDES OF PIT NOT TO BE OVERLY COMPACTED TO ALLOW ROOT GROWTH BEYOND PLANTING PIT 2/3 NATIVE SOIL AND 1/3 COMPOSTED SOIL AMENDMENT TO BE USED AS BACKFILL. AMENDMENT TO BE WELL COMPOSTED AND FREE OF DEBRIS OR DELETERIOUS MATERIALS. UNDISTURBED PIT BOTTOM FOR ROOTBALL BASE

TREE PLANTING DETAIL

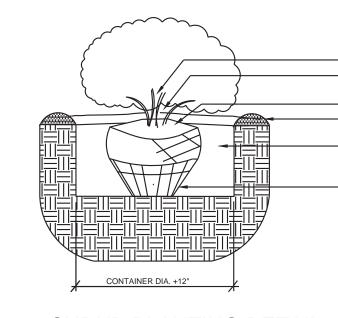

REMOVE PLANT IDENTIFICATION TAGS BEFORE JOB IS COMPLETE FEATHER MULCH TO A 2" DEPTH OVER PLANT ROOTBALL, KEEP MULCH 2" AWAY FROM CENTER OF SHRUB. NO WEED BARRIER OVER ROOTBALL. SET SHRUB ON UNDISTURBED PIT BOTTOM PLUMB AND STRAIGHT BERM REMOVED SOIL AT EDGE OF PLANTING PIT TO AID IN WATER RETENTION OVER ROOTBALL 2/3 NATIVE SOIL AND 1/3 COMPOSTED SOIL AMENDMENT TO BE USED AS

BACKFILL. AMENDMENT TO BE WELL COMPOSTED AND FREE OF DEBRIS OR DELETERIOUS MATERIALS. IF EXCESSIVE ROOTS ARE PRESENT ON ROOTBALL SCORE THE

SIDES OF ROOTBALL TO DISCOURAGE ROOT CIRCLING Sheet Number:

SHRUB PLANTING DETAIL


www.yellowstonelandscape.com PO Box 10597 Albuquerque, NM 87184 505.898.9615 design@yellowstonelandscape.com


Date: 01/06/2023

Revisions:

Drawn by: HA

Reviewed by: <u>CM</u>

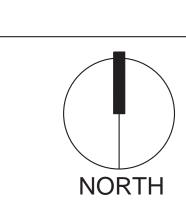

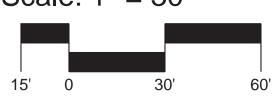

Sheet Title:

Landscape Plan

