

ADDRESS:

PROJECT INFORMATION

2803, 2807 & 2813 SAN MATEO BLVD. **ALBUQUERQUE. NM 87110** (FINAL ADDRESS ASSIGNMENT T.B.D UPON COMPLETION OF PLAT BY OTHERS)

1 INCH = 20 FT.

LEGAL DESCRIPTION:

LOTS NUMBERED EIGHT (8), NINE (9), AND TEN (10) IN BLOCK NUMBERED TWO (2) OF THE PLAT OF BLOCKS 1-44 INCLUSIVE OF BEL-AIR, A SUBDIVISION OF A TRACT OF LAND IN SCHOOL DISTRICTS NUMBERS 13 AND 22, BERNALILLO COUNTY, NEW MEXICO, AS THE SAME IS SHOWN AND DESIGNATED ON THE MAP OF SAID SUBDIVISION, FILED IN THE OFFICE OF THE COUNTY CLERK OF BERNALILLO COUNTY, NEW MEXICO, ON JANUARY 31.

SITE ACREAGE:

FORMER LOTS 8, 9, 10: 0.18 ACRES, 0.17 ACRES, 0.20 ACRES PROPOSED SITE: 0.55 ACRES

PLANNING INFORMATION:

ZONE ATLAS PAGE H-17 LAND USE ZONING IS C-1

PARKING SUMMARY:

AUTOMOBILE PARKING SPACES (1/200 SF)* = 35 ADA SPACES (1 PER 25 AUTOMOBILE SPACES) **MOTORCYCLE PARKING SPACES (4'X18' MIN)** = 2 **BICYCLE PARKING** = 2

PROVIDED STANDARD SPACES = 26 ADA HANDICAP STANDARD SPACES = 1 ADA HANDICAP VAN ACCESSIBLE SPACES = 1 **TOTAL AUTOMOBILE SPACES*** = 28 **MOTORCYCLE PARKING SPACES 4.5'X18'** = 2

*SEE APPROVED VARIANCE 15ZHE-80127 BELOW

APPROVED VARIANCES:


BICYCLE PARKING

15ZHE-80124: REMOVAL OF WEST 10' LANDSCAPE BUFFER 15ZHE-80126: REMOVAL OF NORTH 6' LANDSCAPE BUFFER 15ZHE-80127: REDUCTION OF REQUIRED PARKING SPACES TO 28

= 2

LEGEND

PROPOSED RETAINING WALL
PROPOSED EASEMENT
PROPERTY LINE
PROPOSED BUILDING
PROPOSED SIGN
PARKING COUNT
EXISTING CURB AND GUTTER
PROPOSED 6" STANDARD CURB AND GUTTER
EXISTING SITE LIGHTING
PROPOSED SITE LIGHTING
PROPOSED CONCRETE WALK (SEE DETAIL SHEET C1.3)
PROPOSED INLET
PROPOSED 4' STORM MANHOLE
EXISTING SANITARY/STORM MANHOLE
DENOTES TRAFFIC FLOW PATTERNS (NO ACTUAL STRIPING)

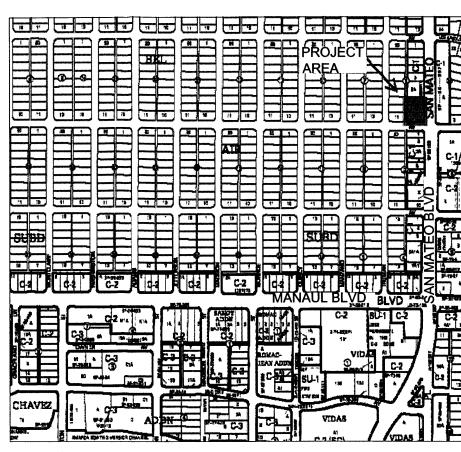

ZONE H-17 VICINITY MAP

NOT TO SCALE

SITE SCHEDULE


- PROPOSED 1' SAWCUT OFFSET FROM PROPOSED
- $(\ 2\)$ PROPOSED STANDARD 6" CURB AND GUTTER PER COA STANDARD DRAWING 2415A MODIFIED TO A 1' GUTTER PAN.
- (3) PROPOSED 6' VALLEY GUTTER PER COA STANDARD DRAWING 2420 AND 2426.
- $(ext{ 4 })$ hatched area to represent loading area location FOR SITE PLAN REVIEW PURPOSES ONLY. NO ACTUAL STRIPING
- (5) PROPOSED 10'X1.5' SOLID WHITE STOP BAR.
- (6) PROPOSED ADA RAMP
- (7) PROPOSED ADA STANDARD HANDICAP PARKING
- (8) PROPOSED TACTILE WARNING PANEL 2'X17' AND 2'X8'.
- (9) SCREENED AREA DEFINES ADA COMPLIANT ZONE OF ACCESSIBILITY FROM BUILDING FRONT ENTRANCE TO HANDICAP PARKING STALLS. CROSS SLOPES NOT TO **EXCEED 2% IN ALL DIRECTIONS.**
- (10) PROPOSED TRASH ENCLOSURE W/6' SCREEN WALL
- (11) PROPOSED FIRE LANE STRIPING. SEE NOTE 14 ON THIS SHEET.
- PROPOSED 6" DEPRESSED CURB AND GUTTER PER COA STANDARD DRAWING 2415A MODIFIED TO HAVE 2% CROSS FALL ACROSS GUTTER TOWARDS PARKING LOT.
- (13) PROPOSED PYLON SIGN PANEL. REFER TO ARCH. SIGNAGE PLANS FOR DETAIL.
- (14) PROPOSED CONCRETE WALK.
- (15) PROPOSED RETAINING WALL AND SCREENING FENCE. MAXIMUM HEIGHT OF RETAINING WALL 3', MAX. COMBINED HEIGHT OF WALL AND FENCE 6' (293' LONG).
- (16) EXISTING LIGHT POLE TO BE RELOCATED OUTSIDE OF THE DRIVEWAY CUT BY THE CONTRACTOR.
- (17) PROPOSED 2' CONCRETE ALLEY GUTTER PER COA STANDARD DRAWING 2415A.
- (18) PROPOSED MOTORCYCLE PARKING STALL (4.5'X18').
- (19) PROPOSED 4'X5' BIKE RACK STAND. PROVIDES (2) BICYCLE SPACES PER RACK.
- (20) PROPOSED HEAVY DUTY ASPHALT PAVEMENT. SEE PAVEMENT SECTION THIS SHEET.
- (21) PROPOSED LIGHT DUTY ASPHALT PAVEMENT. SEE PAVEMENT SECTION
- (22) PROPOSED RUNDOWN CURB AND GUTTER PER COA STANDARD DRAWING 2415A (2')
- (23) PROPOSED FIRE LANE SIGN.
- (24) PROPOSED ADA VAN HANDICAP PARKING SIGN.
- (25) 10' WIDE 6" 4000 PSI CONCRETE STRIP WITH 6" BY 1" REINFORCEMENT.

PAVEMENT SECTIONS

AUTOMOBILE PARKING AREAS (LIGHT DUTY PAVEMENT) 2 1/2" ASPHALT CONCRETE PAVEMENT (AC) OVER 6" ABC OR 5" PCC PER GEOTECHNICAL REPORT

DRIVE LANES (HEAVY DUTY PAVEMENT) 4" ASPHALT CONCRETE (AC) PAVEMENT OVER 6" ABC OR 5" PCC PER GEOTECHNICAL REPORT

PAVEMENT SECTION PER GEOTECHNICAL REPORT PREPARED BY TERRACON **CONSULTANTS INC. PROJECT NUMBER 66155033** REFER TO GEOTECHNICAL REPORT.

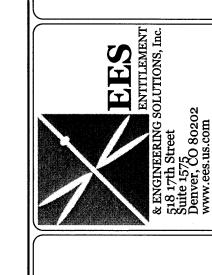

CIRCULATION NC TRAFFIC

PROJECT NO: CAD008.01 DESIGNED BY: DRAWN BY: JDC 06/23/2015

C1.2 SHEET 1 OF 2

1. NO BIKE ROUTES OR PATHS EXIST ALONG FRONTAGE OF SAN MATEO BOULEVARD. 2. ALL CONSTRUCTION SHALL BE PERFORMED IN ACCORDANCE WITH STANDARD SPECIFICATIONS

PROJECT BENCHMARK & VERTICAL DATUM

OF CITY SITE OF ALBUQUERQUE.

3. EMERGENCY AND SERVICE TRUCKS WILL MANEUVER AROUND BUILDING DRIVE AISLES IN A ONE-WAY TRAFFIC MOVEMENT. 4. CARS/TRUCKS WILL MANEUVER AROUND BUILDING DRIVE AISLES IN A TWO-WAY TRAFFIC MOVEMENT.

5. SITE ASSUMES CIRCULATION OF WB-67 SEMI. 6. UPON COMPLETION OF PAVING OPERATIONS THE CONTRACTOR SHALL INSTALL THE PAVEMENT STRIPES AND PAVEMENT MARKINGS AS SHOWN HEREON. ON SITE PARKING STALL STRIPES SHALL BE 4" WIDE AND WHITE IN COLOR. HANDICAP STALL STALLS SHALL BE PAINTED AND SIGNED PER FEDERAL, STATE AND

LOCAL REQUIREMENTS. SEE DETAIL SHEET. 7. HANDICAP PARKING AREAS PROVIDED PER CITY STANDARDS AND SHALL COMPLY WITH REQUIREMENTS OF THE CURRENT ADOPTED UNIFORM BUILDING CODE.

8. UNLESS OTHERWISE NOTED, ALL RADII ON PARKING ISLANDS SHALL BE 3'.

9. CONTRACTOR SHALL REFER TO ARCHITECTURAL PLANS FOR PRECISE BUILDING DIMENSIONS SERVICE AREA DIMENSIONS AND ELEVATIONS. REFERENCE M.E.P. FOR EXACT BUILDING UTILITY ENTRANCE LOCATIONS.

10. THE DISPOSAL OF DEMOLISHED ITEMS SHALL COMPLY TO ALL STATE AND LOCAL REQUIREMENTS. 11. MECHANICAL UNITS, DUMPSTER AND TRASH COMPACTORS SHALL BE SCREENED IN ACCORDANCE WITH THE CITY OF ALBUQUERQUE ZONING ORDINANCE.

12. ALL SIGNAGE CONTINGENT UPON APPROVAL BY THE CITY OF ALBUQUERQUE.

13. ALL SIGNS SHALL BE INSTALLED IN ACCORDANCE WITH THE ZONING ORDINANCE. 14. FIRE LANE STRIPING, "NO PARKING FIRE LANE" MARKING SHALL CONSIST OF A SIX (6) INCH WIDE RED STRIPE ALONG THE CURB ON THE WEST SIDE OF THE BUILDING. THE WORDS "NO PARKING FIRE LANE" SHALL BE MARKED ON THE SIGN IN FOUR (4) INCH HIGH WHITE LETTERS AT 25-FT. MAXIMUM INTERVALS STRIPING AND LETTERS SHALL BE APPLIED ACCORDING TO THE CITY OF ALBUQUERQUE. FIRE LANE AND FIRE PROTECTION MUST BE APPROVED BY THE FIRE MARSHALL PRIOR TO BUILDING PERMIT BEING ISSUED.

CONTRACTOR TO COORDINATE ALL FIRE LANE MARKINGS WITH THE ALBUQUERQUE AND NEW MEXICO DEPARTMENT OF TRANSPORTATION STANDARDS.

15. ALL DRIVEWAYS SHALL BE CONSTRUCTED IN ACCORDANCE WITH CITY OF ALBUQUERQUE AND NEW MEXICO DEPARTMENT OF TRANSPORTATION STANDARDS.


16. ALL DIMENSIONS ARE MEASURED FROM FLOWLINE OF CURB, UNLESS NOTED OTHERWISE.

17. ALL ACCESSIBLE RAMPS SHALL HAVE A MAXIMUM SLOPE OF 12:1.

18. REFER TO PLAT FOR OFFICIAL EASEMENT LOCATIONS.

19. WALLS, LANDSCAPING AND SIGNAGE WILL NOT INTERFERE WITH CLEAR SIGHT REQUIREMENTS; THEREFORE, SIGNS, WALLS, TREES AND SHRUBBERY BETWEEN 3 AND 8 FEET TALL (AS MEASURED FROM THE GUTTER PAN) WILL OT BE ACCEPTABLE IN THIS AREA.

FIRE LANE CURB PAINT

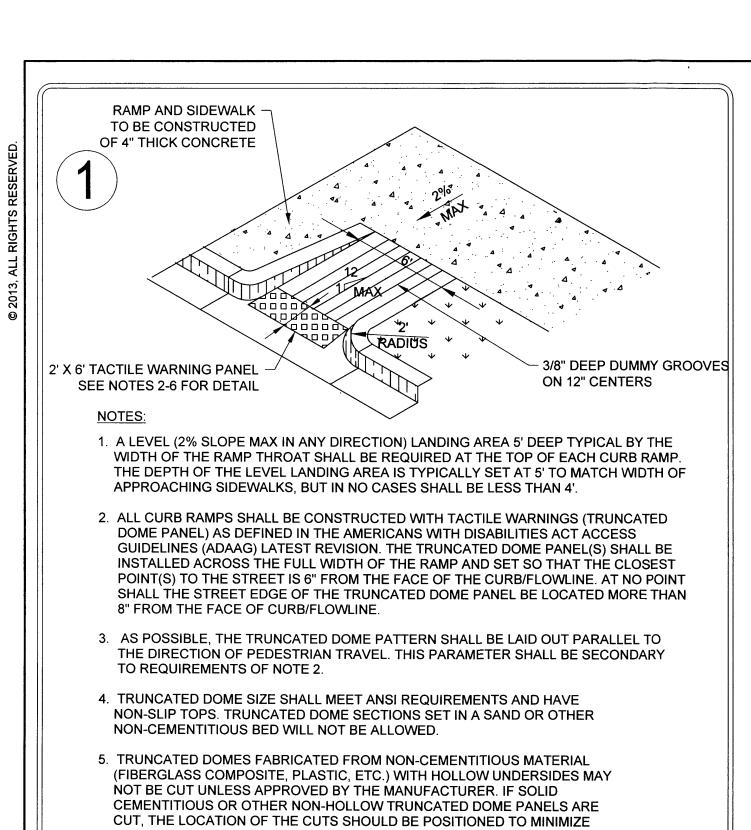

CUTTING THROUGH DOMES. IF DOMES ARE CUT, THE EXPOSED EDGE OF THE PARTIAL DOME MUST BE GROUND TO PROVIDE A SMOOTH, SLOPED

6. ABOVE TRUNCATED DOMES, CURB RAMPS SHALL BE SCORED WITH DUMMY

7. REFER TO COA STANDARD DRAWING 2440 FOR ADA ACCESSIBLE ROUTE

ALIGNED PARALLEL TO THE DIRECTION OF THE RAMP AND STREET CROSSING.


HANDICAP RAMP DETAIL


NOT TO SCALE


GROOVES 3/8" DEEP ON 12" CENTERS. THE GROOVES SHALL BE PLACED IN THE RAMP SECTION ABOVE THE TRUNCATED DOMES AND


TRANSITION TO THE ADJACENT CONCRETE SURFACE.


RAMPS, SLOPES AND RAMP PROFILE.

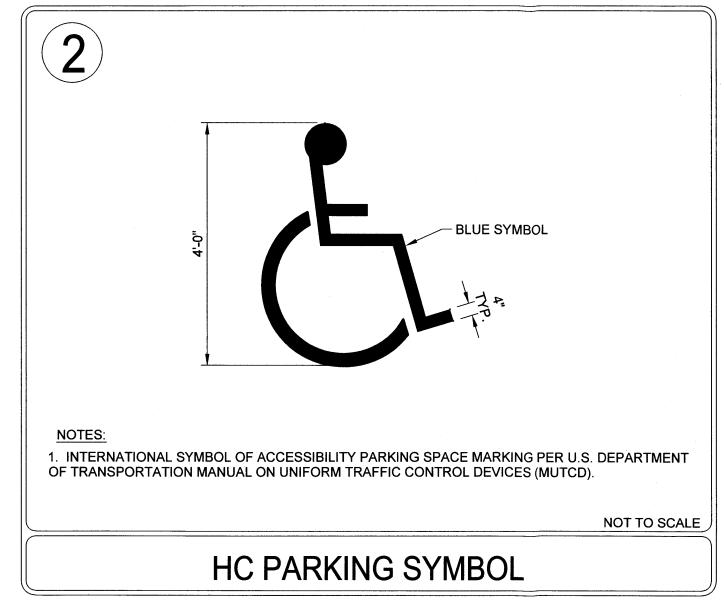


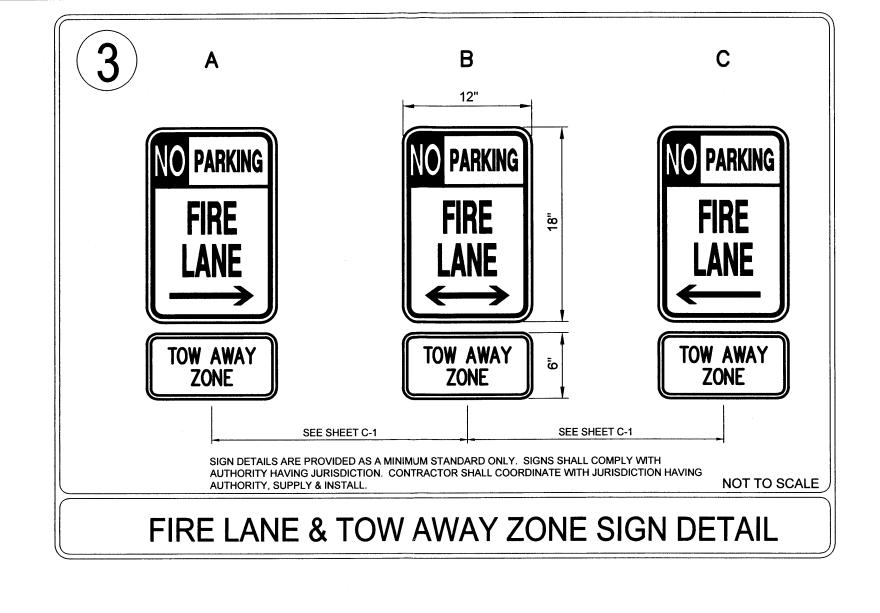


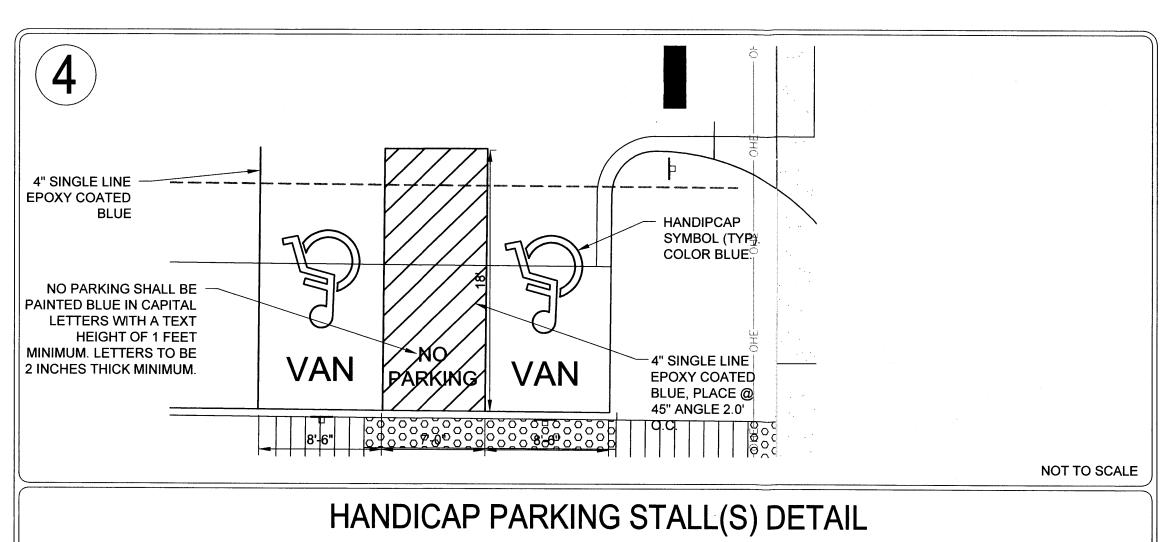

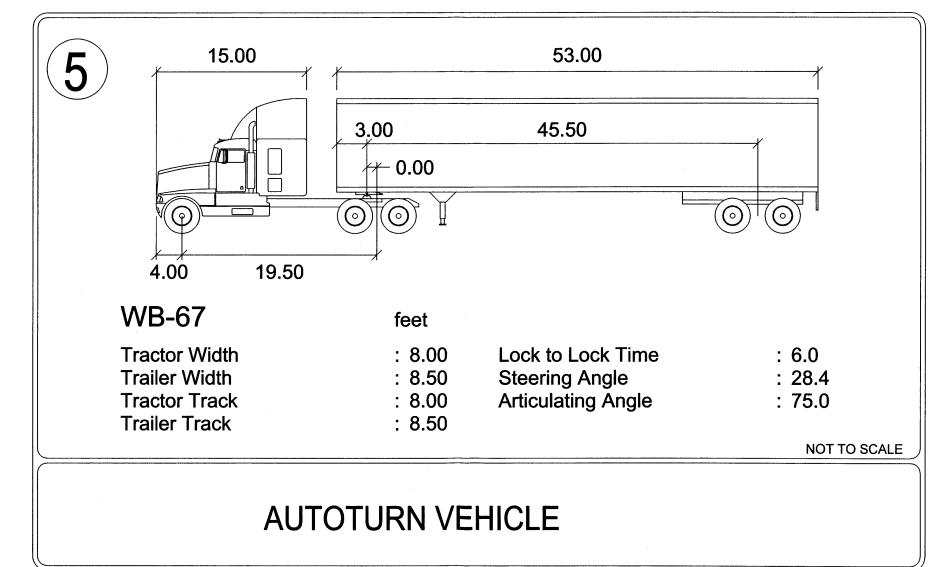

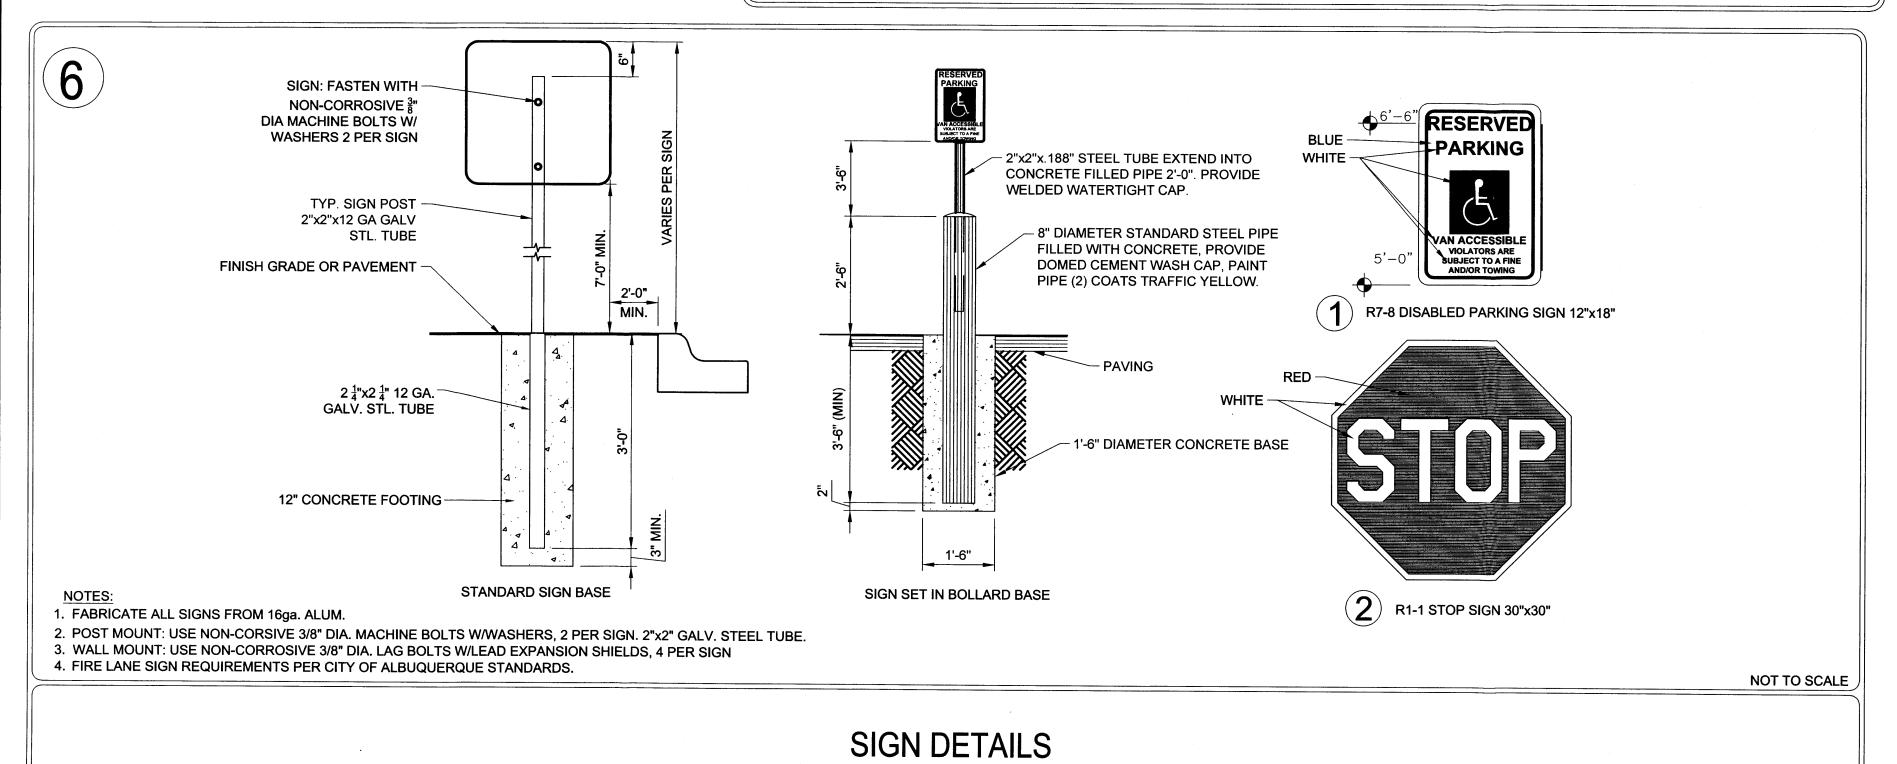

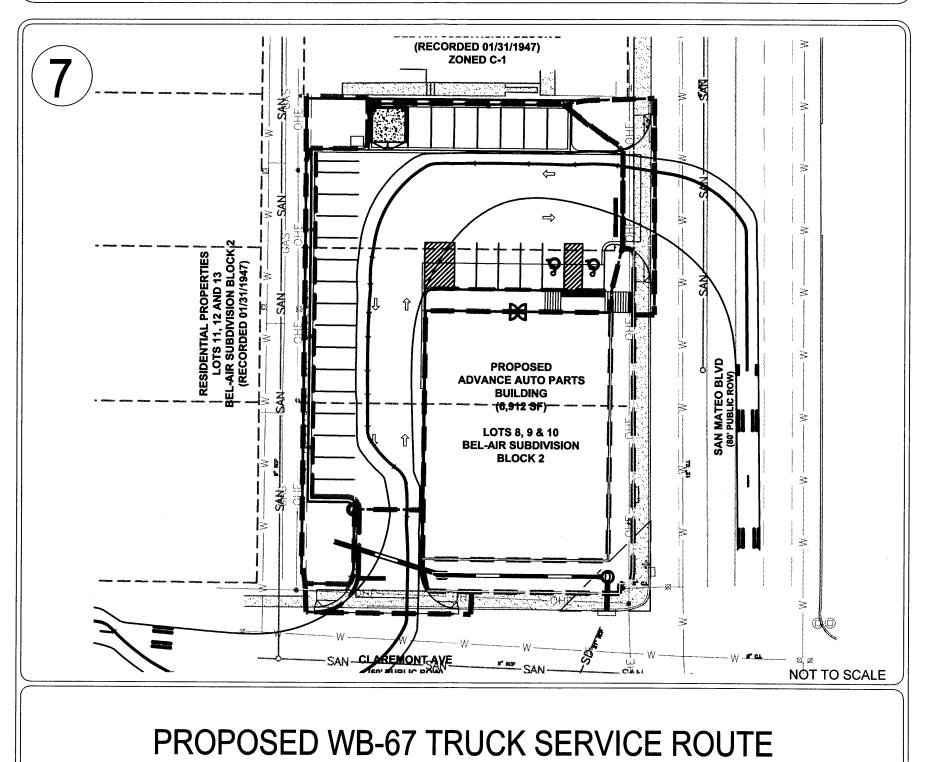

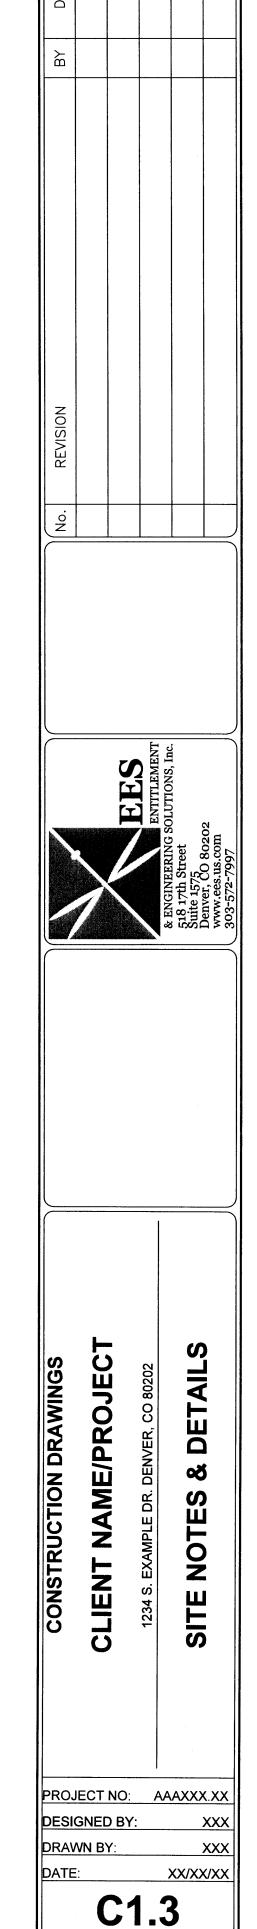


SHEET 4 OF XX

ALL CORNERS FOUND IN PLACE AND HELD WERE TAGGED WITH A BRASS DISK STAMPED "LS 8686" OR WERE ILLEGIBLE UNLESS OTHERWISE INDICATED HEREON. ALL CORNERS THAT WERE SET ARE EITHER A 1/2" REBAR WITH CAP STAMPED "PS 14269" OR SET CHISELED "+" IN CONCRETE.

VERTICAL DATUM IS BASED UPON THE ALBUQUERQUE CONTROL SURVEY BENCHMARK "21-H18", ELEVATION = 5215.209 (NAVD

PROJECT BASIS OF BEARING

NEW MEXICO STATE PLANE GRID SYSTEM, AND OUR PROJECT BEARING IS "S 00D 03' 32" E" ALONG THE WESTERLY RIGHT OF WAY LINE OF SAN MATEO BOULEVARD, NE.

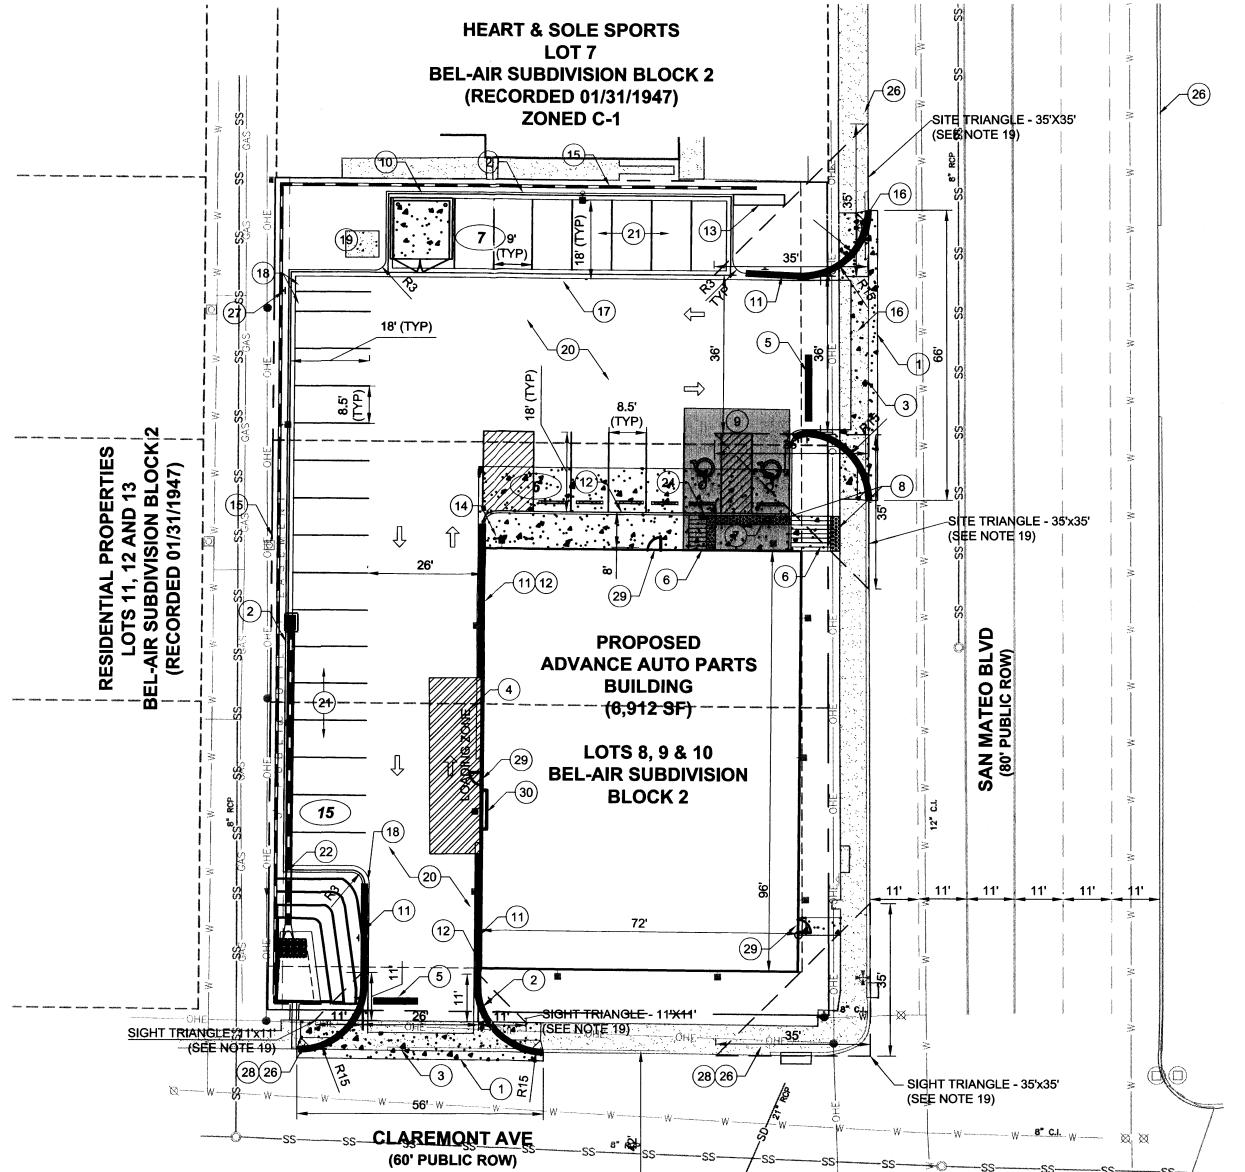

(9)

PROPOSED SITE LIGHTING PROPOSED CONCRETE WALK

 \leftarrow

EXISTING SANITARY/STORM MANHOLE

FIRE LANE CURB PAINT

PROJECT INFORMATION

ADDRESS:

2803, 2807 & 2813 SAN MATEO BLVD. ALBUQUERQUE, NM 87110

(FINAL ADDRESS ASSIGNMENT T.B.D UPON **COMPLETION OF PLAT BY OTHERS)**

LEGAL DESCRIPTION:

LOTS NUMBERED EIGHT (8), NINE (9), AND TEN (10) IN BLOCK NUMBERED TWO (2) OF THE PLAT OF BLOCKS 1-44 INCLUSIVE OF BEL-AIR, A SUBDIVISION OF A TRACT OF LAND IN SCHOOL DISTRICTS NUMBERS 13 AND 22, BERNALILLO COUNTY, NEW MEXICO, AS THE SAME IS SHOWN AND DESIGNATED ON THE MAP OF SAID SUBDIVISION, FILED IN THE OFFICE OF THE COUNTY CLERK OF BERNALILLO COUNTY, NEW MEXICO, ON JANUARY 31,

1 INCH = 20 FT.

SITE ACREAGE:

FORMER LOTS 8, 9, 10: 0.18 ACRES, 0.17 ACRES, 0.20 ACRES PROPOSED SITE: 0.55 ACRES

PLANNING INFORMATION:

ZONE ATLAS PAGE H-17 LAND USE ZONING IS C-1

PARKING SUMMARY:

AUTOMOBILE PARKING SPACES (1/200 SF)* ADA SPACES (1 PER 25 AUTOMOBILE SPACES) = 2 MOTORCYCLE PARKING SPACES (4'X18' MIN) = 2 BICYCLE PARKING = 2

STANDARD SPACES

= 26 ADA HANDICAP STANDARD SPACES ADA HANDICAP VAN ACCESSIBLE SPACES = 1 **TOTAL AUTOMOBILE SPACES*** = 28 **MOTORCYCLE PARKING SPACES 4.5'X18'** = 2 BICYCLE PARKING = 2

*SEE APPROVED VARIANCE 15ZHE-80127 BELOW

APPROVED VARIANCES:

15ZHE-80124: REMOVAL OF WEST 10' LANDSCAPE BUFFER 15ZHE-80126: REMOVAL OF NORTH 6' LANDSCAPE BUFFER 15ZHE-80127: REDUCTION OF REQUIRED PARKING SPACES TO 28

LEGEND


PROPOSED RETAINING WALL PROPOSED EASEMENT PROPERTY LINE PROPOSED BUILDING PROPOSED SIGN PARKING COUNT EXISTING CURB AND GUTTER PROPOSED 6" STANDARD CURB AND GUTTER **EXISTING SITE LIGHTING**

(SEE DETAIL SHEET C1.3) PROPOSED INLET

PROPOSED 4' STORM MANHOLE

DENOTES TRAFFIC FLOW PATTERNS (NO ACTUAL STRIPING)

HEAVY DUTY ASPHALT

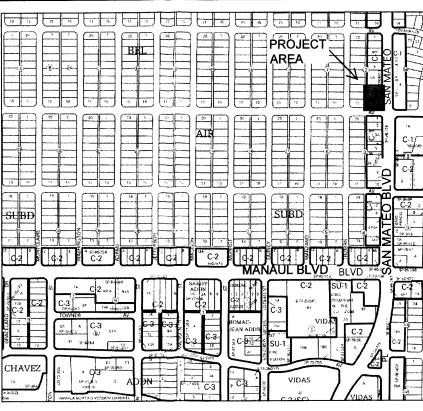

ZONE H-17 VICINITY MAP NOT TO SCALE

SITE SCHEDULE


- 1) PROPOSED 1' SAWCUT OFFSET FROM PROPOSED $\stackrel{\smile}{}$ CURB/GUTTER AND VALLEY GUTTER.
- 2 PROPOSED STANDARD 6" CURB AND GUTTER PER COA STANDARD DRAWING 2415A MODIFIED TO A 1' GUTTER PAN.
- (3) PROPOSED 6' VALLEY GUTTER PER COA STANDARD DRAWING 2420 AND 2426.
- (4) HATCHED AREA TO REPRESENT LOADING AREA LOCATION FOR SITE PLAN REVIEW PURPOSES ONLY. NO ACTUAL STRIPING
- (5) PROPOSED 10'X1.5' SOLID WHITE STOP BAR.
- (6) PROPOSED ADA RAMP
- (7) PROPOSED ADA STANDARD HANDICAP PARKING SIGN.
- (8) PROPOSED TACTILE WARNING PANEL 2'X17' AND 2'X8'.
- (9) SCREENED AREA DEFINES ADA COMPLIANT ZONE OF ACCESSIBILITY FROM BUILDING FRONT ENTRANCE TO HANDICAP PARKING STALLS. CROSS SLOPES NOT TO EXCEED 2% IN ALL DIRECTIONS. "NO PARKING" LETTERING NOT SHOWN. SEE DETAIL SHEET.
- (10) PROPOSED TRASH ENCLOSURE W/6' SCREEN WALL.
- (11) PROPOSED FIRE LANE STRIPING. SEE NOTE 14 ON THIS SHEET.
- (12) PROPOSED 6" DEPRESSED CURB AND GUTTER PER COA STANDARD DRAWING 2415A MODIFIED TO HAVE 2% CROSS FALL ACROSS GUTTER TOWARDS PARKING LOT.
- (13) PROPOSED PYLON SIGN PANEL. REFER TO ARCH. SIGNAGE PLANS FOR DETAIL.
- (14) PROPOSED CONCRETE WALK.
- (15) PROPOSED RETAINING WALL AND SCREENING FENCE. MAXIMUM HEIGHT OF RETAINING WALL 3', MAX. COMBINED HEIGHT OF WALL AND FENCE 6' (293' LONG).
- (16) EXISTING LIGHT POLE TO BE RELOCATED OUTSIDE OF THE
- DRIVEWAY CUT BY THE CONTRACTOR.
- (17) PROPOSED 2' CONCRETE ALLEY GUTTER PER COA STANDARD DRAWING 2415A.
- (18) PROPOSED MOTORCYCLE PARKING STALL (4.5'X18').
- (19) PROPOSED 4'X5' BIKE RACK STAND. PROVIDES (2) BICYCLE SPACES
- PER RACK.
- (20) PROPOSED HEAVY DUTY ASPHALT PAVEMENT. SEE PAVEMENT SECTION (21) PROPOSED LIGHT DUTY ASPHALT PAVEMENT. SEE PAVEMENT SECTION
- THIS SHEET. (22) PROPOSED RUNDOWN CURB AND GUTTER PER COA STANDARD DRAWING 2415A (2')
- (23) PROPOSED FIRE LANE SIGN.
- (24) PROPOSED ADA VAN HANDICAP PARKING SIGN.
- (25) 10' WIDE 6" 4000 PSI CONCRETE STRIP WITH 6" BY 1" REINFORCEMENT.
- (26) EXISTING CURB CUT.
- (27) MOTORCYCLE PARKING SIGN PER C.O.A. ZONING CODE 14-16-3-1 (C)(2).
- (28) EXISTING CURB CUTS NOT MODIFIED BY NEW CURB CUTS TO BE REPLACED WITH CURB, GUTTER AND WALL PER C.O.A. STANDARD DWG 2430.
- (29) PEDESTRIAN DOORS TO BUILDING
- (30) ROLLER SHUTTER DOOR FOR DELIVERIES

PAVEMENT SECTIONS

AUTOMOBILE PARKING AREAS (LIGHT DUTY PAVEMENT) 2 1/2" ASPHALT CONCRETE PAVEMENT (AC) OVER 6" ABC OR 5" PCC PER GEOTECHNICAL REPORT

DRIVE LANES (HEAVY DUTY PAVEMENT) 4" ASPHALT CONCRETE (AC) PAVEMENT OVER 6" ABC OR 5" PCC PER GEOTECHNICAL REPORT

PAVEMENT SECTION PER GEOTECHNICAL REPORT PREPARED BY TERRACON CONSULTANTS INC. PROJECT NUMBER 66155033 REFER TO GEOTECHNICAL REPORT.

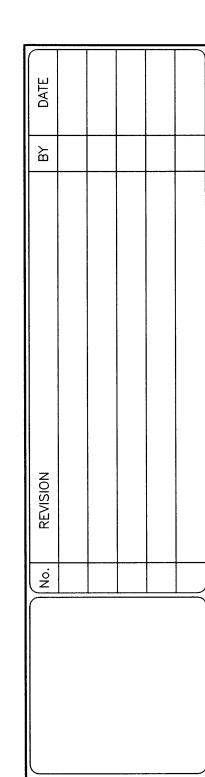



AUTO NCE 2

PROJECT NO: CAD008.01 DESIGNED BY: DRAWN BY: 08/07/2015

SHEET 1 OF 2

NOTES

1. NO BIKE ROUTES OR PATHS EXIST ALONG FRONTAGE OF SAN MATEO BOULEVARD.

OF CITY SITE OF ALBUQUERQUE.

ONE-WAY TRAFFIC MOVEMENT

5. SITE ASSUMES CIRCULATION OF WB-67 SEMI.

AND PAVEMENT MARKINGS AS SHOWN HEREON. ON SITE PARKING STALL STRIPES SHALL BE 4" WIDE AND WHITE IN COLOR. HANDICAP STALL STALLS SHALL BE PAINTED AND SIGNED PER FEDERAL, STATE AND LOCAL REQUIREMENTS. SEE DETAIL SHEET. 7. HANDICAP PARKING AREAS PROVIDED PER CITY STANDARDS AND SHALL COMPLY WITH REQUIREMENTS OF THE CURRENT ADOPTED UNIFORM BUILDING CODE. 8. UNLESS OTHERWISE NOTED, ALL RADII ON PARKING ISLANDS SHALL BE 3'.

9. CONTRACTOR SHALL REFER TO ARCHITECTURAL PLANS FOR PRECISE BUILDING DIMENSIONS SERVICE AREA DIMENSIONS AND ELEVATIONS. REFERENCE M.E.P. FOR EXACT BUILDING UTILITY ENTRANCE

10. THE DISPOSAL OF DEMOLISHED ITEMS SHALL COMPLY TO ALL STATE AND LOCAL REQUIREMENTS. 11. MECHANICAL UNITS, DUMPSTER AND TRASH COMPACTORS SHALL BE SCREENED IN ACCORDANCE WITH THE CITY OF ALBUQUERQUE ZONING ORDINANCE.

2. ALL CONSTRUCTION SHALL BE PERFORMED IN ACCORDANCE WITH STANDARD SPECIFICATIONS

4. CARS/TRUCKS WILL MANEUVER AROUND BUILDING DRIVE AISLES IN A TWO-WAY TRAFFIC MOVEMENT.

6. UPON COMPLETION OF PAVING OPERATIONS THE CONTRACTOR SHALL INSTALL THE PAVEMENT STRIPES

3. EMERGENCY AND SERVICE TRUCKS WILL MANEUVER AROUND BUILDING DRIVE AISLES IN A


- 12. ALL SIGNAGE CONTINGENT UPON APPROVAL BY THE CITY OF ALBUQUERQUE. 13. ALL SIGNS SHALL BE INSTALLED IN ACCORDANCE WITH THE ZONING ORDINANCE. 14. FIRE LANE STRIPING, "NO PARKING FIRE LANE" MARKING SHALL CONSIST OF A SIX (6) INCH WIDE RED STRIPE


• SAN MATEO & CLAREMONT (NW CORNER) - 35 FEET CLEAR SITE BOTH SIDES

NORTHERN SITE ACCESS & SAN MATEO - 35 FEET CLEAR BOTH SIDES

- ALONG THE CURB ON THE WEST SIDE OF THE BUILDING. THE WORDS "NO PARKING FIRE LANE" SHALL BE MARKED ON THE SIGN IN FOUR (4) INCH HIGH WHITE LETTERS AT 25-FT. MAXIMUM INTERVALS STRIPING AND LETTERS SHALL BE APPLIED ACCORDING TO THE CITY OF ALBUQUERQUE, FIRE LANE AND FIRE PROTECTION MUST BE APPROVED BY THE FIRE MARSHALL PRIOR TO BUILDING PERMIT BEING ISSUED. CONTRACTOR TO COORDINATE ALL FIRE LANE MARKINGS WITH THE ALBUQUERQUE AND NEW MEXICO
- DEPARTMENT OF TRANSPORTATION STANDARDS. 15. ALL DRIVEWAYS SHALL BE CONSTRUCTED IN ACCORDANCE WITH CITY OF ALBUQUERQUE AND NEW MEXICO DEPARTMENT OF TRANSPORTATION STANDARDS.
- 16. ALL DIMENSIONS ARE MEASURED FROM FLOWLINE OF CURB, UNLESS NOTED OTHERWISE. 17. ALL ACCESSIBLE RAMPS SHALL HAVE A MAXIMUM SLOPE OF 12:1.
- 18. REFER TO PLAT FOR OFFICIAL EASEMENT LOCATIONS. 19. WALLS, LANDSCAPING AND SIGNAGE WILL NOT INTERFERE WITH CLEAR SIGHT REQUIREMENTS; THEREFORE, SIGNS, WALLS, TREES AND SHRUBBERY BETWEEN 3 AND 8 FEET TALL (AS MEASURED FROM THE GUTTER PAN) WILL OT BE ACCEPTABLE IN THIS AREA. THE FOLLOWING SIGHT TRIANGLE LENGTHS HAVE BEEN USED;


• SOUTHERN SITE ACCESS & CLAREMONT AVENUE - 11 FEET CLEAR BOTH SIDES (PER MINI CLEAR SITE TRIANGLE DETAIL).

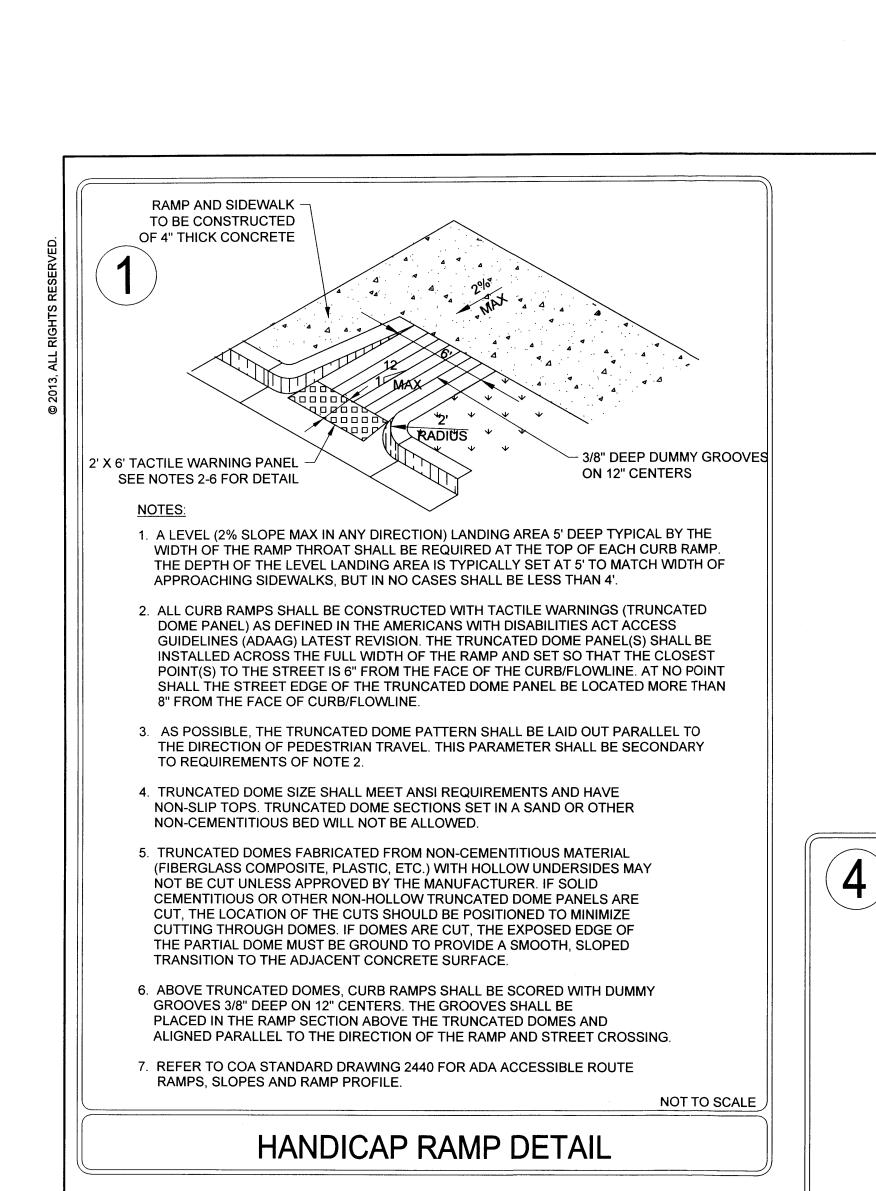


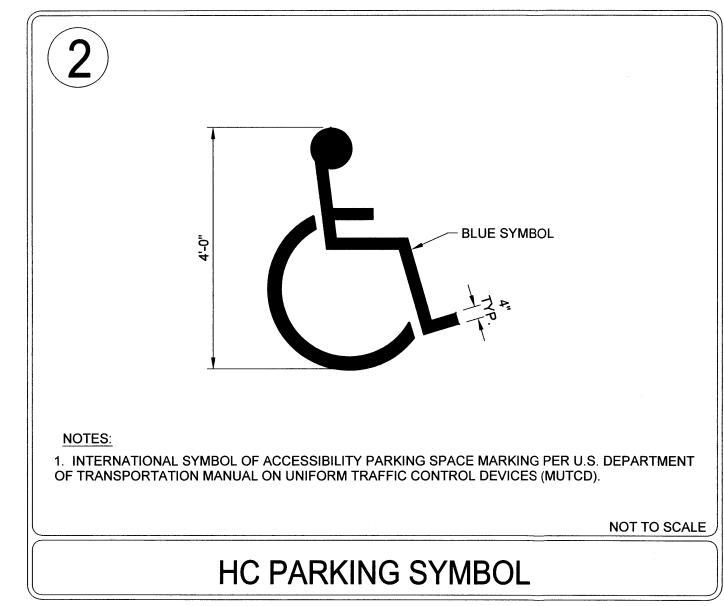



HANDICAP PARKING STALL(S) DETAIL


NΑV

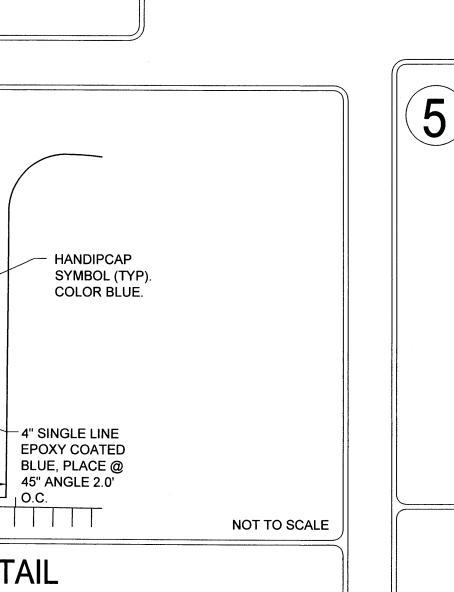


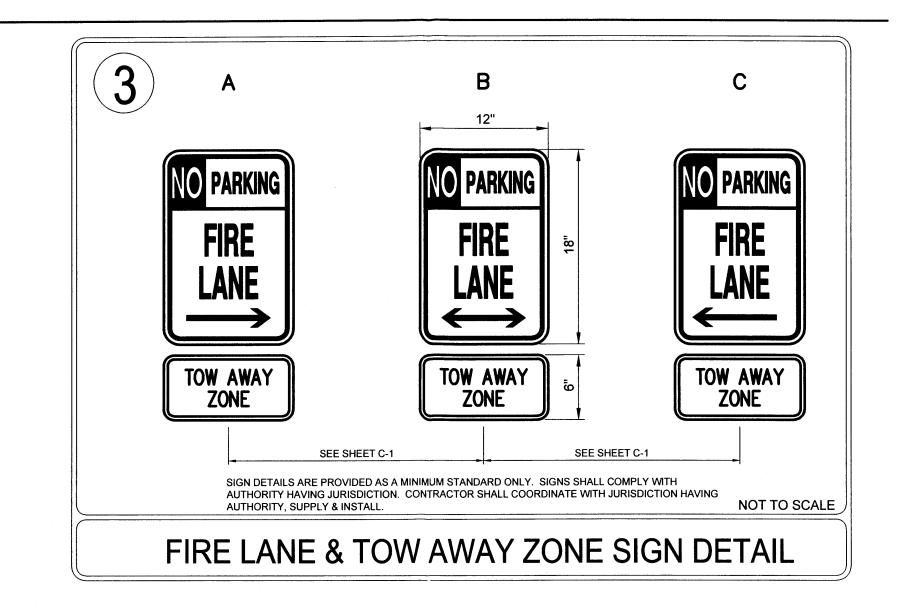


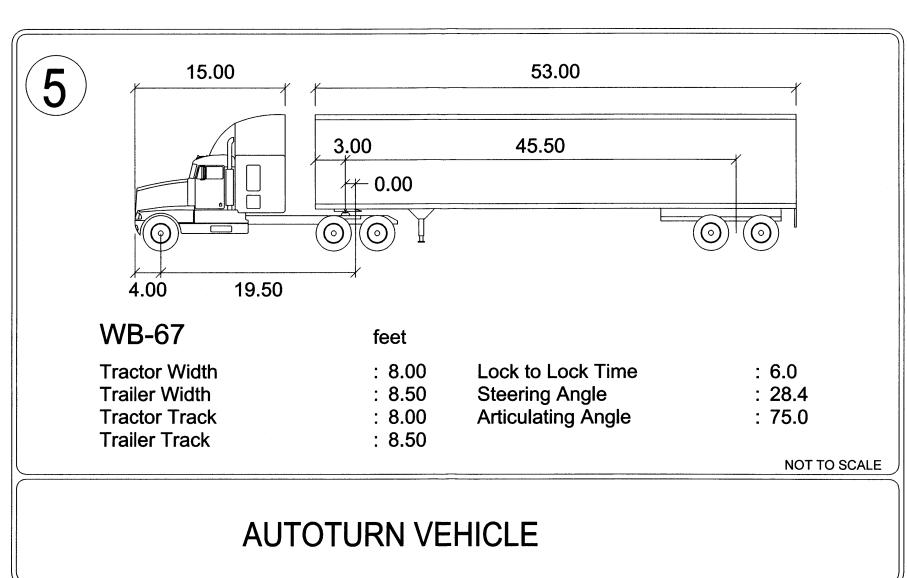

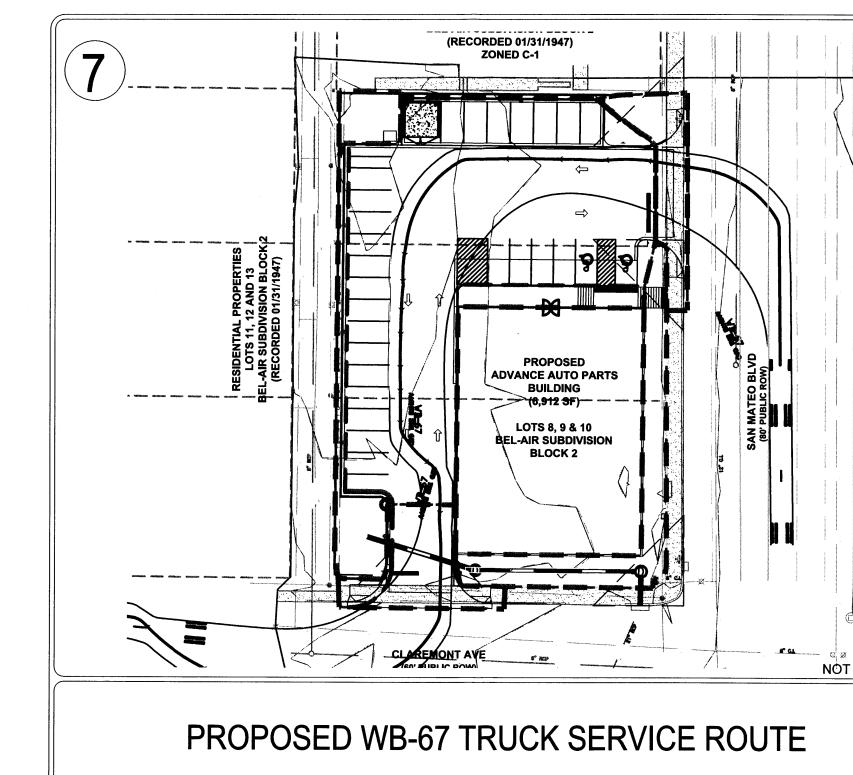

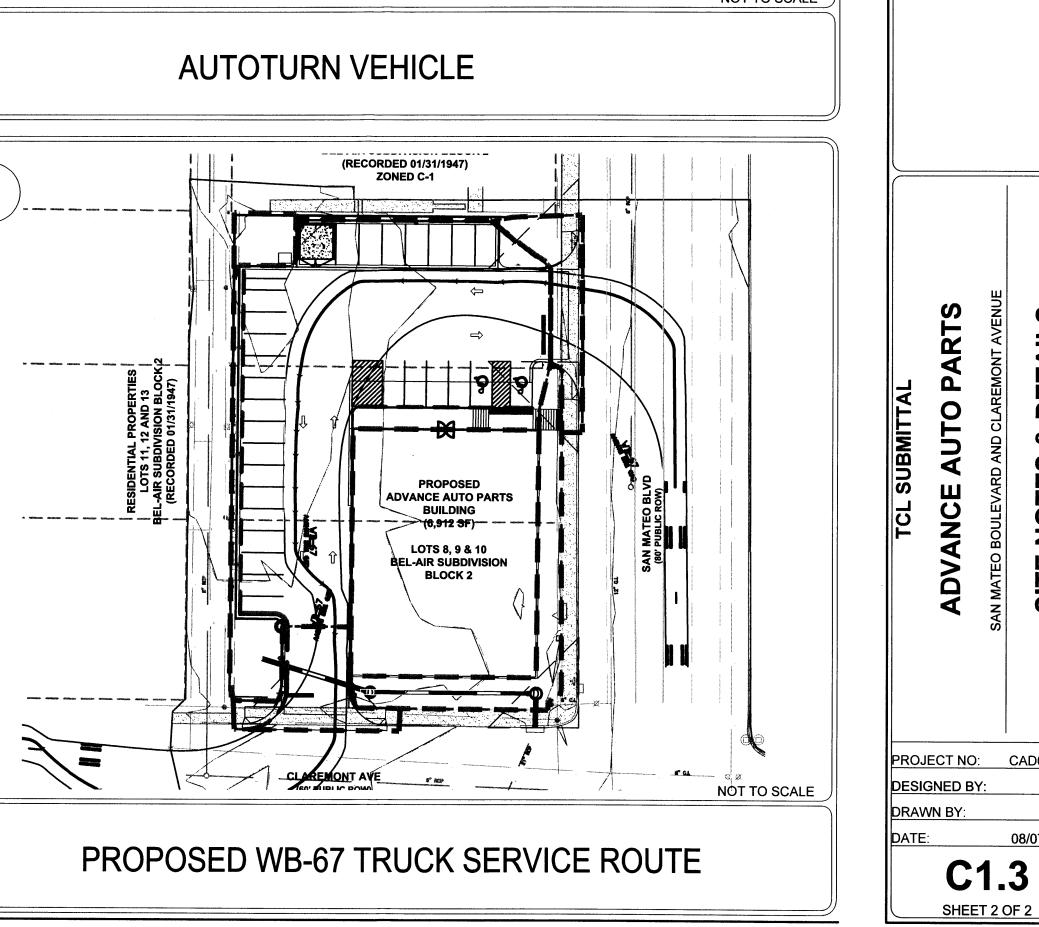

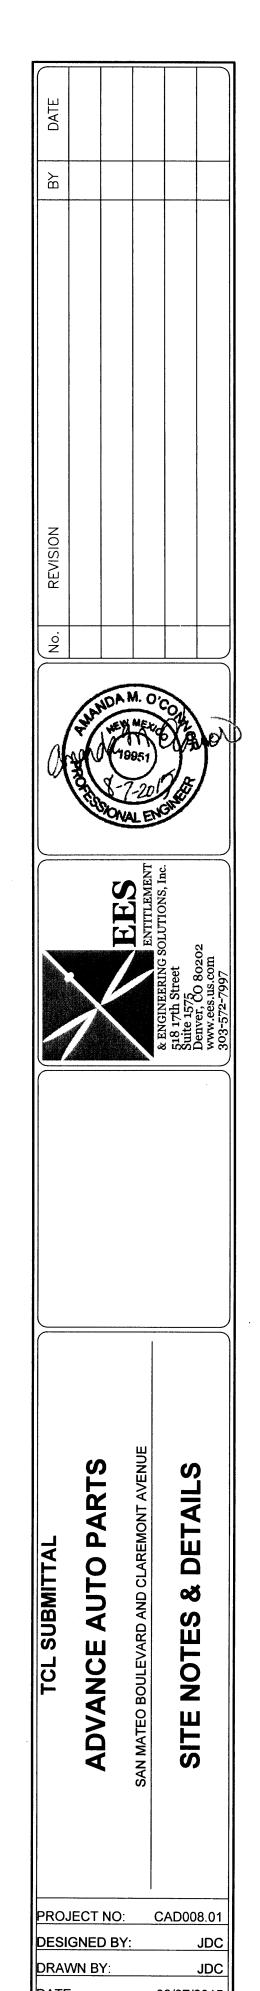

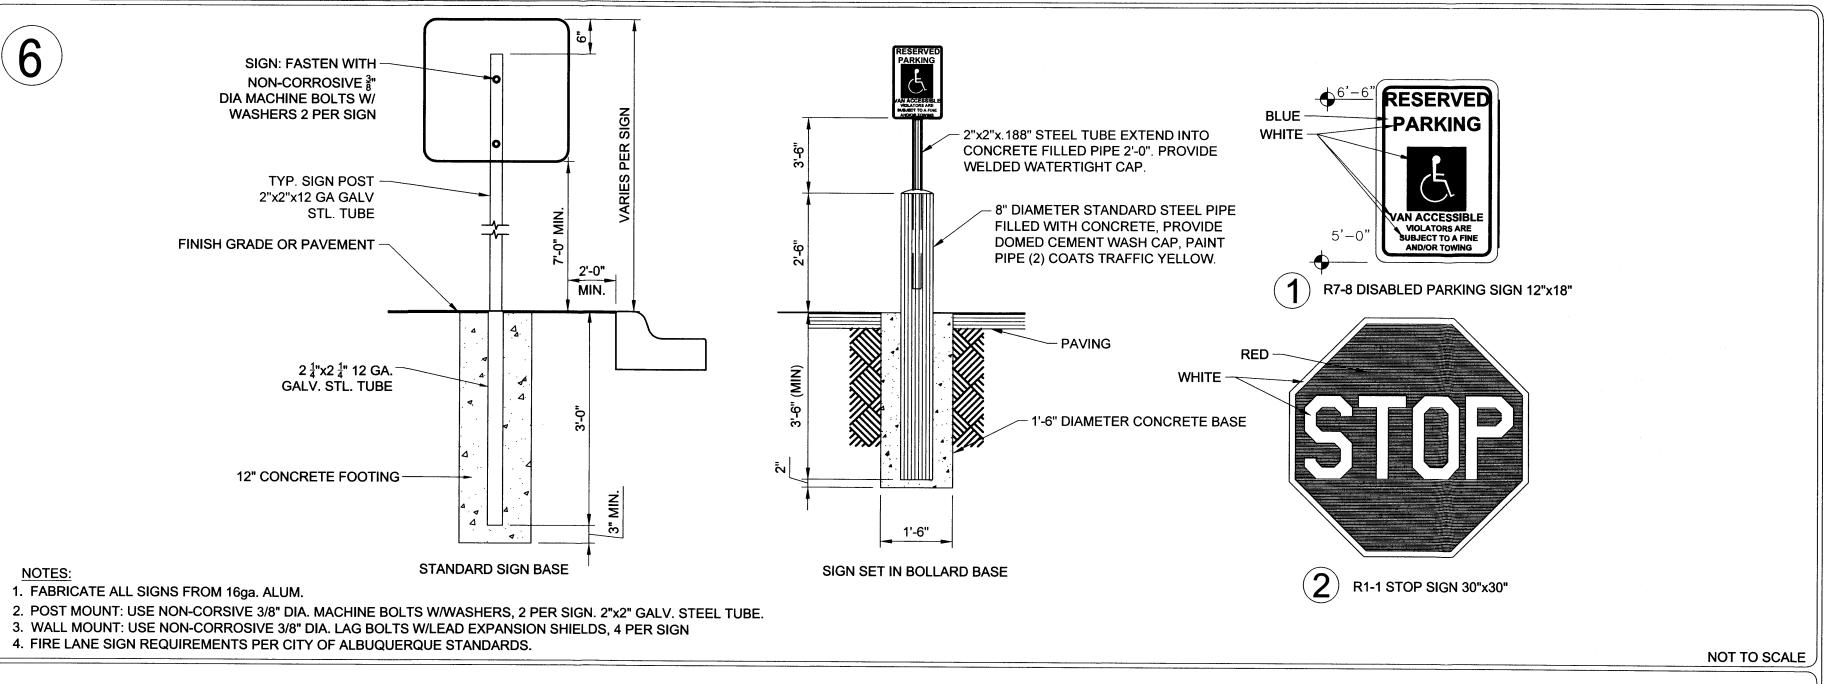

SIGN DETAILS

NO PARKING SHALL BE

LETTERS WITH A TEXT

HEIGHT OF 1 FEET


PAINTED BLUE IN CAPITAL

MINIMUM. LETTERS TO BE

2 INCHES THICK MINIMUM.

4" SINGLE LINE

EPOXY COATED

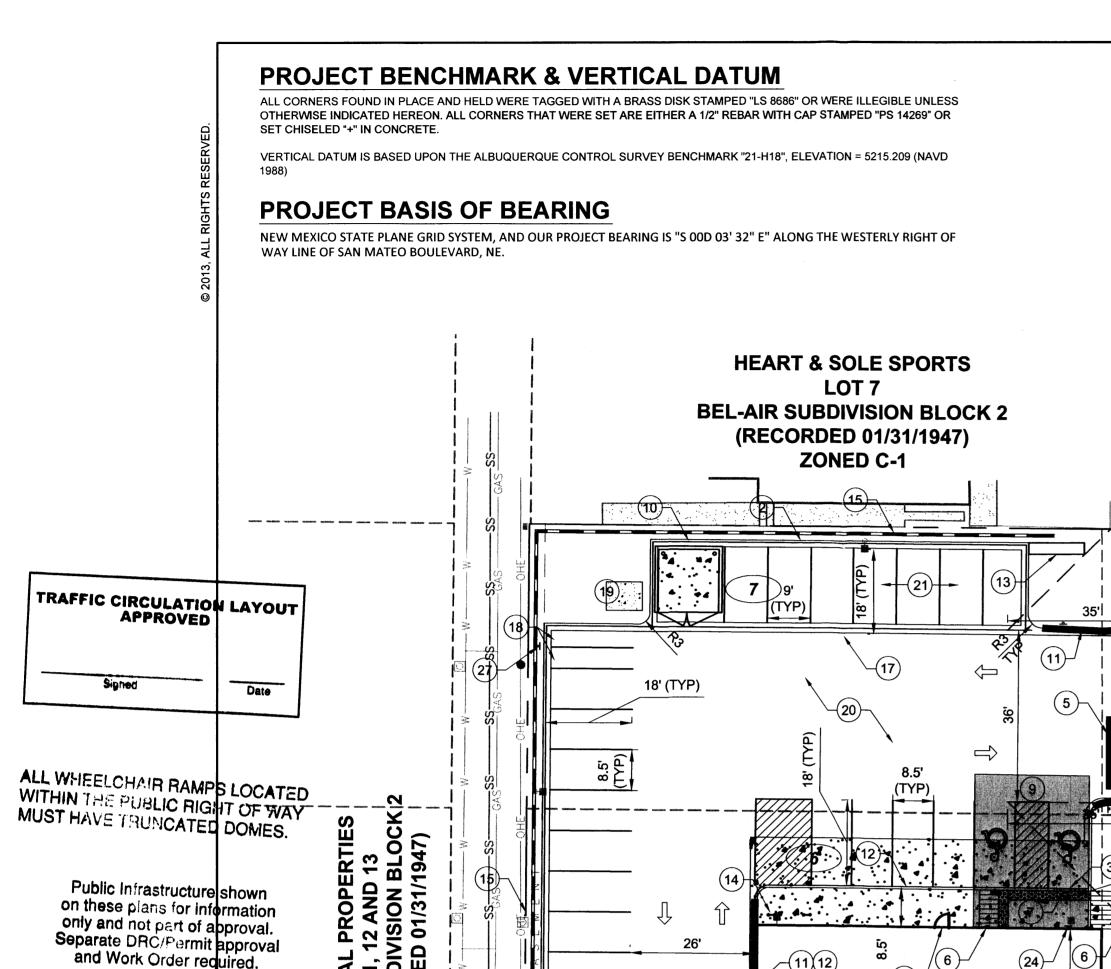

OF CITY SITE OF ALBUQUERQUE.

ONE-WAY TRAFFIC MOVEMENT

5. SITE ASSUMES CIRCULATION OF WB-67 SEMI.

LOCAL REQUIREMENTS. SEE DETAIL SHEET.


OF THE CURRENT ADOPTED UNIFORM BUILDING CODE.

THE CITY OF ALBUQUERQUE ZONING ORDINANCE.

8. UNLESS OTHERWISE NOTED, ALL RADII ON PARKING ISLANDS SHALL BE 3'.

NOTES

LOCATIONS.

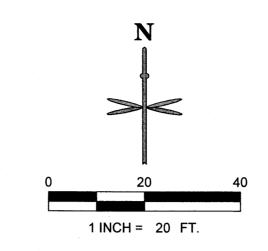

PROJECT INFORMATION

ADDRESS:

SITE TRIANGLE - 35'X35'

SITE TRIANGLE - 35'x35'

(SEE NOTE 19)

BL ow

MATI

SIGHT TRIANGLE - 35'x35'

12. ALL SIGNAGE CONTINGENT UPON APPROVAL BY THE CITY OF ALBUQUERQUE.

DEPARTMENT OF TRANSPORTATION STANDARDS.

18. REFER TO PLAT FOR OFFICIAL EASEMENT LOCATIONS.

MEXICO DEPARTMENT OF TRANSPORTATION STANDARDS.

17. ALL ACCESSIBLE RAMPS SHALL HAVE A MAXIMUM SLOPE OF 12:1.

• SAN MATEO & CLAREMONT (NW CORNER) - 35 FEET CLEAR SITE BOTH SIDES

• NORTHERN SITE ACCESS & SAN MATEO - 35 FEET CLEAR BOTH SIDES

13. ALL SIGNS SHALL BE INSTALLED IN ACCORDANCE WITH THE ZONING ORDINANCE.

14. FIRE LANE STRIPING, "NO PARKING FIRE LANE" MARKING SHALL CONSIST OF A SIX (6) INCH WIDE RED STRIPE

ALONG THE CURB ON THE WEST SIDE OF THE BUILDING. THE WORDS "NO PARKING FIRE LANE" SHALL BE

MARKED ON THE SIGN IN FOUR (4) INCH HIGH WHITE LETTERS AT 25-FT. MAXIMUM INTERVALS STRIPING

AND LETTERS SHALL BE APPLIED ACCORDING TO THE CITY OF ALBUQUERQUE. FIRE LANE AND FIRE

15. ALL DRIVEWAYS SHALL BE CONSTRUCTED IN ACCORDANCE WITH CITY OF ALBUQUERQUE AND NEW

16. ALL DIMENSIONS ARE MEASURED FROM FLOWLINE OF CURB, UNLESS NOTED OTHERWISE.

PROTECTION MUST BE APPROVED BY THE FIRE MARSHALL PRIOR TO BUILDING PERMIT BEING ISSUED.

CONTRACTOR TO COORDINATE ALL FIRE LANE MARKINGS WITH THE ALBUQUERQUE AND NEW MEXICO

19. WALLS, LANDSCAPING AND SIGNAGE WILL NOT INTERFERE WITH CLEAR SIGHT REQUIREMENTS; THEREFORE

SIGNS, WALLS. TREES AND SHRUBBERY BETWEEN 3 AND 8 FEET TALL (AS MEASURED FROM THE GUTTER

• SOUTHERN SITE ACCESS & CLAREMONT AVENUE - 11 FEET CLEAR BOTH SIDES (PER MINI CLEAR SITE TRIANGLE DETAIL).

PAN) WILL OT BE ACCEPTABLE IN THIS AREA. THE FOLLOWING SIGHT TRIANGLE LENGTHS HAVE BEEN USED;

(SEE NOTE 19)

PROPOSED

ADVANCE AUTO PARTS

BUILDING

LOTS 8, 9 & 10

BEL-AIR SUBDIVISION

BLOCK 2

72'

11' SIGHT TRIANGLE - 11'X11'

(SEE NOTE 19)

(12)

----SS-CLAREMONT AVE

I. NO BIKE ROUTES OR PATHS EXIST ALONG FRONTAGE OF SAN MATEO BOULEVARD.

2. ALL CONSTRUCTION SHALL BE PERFORMED IN ACCORDANCE WITH STANDARD SPECIFICATIONS

4. CARS/TRUCKS WILL MANEUVER AROUND BUILDING DRIVE AISLES IN A TWO-WAY TRAFFIC MOVEMENT.

6. UPON COMPLETION OF PAVING OPERATIONS THE CONTRACTOR SHALL INSTALL THE PAVEMENT STRIPES

WHITE IN COLOR. HANDICAP STALL STALLS SHALL BE PAINTED AND SIGNED PER FEDERAL, STATE AND

HANDICAP PARKING AREAS PROVIDED PER CITY STANDARDS AND SHALL COMPLY WITH REQUIREMENTS

9. CONTRACTOR SHALL REFER TO ARCHITECTURAL PLANS FOR PRECISE BUILDING DIMENSIONS SERVICE

AREA DIMENSIONS AND ELEVATIONS. REFERENCE M.E.P. FOR EXACT BUILDING UTILITY ENTRANCE

10. THE DISPOSAL OF DEMOLISHED ITEMS SHALL COMPLY TO ALL STATE AND LOCAL REQUIREMENTS. 11. MECHANICAL UNITS, DUMPSTER AND TRASH COMPACTORS SHALL BE SCREENED IN ACCORDANCE WITH

AND PAVEMENT MARKINGS AS SHOWN HEREON. ON SITE PARKING STALL STRIPES SHALL BE 4" WIDE AND

EMERGENCY AND SERVICE TRUCKS WILL MANEUVER AROUND BUILDING DRIVE AISLES IN A

(60' PUBLIC ROW)

----(6,912 SF) ----+-

(SEE NOTE 19)

2803, 2807 & 2813 SAN MATEO BLVD. ALBUQUERQUE, NM 87110 (FINAL ADDRESS ASSIGNMENT T.B.D UPON **COMPLETION OF PLAT BY OTHERS)**

LEGAL DESCRIPTION:

LOTS NUMBERED EIGHT (8), NINE (9), AND TEN (10) IN BLOCK NUMBERED TWO (2) OF THE PLAT OF BLOCKS 1-44 INCLUSIVE OF BEL-AIR, A SUBDIVISION OF A TRACT OF LAND IN SCHOOL DISTRICTS NUMBERS 13 AND 22, BERNALILLO COUNTY, NEW MEXICO, AS THE SAME IS SHOWN AND DESIGNATED ON THE MAP OF SAID SUBDIVISION, FILED IN THE OFFICE OF THE COUNTY CLERK OF BERNALILLO COUNTY, NEW MEXICO, ON JANUARY 31,

SITE ACREAGE:

FORMER LOTS 8, 9, 10: 0.18 ACRES, 0.17 ACRES, 0.20 ACRES PROPOSED SITE: 0.55 ACRES

PLANNING INFORMATION:

ZONE ATLAS PAGE H-17 LAND USE ZONING IS C-1

PARKING SUMMARY:

REQUIRED AUTOMOBILE PARKING SPACES (1/200 SF)* ADA SPACES (1 PER 25 AUTOMOBILE SPACES) MOTORCYCLE PARKING SPACES (4'X18' MIN) **BICYCLE PARKING** = 2

PROVIDED STANDARD SPACES


ADA HANDICAP STANDARD SPACES = 1 ADA HANDICAP VAN ACCESSIBLE SPACES = 1 **TOTAL AUTOMOBILE SPACES*** = 28 **MOTORCYCLE PARKING SPACES 4.5'X18'** = 2 **BICYCLE PARKING**

*SEE APPROVED VARIANCE 15ZHE-80127 BELOW


APPROVED VARIANCES:

15ZHE-80124: REMOVAL OF WEST 10' LANDSCAPE BUFFER 15ZHE-80126: REMOVAL OF NORTH 6' LANDSCAPE BUFFER 15ZHE-80127: REDUCTION OF REQUIRED PARKING SPACES TO 28

LEGEND

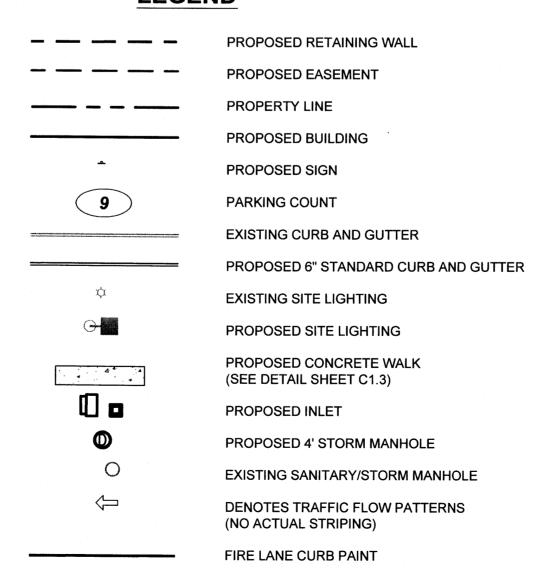

HEAVY DUTY ASPHALT

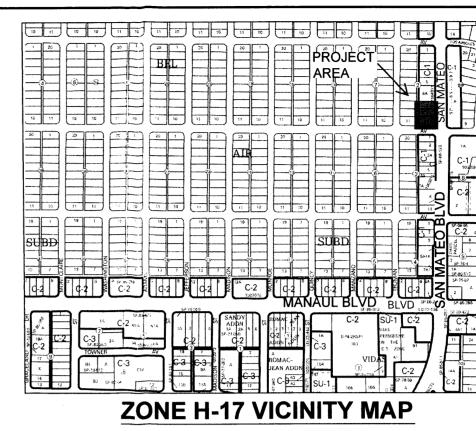

NOT TO SCALE

SITE SCHEDULE


- (1) PROPOSED 1' SAWCUT OFFSET FROM PROPOSED $^{\prime}$ CURB/GUTTER AND VALLEY GUTTER.
- (2) PROPOSED STANDARD 6" CURB AND GUTTER PER COA STANDARD DRAWING 2415A MODIFIED TO A 1' GUTTER PAN.
- (3) PROPOSED 6' VALLEY GUTTER PER COA STANDARD DRAWING 2420 AND 2426.
- (4) HATCHED AREA TO REPRESENT LOADING AREA LOCATION FOR SITE PLAN REVIEW PURPOSES ONLY. NO ACTUAL STRIPING PROPOSED.
- 5) PROPOSED 10'X1.5' SOLID WHITE STOP BAR.
- (6) PROPOSED ADA RAMP
- (7) PROPOSED ADA STANDARD HANDICAP PARKING SIGN.
- $ig(\,8\,ig)$ PROPOSED TACTILE WARNING PANEL 2'X17' AND 2'X8'.
- (9) SCREENED AREA DEFINES ADA COMPLIANT ZONE OF ACCESSIBILITY FROM BUILDING FRONT ENTRANCE TO HANDICAP PARKING STALLS. CROSS SLOPES NOT TO EXCEED 2% IN ALL DIRECTIONS. "NO PARKING" LETTERING NOT SHOWN, SEE DETAIL SHEET.
- (10) PROPOSED TRASH ENCLOSURE W/6' SCREEN WALL
- (11) PROPOSED FIRE LANE STRIPING. SEE NOTE 14 ON THIS SHEET.
- (12) PROPOSED 6" DEPRESSED CURB AND GUTTER PER COA STANDARD DRAWING 2415A MODIFIED TO HAVE 2% CROSS FALL ACROSS GUTTER TOWARDS PARKING LOT.
- (13) PROPOSED PYLON SIGN PANEL. REFER TO ARCH. SIGNAGE PLANS FOR DETAIL
- (14) PROPOSED CONCRETE WALK.
- (15) PROPOSED RETAINING WALL AND SCREENING FENCE. MAXIMUM HEIGHT OF RETAINING WALL 3', MAX. COMBINED HEIGHT OF WALL AND FENCE 6' (293' LONG).
- (16) EXISTING LIGHT POLE TO BE RELOCATED OUTSIDE OF THE
- DRIVEWAY CUT BY THE CONTRACTOR.
- (17) PROPOSED 2' CONCRETE ALLEY GUTTER PER COA STANDARD DRAWING 2415A.
- (18) PROPOSED MOTORCYCLE PARKING STALL (4.5'X18').
- (19) PROPOSED 4'X5' BIKE RACK STAND. PROVIDES (2) BICYCLE SPACES
- (20) PROPOSED HEAVY DUTY ASPHALT PAVEMENT. SEE PAVEMENT SECTION
- (21) PROPOSED LIGHT DUTY ASPHALT PAVEMENT. SEE PAVEMENT SECTION THIS SHEET.
- (22) PROPOSED RUNDOWN CURB AND GUTTER PER COA STANDARD DRAWING 2415A (2')
- (23) PROPOSED FIRE LANE SIGN.
- (24) PROPOSED ADA VAN HANDICAP PARKING SIGN (WALL MOUNTED).
- (25) 10' WIDE 6" 4000 PSI CONCRETE STRIP WITH 6" BY 1" REINFORCEMENT.
- (26) EXISTING CURB CUT.
- (27) MOTORCYCLE PARKING SIGN PER C.O.A. ZONING CODE 14-16-3-1 (C)(2).
- (28) EXISTING CURB CUTS NOT MODIFIED BY NEW CURB CUTS TO BE REPLACED WITH CURB, GUTTER AND WALL PER C.O.A. STANDARD DWG 2430.
- (29) PEDESTRIAN DOORS TO BUILDING
- (30) ROLLER SHUTTER DOOR FOR DELIVERIES
- (31) WHEEL STOP


PAVEMENT SECTIONS

AUTOMOBILE PARKING AREAS (LIGHT DUTY PAVEMENT) 2 1/2" ASPHALT CONCRETE PAVEMENT (AC) OVER 6" ABC OR 5" PCC PER GEOTECHNICAL REPORT

DRIVE LANES (HEAVY DUTY PAVEMENT) 4" ASPHALT CONCRETE (AC) PAVEMENT OVER 6" ABC OR 5" PCC PER GEOTECHNICAL REPORT

PAVEMENT SECTION PER GEOTECHNICAL REPORT PREPARED BY TERRACON CONSULTANTS INC. PROJECT NUMBER 66155033 REFER TO GEOTECHNICAL REPORT.

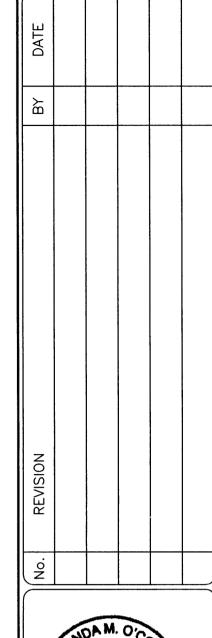

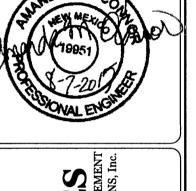





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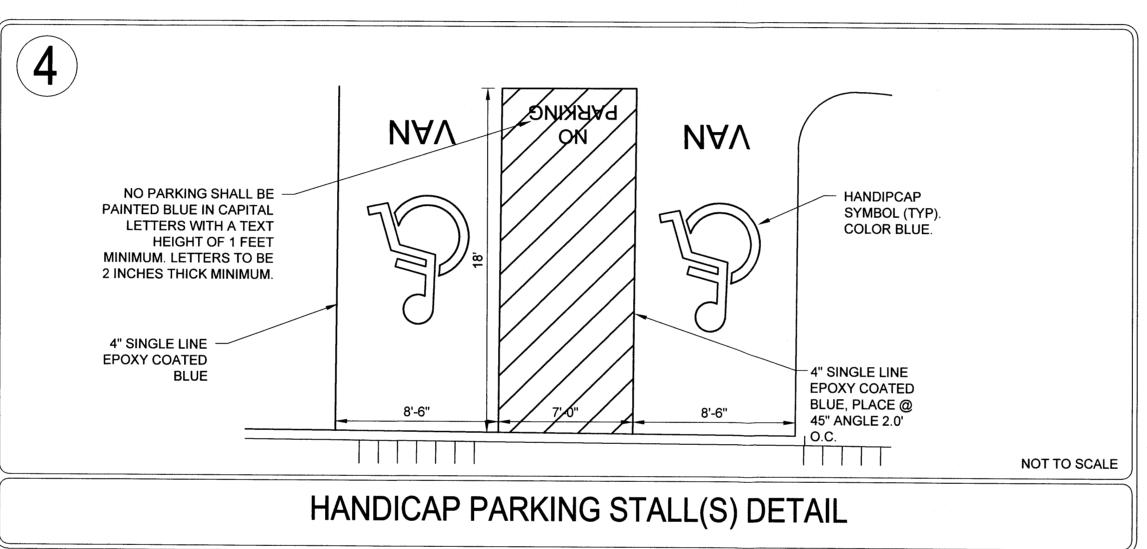
PROJECT NO: CAD008.01 DESIGNED BY: DRAWN BY: 08/07/2015


SHEET 1 OF 2

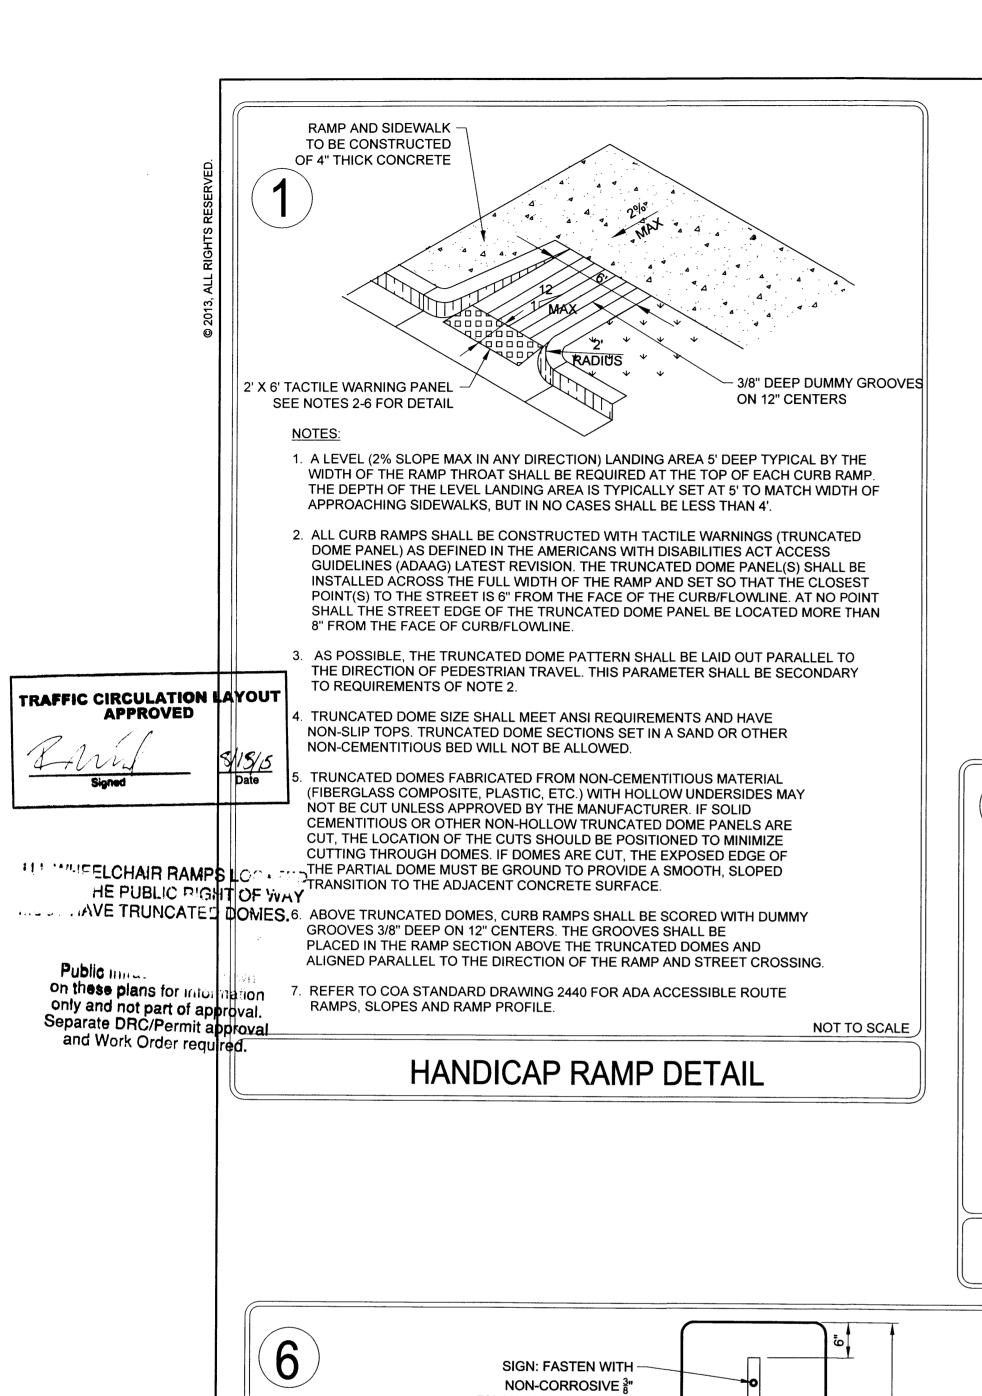



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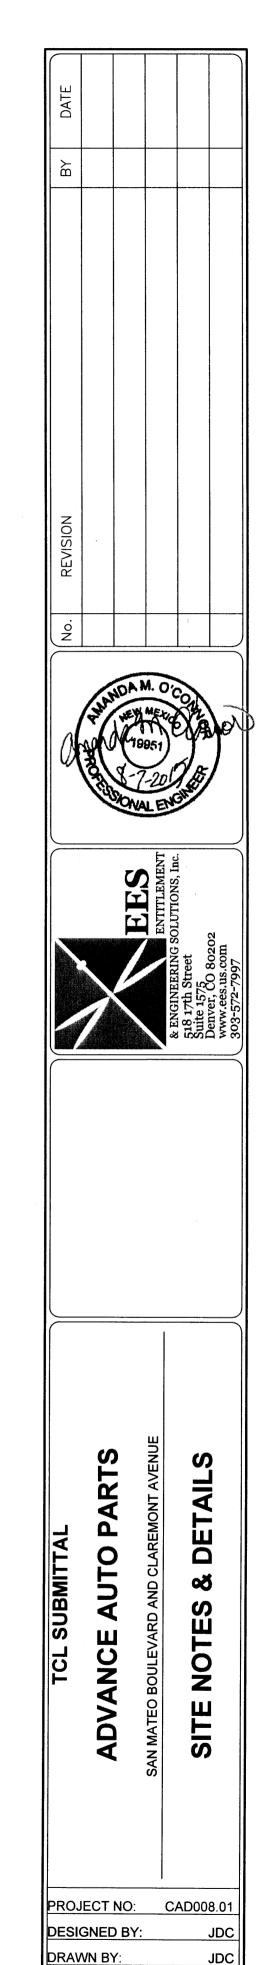




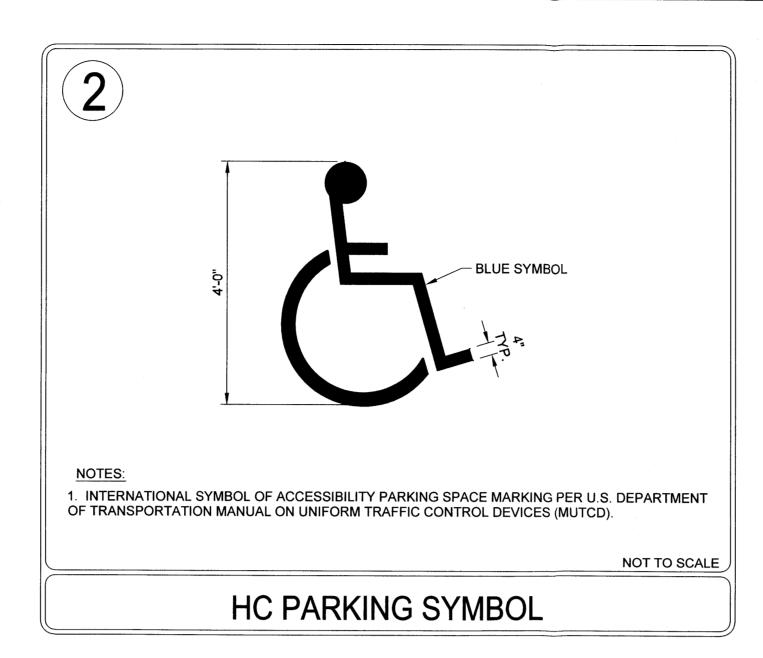

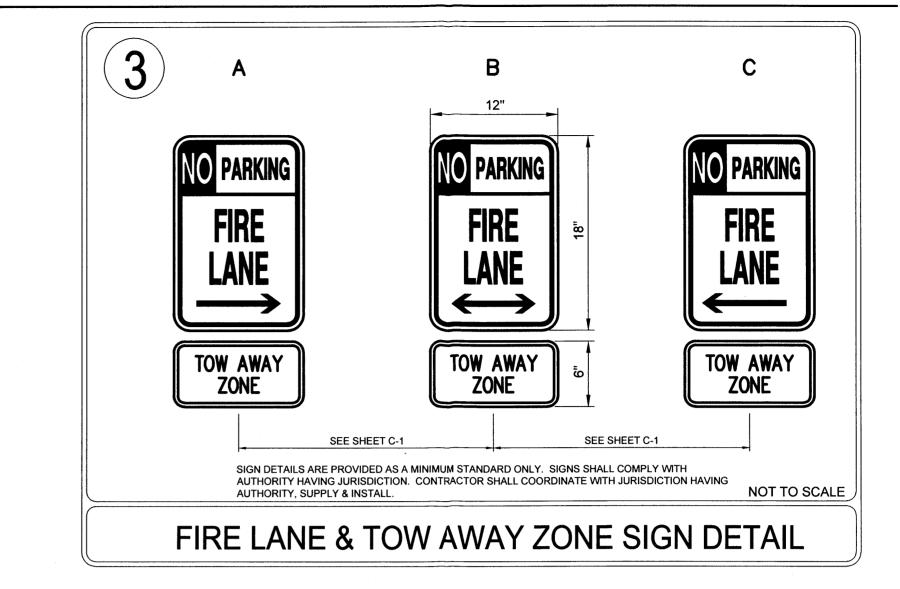

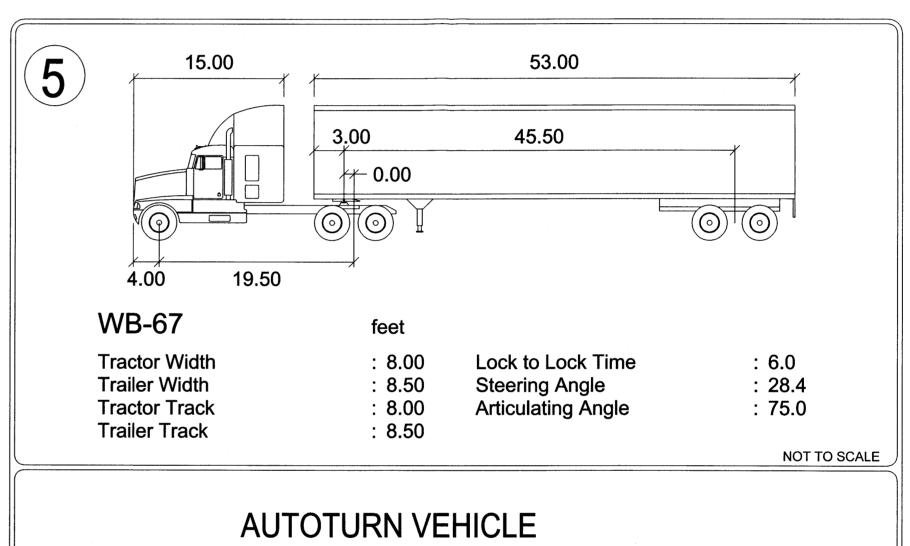


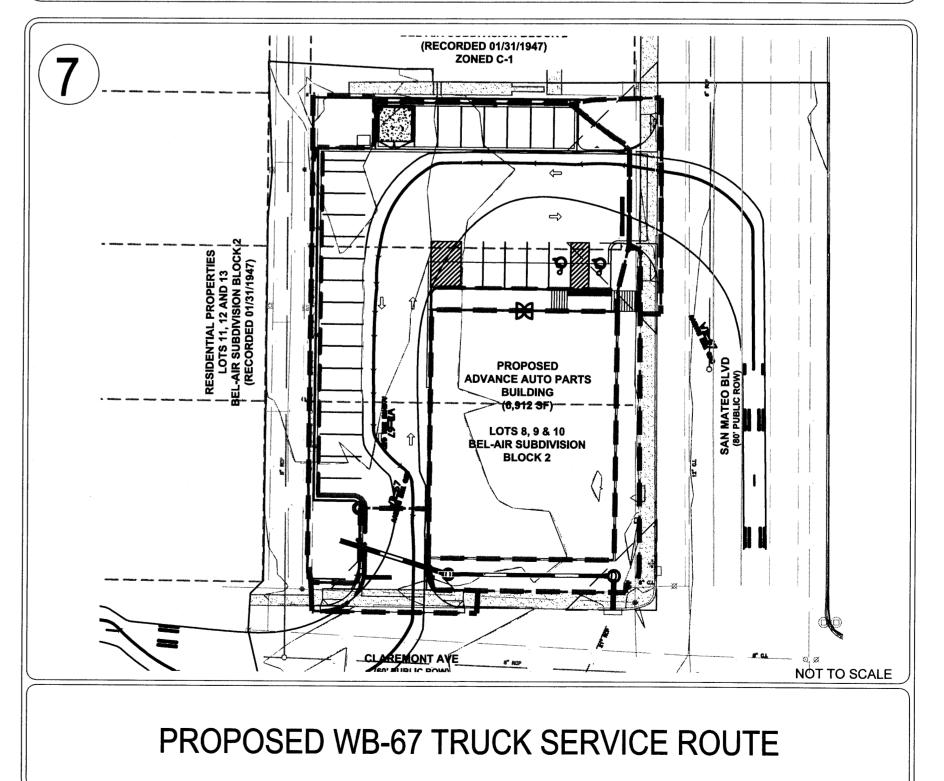

08/07/201

C1.3

SHEET 2 OF 2

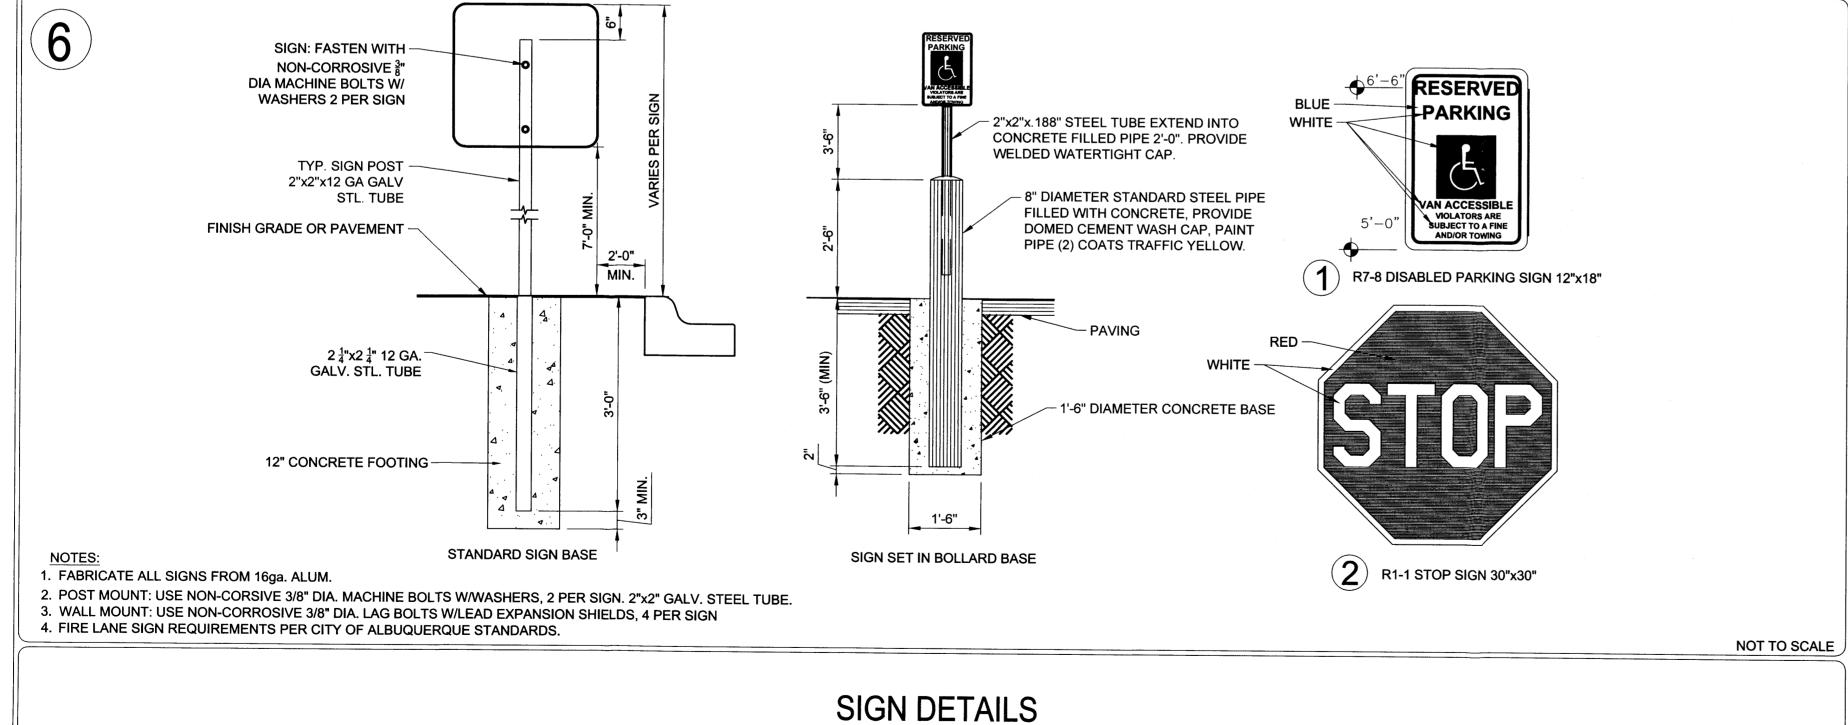


ALL CORNERS FOUND IN PLACE AND HELD WERE TAGGED WITH A BRASS DISK STAMPED "LS 8686" OR WERE ILLEGIBLE UNLESS OTHERWISE INDICATED HEREON. ALL CORNERS THAT WERE SET ARE EITHER A 1/2" REBAR WITH CAP STAMPED "PS 14269" OR SET CHISELED "+" IN CONCRETE.

VERTICAL DATUM IS BASED UPON THE ALBUQUERQUE CONTROL SURVEY BENCHMARK "21-H18", ELEVATION = 5215.209 (NAVD

PROJECT BASIS OF BEARING

NEW MEXICO STATE PLANE GRID SYSTEM, AND OUR PROJECT BEARING IS "S 00D 03' 32" E" ALONG THE WESTERLY RIGHT OF WAY LINE OF SAN MATEO BOULEVARD, NE.

I, DAVID SOULE, NMPE 14522, HAVE PERSONALLY INSPECTED THE COMPLETED SITE. I HEREBY CERTIFY THE SITE HAS BEEN CONSTRUCTED IN SUBSTANTIAL COMPLIANCE TO THE APPROVED PLAN. ALL AS BUILT DEVIATIONS FROM THE APPROVED PLAN HAS BEEN SHOWN ON THIS PLAN.

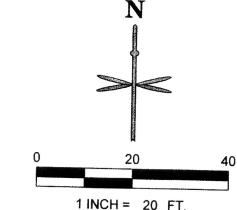

4/8/16 TRAFFIC CIRCULATION LAYOUT PROJECT INFORMATION **HEART & SOLE SPORTS** APPROVED **BEL-AIR SUBDIVISION BLOCK 2** ADDRESS: (RECORDED 01/31/1947) **~(26)** 2803, 2807 & 2813 SAN MATEO BLVD. **ZONED C-1 ALBUQUERQUE, NM 87110** SITE TRIANGLE - 35'X35' (FINAL ADDRESS ASSIGNMENT T.B.D UPON (SEENOTE 19) COMPLETION OF PLAT BY OTHERS) ALL WHEELCHAIR RAMPS LOCATED LEGAL DESCRIPTION: WITHIN THE PUBLIC RIGHT OF WAY LOTS NUMBERED EIGHT (8), NINE (9), AND TEN (10) IN BLOCK MUST HAVE TRUNCATED DOMES. NUMBERED TWO (2) OF THE PLAT OF BLOCKS 1-44 INCLUSIVE OF BEL-AIR, A SUBDIVISION OF A TRACT OF LAND IN SCHOOL DISTRICTS NUMBERS 13 AND 22, BERNALILLO COUNTY, NEW Public Infrastructure shown MEXICO, AS THE SAME IS SHOWN AND DESIGNATED ON THE MAP on these plans for information only and not part of approval.

Separate DRC/Permit approval
and Work Order required. OF SAID SUBDIVISION, FILED IN THE OFFICE OF THE COUNTY CLERK OF BERNALILLO COUNTY, NEW MEXICO, ON JANUARY 31, SITE ACREAGE: FORMER LOTS 8, 9, 10: 0.18 ACRES, 0.17 ACRES, 0.20 ACRES PROPOSED SITE: 0.55 ACRES PLANNING INFORMATION: **ZONE ATLAS PAGE H-17** SITE TRIANGLE - 35'x35' LAND USE ZONING IS C-1 (SEE NOTE 19) **PARKING SUMMARY:** REQUIRED AUTOMOBILE PARKING SPACES (1/200 SF)* ADA SPACES (1 PER 25 AUTOMOBILE SPACES) PROPOSED MOTORCYCLE PARKING SPACES (4'X18' MIN) **ADVANCE AUTO PARTS BICYCLE PARKING** BUILDING PROVIDED (6,912 SF) ---- STANDARD SPACES ADA HANDICAP STANDARD SPACES LOTS 8, 9 & 10 ADA HANDICAP VAN ACCESSIBLE SPACES A 80. **BEL-AIR SUBDIVISION TOTAL AUTOMOBILE SPACES*** MOTORCYCLE PARKING SPACES 4.5'X18' BLOCK 2 **BICYCLE PARKING** *SEE APPROVED VARIANCE 15ZHE-80127 BELOW **APPROVED VARIANCES:** 11' 11' 11' 15ZHE-80124: REMOVAL OF WEST 10' LANDSCAPE BUFFER 15ZHE-80126: REMOVAL OF NORTH 6' LANDSCAPE BUFFER (12) 15ZHE-80127: REDUCTION OF REQUIRED PARKING SPACES TO 28 PRINCED CANADO PROMERO CINCADA TRADESSO NATURAN MANAGOS TRADESSO ARRESTO ARRES **LEGEND** -SIGHT TRIANGLE - 111X11 SIGHT TRIANGLE #1111 (28) 26)-/ SIGHT TRIANGLE - 35'x35' (SEE NOTE 19)

	PROPOSED RETAINING WALL			
	PROPOSED EASEMENT			
	PROPERTY LINE			
	PROPOSED BUILDING			
•	PROPOSED SIGN			
9	PARKING COUNT			
	EXISTING CURB AND GUTTER			
	PROPOSED 6" STANDARD CURB AND GUTTER			
φ	EXISTING SITE LIGHTING			
G-	PROPOSED SITE LIGHTING			
4 4	PROPOSED CONCRETE WALK (SEE DETAIL SHEET C1.3)			
U o	PROPOSED INLET			
•	PROPOSED 4' STORM MANHOLE			
0	EXISTING SANITARY/STORM MANHOLE			
(DENOTES TRAFFIC FLOW PATTERNS (NO ACTUAL STRIPING)			
	FIRE LANE CURB PAINT			
	HEAVY DUTY ASPHALT			

= 35

= 2

= 2


= 1

= 1

= 28

= 2

= 2

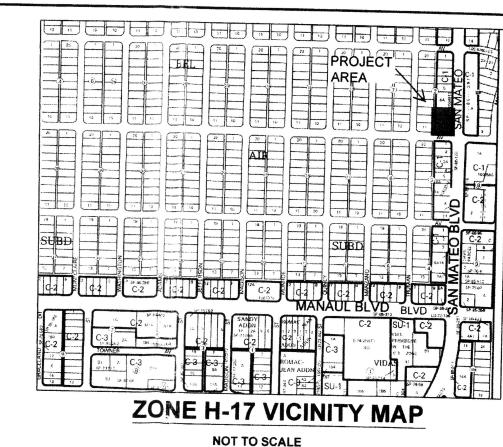

SITE SCHEDULE

- 1) PROPOSED 1' SAWCUT OFFSET FROM PROPOSED CURB/GUTTER AND VALLEY GUTTER.
- PROPOSED STANDARD 6" CURB AND GUTTER PER COA STANDARD DRAWING 2415A MODIFIED TO A 1' GUTTER PAN.
- (3) PROPOSED 6' VALLEY GUTTER PER COA STANDARD DRAWING 2420 AND 2426.
- (4) HATCHED AREA TO REPRESENT LOADING AREA LOCATION FOR SITE PLAN REVIEW PURPOSES ONLY. NO ACTUAL STRIPING PROPOSED.
- (5) PROPOSED 10'X1.5' SOLID WHITE STOP BAR.
- (6) PROPOSED ADA RAMP
- 7) PROPOSED ADA STANDARD HANDICAP PARKING SIGN.
- (8) PROPOSED TACTILE WARNING PANEL 2'X17' AND 2'X8'.
- 9 SCREENED AREA DEFINES ADA COMPLIANT ZONE OF ACCESSIBILITY FROM BUILDING FRONT ENTRANCE TO HANDICAP PARKING STALLS. CROSS SLOPES NOT TO EXCEED 2% IN ALL DIRECTIONS. "NO PARKING" LETTERING NOT SHOWN. SEE DETAIL SHEET.
- (10) PROPOSED TRASH ENCLOSURE W/6' SCREEN WALL.
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- (14) PROPOSED CONCRETE WALK.
- (15) PROPOSED RETAINING WALL AND SCREENING FENCE. MAXIMUM HEIGHT OF RETAINING WALL 3', MAX. COMBINED HEIGHT OF WALL AND FENCE 6' (293' LONG).
- (16) EXISTING LIGHT POLE TO BE RELOCATED OUTSIDE OF THE DRIVEWAY CUT BY THE CONTRACTOR.
- (17) PROPOSED 2' CONCRETE ALLEY GUTTER PER COA STANDARD DRAWING 2415A.
- (18) PROPOSED MOTORCYCLE PARKING STALL (4.5'X18').
- (19) PROPOSED 4'X5' BIKE RACK STAND. PROVIDES (2) BICYCLE SPACES
- (20) PROPOSED HEAVY DUTY ASPHALT PAVEMENT. SEE PAVEMENT SECTION
- (21) PROPOSED LIGHT DUTY ASPHALT PAVEMENT. SEE PAVEMENT SECTION
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- (28) EXISTING CURB CUTS NOT MODIFIED BY NEW CURB CUTS TO BE REPLACED WITH CURB, GUTTER AND WALL PER C.O.A. STANDARD DWG 2430.

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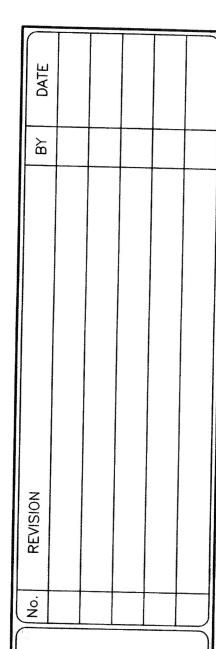
- (29) PEDESTRIAN DOORS TO BUILDING
- (30) ROLLER SHUTTER DOOR FOR DELIVERIES
- (31) WHEEL STOP


PAVEMENT SECTIONS

AUTOMOBILE PARKING AREAS (LIGHT DUTY PAVEMENT) 2 1/2" ASPHALT CONCRETE PAVEMENT (AC) OVER 6" ABC OR 5" PCC PER GEOTECHNICAL REPORT

DRIVE LANES (HEAVY DUTY PAVEMENT) 4" ASPHALT CONCRETE (AC) PAVEMENT OVER 6" ABC OR 5" PCC PER GEOTECHNICAL REPORT

PAVEMENT SECTION PER GEOTECHNICAL REPORT PREPARED BY TERRACON CONSULTANTS INC. PROJECT NUMBER 66155033 REFER TO GEOTECHNICAL REPORT.



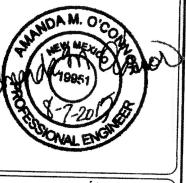



Ō ATION **AUTO** CIRCULA ADVA

PROJECT NO: CAD008.01 DESIGNED BY: DRAWN BY: 08/07/2015

NOTES 1. NO BIKE ROUTES OR PATHS EXIST ALONG FRONTAGE OF SAN MATEO BOULEVARD. 2. ALL CONSTRUCTION SHALL BE PERFORMED IN ACCORDANCE WITH STANDARD SPECIFICATIONS

OF CITY SITE OF ALBUQUERQUE.

5. SITE ASSUMES CIRCULATION OF WB-67 SEMI.

LOCAL REQUIREMENTS. SEE DETAIL SHEET

ONE-WAY TRAFFIC MOVEMENT

FFIC

C1.2 SHEET 1 OF 2

HANDICAP PARKING AREAS PROVIDED PER CITY STANDARDS AND SHALL COMPLY WITH REQUIREMENTS OF THE CURRENT ADOPTED UNIFORM BUILDING CODE. 8. UNLESS OTHERWISE NOTED, ALL RADII ON PARKING ISLANDS SHALL BE 3'. 9. CONTRACTOR SHALL REFER TO ARCHITECTURAL PLANS FOR PRECISE BUILDING DIMENSIONS SERVICE LOCATIONS.

AREA DIMENSIONS AND ELEVATIONS. REFERENCE M.E.P. FOR EXACT BUILDING UTILITY ENTRANCE 10. THE DISPOSAL OF DEMOLISHED ITEMS SHALL COMPLY TO ALL STATE AND LOCAL REQUIREMENTS. 11. MECHANICAL UNITS, DUMPSTER AND TRASH COMPACTORS SHALL BE SCREENED IN ACCORDANCE WITH THE CITY OF ALBUQUERQUE ZONING ORDINANCE.

3. EMERGENCY AND SERVICE TRUCKS WILL MANEUVER AROUND BUILDING DRIVE AISLES IN A

4. CARS/TRUCKS WILL MANEUVER AROUND BUILDING DRIVE AISLES IN A TWO-WAY TRAFFIC MOVEMENT.

6. UPON COMPLETION OF PAVING OPERATIONS THE CONTRACTOR SHALL INSTALL THE PAVEMENT STRIPES

AND PAVEMENT MARKINGS AS SHOWN HEREON. ON SITE PARKING STALL STRIPES SHALL BE 4" WIDE AND WHITE IN COLOR. HANDICAP STALL STALLS SHALL BE PAINTED AND SIGNED PER FEDERAL, STATE AND

CLAREMONT AVE

(60' PUBLIC ROW)

- - PAN) WILL OT BE ACCEPTABLE IN THIS AREA. THE FOLLOWING SIGHT TRIANGLE LENGTHS HAVE BEEN USED;
- PROTECTION MUST BE APPROVED BY THE FIRE MARSHALL PRIOR TO BUILDING PERMIT BEING ISSUED. CONTRACTOR TO COORDINATE ALL FIRE LANE MARKINGS WITH THE ALBUQUERQUE AND NEW MEXICO DEPARTMENT OF TRANSPORTATION STANDARDS. 15. ALL DRIVEWAYS SHALL BE CONSTRUCTED IN ACCORDANCE WITH CITY OF ALBUQUERQUE AND NEW MEXICO DEPARTMENT OF TRANSPORTATION STANDARDS.

14. FIRE LANE STRIPING, "NO PARKING FIRE LANE" MARKING SHALL CONSIST OF A SIX (6) INCH WIDE RED STRIPE

ALONG THE CURB ON THE WEST SIDE OF THE BUILDING. THE WORDS "NO PARKING FIRE LANE" SHALL BE

MARKED ON THE SIGN IN FOUR (4) INCH HIGH WHITE LETTERS AT 25-FT. MAXIMUM INTERVALS STRIPING


AND LETTERS SHALL BE APPLIED ACCORDING TO THE CITY OF ALBUQUERQUE. FIRE LANE AND FIRE


16. ALL DIMENSIONS ARE MEASURED FROM FLOWLINE OF CURB, UNLESS NOTED OTHERWISE. 17. ALL ACCESSIBLE RAMPS SHALL HAVE A MAXIMUM SLOPE OF 12:1.

12. ALL SIGNAGE CONTINGENT UPON APPROVAL BY THE CITY OF ALBUQUERQUE.


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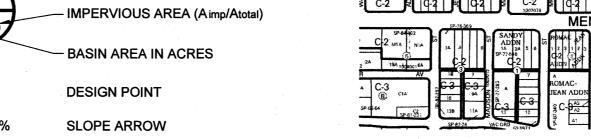
- 18. REFER TO PLAT FOR OFFICIAL EASEMENT LOCATIONS. 19. WALLS, LANDSCAPING AND SIGNAGE WILL NOT INTERFERE WITH CLEAR SIGHT REQUIREMENTS; THEREFORE, SIGNS, WALLS, TREES AND SHRUBBERY BETWEEN 3 AND 8 FEET TALL (AS MEASURED FROM THE GUTTER
- SAN MATEO & CLAREMONT (NW CORNER) 35 FEET CLEAR SITE BOTH SIDES • NORTHERN SITE ACCESS & SAN MATEO - 35 FEET CLEAR BOTH SIDES
- SOUTHERN SITE ACCESS & CLAREMONT AVENUE 11 FEET CLEAR BOTH SIDES (PER MINI CLEAR SITE TRIANGLE DETAIL).




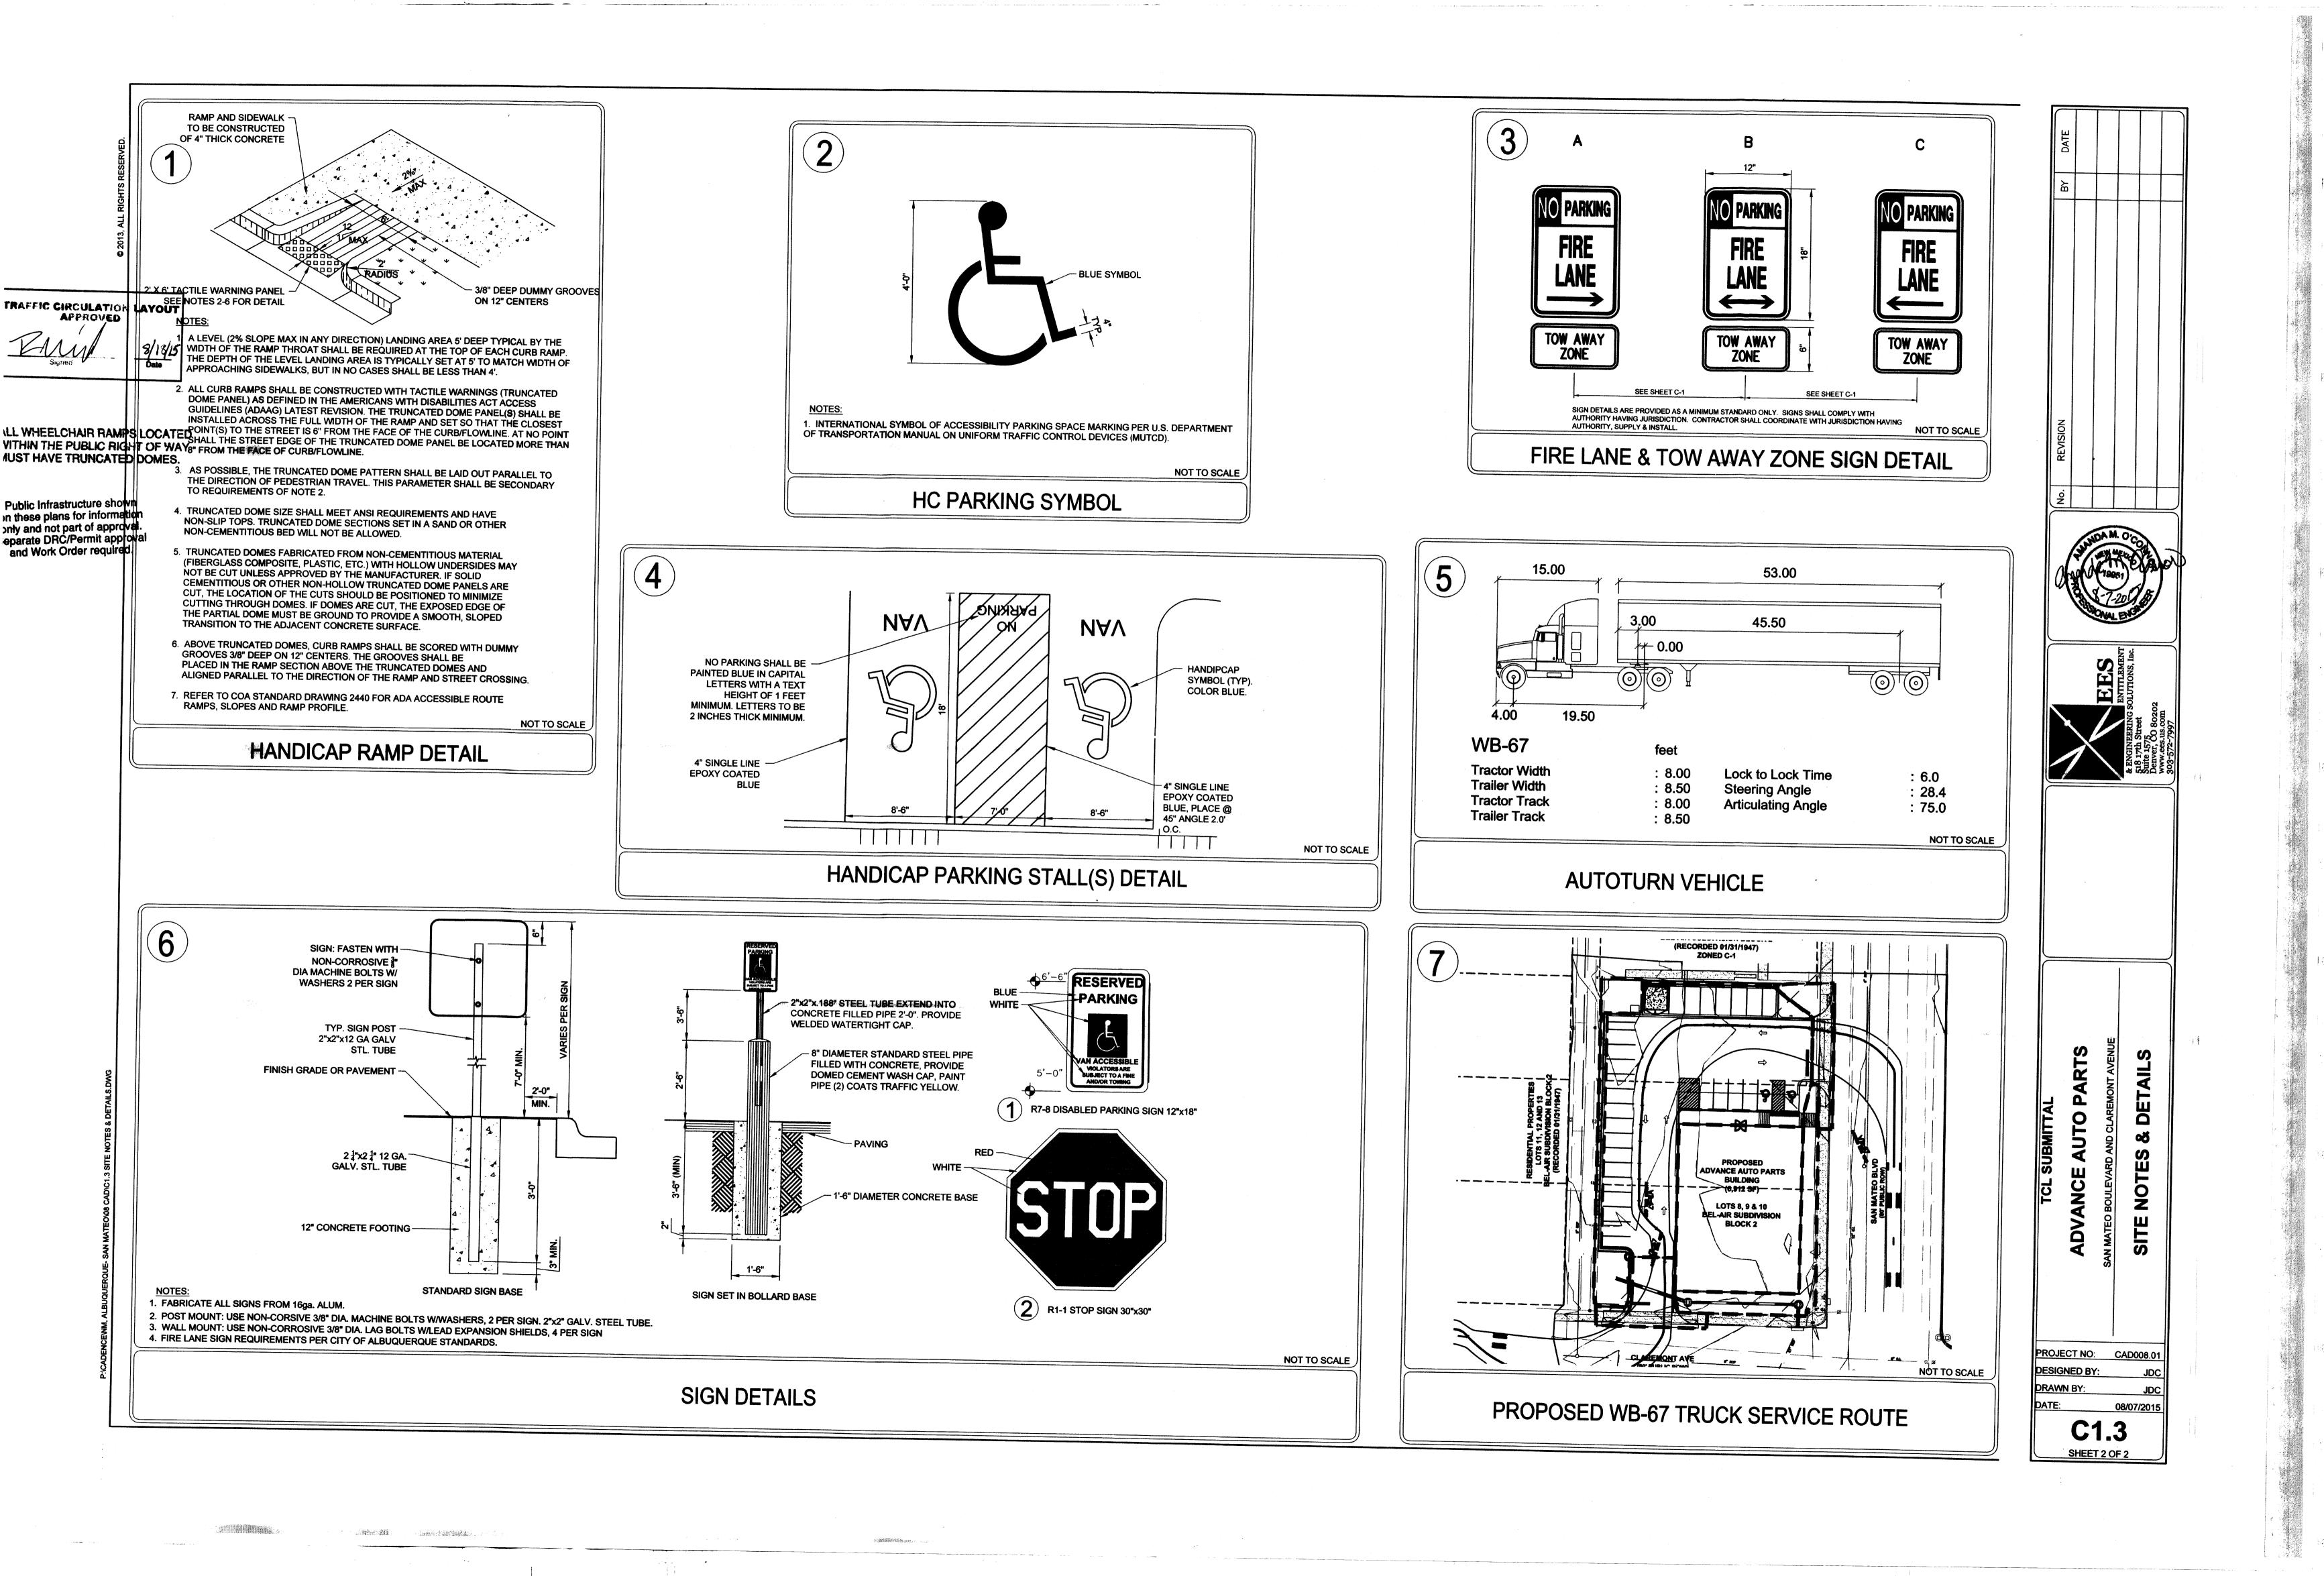

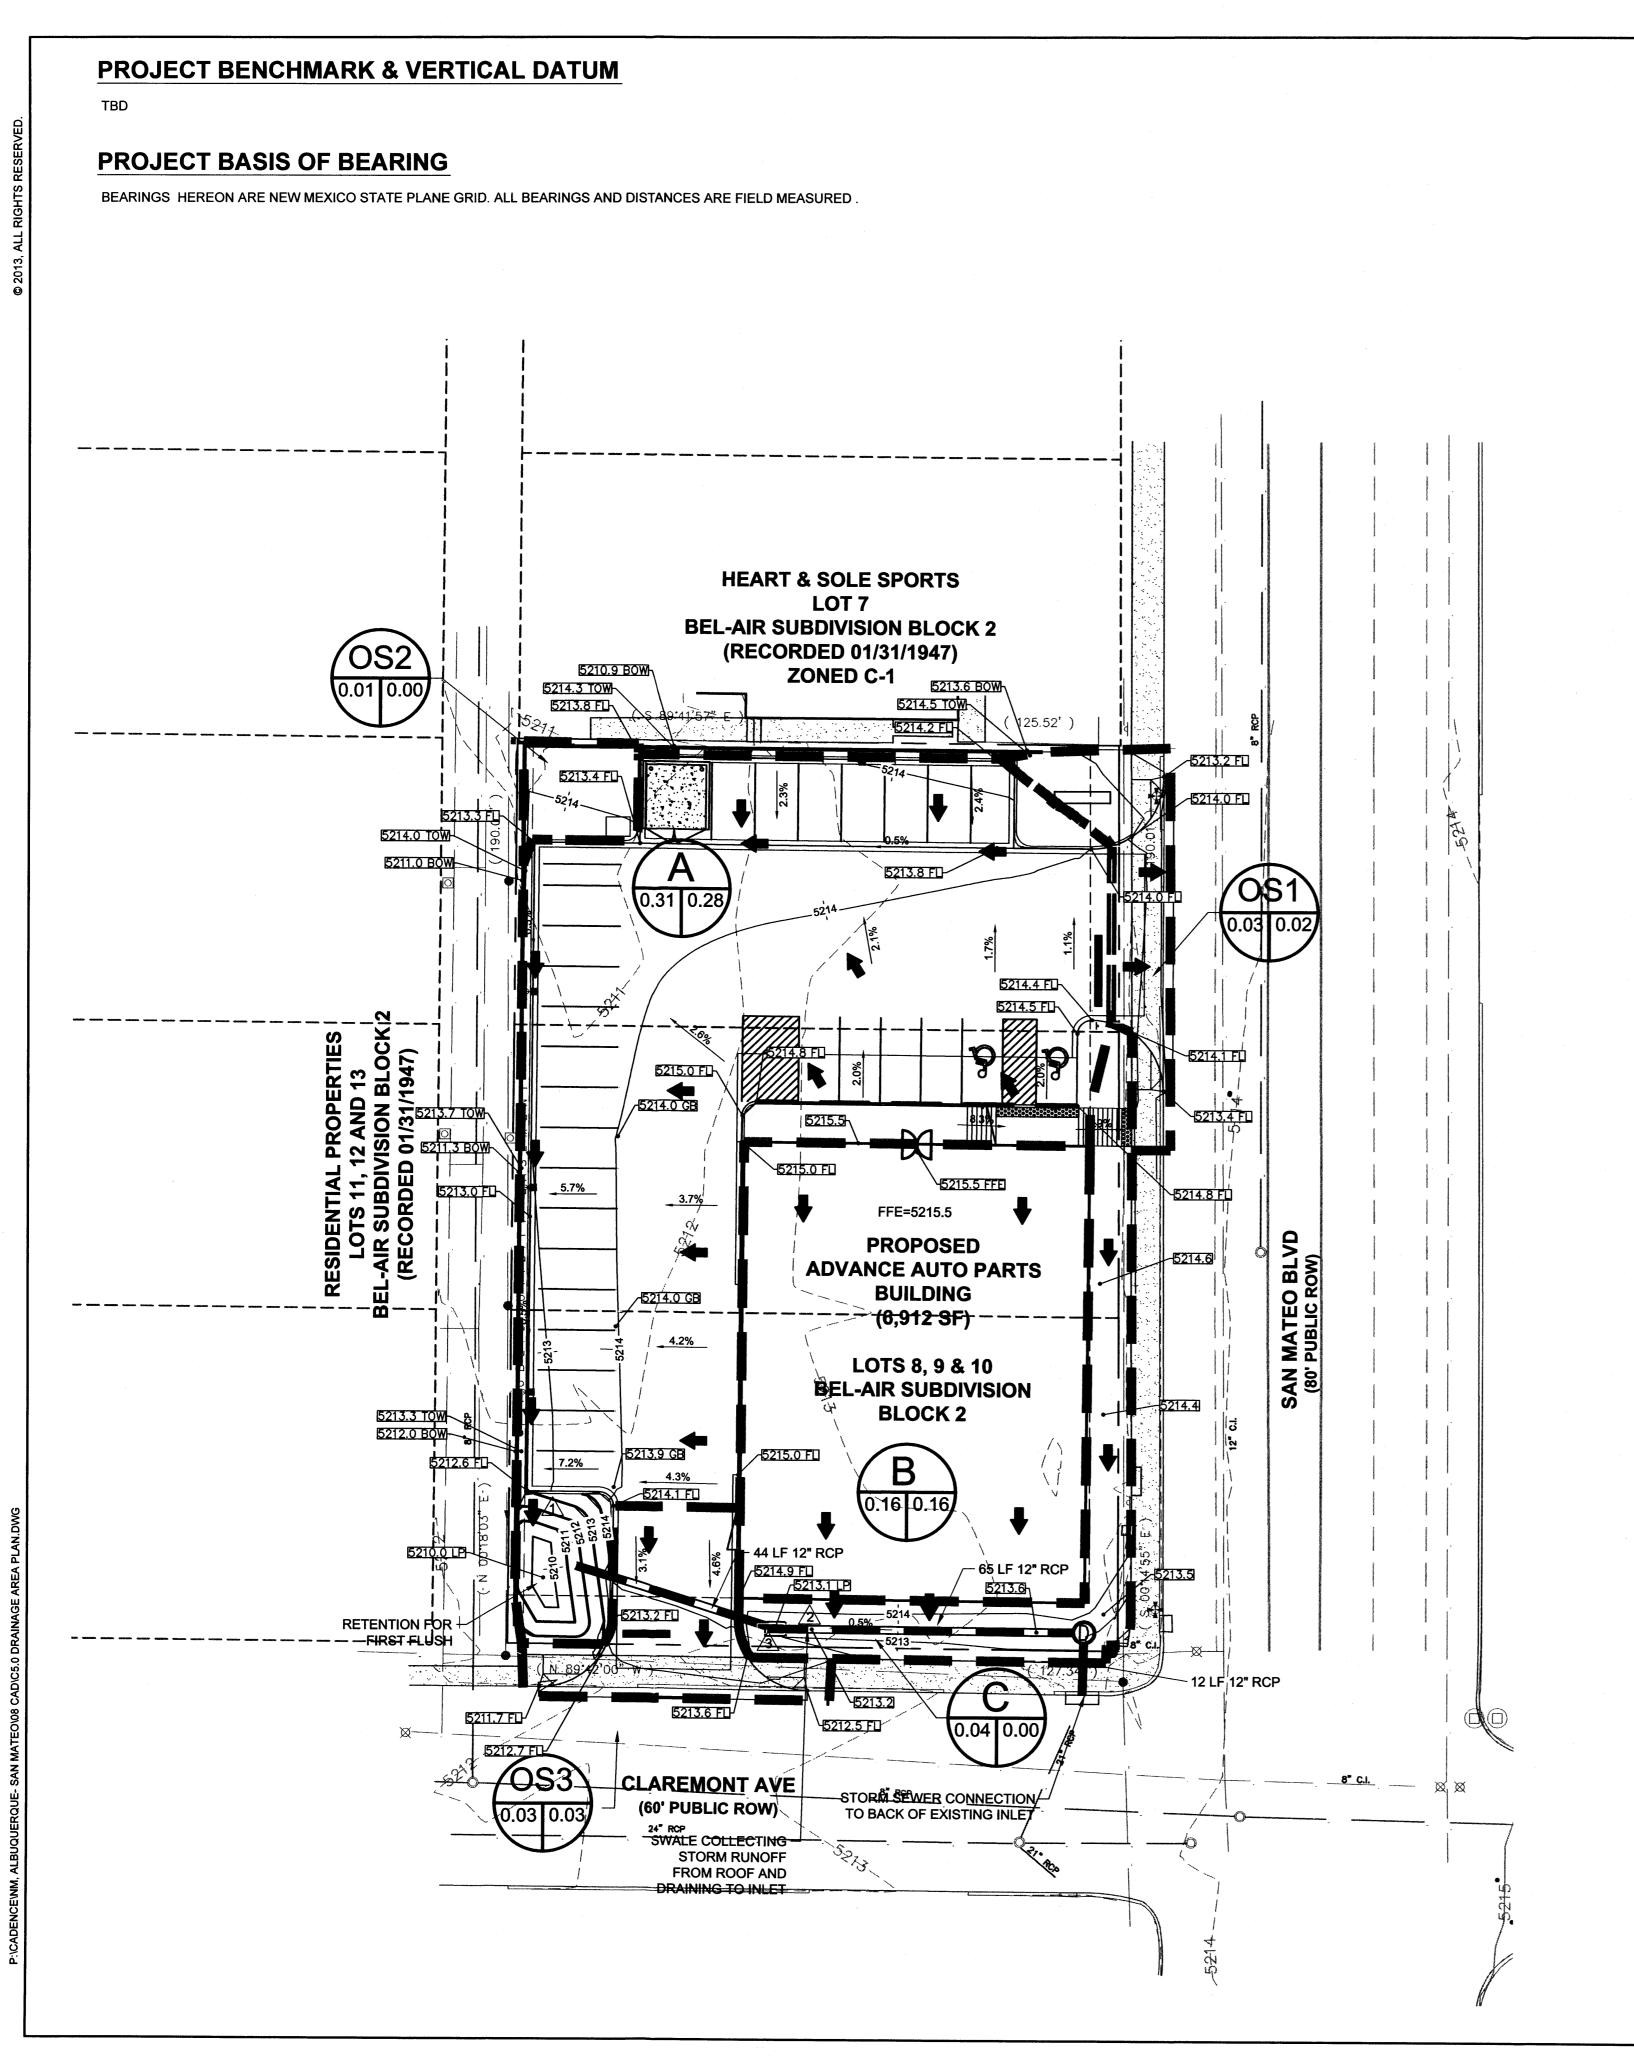
DRAINAGE LEGEND




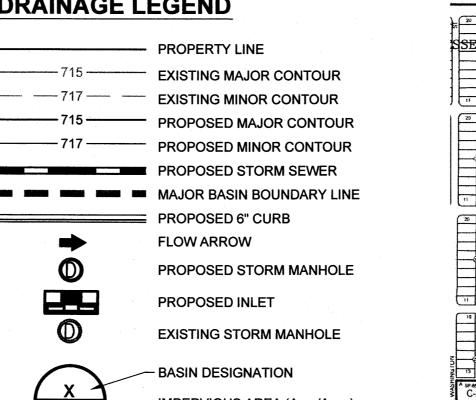


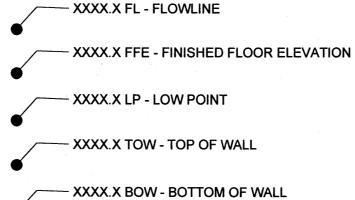

- XXXX.X GB - GRADE BREAK

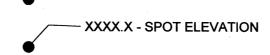

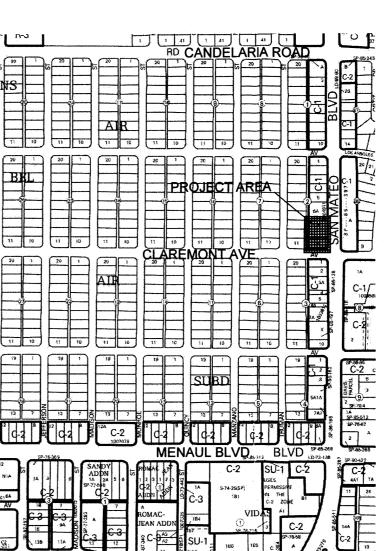


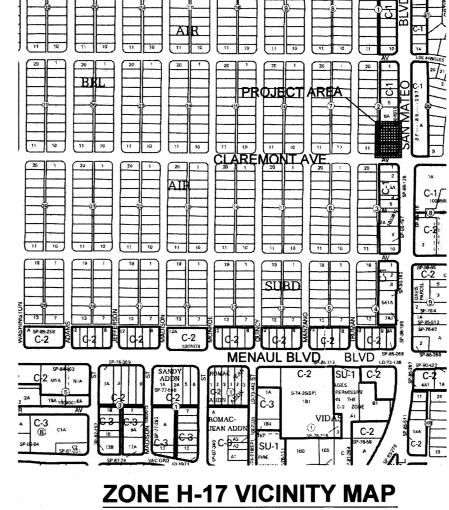

DRAINAGE NOTES:

	TABLE 1: BASIN SUMMARY RUNOFF TABLE					
BASIN	DESIGN POINT	CONTRIBUTING AREA (AC)	IMPERVIOUS AREA (AC)**	BASIN IMPERVIOUSNESS	10-YEAR PEAK FLOW (CFS)	100-YEAR PEAK FLOW (CFS)
Α	1	0.31	0.28	91.3%	0.91	1.38
B*	2	0.16	0.16	100.0%	0.50	0.75
С	3	0.04	0.00	0.0%	0.04	0.10
OS1		0.03	0.02	74.9%	0.07	0.31
OS2		0.01	0.00	0.0%	0.01	0.27
OS3		0.03	0.03	89.9%	0.10	0.25

* FIRST FLUSH FROM ROOF CONNECTED DIRECTLY TO STORM SEWER VIA SWALE DUE TO CONSTRAINTS OF THE EXISTING STORM SEWER ELEVATIONS (NO RETENTION PROVIDED FOR THIS RUNOFF). ** AREA OF LAND TREATMENT D

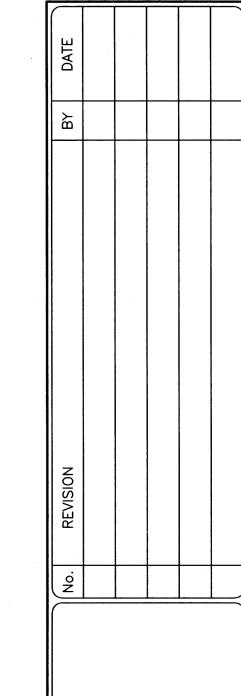

1 INCH = 20 FT.

DRAINAGE •გ GRADING

PROJECT NO: AAAXXX.XX DESIGNED BY:

C5.0 SHEET 1 OF XX

ALL CORNERS FOUND IN PLACE AND HELD WERE TAGGED WITH A BRASS DISK STAMPED "LS 8686" OR WERE ILLEGIBLE UNLESS OTHERWISE INDICATED HEREON. ALL CORNERS THAT WERE SET ARE EITHER A 1/2" REBAR WITH CAP STAMPED "PS 14269" OR SET CHISELED "+" IN CONCRETE.


VERTICAL DATUM IS BASED UPON THE ALBUQUERQUE CONTROL SURVEY BENCHMARK "21-H18", ELEVATION = 5215.209 (NAVD

PROJECT BASIS OF BEARING

NEW MEXICO STATE PLANE GRID SYSTEM, AND OUR PROJECT BEARING IS "S 00D 03' 32" E" ALONG THE WESTERLY RIGHT OF

PRIVATE DRAINAGE FACILITIES WITHIN CITY RIGHT-OF-WAY NOTICE TO CONTRACTOR (SPECIAL ORDER 19 ~ "SO-19")

- 1. AN EXCAVATION PERMIT WILL BE REQUIRED BEFORE BEGINNING ANY WORK WITHIN CITY RIGHT-OF-WAY.
- 2. ALL WORK ON THIS PROJECT SHALL BE PERFORMED IN ACCORDANCE WITH APPLICABLE FEDERAL, STATE AND LOCAL LAWS, RULES AND REGULATIONS CONCERNING CONSTRUCTION SAFETY AND HEALTH.
- 3. TWO WORKING DAYS PRIOR TO ANY EXCAVATION, THE CONTRACTOR MUST CONTACT NEW MEXICO ONE CALL, DIAL **"811"** [OR (505) 260-1990] FOR THE LOCATION OF EXISTING UTILITIES.
- 4. PRIOR TO CONSTRUCTION, THE CONTRACTOR SHALL EXCAVATE AND VERIFY THE LOCATIONS OF ALL OBSTRUCTIONS. SHOULD A CONFLICT EXIST, THE CONTRACTOR SHALL NOTIFY THE ENGINEER SO THAT THE CONFLICT CAN BE RESOLVED WITH A MINIMUM AMOUNT OF DELAY.
- 5. BACKFILL COMPACTION SHALL BE ACCORDING TO TRAFFIC/STREET USE.
- 6. MAINTENANCE OF THE FACILITY SHALL BE THE RESPONSIBILITY OF THE OWNER OF THE PROPERTY BEING SERVED.
- 7. WORK ON ARTERIAL STREETS SHALL BE PERFORMED ON A 24-HOUR BASIS.

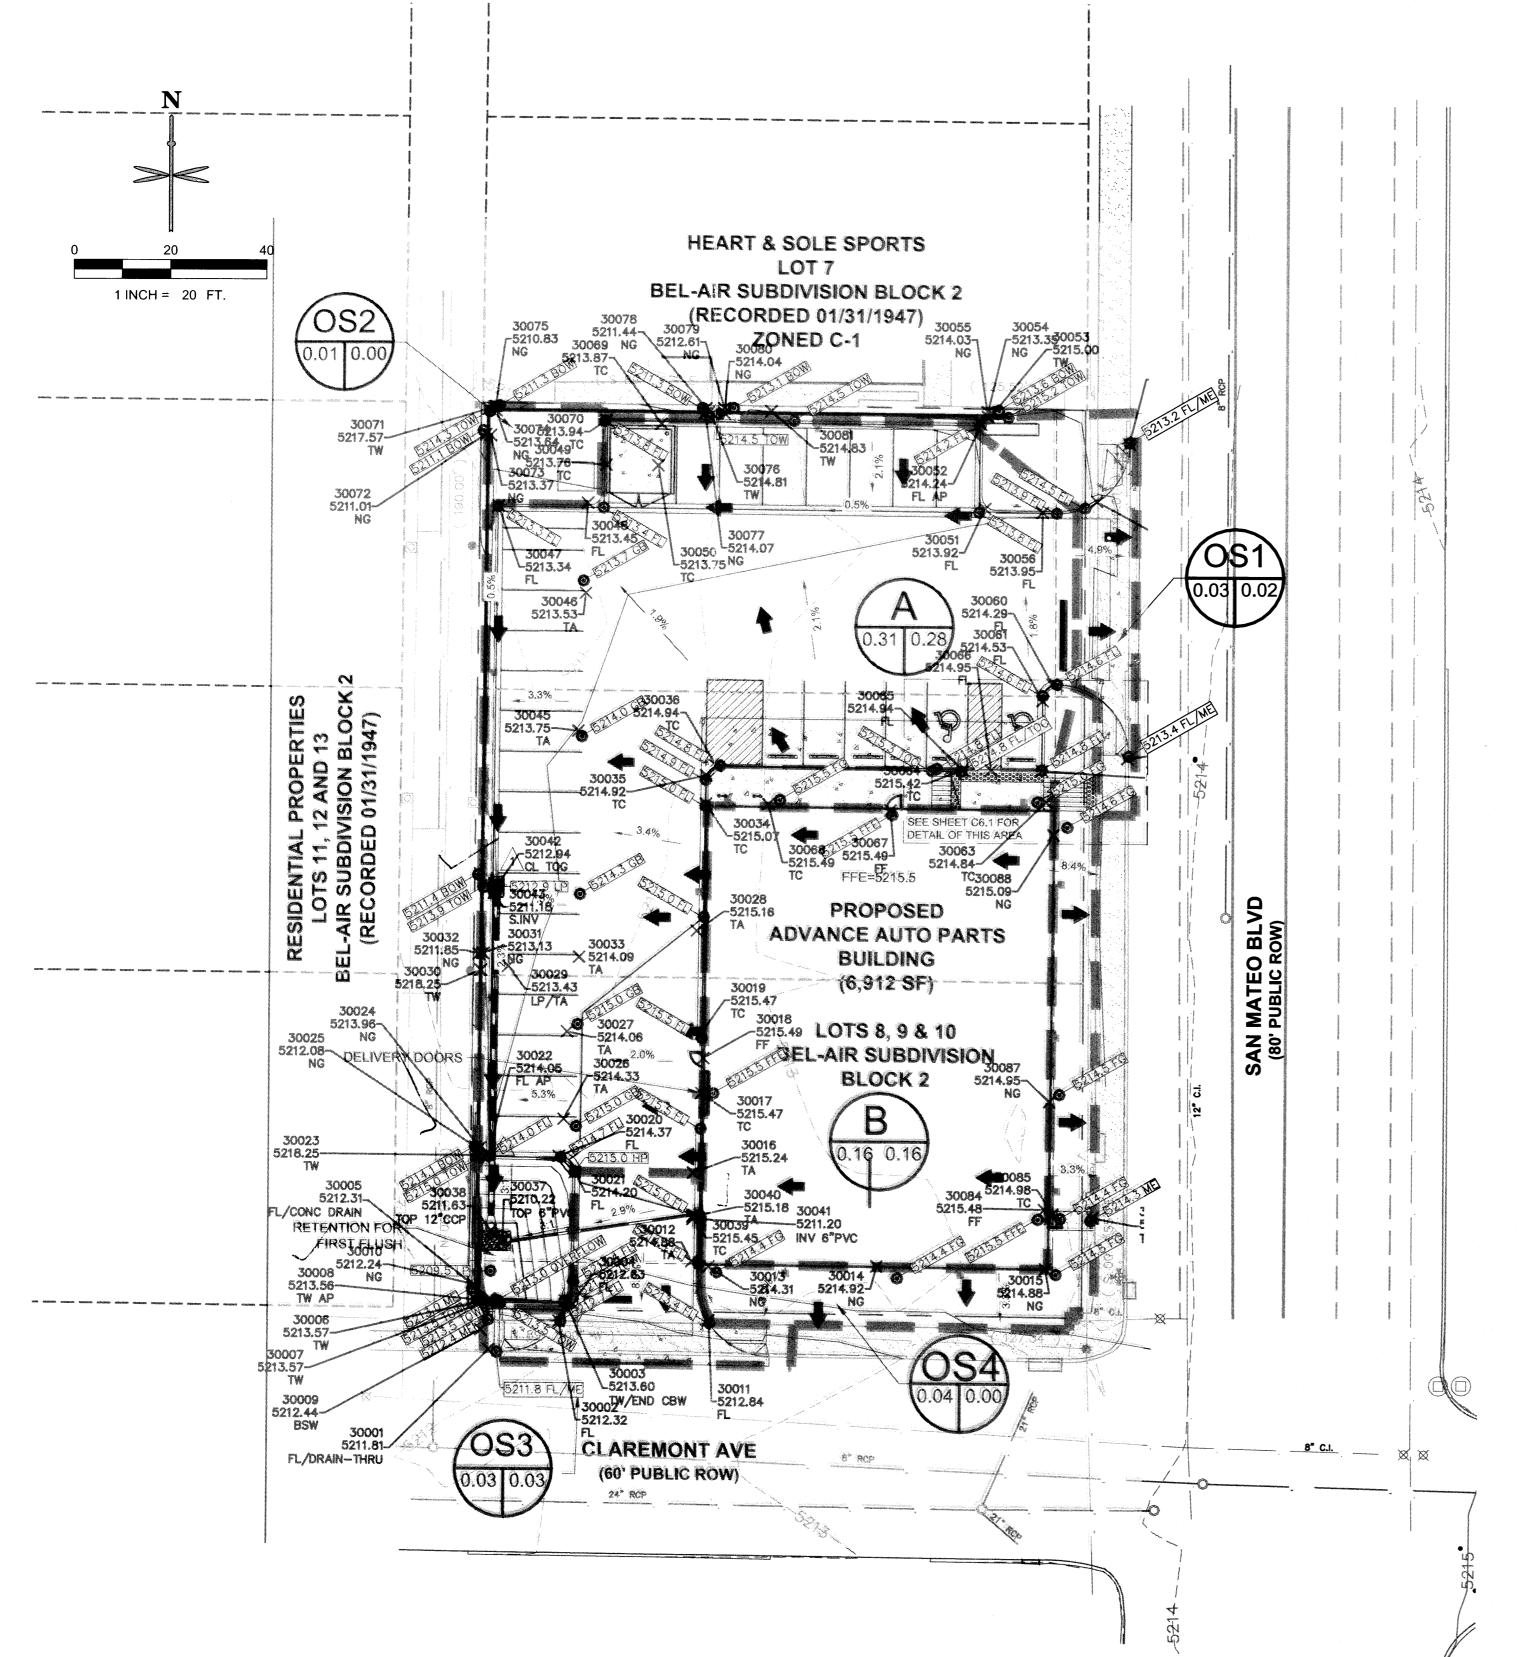

DRAINAGE NOTES:

TABLE 1: BASIN SUMMARY RUNOFF TABLE						
BASIN	DESIGN POINT	CONTRIBUTING AREA (AC)	IMPERVIOUS AREA (AC)**	BASIN IMPERVIOUSNESS	10-YEAR PEAK FLOW (CFS)	100-YEAR PEAK FLOW (CFS)
Α		0.31	0.28	91.3%	0.91	1.38
В	1	0.16	0.16	100.0%	0.50	0.75
OS1*		0.03	0.02	74.9%	0.07	0.31
OS2*		0.01	0.00	0.0%	0.01	0.27
OS3		0.03	0.03	89.9%	0.10	0.25
OS4*		0.04	0.00	0.0%	0.04	0.10

* BASIN CONSIST OF ENTIRELY LANDSCAPED AREA (OS2 & OS4) OR PARTIALLY LANDSCAPED AREA (OS1). ** AREA OF LAND TREATMENT D

DRAINAGE LEGEND

	EXISTING MINOR CONTOUR
715 ——	PROPOSED MAJOR CONTOUR
717 ———	PROPOSED MINOR CONTOUR
	PROPOSED STORM SEWER
	MAJOR BASIN BOUNDARY LINE
	PROPOSED 6" CURB
→	FLOW ARROW
•	PROPOSED STORM MANHOLE
©	EXISTING STORM MANHOLF

BASIN DESIGNATION

BASIN AREA IN ACRES

DESIGN POINT

- XXXX.X FFE - FINISHED FLOOR ELEVATION

XXXX.X FG - FINISHED GRADE SPOT ELEVATION

XXXX.X FL - FLOWLINE

- XXXX.X LP - LOW POINT

XXXX.X TOW - TOP OF WALL

XXXX.X GB - GRADE BREAK

XXXX.X BOC - BACK OF CURB

- XXXX.X ME - MATCH EXISTING

- XXXX.X BOW - BOTTOM OF WALL

XX.XX%

IMPERVIOUS AREA (Aimp/Atotal)

PROPERTY LINE — 715 — EXISTING MAJOR CONTOUR


> I David Soule, NMPE 14522, of the firm Rio Grande Engineering, hereby certify that this project has been graded and will drain in substantial compliance with and in accordance with the design intend of the approved plan dated8/7/15The record information edited on the original design document has performed by me or under my direct supervision and is true and correct to the best of my knowledge and belief. The asbuilt survey was provided thomas johnson 14269 . The certification is submitted in support of a request for PERMANENT CERTIFICATE OF. The record information presented heron is not necessarily complete and intended only to verify substantial compliance of the grading and drainage aspects of this project. Those relying on this record document are advised to obtain independent verification of its accuracy before

using it for any other purpose.
Southwist of the way excepts Ada slope is less than approved plan


ZONE H-17 VICINITY MAP

CLAREMONT AVE




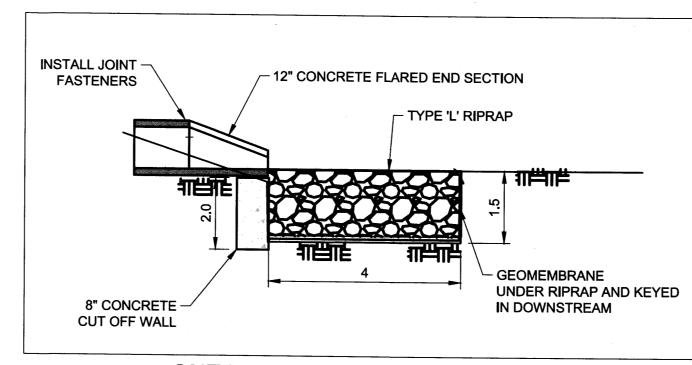

OUTFALL PROTECTION DETAIL NOT TO SCALE

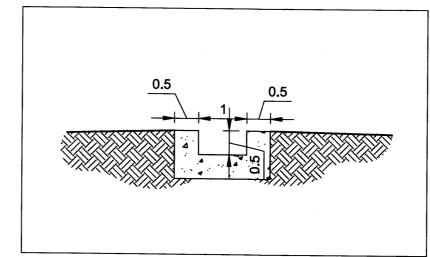

CONCRETE DRAINAGE PAN DETAIL NOT TO SCALE

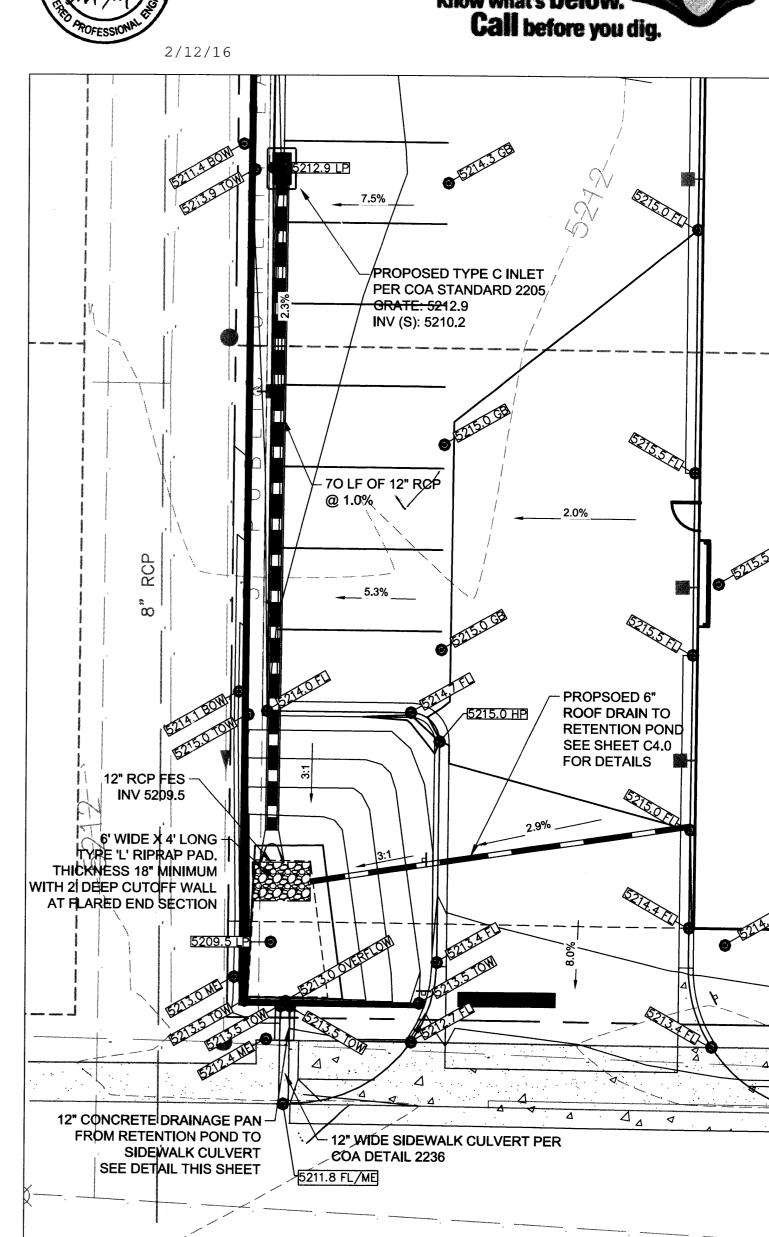

RETENTION POND & OUTFALL DETAIL

PROJECT NO: CAD008.01 C5.0

SHEET 7 OF 13

GRADING

DRAINAGE

SCALE 1" = 10' ND DEVELOPMENT SECTION

ALL CORNERS FOUND IN PLACE AND HELD WERE TAGGED WITH A BRASS DISK STAMPED "LS 8686" OR WERE ILLEGIBLE UNLESS OTHERWISE INDICATED HEREON. ALL CORNERS THAT WERE SET ARE EITHER A 1/2" REBAR WITH CAP STAMPED "PS 14269" OR


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PROJECT BASIS OF BEARING

NEW MEXICO STATE PLANE GRID SYSTEM, AND OUR PROJECT BEARING IS "S 00D 03' 32" E" ALONG THE WESTERLY RIGHT OF WAY LINE OF SAN MATEO BOULEVARD, NE.

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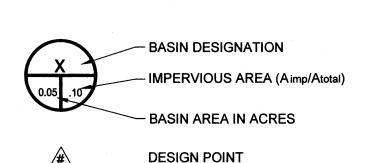
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^{*} BASIN CONSIST OF ENTIRELY LANDSCAPED AREA (OS2 & OS4) OR PARTIALLY LANDSCAPED AREA (OS1).
** AREA OF LAND TREATMENT D

DRAINAGE LEGEND

	PROPERTY LINE
715	EXISTING MAJOR CONTOUR
717 —	EXISTING MINOR CONTOUR
715	PROPOSED MAJOR CONTOUR
717 ———	PROPOSED MINOR CONTOUR
	PROPOSED STORM SEWER
	MAJOR BASIN BOUNDARY LINE
	PROPOSED 6" CURB
•	FLOW ARROW
•	PROPOSED STORM MANHOLE
•	EXISTING STORM MANHOLE

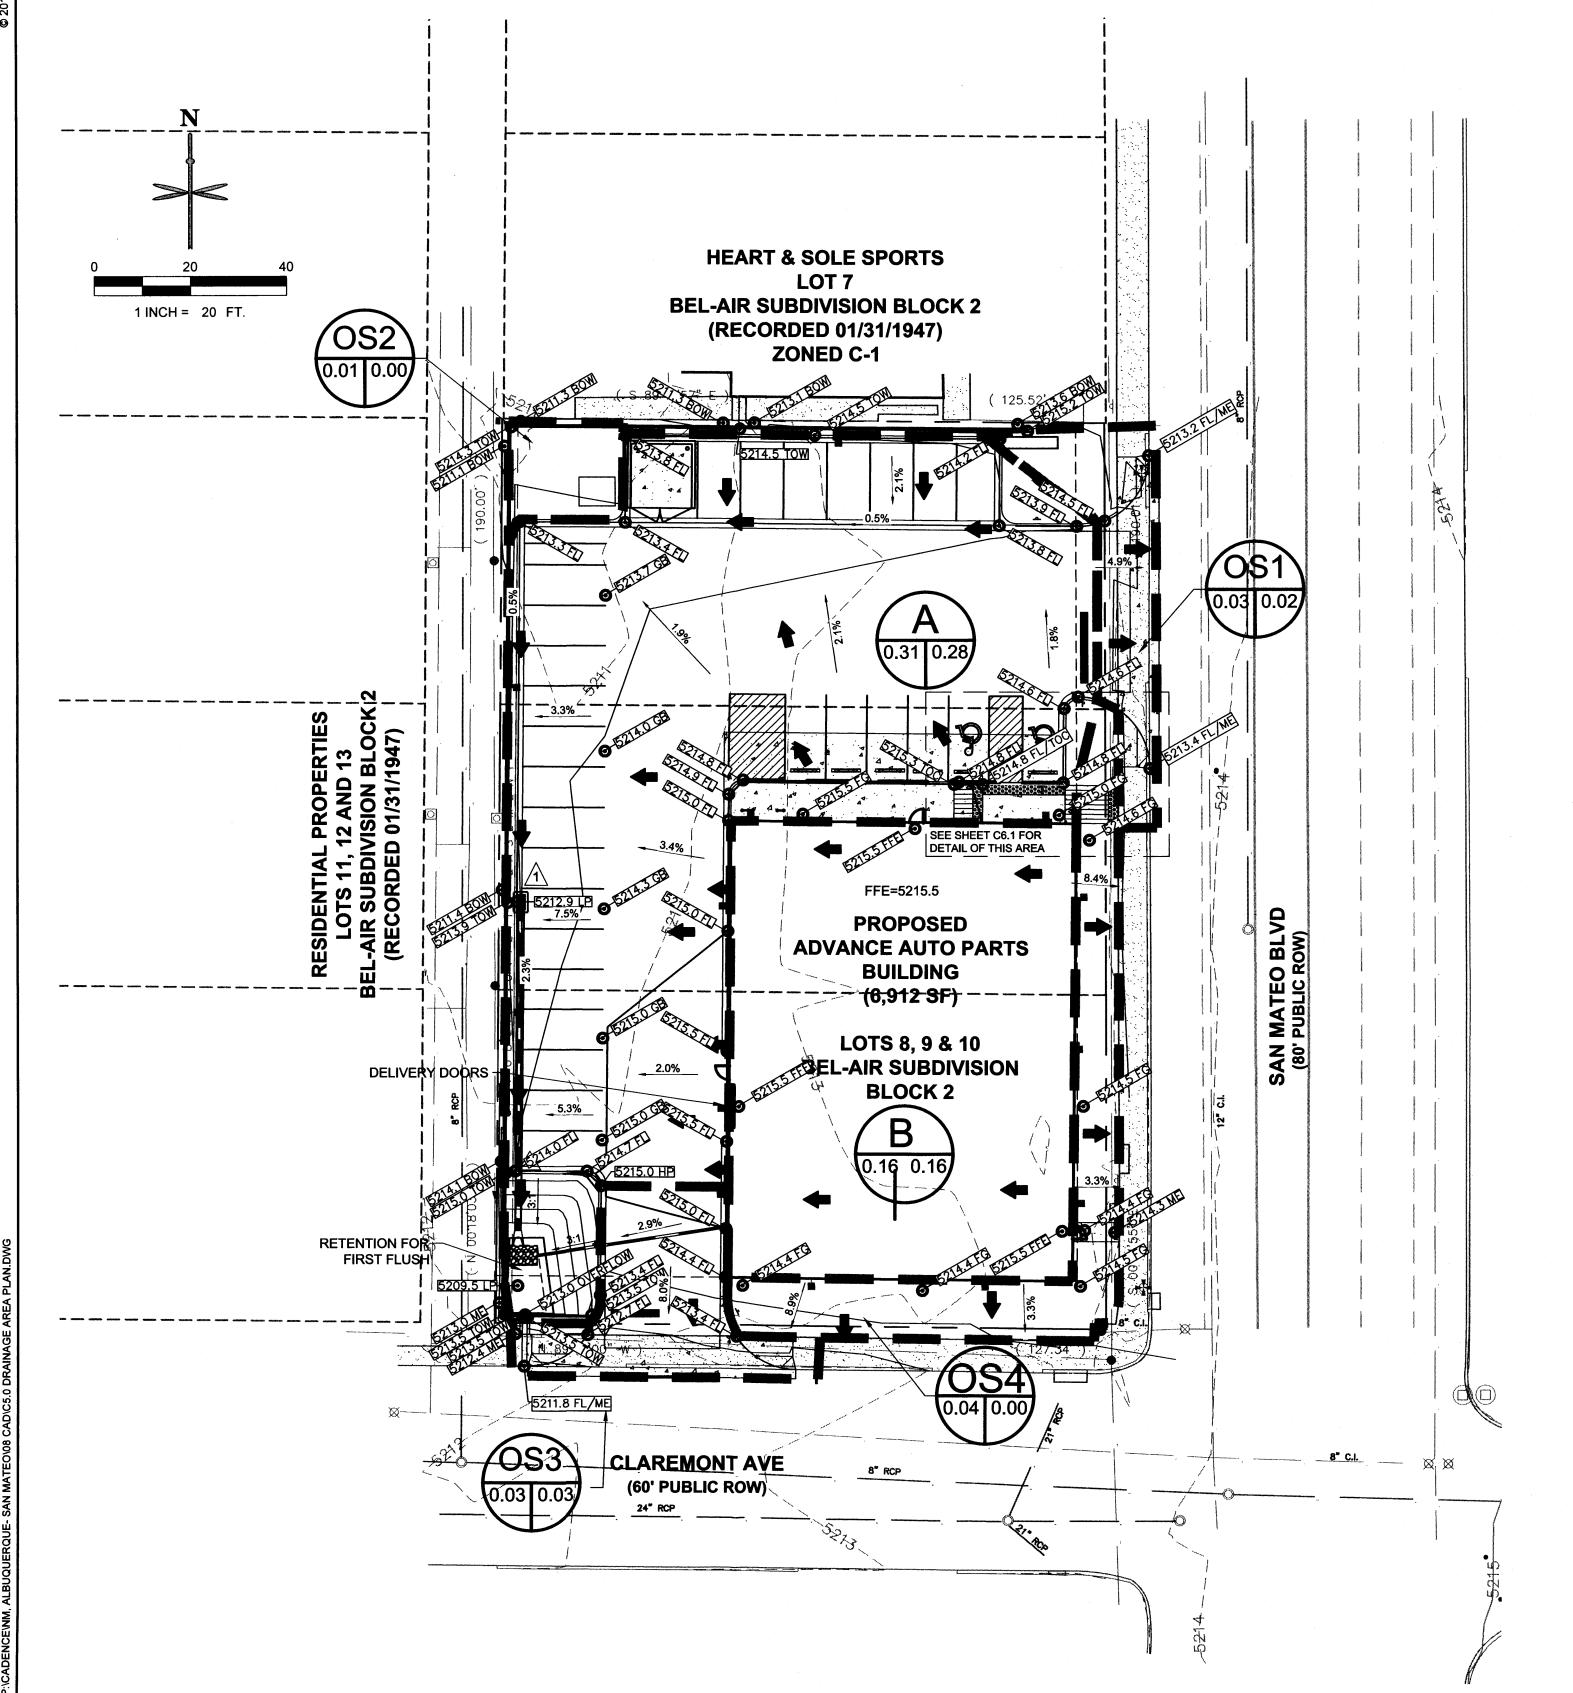

XX.XX% SLOPE ARROW

XXXX.X FL - FLOWLINE

XXXX.X FFE - FINISHED FLOOR ELEVATION

XXXX.X LP - LOW POINT

-- XXXX.X TOW - TOP OF WALL


XXXX.X BOW - BOTTOM OF WALL

XXXX.X GB - GRADE BREAK


XXXX.X FG - FINISHED GRADE SPOT ELEVATION

XXXX.X BOC - BACK OF CURB

XXXX.X ME - MATCH EXISTING

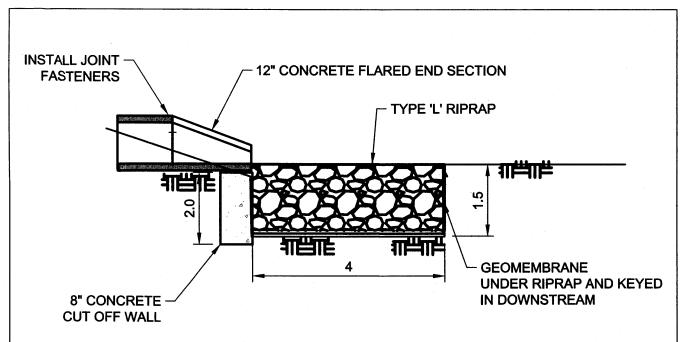

OUTFALL PROTECTION DETAIL NOT TO SCALE

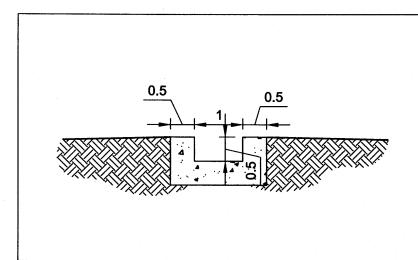


CONCRETE DRAINAGE PAN DETAIL
NOT TO SCALE



ZONE H-17 VICINITY MAP



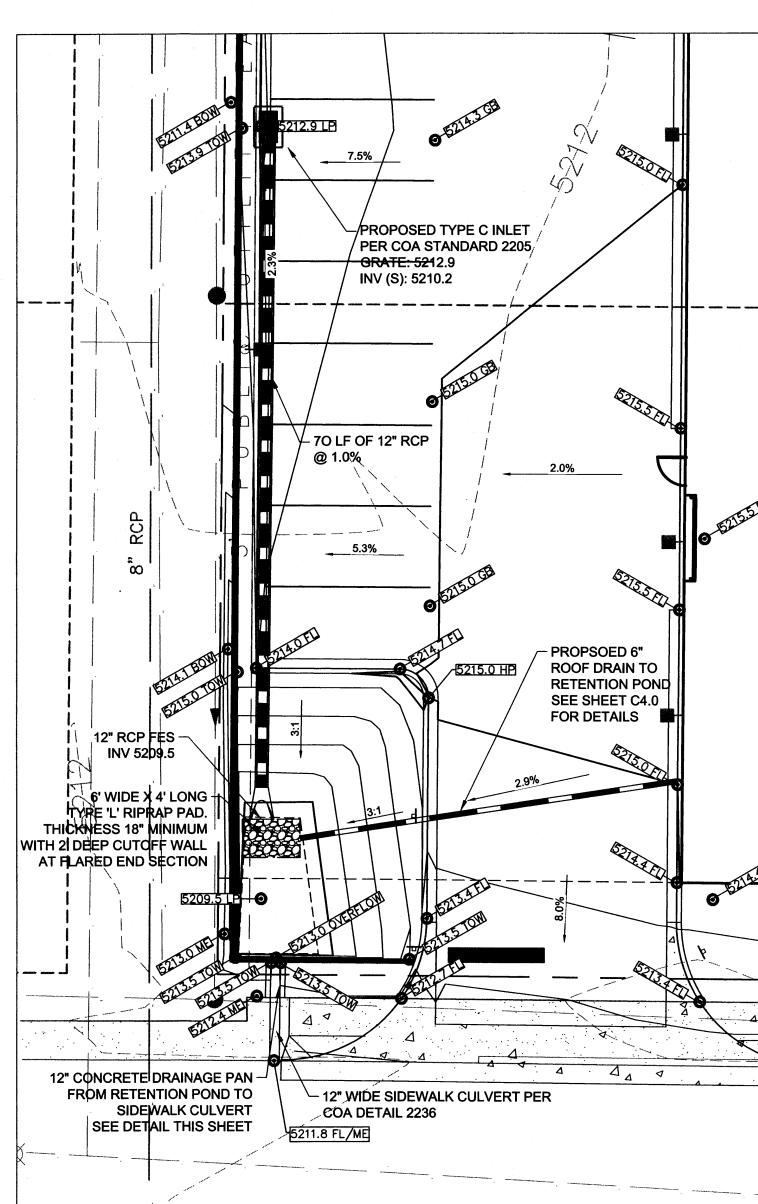

RETENTION POND & OUTFALL DETAIL


SCALE 1" = 10'

No. REVISION

BY D





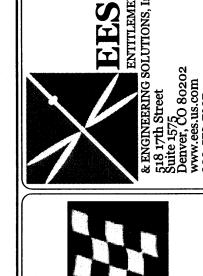



ADVANCE AUTO PARTS
AN MATEO BOULEVARD AND GRADING PLAN

PROJECT NO: CAD008.01

DESIGNED BY: JDC

DRAWN BY: JDC

DATE: 08/07/15

C5.0SHEET 7 OF 13