CITY OF ALBUQUERQUE

Planning Department Alan Varela, Interim Director



Mayor Timothy M. Keller

October 22, 2021

Ronald Bohannan, P.E. Tierra West, LLC 5571 Midway Park Place NE Albuquerque, NM 87109

RE: 5400 Menaul Blvd NE Grading and Drainage Plans Engineer's Stamp Date: 09/08/21 Hydrology File: H18D074

Dear Mr. Bohannan:

PO Box 1293 Based upon the information provided in your submittal received 09/08/2021, the Grading & Drainage Plan **is not** approved for Building Permit, Grading Permit, SO-19 Permit, and for action by the DRB on Site Plan for Building Permit. The following comments need to be addressed for approval of the above referenced project:

Albuquerque <u>SHEET C3.1</u>

NM 87103

www.cabq.gov

1. Please provide a vicinity map showing the location of the site. Typically this is the Zone Atlas. This can be downloaded in pdf format from the City of Albuquerque's website.

2. Please provide the weir calculations, per DPM Article 6-16(A), for the curb cuts and sidewalk culverts. A coefficient of 2.7 is typically used for the weir equation $Q = CLH^{2/3}$.

SHEET C3.2

- 3. Please contact Transportation. There are some existing drives that need to be closed on both Menaul and La Veta. Also, the ADA ramps may need to be brought up to current standards on Menaul.
- 4. Please show and label on both Menaul and La Veta where the existing drives are to be closed. This can be placed here or on C3.3.

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5. Please update the SO-19 Notes. See Attachment.

Drawing has been called out.

PO Box 1293

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7. Please add a note to the sidewalk culvert on the southwest corner of the site as "a private on-site sidewalk culvert". The City will only inspect the one in Menaul's R.O.W.

The Sidewalk Culvert detail does not need to be shown. The correct COA Standard

SHEET C3.3

6.


8. Provide a section through all proposed screen walls on the south side of the property. This needs to show proposed screen walls, footer within the property, property/ROW lines, existing and proposed grades, stormwater quality pond, and label the public alley. In accordance with DPM, grading and wall construction near the property line may not endanger adjacent property or constrain its use.

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As a reminder, if the project total area of disturbance (including the staging area and any work within the adjacent Right-of-Way) is 1 acre or more, then an Erosion and Sediment Control (ESC) Plan and Owner's certified Notice of Intent (NOI) is required to be submitted to the Stormwater Quality Engineer (Doug Hughes, PE, jhughes@cabq.gov, 924-3420) 14 days prior to any earth disturbance.

If you have any questions, please contact me at 924-3995 or <u>rbrissette@cabq.gov</u>.

Sincerely,

Renée C. Brissette

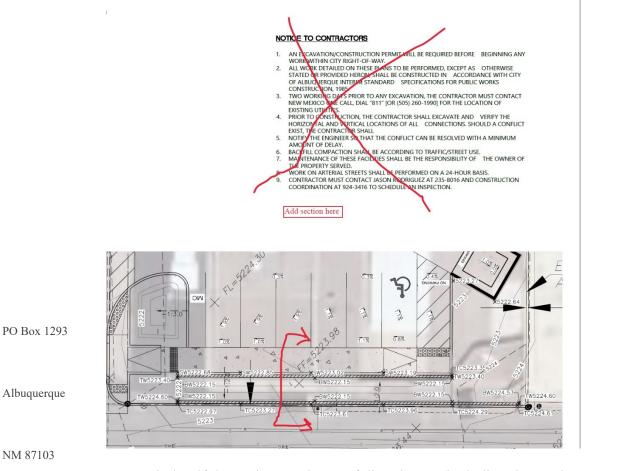Renée C. Brissette, P.E. CFM Senior Engineer, Hydrology Planning Department


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City of Albuquerque

Planning Department Development & Building Services Division


DRAINAGE AND TRANSPORTATION INFORMATION SHEET (REV 6/2018)

Project Title: 5400 Menaul	Building Pe	rmit #:	Hydrology File #:
DRB#:			
Legal Description: TR A PLAT OF TR A B			
City Address: 5400 Menaul Blvd NE, Albuqu	uerque, NM 87	110	
Applicant: Tierra West, LLC			Contact: Luis Noriega
Address: 5571 Midway Park PI NE, Albuque			
Phone#: 505-858-3100	Fax#: <u>505-8</u>	58-1118	E-mail: Inoriega@tierrawestllc.com
Other Contact:			Contact:
Address:			
Phone#:	Fax#:		E-mail:
TYPE OF DEVELOPMENT: PLAT	(# of lots)	RESIDENCE	DRB SITE 🖌 ADMIN SITE
IS THIS A RESUBMITTAL? Yes	No		
DEPARTMENT TRANSPORTATION	_∕_нүі	DROLOGY/DRAINAG	Έ
Check all that Apply: TYPE OF SUBMITTAL: ENGINEER/ARCHITECT CERTIFICATION PAD CERTIFICATION CONCEPTUAL G & D PLAN GRADING PLAN GRADING PLAN DRAINAGE REPORT DRAINAGE MASTER PLAN FLOODPLAIN DEVELOPMENT PERMIT ELEVATION CERTIFICATE CLOMR/LOMR TRAFFIC CIRCULATION LAYOUT (TCI TRAFFIC IMPACT STUDY (TIS) STREET LIGHT LAYOUT OTHER (SPECIFY) PRE-DESIGN MEETING?	APPLIC	 ✓ BUILDING CERTIFICA PRELIMINA SITE PLAN ✓ SITE PLAN ✓ SITE PLAN FINAL PLA GRADING GRADING GRADING/ WORK ORD CLOMR/LO FLOODPLA OTHER (SF 	ASE OF FINANCIAL GUARANTEE ON PERMIT APPROVAL PERMIT APPROVAL ROVAL ERMIT APPROVAL PAD CERTIFICATION ER APPROVAL
DATE SUBMITTED: <u>9/08/2021</u>	By: Luis		
COA STAFF:		C SUBMITTAL RECEIVED:_	

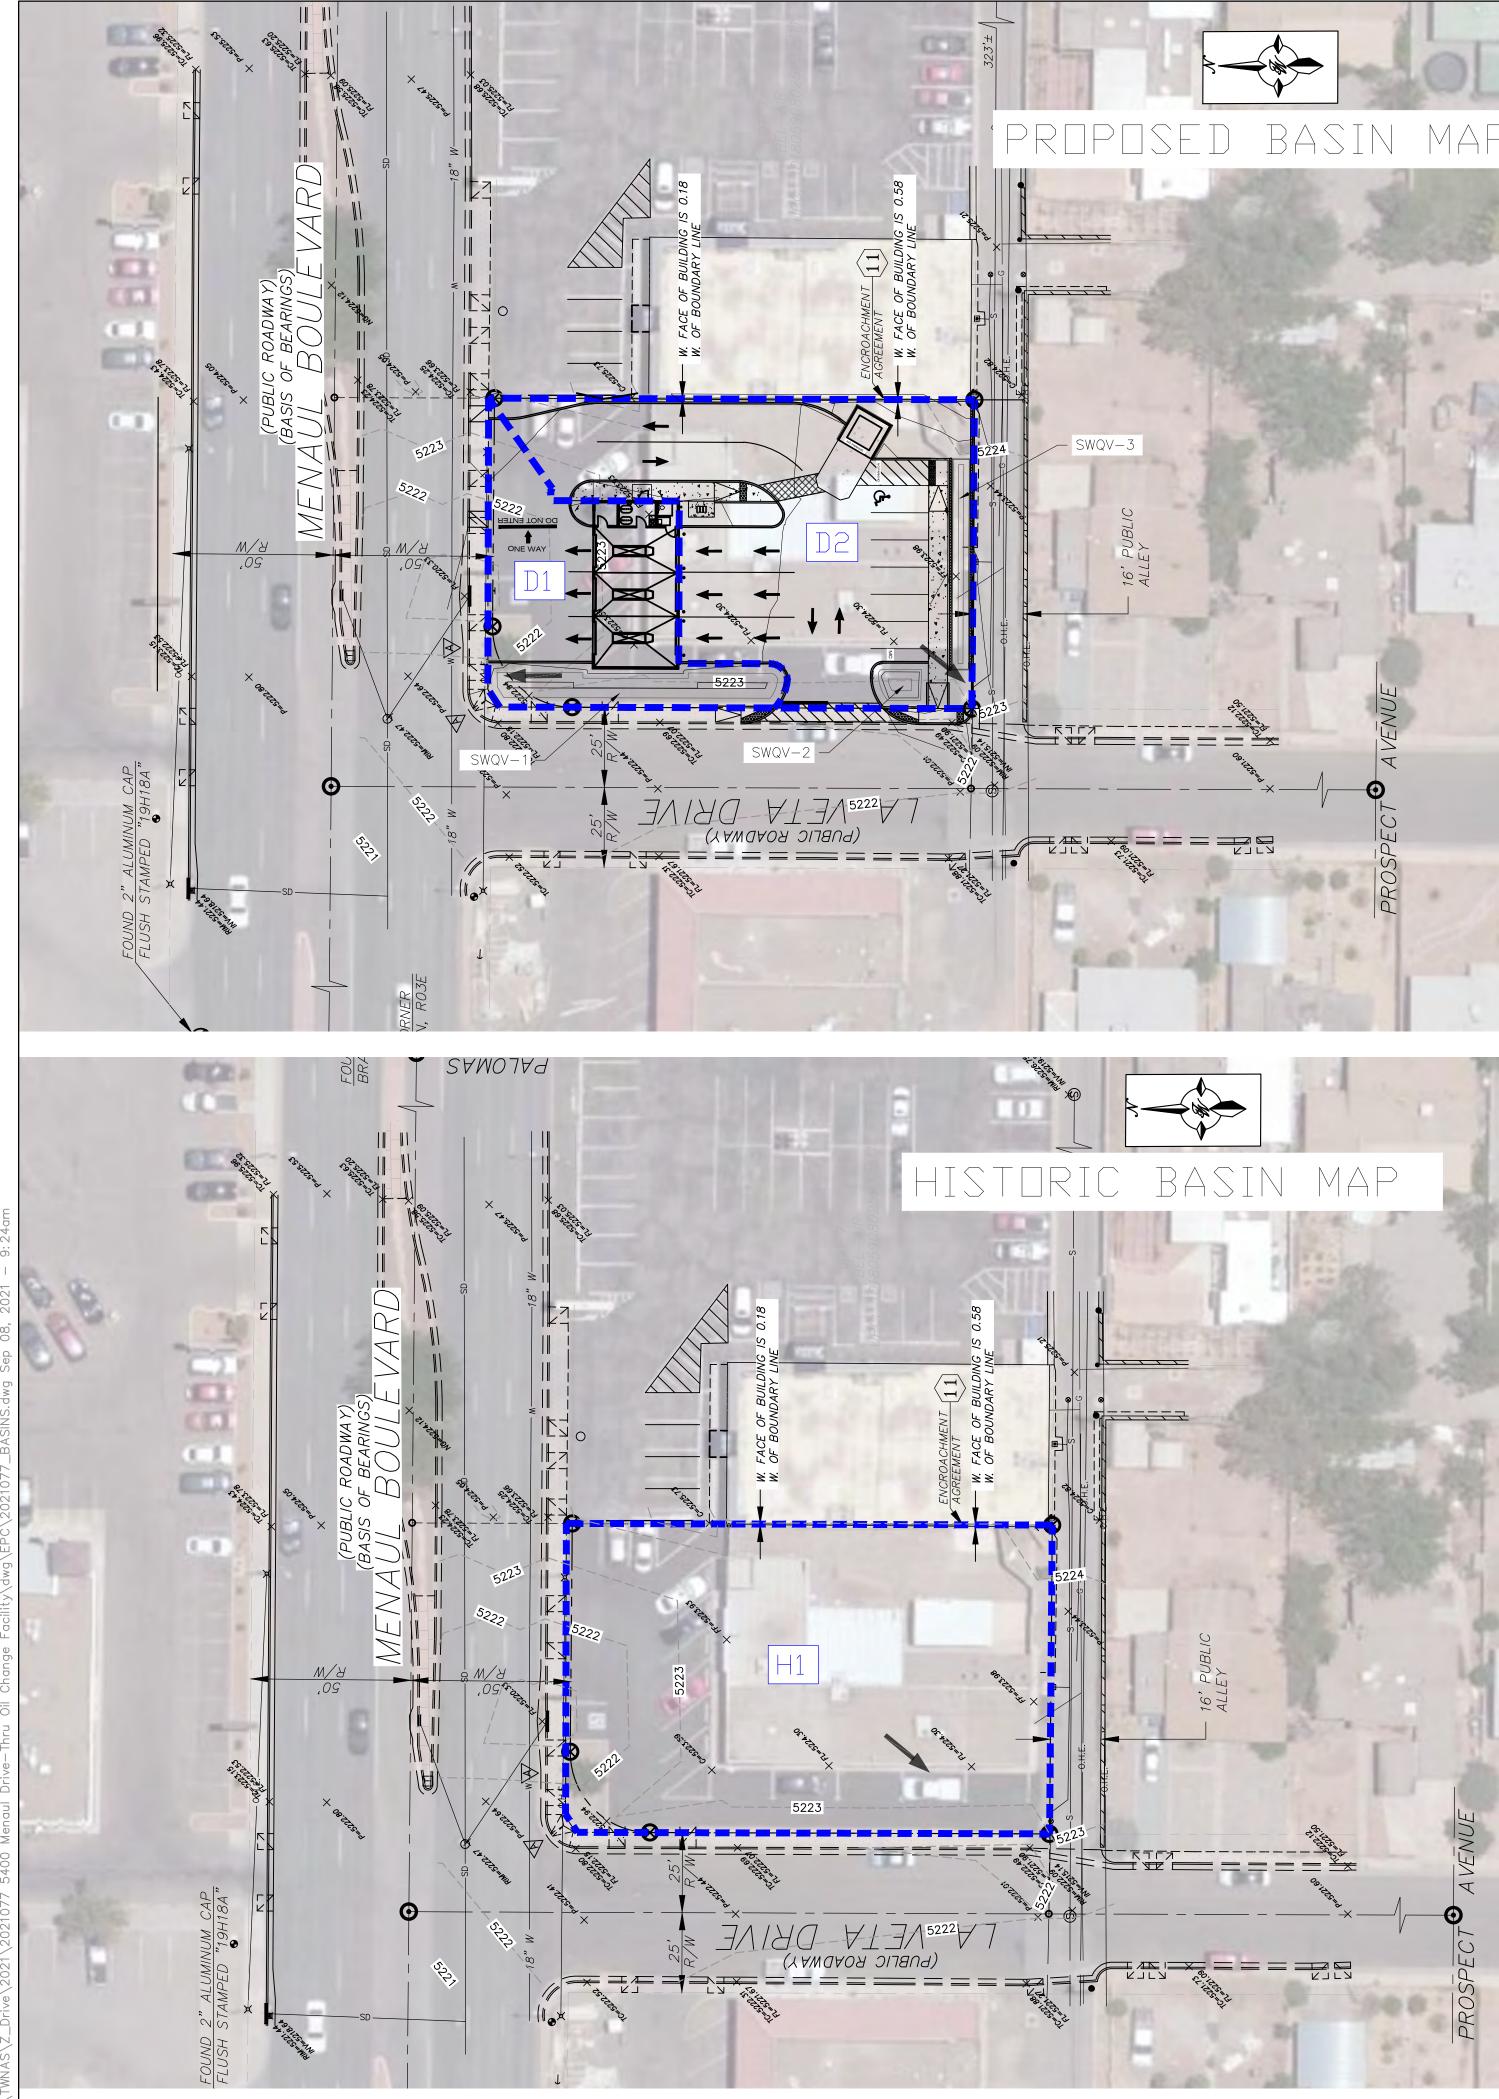

MAP

LEGEND

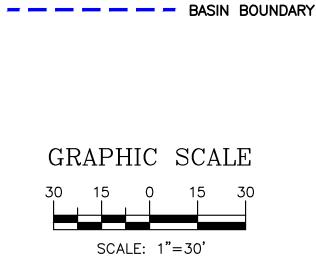

Existing Conditions

Basin Descriptions								100)-Year, 6-H	r					
Basin	Tract	Area	Area	Area	Treatm	ent A	Treat	nent B	Treatmo	ent C	Treatr	nent D	Weighted E	Volume	Flow
ID	Tract	(sf)	(acres)	(sq miles)	%	(acres)	%	(acres)	%	(acres)	%	(acres)	(in)	(ac-ft)	cfs
H1	А	14,615	0.34	0.00052	0%	0.000	2%	0.007	0%	0.000	98%	0.329	2.546	0.071	1.49
Total		14,615	0.34	0.00052	<u> </u>	0.000		0.007		0.000		0.329		0.071	1.493

Proposed Conditions

Basin Descriptions									100	100-Year, 6-Hr					
Basin	Troat	Area	Area	Area	Treatm	nent A	Treat	nent B	Treatme	ent C	Treatr	nent D	Weighted E	Volume	Flow
ID	Tract	(sf)	(acres)	(sq miles)	%	(acres)	%	(acres)	%	(acres)	%	(acres)	(in)	(ac-ft)	cfs
D1	А	4,650	0.11	0.00017	0%	0.000	9%	0.010	18%	0.019	73%	0.0779	2.157	0.019	0.43
D2	А	9,965	0.23	0.00036	0%	0.000	6%	0.014	12%	0.027	82%	0.1876	2.298	0.044	0.96
Total		14,615	0.336	0.00052		0.000		0.023		0.047		0.266		0.063	1.398

	SWQV				
Basin ID	Vol Required (cf)	Provided (cf)			
D1	120	175			
D2	286	308			
Total	406	483			


Equations:

Weighted E = Ea*Aa + Eb*Ab + Ec*Ac + Ed Volume = Weighted E * Total Area Flow = Qa*Aa + Qb*Ab + Qc*Ac + Qd*Ad

SWQV-1 Pond Volume Calculation							
Area at Mid Depth	350	Sq. Ft.					
Depth of Pond	1	Ft.					
Total Volume	175	Cubic Ft.					

SWQV-2 Pond	Volume Ca	alculation
Area at Mid Depth	73	Sq. Ft.
Depth of Pond	1	Ft.
Total Volume	73	Cubic Ft.

SWQV-3 Pond Volume (
235	Sq. Ft.					
1	Ft.					
235	Cubic Ft.					
	235 1					

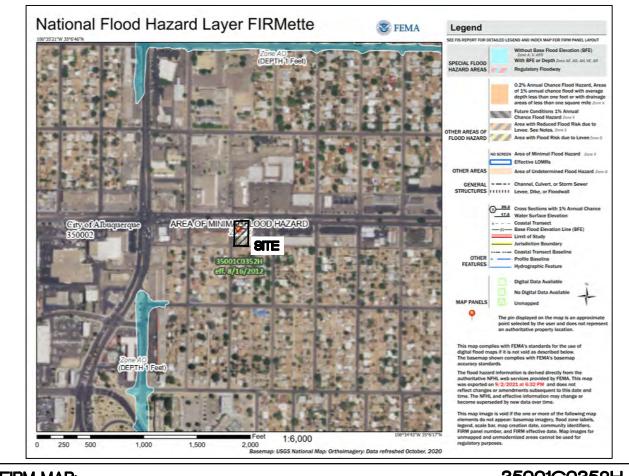

FI	RM	MA	۱P
		1412	

35001C0352H

Excess Precipitation, E (in.)							
Zone 3	100-Year	10-Year					
Ea	0.67	0.18					

Zone 3	Tuu-year	IU-year
Ea	0.67	0.18
Eb	0.86	0.34
Ec	1.09	0.52
Ed	2.58	1.64

Peak Discharge (cfs/acre)							
Zone 3	100-Year	10-Year					
Qa	1.84	0.51					
Qb	2.49	1.07					
Qc	3.17	1.69					
Qd	4.49	2.81					


foot

<u>Stormwater</u>	Quality	Volume	


Total Impervious Area = Retainage depth = 0.42" Per DPM Pg. 272 Retention Volume =

ΣArea in "Treatment D"


0.035 =0.035 x area CF

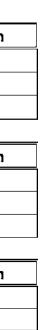

ENGINEER'S SEAL	3-BAY OIL CHANGE	DRAWN BY
SEAL	5400 MENAUL BLVD NE	
ON HUR. BOHANNE	GRADING AND DRAINAGE	<i>DATE</i> 08/31/2021
	BASIN MAP	2021077_BASINS
BORTH SSIONAL ENGINE	TIERRA WEST, LLC	SHEET # C3.1
09/08/2021 RONALD R. BOHANNAN P.E. #7868	T 5571 MIDWAY PARK PLACE NE ALBUQUERQUE, NM 87109 (505) 858-3100 www.tierrawestllc.com	јов # 2021077

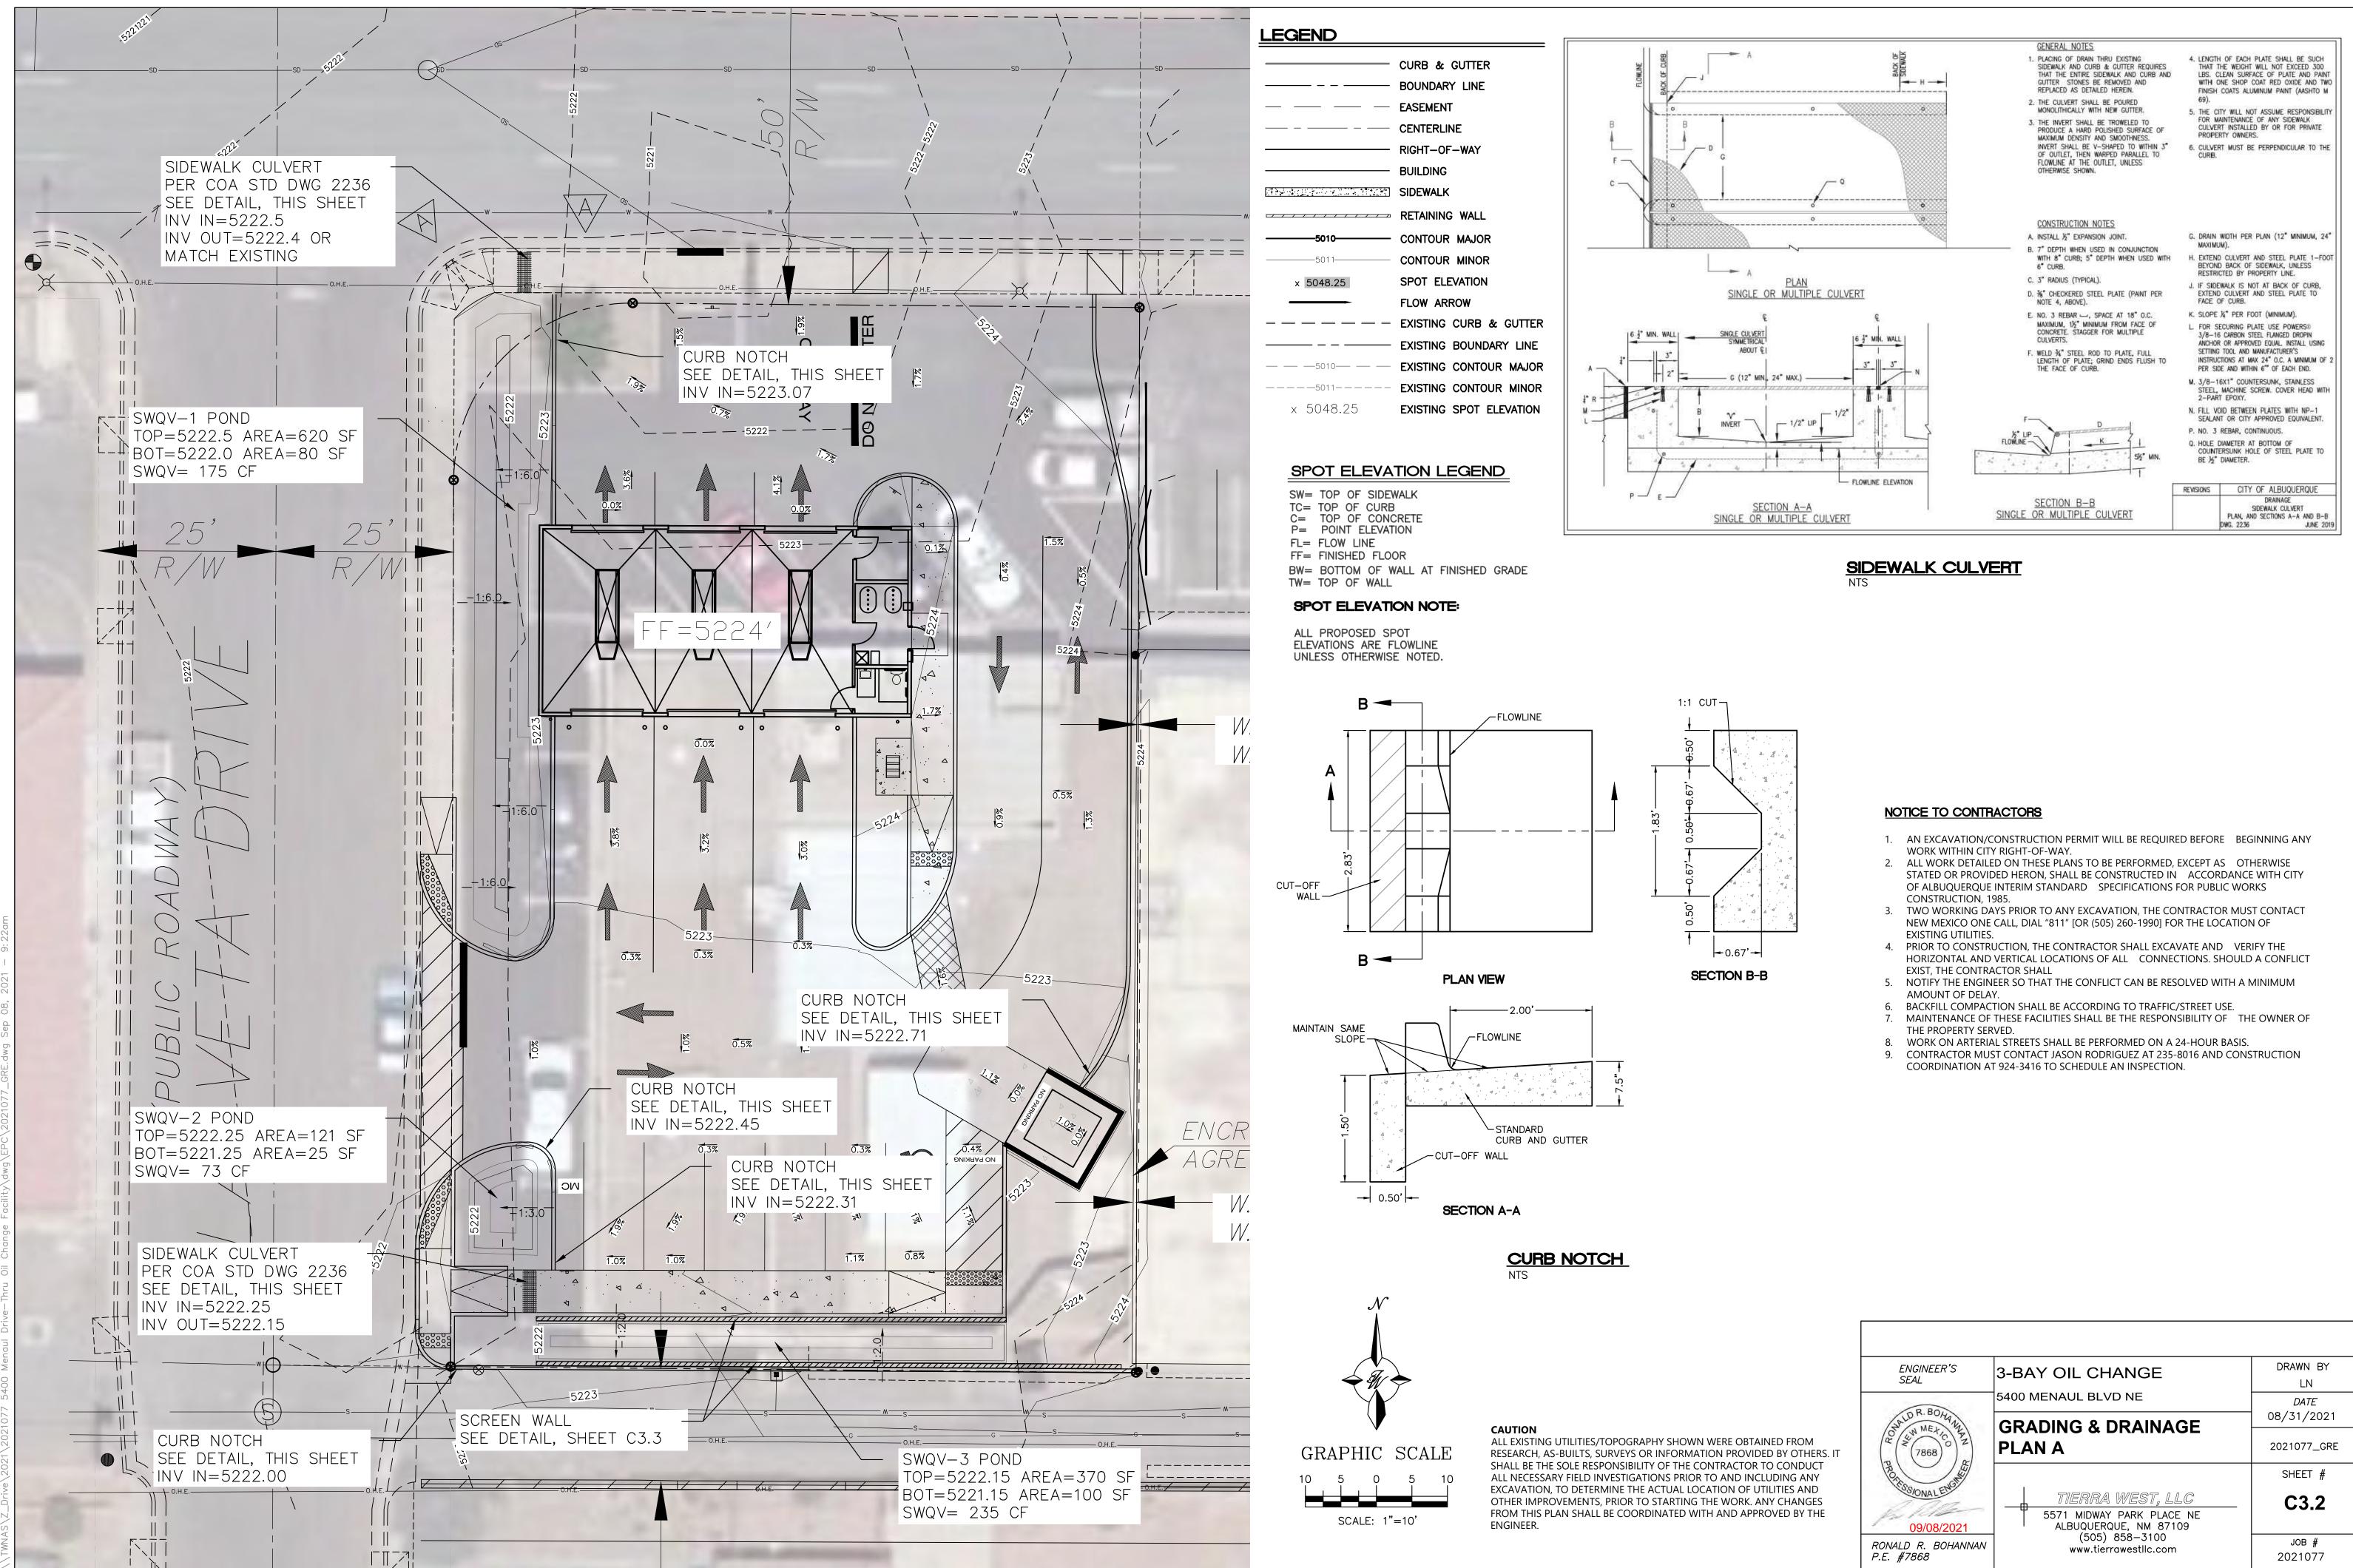

ENGINEER'S SEAL	3-BAY OIL CHANGE	DRAWN BY LN
NALD R. BOHANN		<i>DATE</i> 08/31/2021
	GRADING & DRAINAGE PLAN A	2021077_GRE
		SHEET #
	5571 MIDWAY PARK PLACE NE ALBUQUERQUE, NM 87109	C3.2
RONALD R. BOHANNAN P.E. #7868	(505) 858-3100 www.tierrawestllc.com	јов # 2021077

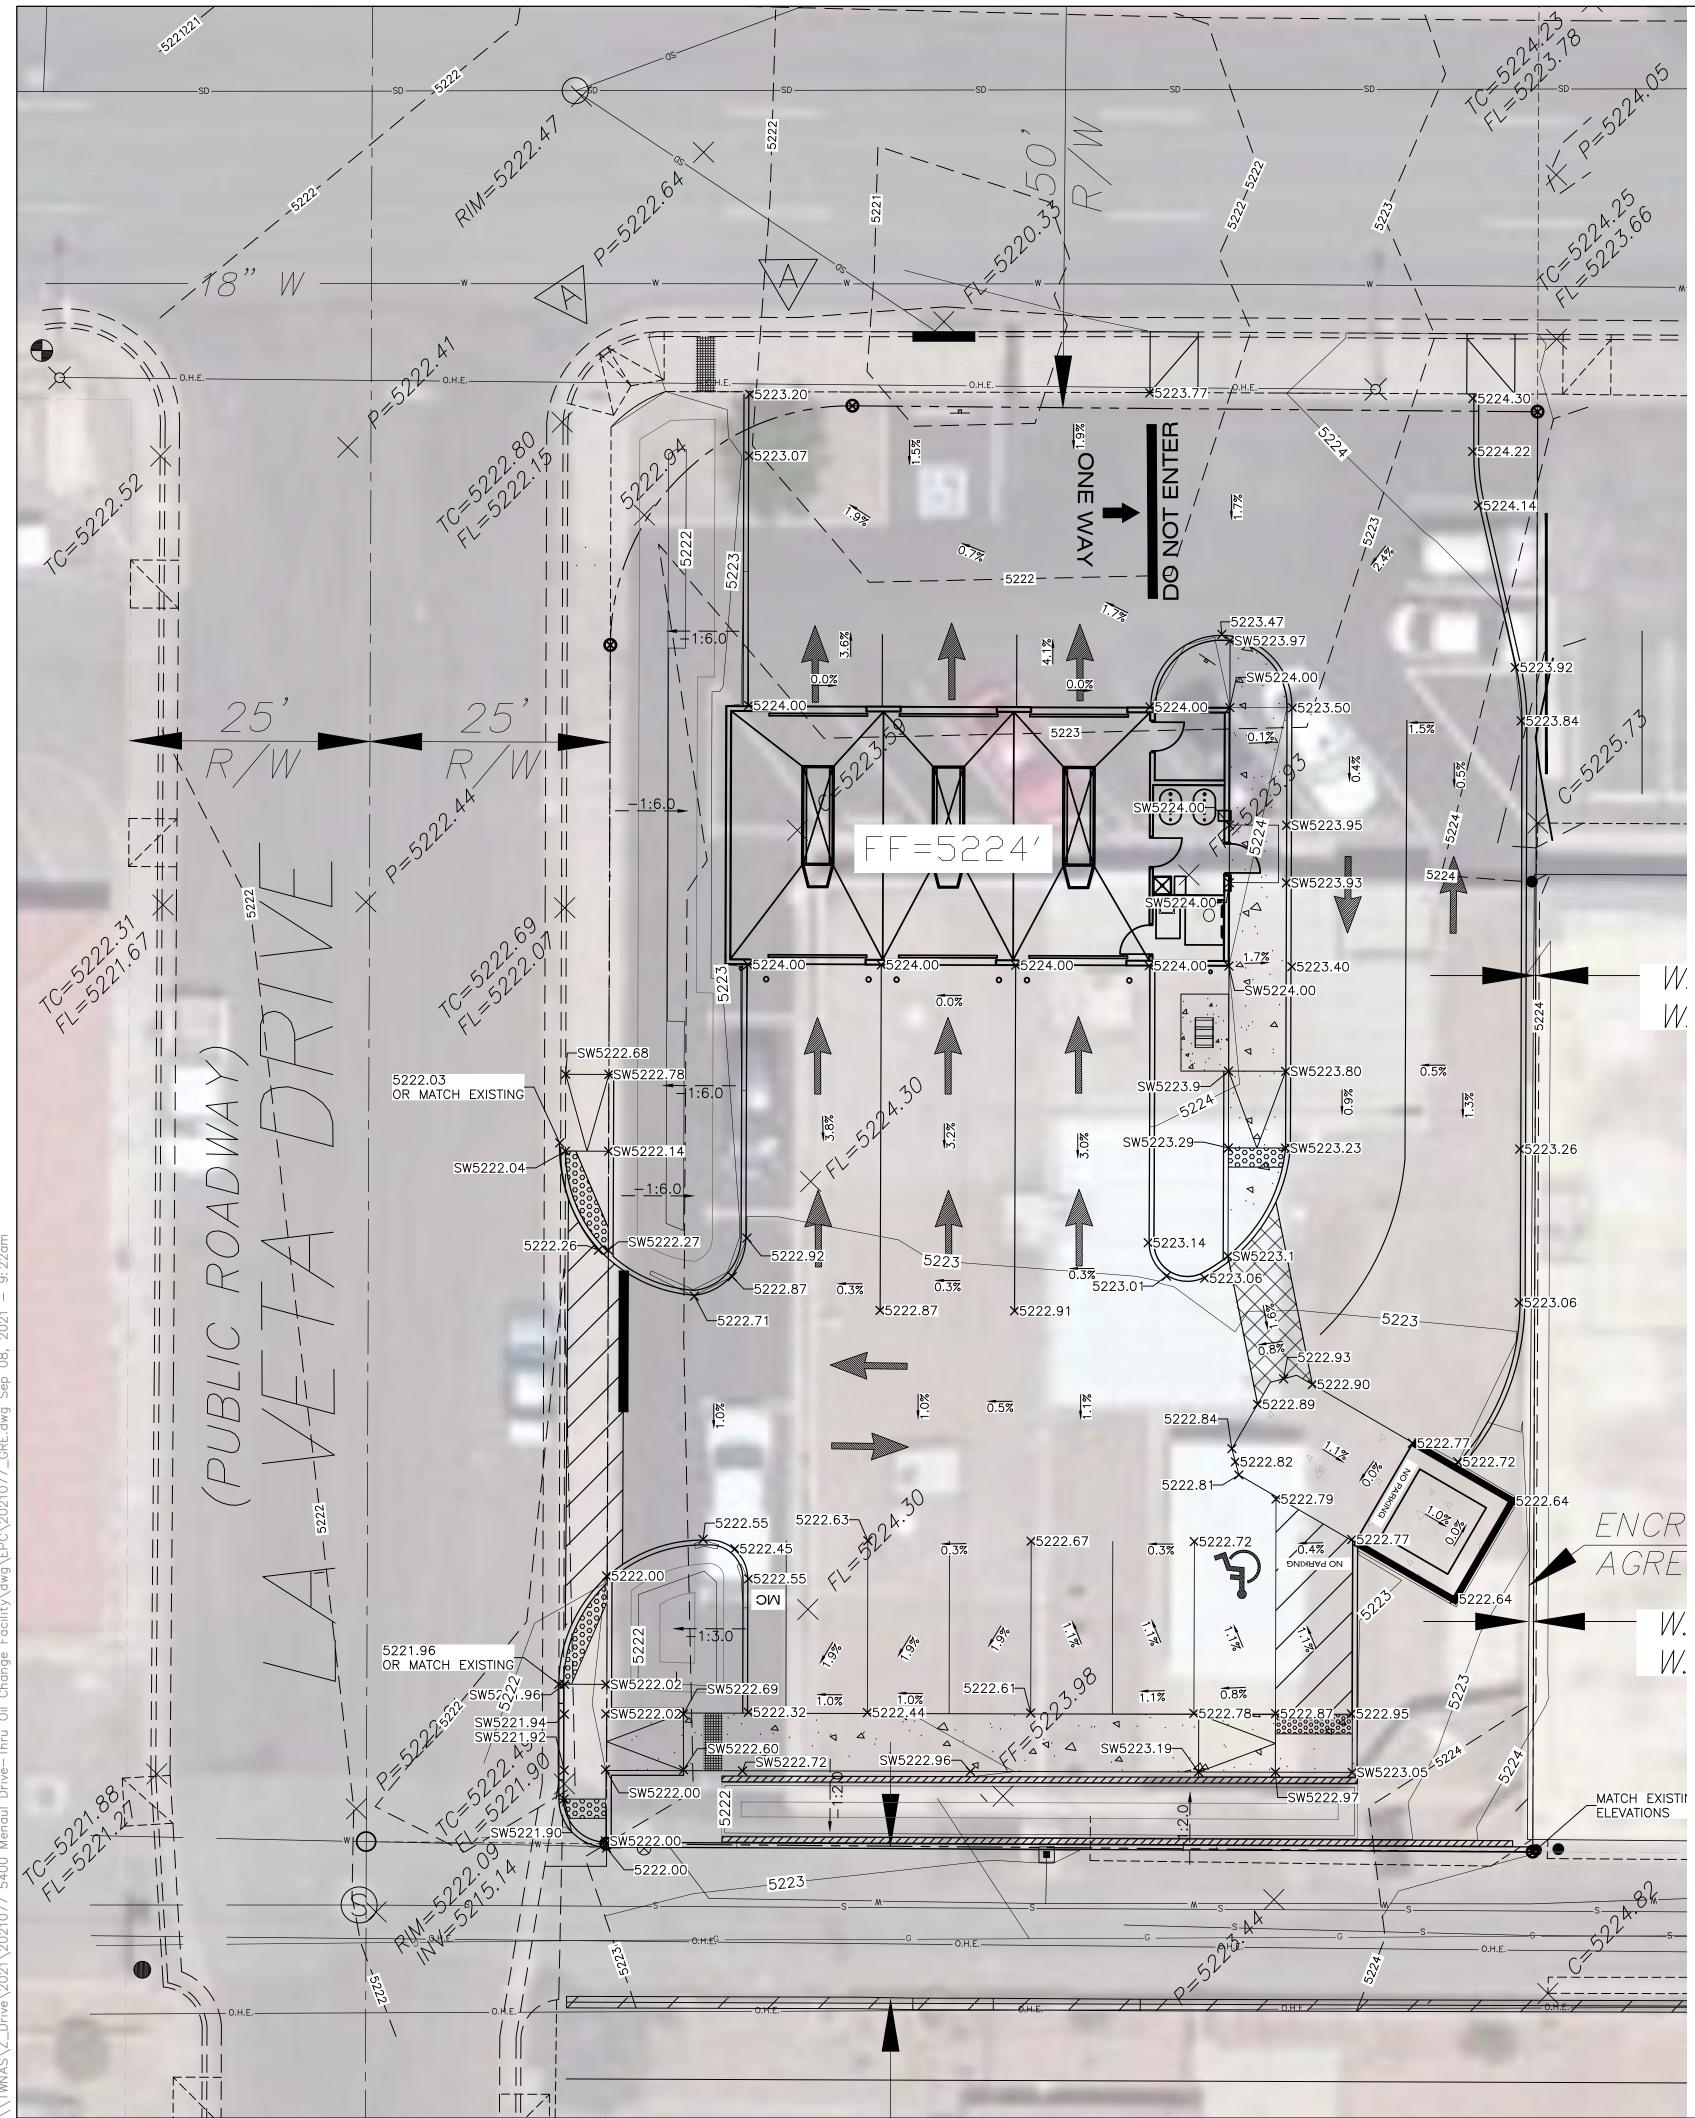

LEGEND

	CURB & GUTTER	
	BOUNDARY LINE	
	EASEMENT	
	CENTERLINE	
	RIGHT-OF-WAY	
	BUILDING	
	SIDEWALK	
	RETAINING WALL	
5010	CONTOUR MAJOR	
5011	CONTOUR MINOR	
x 5048.25	SPOT ELEVATION	
	FLOW ARROW	
	EXISTING CURB & GUTTER	
	EXISTING BOUNDARY LINE	
<u> </u>	EXISTING CONTOUR MAJOR	
————————————————————	EXISTING CONTOUR MINOR	
x 5048.25	EXISTING SPOT ELEVATION	

- SPOT ELEVATION LEGEND
- SW= TOP OF SIDEWALK TC= TOP OF CURB C= TOP OF CONCRETE P= POINT ELEVATION FL= FLOW LINE FF= FINISHED FLOOR BW= BOTTOM OF WALL AT FINISHED GRADE TW= TOP OF WALL


SPOT ELEVATION NOTE:


ALL PROPOSED SPOT ELEVATIONS ARE FLOWLINE UNLESS OTHERWISE NOTED.



GRAPHIC SCALE


SCALE: 1"=10'

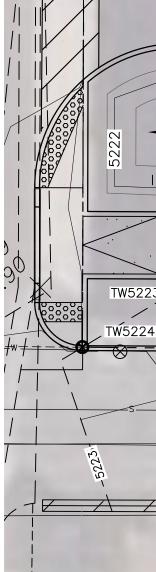

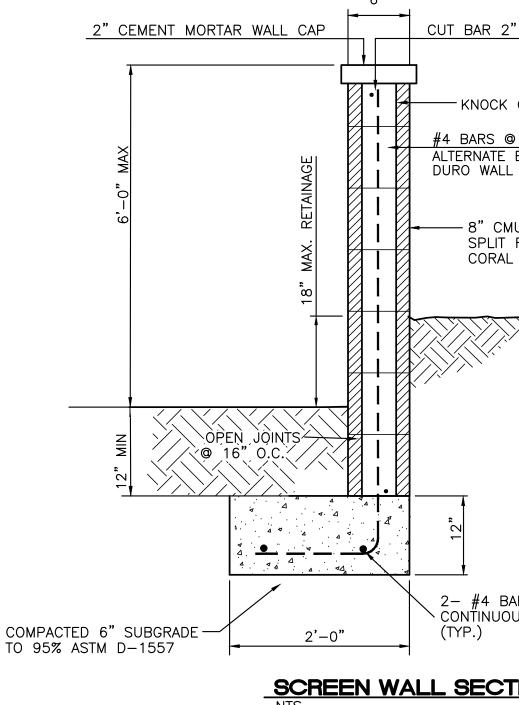

NOTICE TO CONTRACTORS

- 1. AN EXCAVATION/CONSTRUCTION PERMIT WILL BE REQUIRED BEFORE BEGINNING ANY WORK WITHIN CITY RIGHT-OF-WAY.
- 2. ALL WORK DETAILED ON THESE PLANS TO BE PERFORMED, EXCEPT AS OTHERWISE STATED OR PROVIDED HERON, SHALL BE CONSTRUCTED IN ACCORDANCE WITH CITY OF ALBUQUERQUE INTERIM STANDARD SPECIFICATIONS FOR PUBLIC WORKS CONSTRUCTION, 1985.
- 3. TWO WORKING DAYS PRIOR TO ANY EXCAVATION, THE CONTRACTOR MUST CONTACT NEW MEXICO ONE CALL, DIAL "811" [OR (505) 260-1990] FOR THE LOCATION OF EXISTING UTILITIES.
- 4. PRIOR TO CONSTRUCTION, THE CONTRACTOR SHALL EXCAVATE AND VERIFY THE HORIZONTAL AND VERTICAL LOCATIONS OF ALL CONNECTIONS. SHOULD A CONFLICT EXIST, THE CONTRACTOR SHALL
- 5. NOTIFY THE ENGINEER SO THAT THE CONFLICT CAN BE RESOLVED WITH A MINIMUM AMOUNT OF DELAY.
- BACKFILL COMPACTION SHALL BE ACCORDING TO TRAFFIC/STREET USE. MAINTENANCE OF THESE FACILITIES SHALL BE THE RESPONSIBILITY OF THE OWNER OF THE PROPERTY SERVED.
- WORK ON ARTERIAL STREETS SHALL BE PERFORMED ON A 24-HOUR BASIS. 8. 9. CONTRACTOR MUST CONTACT JASON RODRIGUEZ AT 235-8016 AND CONSTRUCTION COORDINATION AT 924-3416 TO SCHEDULE AN INSPECTION.

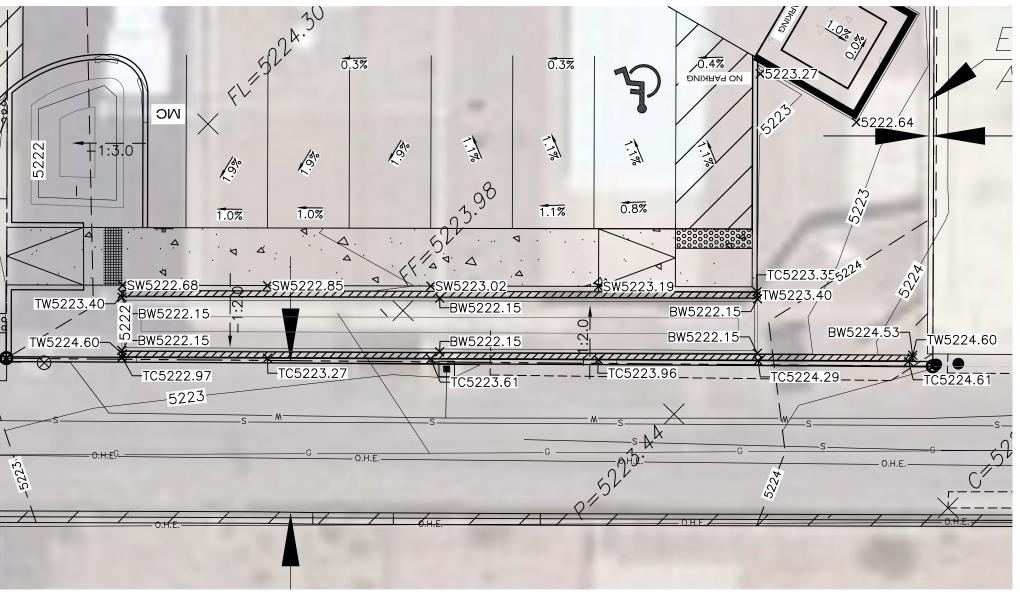



CUT BAR 2" FROM TOP OF CAP

-KNOCK OUT BOND BEAM WITH 1-#4 CONT. #4 BARS @ 24" O.C. VERT. GROUT FILL

ALTERNATE BENDS DURO WALL EVERY OTHER COURSE

— 8"CMU WALL SPLIT FACE CORAL COLOR

 \times

GENERAL NOTES:

- 1. ALL CONCRETE IS TO BE 3000 PSI @ 28 DAYS.
- ALL CONVERTE IS TO BE SOUD FOR @ 20 DATS.
 MINIMUM COMPACTION UNDER FOOTINGS IS TO BE 95% PER ASTM. D 1557 FOR A DEPTH OF 12" MOISTURE CONTENT IS TO BE ± 2.0%.
 BACK FILL AGAINST WALLS IS TO BE HAND-PLACED AND COMPACTED.
- ALL BARS ARE TO BE GRADE 60, ASTM 615. 4
- 5. TRUSS TYPE DUR-O-WALL EVERY OTHER COURSE. 6. DOWELS SHALL BE AT LEAST EQUAL IN SIZE AND SPACING TO V-BARS, SHALL PROJECT A MINIMUM OF 30 BAR DIA. INTO THE FILLED BLOCK CORES, AND SHALL EXTEND TO THE TOE OF THE FOOTING.
- 7. USE EITHER EXPANSION JOINTS ON 20' CENTERS OR PILASTERS EVERY 16'.

CAUTION

ALL EXISTING UTILITIES/TOPOGRAPHY SHOWN WERE OBTAINED FROM RESEARCH, AS-BUILTS, SURVEYS OR INFORMATION PROVIDED BY OTHERS. IT SHALL BE THE SOLE RESPONSIBILITY OF THE CONTRACTOR TO CONDUCT ALL NECESSARY FIELD INVESTIGATIONS PRIOR TO AND INCLUDING ANY EXCAVATION, TO DETERMINE THE ACTUAL LOCATION OF UTILITIES AND OTHER IMPROVEMENTS, PRIOR TO STARTING THE WORK. ANY CHANGES FROM THIS PLAN SHALL BE COORDINATED WITH AND APPROVED BY THE ENGINEER.

	ENGINEER'S SEAL	3-BAY OIL CHANGE	DRAWN BY LN
	UD R. BOHA	5400 MENAUL BLVD NE	<i>DATE</i> 08/31/2021
RS JS	TREATING OF TRANSPORT	GRADING & DRAINAGE PLAN B	2021077_GRE
<u>10N</u>	1980 ALENON 09/08/2021	5571 MIDWAY PARK PLACE NE ALBUQUERQUE, NM 87109	SHEET # C3.3
	RONALD R. BOHANNAN P.E. #7868	(505) 858-3100 www.tierrawestllc.com	JOВ # 2021077