GENERAL NOTES:

- A. REFER TO PROJECT MANUAL FOR ADDITIONAL REQUIREMENTS.
- B. ALL SITE DIMENSIONS TO THE GUTTER LINE OF CURB, CONCRETE OR PROPERTY LINE UNLESS OTHERWISE NOTED. CONTRACTOR TO FIELD VERIFY EXISTING CONDITIONS BY DETAILED INSPECTION PRIOR TO SUBMITTING BID AND STARTING CONSTRUCTION.
- C. COORDINATE WORK WITH OTHER SITE RELATED DEVELOPMENT

STAGES OF CONSTRUCTION:

CONTRACTOR TO PERFORM DETAILED SITE INSPECTION TO LOCATE ALL EXISTING UTILITIES AND VERIFY ANY POSSIBLE CONFLICTS WITH PROPOSED IMPROVEMENTS PRIOR TO BEGINNING ANY CONSTRUCTION. CONTACT OWNER WITH ANY CONFLICTS.

- INSTALLATION OF EROSION CONTROL FENCE.
- DEMOLITION OF EXISTING SITE IMPROVEMENTS.
- REMOVAL OF INDICATED EXISTING PAVEMENT ON THE SITE INSTALLATION OF ALL STORM WATER DRAINAGE IMPROVEMENTS.
- ROUGH GRADING.
- CONSTRUCTION OF NEW SITE IMPROVEMENTS.
- FINAL GRADING. 9. PLACEMENT OF FINAL LANDSCAPING ITEMS AND SOD.
- 10. REMOVAL OF EROSION CONTROL FENCE.

LEGAL DESCRIPTION (AS-SURVEYED):

TRACT NUMBERED FOUR-A (4-A) OF THE REPLAT OF LOTS NUMBERED THREE (3), FOUR (4) AND FIVE (5), IN BLOCK NUMBERED SIX (6) OF THE AMENDED PLAT OF SOMBRA DEL MONTE, A SUBDIVISION, THE CITY OF ALBUQUERQUE, NEW MEXICO, AS SAME IS SHOWN AND DESIGNATED ON THE MAP OF SAID SUBDIVISION, FILED IN THE OFFICE OF THE COUNTY CLERK OF BERNALILLO COUNTY, NEW MEXICO, FILED JUNE 8, 1987, IN PLAT BOOK C33, FOLIO 172.

SPECIAL NOTE:

ALL BROKEN OR CRACKED SIDEWALK MUST BE REPLACED WITH SIDEWALK AND CURB & GUTTER. REFER TO CITY OF ALBUQUERQUE STANDARD DRAWING 2430.

GENERAL INFORMATION:

TYPE OF DEVELOPMENT: SIZE OF DEVELOPMENT:

PARKING SPACES REQUIRED: PARKING REDUCTION:

BUILDING = 7,440 SQ. FT. PARKING LOT = 14,150 SQ. FT. 7,440 / 200 = 37.2 = 38 SPACES

COMMERCIAL RETAIL

ACCORDING TO 14-16-3-1-E-6-a-1, REQUIRED PARKING MAY BE REDUCED BY 10% IF WITHIN 300 FT OF A REGULAR ALBUQUERQUE TRANSIT SYSTEM ROUTE. ALBUQUERQUE BUS ROUTE 8 IS WITHIN 300 FT OF PROPOSED DEVELOPMENT.


38 SPACES * 0.90 = 34.2 = 35 SPACES 33 SPACES PARKING SPACES PROVIDED: COMPACT SPACES PROVIDED: 2 SPACES 2 SPACES HANDICAP SPACES PROVIDED:

EXECUTIVE SUMMARY:

THIS COMMERCIAL PROJECT IS LOCATED AT 8117 MENAUL BLVD NE ALBUQUERQUE, NM. O'REILLY AUTO PARTS IS RENOVATING A 7,440 SQ. FT. EXISTING BUILDING AND 14.150 SQ. FT. OF EXISTING PARKING LOT. THE PARKING LOT PROVIDES 35 TOTAL PARKING SPACES WITH 2 HANDICAP SPACES. THE EXISTING PARKING LAYOUT PROVIDES 2 DRIVEWAY ACCESSES WITH AN EXISTING 34 WIDE DRIVE AISLE CONNECTING TO MENAUL BLVD NE AND AN EXISTING 23' WIDE DRIVE AISLE CONNECTING TO VIRGINIA ST NE






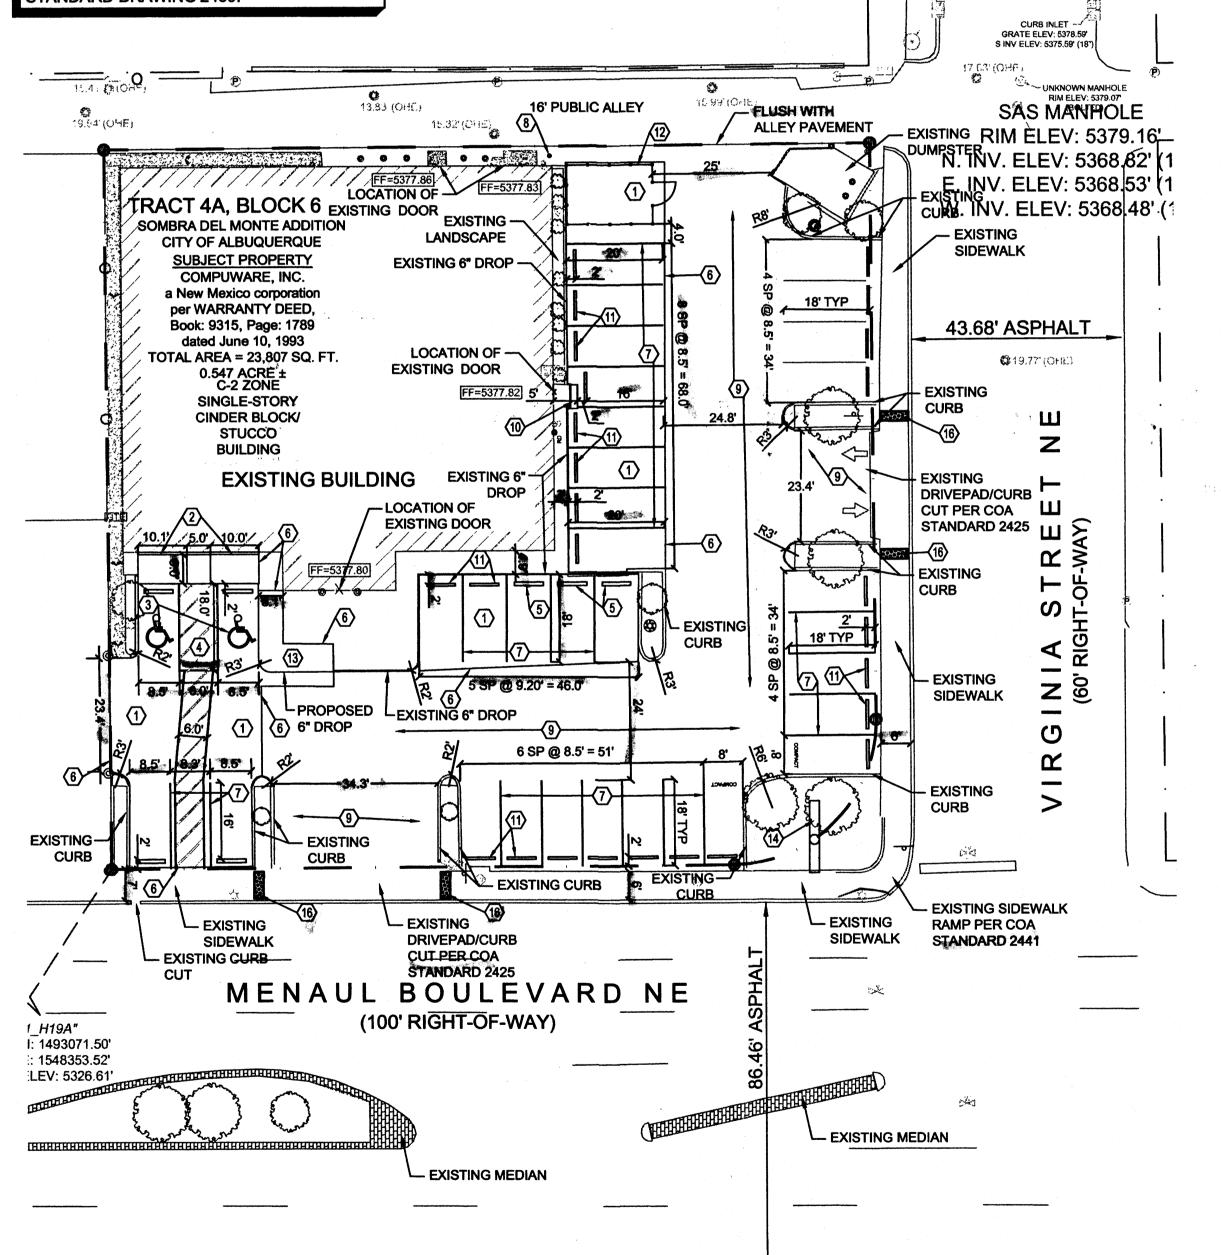

SIGN TYPE R7-8 (12"x18") - sign field is white sign lettering and border are green International Symbol of Accessibility PARKING is white on a blue background bottom of this sign Required language per NMSA 197866-7-352,4C 60" min, above ground SIGN TYPE R7-8A (6"x12") sign field is white Van accessible spaces sign lettering and border are green bottom of this sign Required language (Van Accessible Spaces 60" min, above the ground ATTACH EA. SIGN TO BUIDLING W/ GALV. MOUNTING BOLTS. NOTE: ATTACH EA. SIGN TO EXISTING **BUILDING W/ GALV. MOUNTING BOLTS WHERE APPLICABLE.**

2 BUILDING HANDICAP PARKING SIGN

SCALE: NOT TO SCALE

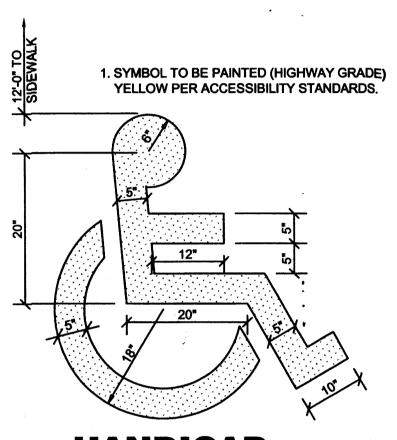

HANDICAP PARKING SYMBOL SCALE: NOT TO SCALE

KEY NOTES:

NEW CONCRETE PAVING: REFER TO DETAIL 2/C3.


ALTERNATE #1:


ASPHALT PAVING REFER TO DETAIL 3/C3.

- NEW BUILDING HANDICAP PARKING SIGN: REFER TO DETAIL 2/C2.
- NEW HANDICAP PARKING SYMBOL: REFER TO DETAIL 3/C2.
- ANEW HANDICAP ACCESS UNLOADING ZONE: SLOPE 2% MAX. EACH WAY (ADA COMPLIANT) AND STRIPE AS SHOWN. REFER TO SHEET C1 FOR ELEVATIONS.
- NEW CONCRETE BUMPER BLOCK:
 8"w x 5"h x 6'-0" LONG CONCRETE. ANCHOR TO PAVING WITH (2) 1'-6" LONG #4 REBAR (TO SIT LEVEL WITH PAVING).
- 6 LIMITS OF NEW PAVING: MATCH EXISTING PER CITY AND OR STATE STANDARDS.
- 7 NEW STRIPING:
 PROVIDE 4" WIDE PARKING LOT STRIPING AS SHOWN. USE HIGHWAY MARKING PAINT - WHITE (2 COATS)
- NEW STEEL BOLLARD:
 REFER TO DETAIL 5/C3. PROVIDE (1) AT REAR OF BUILDING. REFER TO ARCHITECTURAL PLAN FOR LOCATION.
- (9) REPAIR, SEAL, AND STRIPE EXISTING ASPHALT PAVING.
- NEW CONCRETE DOOR LANDING:
 REFER TO DETAIL 4/C3 AND STRUCTURAL DETAILS. LANDING CAN BE POURED MONOLITHIC.
- EXISTING CONCRETE BUMPER BLOCKS:
 RELOCATE AND REUSE EXISTING CONCRETE BUMPER BLOCKS WHERE POSSIBLE. IF DAMAGED DURING CONSTRUCTION, REPLACE WITH NEW CONCRETE BUMPER BLOCKS PER KEYNOTE 5.
- NEW SCREEN FENCE: REFER TO DETAIL 6/C3.
- CONCRETE SIDEWALK: REFER TO DETAIL 4/C3.
- NEW SIGN LOCATION:
 EXISTING SIGN POLE TO BE REMOVED. NEW SIGN UNDER SEPARATE PERMIT (BY OTHERS).
- (15) ANDSCAPING AND SIGNAGE WILL NOT INTERFERE WITH SIGHT REQUIREMENTS. THEREFORE, SIGNS, WALLS, TREES, AND SHRUBBERY BETWEEN 3 AND 8 FEET TALL (AS MEASURED FROM THE GUTTER PAN) WILL NOT BE ACCEPTABLE IN THIS AREA.
- (16) INSTALL 6' X 2' TRUNCATED DOMES PER ADA STANDARDS.

TRAFFIC CIRCULATION LAYOUT PLAN SCALE: 1" = 20"



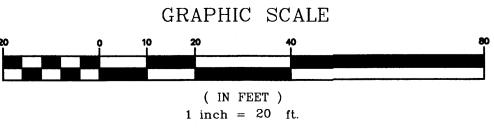

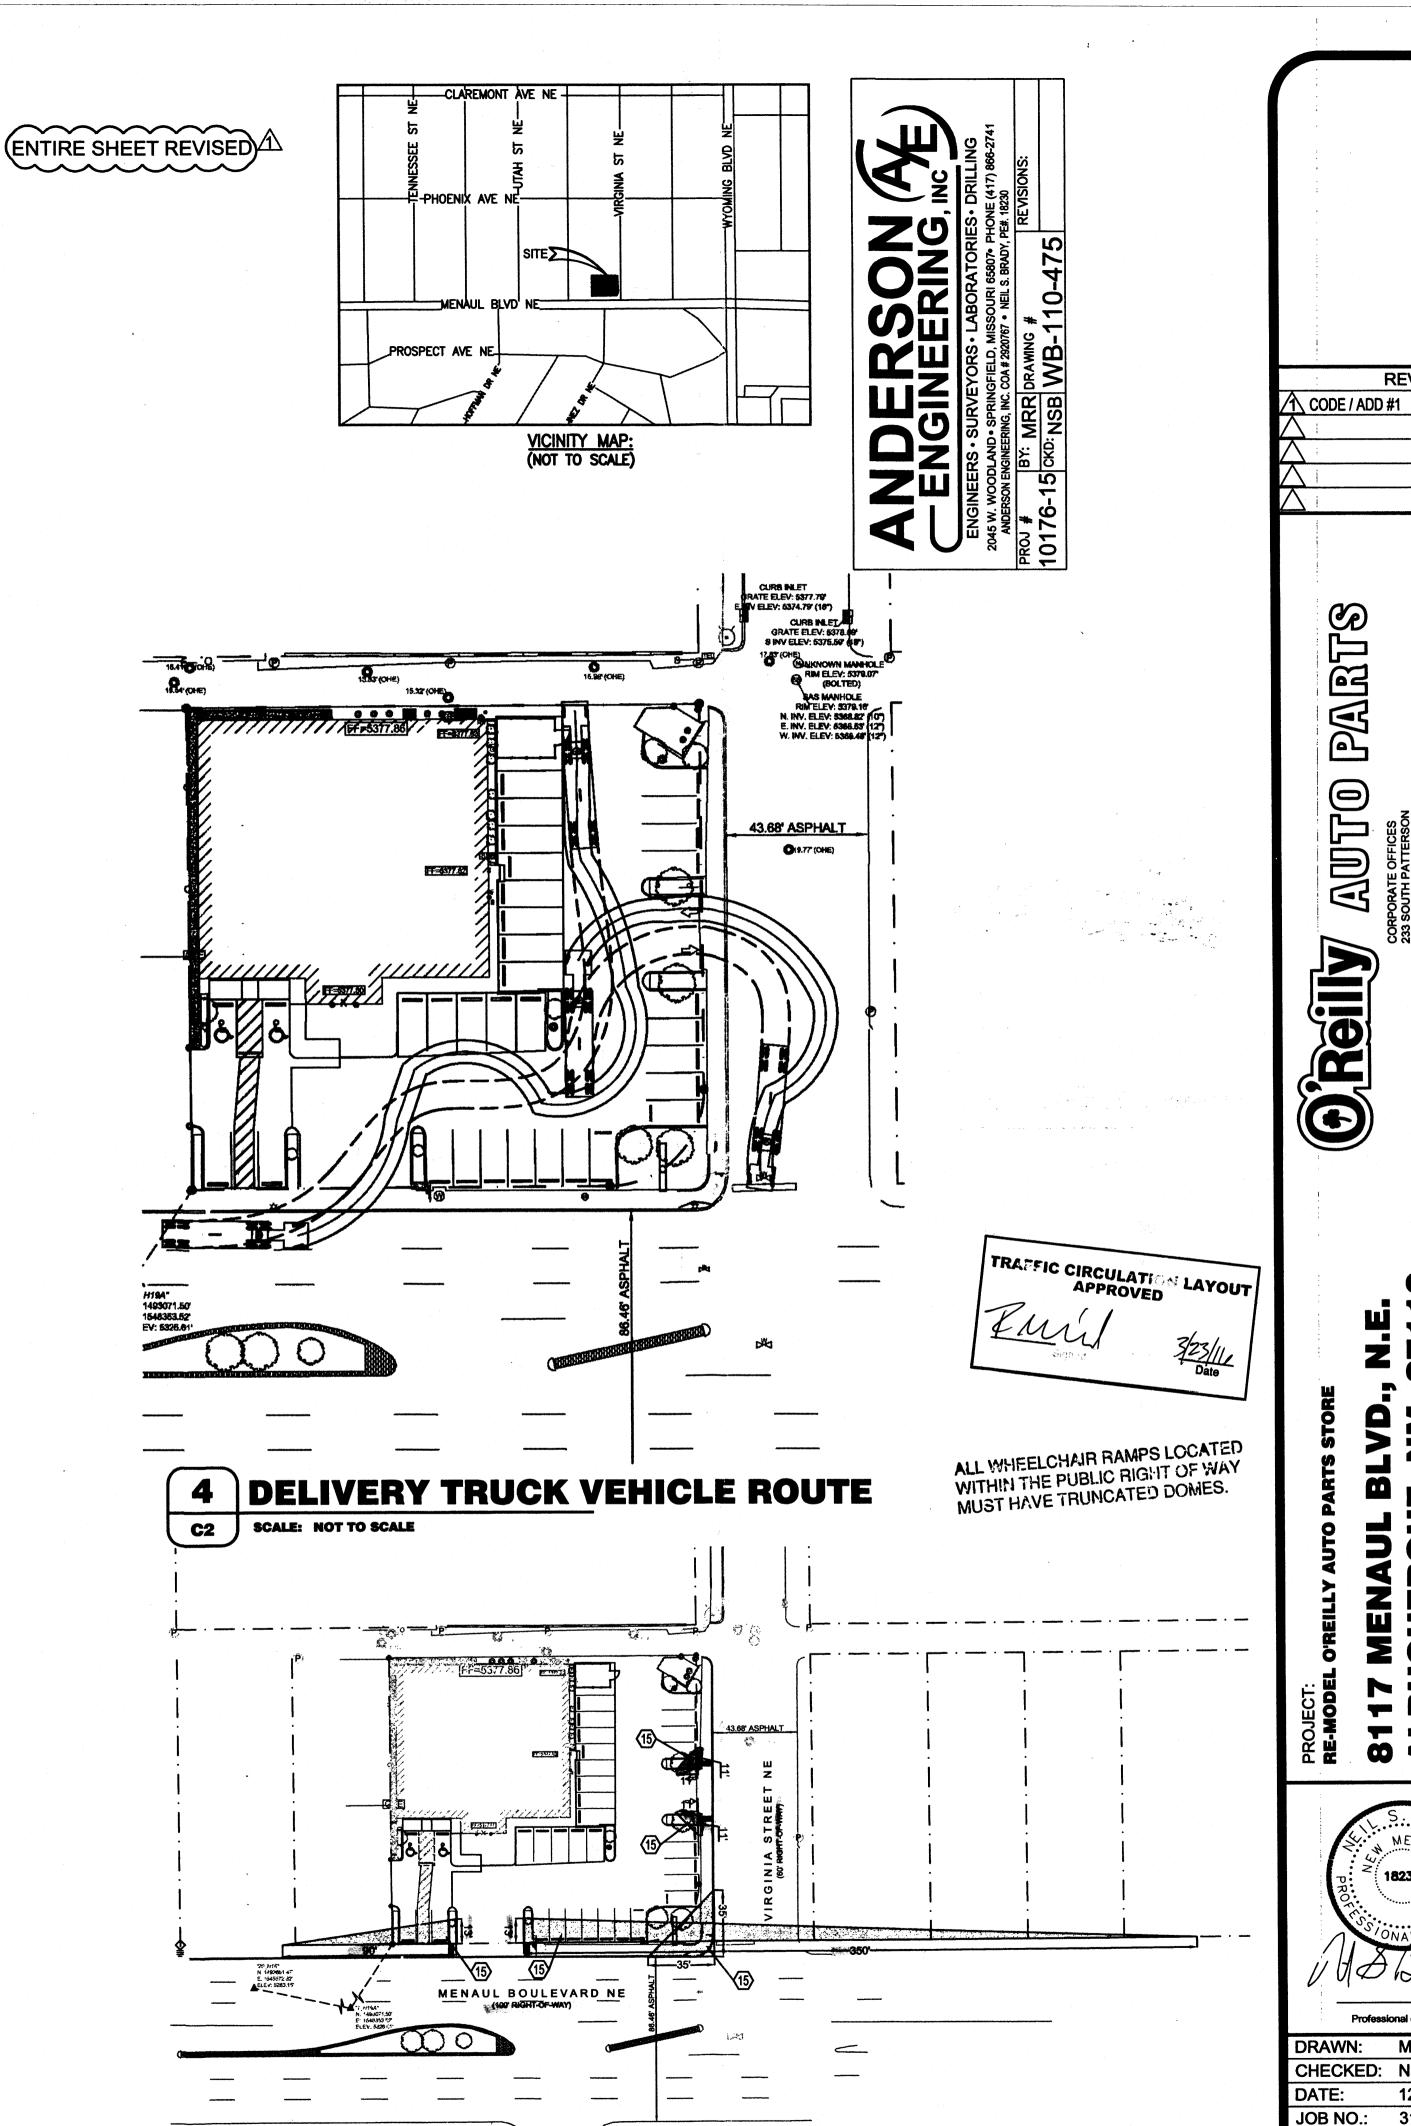

5 SIGHT DISTANCE EXHIBIT

SCALE: 1" = 50"

DRAWN: MRR CHECKED: NSB 12/23/15 JOB NO.: 315619 (A16)

REVISIONS:

03/10/16

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KEY NOTES: NEW CONCRETE PAVING: REFER TO DETAIL 2/C3.

ALTERNATE #1: ASPHALT PAVING REFER TO DETAIL 3/C3.

2 NEW BUILDING HANDICAP PARKING SIGN:

- REFER TO DETAIL 2/C2.
- NEW HANDICAP PARKING SYMBOL: REFER TO DETAIL 3/C2.
- NEW HANDICAP ACCESS UNLOADING ZONE: SLOPE 2% MAX. EACH WAY (ADA COMPLIANT) AND STRIPE AS SHOWN. REFER TO SHEET C1 FOR ELEVATIONS.
- NEW CONCRETE BUMPER BLOCK:
 8"w x 5"h x 6'-0" LONG CONCRETE. ANCHOR TO PAVING WITH (2) 1'-6" LONG #4 REBAR (TO SIT LEVEL WITH PAVING).
- 6 LIMITS OF NEW PAVING: MATCH EXISTING PER CITY AND OR STATE STANDARDS.
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 REFER TO ARCHITECTURAL PLAN FOR LOCATION.
- (9) REPAIR, SEAL, AND STRIPE EXISTING ASPHALT PAVING.

MUST HAVE TRUNCATED DOMES.

TRAFFIC CIRCULATION LAYOUT

- NEW CONCRETE DOOR LANDING:
 REFER TO DETAIL 4/C3 AND STRUCTURAL DETAILS. LANDING CAN BE POURED MONOLITHIC.
- EXISTING CONCRETE BUMPER BLOCKS:
 RELOCATE AND REUSE EXISTING CONCRETE BUMPER BLOCKS WHERE POSSIBLE. IF DAMAGED DURING CONSTRUCTION, REPLACE WITH NEW CONCRETE BUMPER BLOCKS PER KEYNOTE 5.
- NEW SCREEN FENCE: REFER TO DETAIL 6/C3.
- CONCRETE SIDEWALK: REFER TO DETAIL 4/C3.
- NEW SIGN LOCATION: EXISTING SIGN POLE TO BE REMOVED. NEW SIGN UNDER SEPARATE PERMIT (BY OTHERS).
- 15 NOT SHOWN ON SHEET C3.
- (16) INSTALL 6' X 2' TRUNCATED DOMES PER ADA STANDARDS.



GENERAL NOTES:


A. REFER TO PROJECT MANUAL FOR ADDITIONAL REQUIREMENTS


B. ALL SITE DIMENSIONS TO THE GUTTER LINE OF CURB, CONCRETE


C. COORDINATE WORK WITH OTHER SITE RELATED DEVELOPMENT

OR PROPERTY LINE UNLESS OTHERWISE NOTED. CONTRACTOR

TO FIELD VERIFY EXISTING CONDITIONS BY DETAILED INSPECTION PRIOR TO SUBMITTING BID AND STARTING CONSTRUCTION.

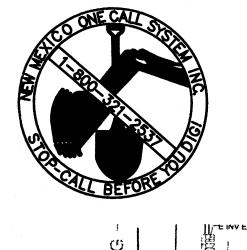


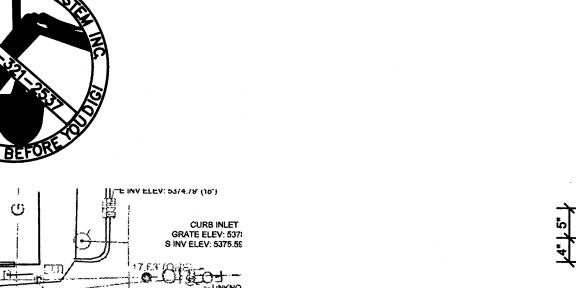


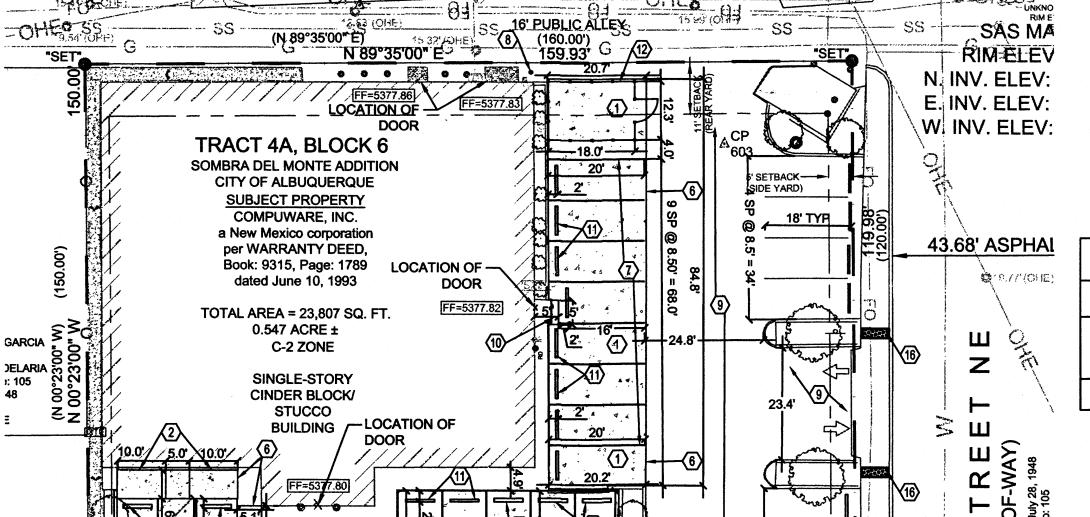

5 SP @ 9.20' = 46.0'

OHE (130.00')

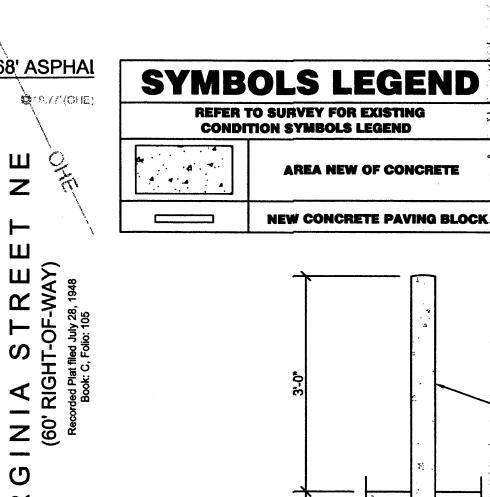

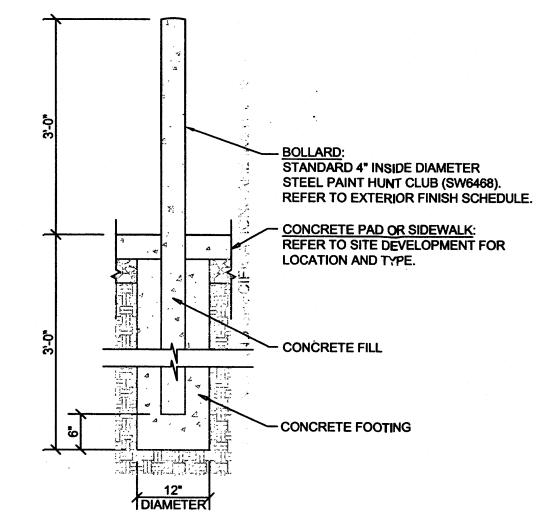

PROVIDE CONTROL JOINTS AT

12' O.C. (25% SLAB THICKNESS

- 5" THICK CONCRETE

6X6-W1.4XW1.4 WWF

(PLACED AT MID HEIGHT

PAVING WITH

~ COMPACTED SUB

┌ COMPACTED SUB

PAVING SECTION

OF SLAB)

GRADE

CONCRETE

SCALE: NOT TO SCALE

C3

STEEL BOLLARD SECTION SCALE: NOT TO SCALE

SITE DIMENSION PLAN

S 89°35'00" W

-(\$ 89<u>(35'00" W)</u> -

MENAUL BOULEVARD NE

(100' RIGHT-OF-WAY)


Recorded Plat filed July 28, 1948

Book: C, Folio: 105


C3 SCALE: 1" = 20"


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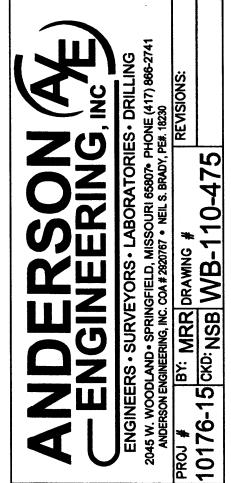
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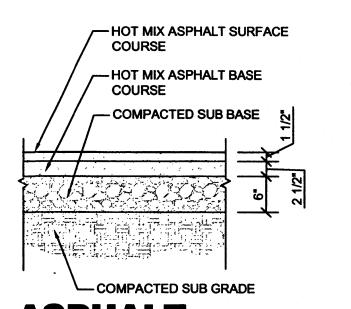
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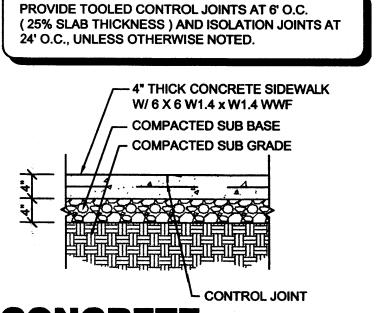


SHEET ADDED TO SET

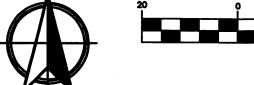


ASPHALT PAVING SECTION

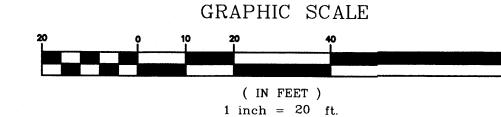
SCALE: NOT TO SCALE

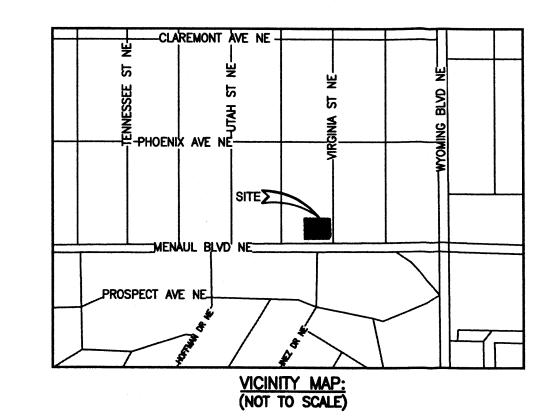

CONCRETE SIDEWALK SECTION SCALE: NOT TO SCALE C3

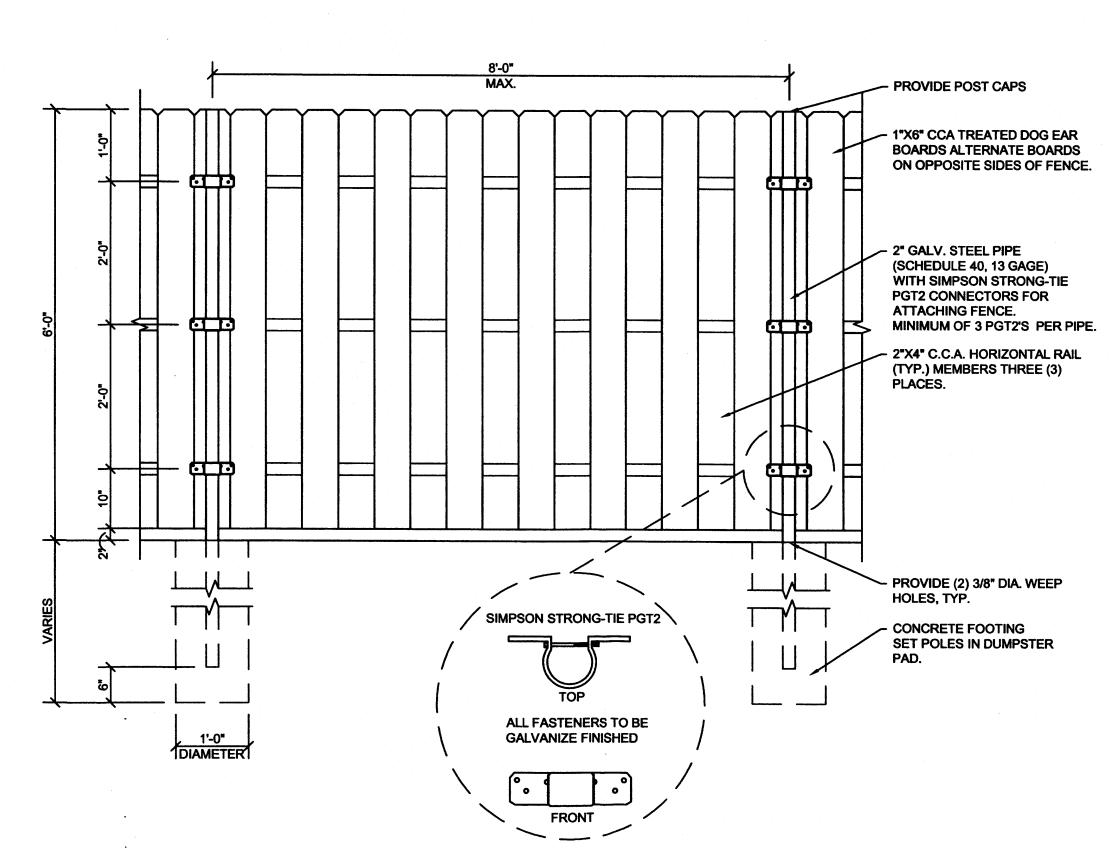

SCREEN FENCE SCALE: NOT TO SCALE

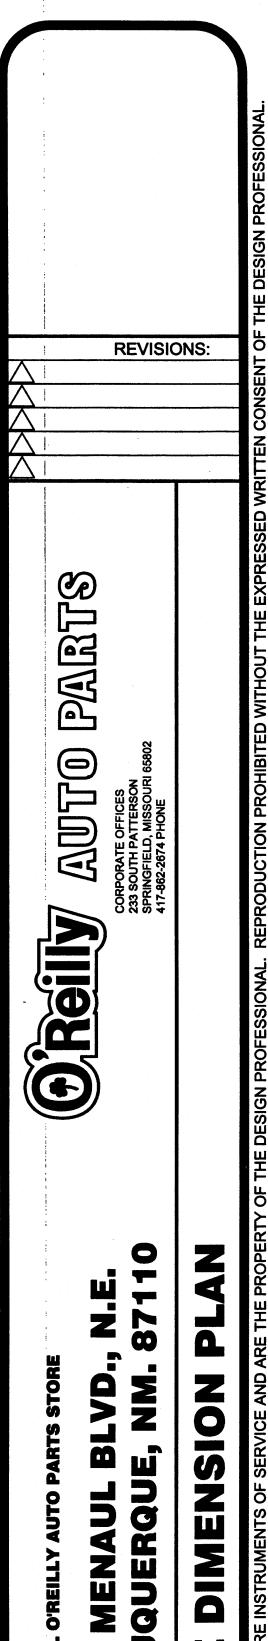

₩ ₹ DRAWN: MRR CHECKED: NSB DATE: 03/10/16 JOB NO.: 315619 (A16) SHEET: