CITY OF ALBUQUERQUE

Planning Department Alan Varela, Director



June 24, 2022

Scott McGee, P.E. 9700 Sand Verbena Trail NE Albuquerque, NM 87122

RE: 2440 Louisiana Office Bldg Grading & Drainage Plan Engineer's Stamp Date: 06/07/22

Hydrology File: H19D084A

Dear Mr. McGee:

Based upon the information provided in your submittal received 06/13/2022, the Grading & Drainage Plans are approved for Building Permit. Please attach a copy of this approved plan in the construction sets for Building Permit processing along with a copy of this letter.

PO Box 1293

PRIOR TO CERTIFICATE OF OCCUPANCY:

Albuquerque

1. Engineer's Certification, per the DPM Part 6-14 (F): *Engineer's Certification Checklist For Non-Subdivision* is required.

NM 87103

- www.cabq.gov
- 2. Please provide the Drainage Covenant with Exhibit A for the underground detention system per Article 6-15(C) of the DPM prior to Permanent Release of Occupancy. Please submit the original copies along with the \$ 25.00 recording fee check made payable to Bernalillo County to Carrie Compton (cacompton@cabq.gov) on the 4th floor of Plaza de Sol. Please note that Hydrology will need a pdf copy of the recorded Drainage Covenant prior to Hydrology's approval of Permanent Release of Occupancy.
- 3. Prior to the backfill of the underground detention system, please composed an Engineer Certification letter for the underground detention system with construction photos. This letter must be included in the Grading & Drainage submittal for Permanent Release of Occupancy.

As a reminder, if the project total area of disturbance (including the staging area and any work within the adjacent Right-of-Way) is 1 acre or more, then an Erosion and Sediment Control (ESC) Plan and Owner's certified Notice of Intent (NOI) is required to be submitted to the Stormwater Quality Engineer (Doug Hughes, PE, jhughes@cabq.gov, 924-3420) 14 days prior to any earth disturbance.

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Mayor Timothy M. Keller

If you have any questions, please contact me at 924-3995 or rbrissette@cabq.gov.

Renée C. Brissette

Renée C. Brissette, P.E. CFM Senior Engineer, Hydrology Planning Department

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Albuquerque

NM 87103

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City of Albuquerque

Planning Department


Development & Building Services Division


DRAINAGE AND TRANSPORTATION INFORMATION SHEET (REV 10/2018)

Project Title:	Building	Permit #:	#: Hydrology File #:	
DRB#:	EPC#:		Work Order#:	
Legal Description:				
City Address:				
Applicant:			Contact	
Address:Phone#:				
Other Contact:				
Address:				_
Phone#:				
TYPE OF DEVELOPMENT:	PLAT (# of lots)	RESIDENCE _	DRB SITE	ADMIN SITE
IS THIS A RESUBMITTAL? Y				
DEPARTMENT: TRAFFIC/TI		HYDROLOG	Y/DRAINAGE	
Check all that Apply: TYPE OF SUBMITTAL: ENGINEER/ARCHITECT CERTIFICATION PAD CERTIFICATION CONCEPTUAL G & D PLAN GRADING PLAN DRAINAGE MASTER PLAN DRAINAGE REPORT FLOODPLAIN DEVELOPMENT PERMIT APPLIC ELEVATION CERTIFICATE CLOMR/LOMR TRAFFIC CIRCULATION LAYOUT (TCL) TRAFFIC IMPACT STUDY (TIS) OTHER (SPECIFY) PRE-DESIGN MEETING?		TYPE OF APPROVAL/ACCEPTANCE SOUGHT: BUILDING PERMIT APPROVAL CERTIFICATE OF OCCUPANCY PRELIMINARY PLAT APPROVAL SITE PLAN FOR SUB'D APPROVAL SITE PLAN FOR BLDG. PERMIT APPROVAI FINAL PLAT APPROVAL SIA/ RELEASE OF FINANCIAL GUARANTEE FOUNDATION PERMIT APPROVAL GRADING PERMIT APPROVAL SO-19 APPROVAL PAVING PERMIT APPROVAL GRADING/ PAD CERTIFICATION WORK ORDER APPROVAL CLOMR/LOMR FLOODPLAIN DEVELOPMENT PERMIT OTHER (SPECIFY)		

FEE PAID:___



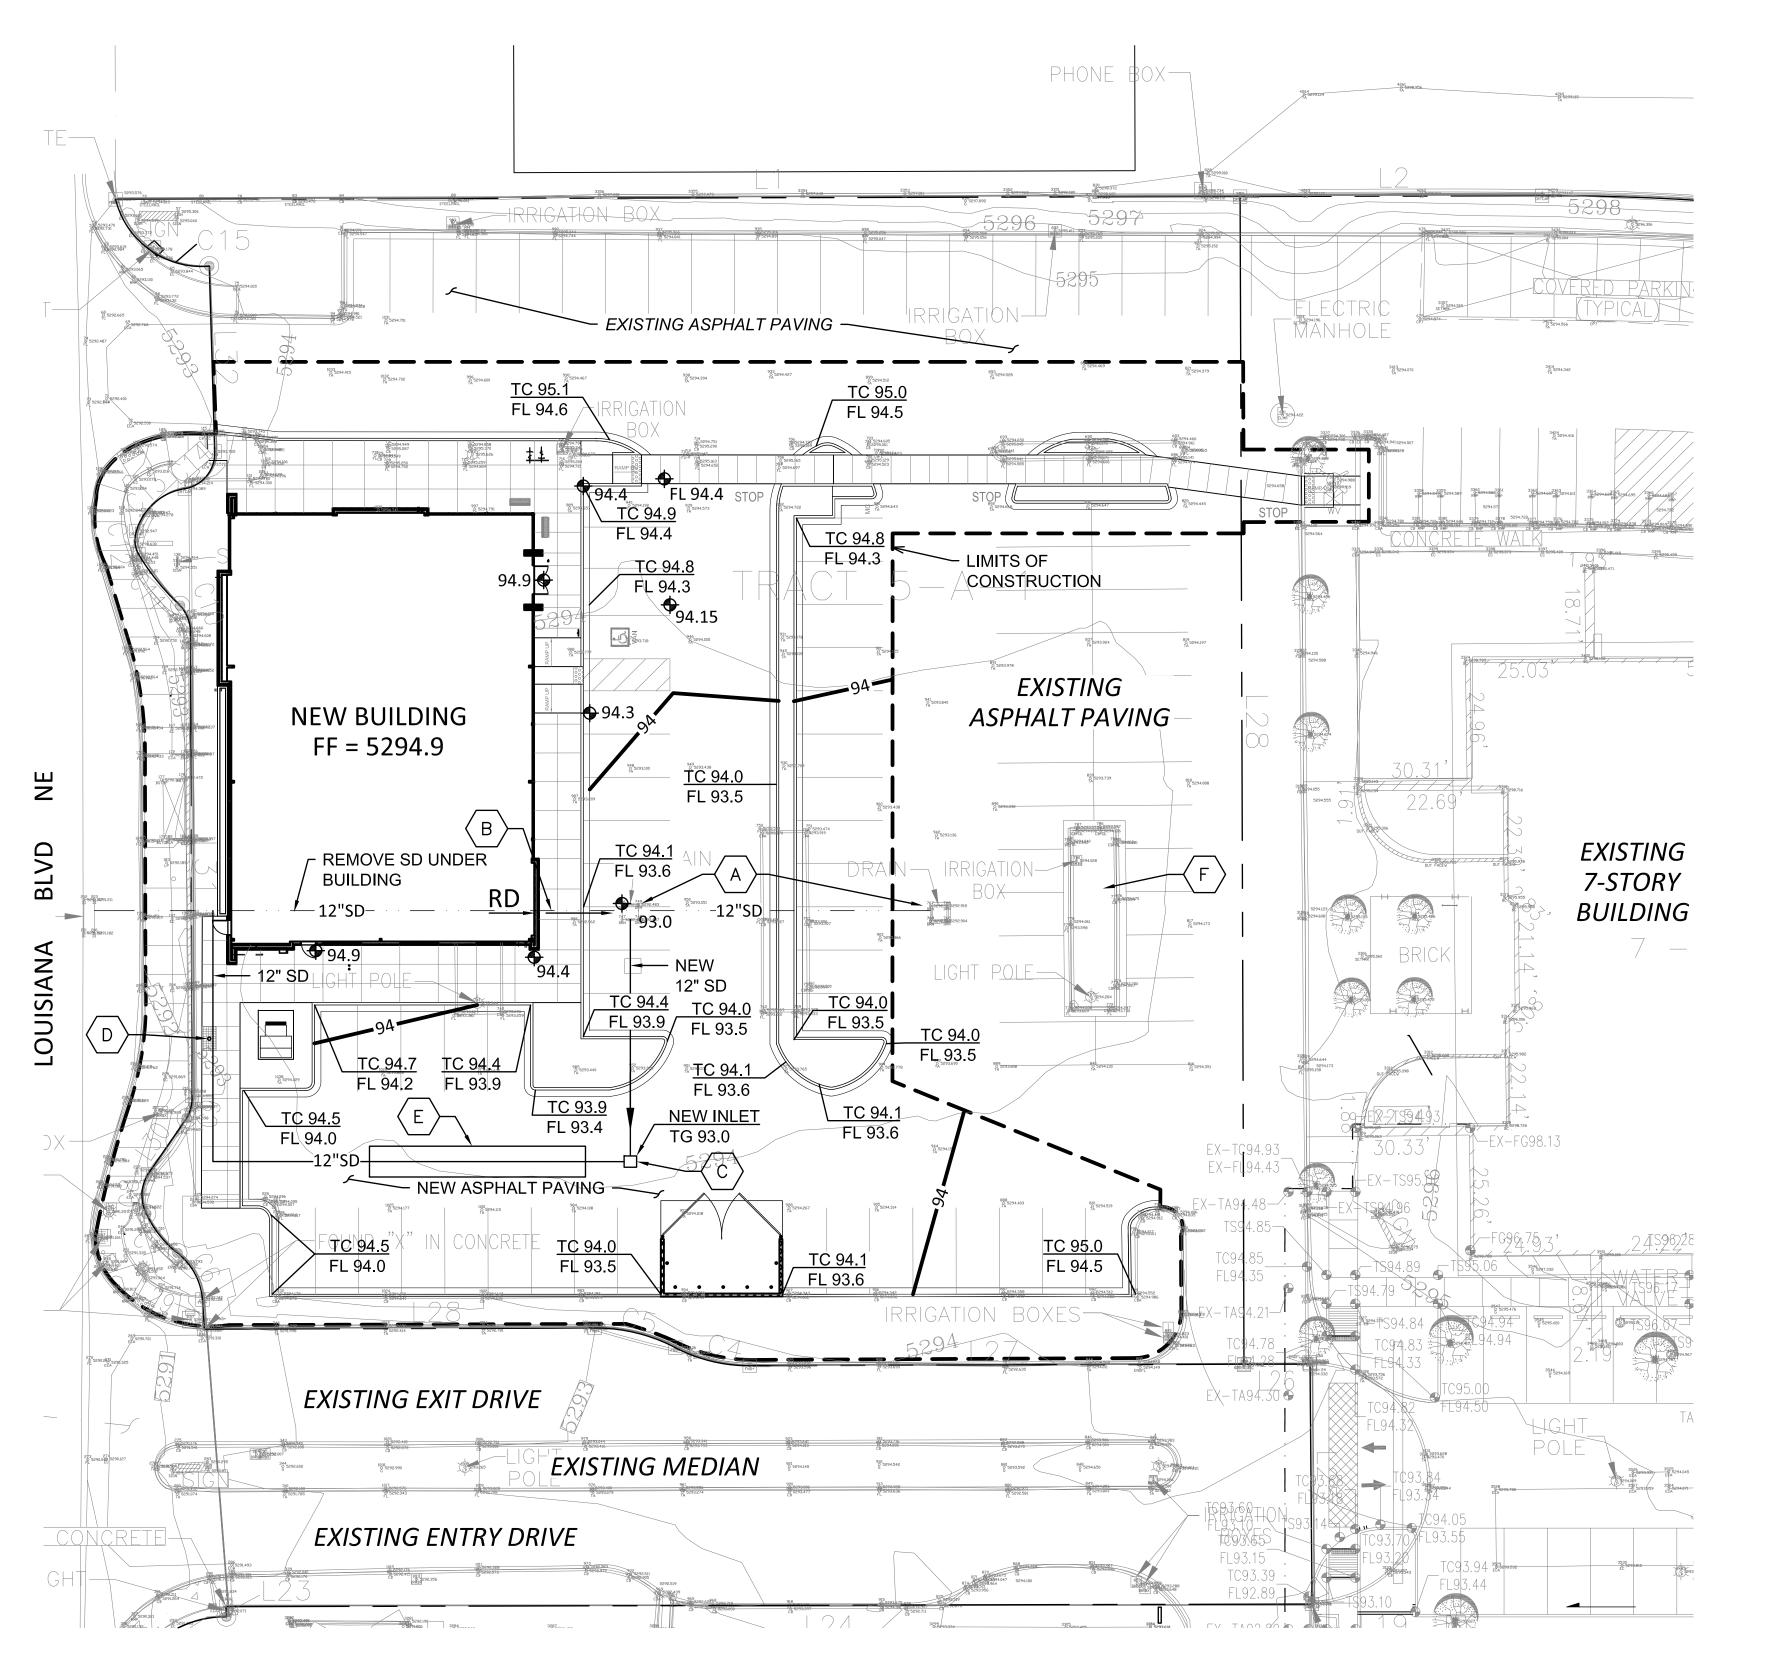

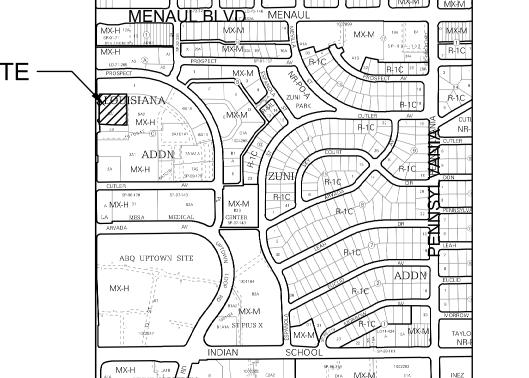

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VICINITY MAP

H-19-Z

LEGEND

EXISTING CONSTRUCTION NEW CONTOUR FF=5294.9 PROPOSED BUILDING FINISH FLOOR ELEV **NEW SPOT ELEVATION NEW CONSTRUCTION ROOF DRAIN** TOP OF CURB

KEYED NOTES

- A. EXISTING DRAINAGE INLET TO REMAIN.
- B. NEW ROOF DRAIN PIPED TO EXISTING INLET.
- C. NEW DROP INLET WITH 4" OUTLET ORIFICE.
- D. NEW 12" STORM DRAIN LINE TO CONNECT TO EXISTING STORM
- E. NEW UNDERGROUND STORAGE SHALL PROVIDE 1070 CF STORAGE. USE 6 STORMTECH MC-3500 CHAMBERS (ON 9" GRAVEL FOUNDATION) WITH END CAPS TO PROVIDE 1140 CF STORAGE VOLUME.
- F. EXISTING PARKING LOT MEDIAN TO REMAIN.

DRAINAGE ANALYSIS

ADDRESS: 2440 Louisiana Blvd NE, Albuquerque, NM

LEGAL DESCRIPTION: TRACT 5-A-1, BLOCK C LOUISIANA SUBDIVISION

AREA: 52,870 SF (1.21 AC) SITE AREA = 0.68 ACRES

BENCHMARK: City of Albuquerque Station '15-H18' being a brass cap. ELEV= 5303.391 (NAVD 1988)

SURVEYOR: Survey Office LLC, dated July 2019

PRECIPITATION ZONE: 3

FLOOD HAZARD: From FEMA Map 35001C0352H (8/16/12), this site is identified as being within Zone 'X' which is determined to be of minimal flood hazard.

OFFSITE FLOW: The site does not accept offsite flows.

EXISTING CONDITIONS: The site is a fully developed portion of an existing site with asphalt parking and some landscaping. The prior drainage file (H19-D084) was prepared by BHI in 1984. This site was identified as Basin 5 with a required storage of 5,720 CF and allowable Q=0.5 CFS. The site drains to the center of the lot where an inlet accepts runoff and discharges to an existing inlet in Louisiana NE.

PROPOSED IMPROVEMENTS: The proposed redevelopment of the site includes a new 5,660 SF office building, associated paved access and parking, and landscaping.

DRAINAGE APPROACH: The site drainage pattern will follow the DMP for the American Financial Center referenced above. The existing storm drain will be re-routed onsite to the south of the new building. A new inlet will accept site runoff which will be directed to underground storage to offset the loss in surface storage volume.

Existing land treatment: 10% C and 90% D Q = [(.10)(3.45) + (0.90)(5.02)](1.21) = 5.9 CFS

Proposed land treatment: 2% B, 4% C and 94% D Q = [(0.02)(2.60) + (0.04)(3.45) + (0.94)(5.02)](1.21) = 5.9 CFS

Redevelopment SWQ V= (29,620)(0.26/12)= 642 CF Ponding provided: Surface V=4650 CF at WSEL=94.0 Underground storage V= 5720-4650= 1070 CF Orifice equation for H=2.5' and 4" diameter orifice: Q=KxA(2gH)*1/2=(0.7)(0.087)(12.7)=0.7 CFS

TRUE NORTH

Architect



Engineer

STUDIO SW

OFFICE BUILDING

2442 Louisiana Boulevard NE ALBUQUERQUE. NM 87110

Key Plan

No	Date	Description		
Revision Schedule				
ISSUE:		PERMIT SET		
PROJECT NUMBER:		2130		
FILE:		2130 Office Building		
DRAWN BY:		JSK		
CHECKED BY:		SSM		
DATE:		6/7/2022		

SHEET TITLE

GRADING & DRAINAGE PLAN

C101

GRADING & DRAINAGE PLAN

1" = 20'-0"