# CITY OF ALBUQUERQUE

Planning Department Suzanne Lubar, Director



December 11, 2015

Troy Kelts, P.E. Merrick & Company 5970 Greenwood Plaza Blvd Greenwood Village, CO 80015

RE: Chick-fil-A on Wyoming
2274 Wyoming Blvd. NE
Requested for 30 Day Temporary C. O. - Accepted
Engineers Stamp Date 6/23/15 (H20D003C)

Dear Mr. Kelts,

PO Box 1293

Based on the certification provided in your submittal received 12/10/2015, the above referenced is approved for a 30-day Temporary Release of Occupancy by Hydrology. However, before a permanent CO can be accepted the following comments must be addressed.

Albuquerque

- The pond on the southwest corner must be completed.
- The pond on the west side must be completed.

New Mexico 87103

An inspection by our office will need to take place after these corrections are made. Another request for a permanent certificate of occupancy must be submitted.

If you have any questions, you can contact me at 924-3686 or Totten Elliott at 924-3982.

www.cabq.gov

Abiel Carrillo, P.E.,


Principal Engineer, Planning Department


Development and Review Services

Sincerely,

Sincerely

TE/AC C: File

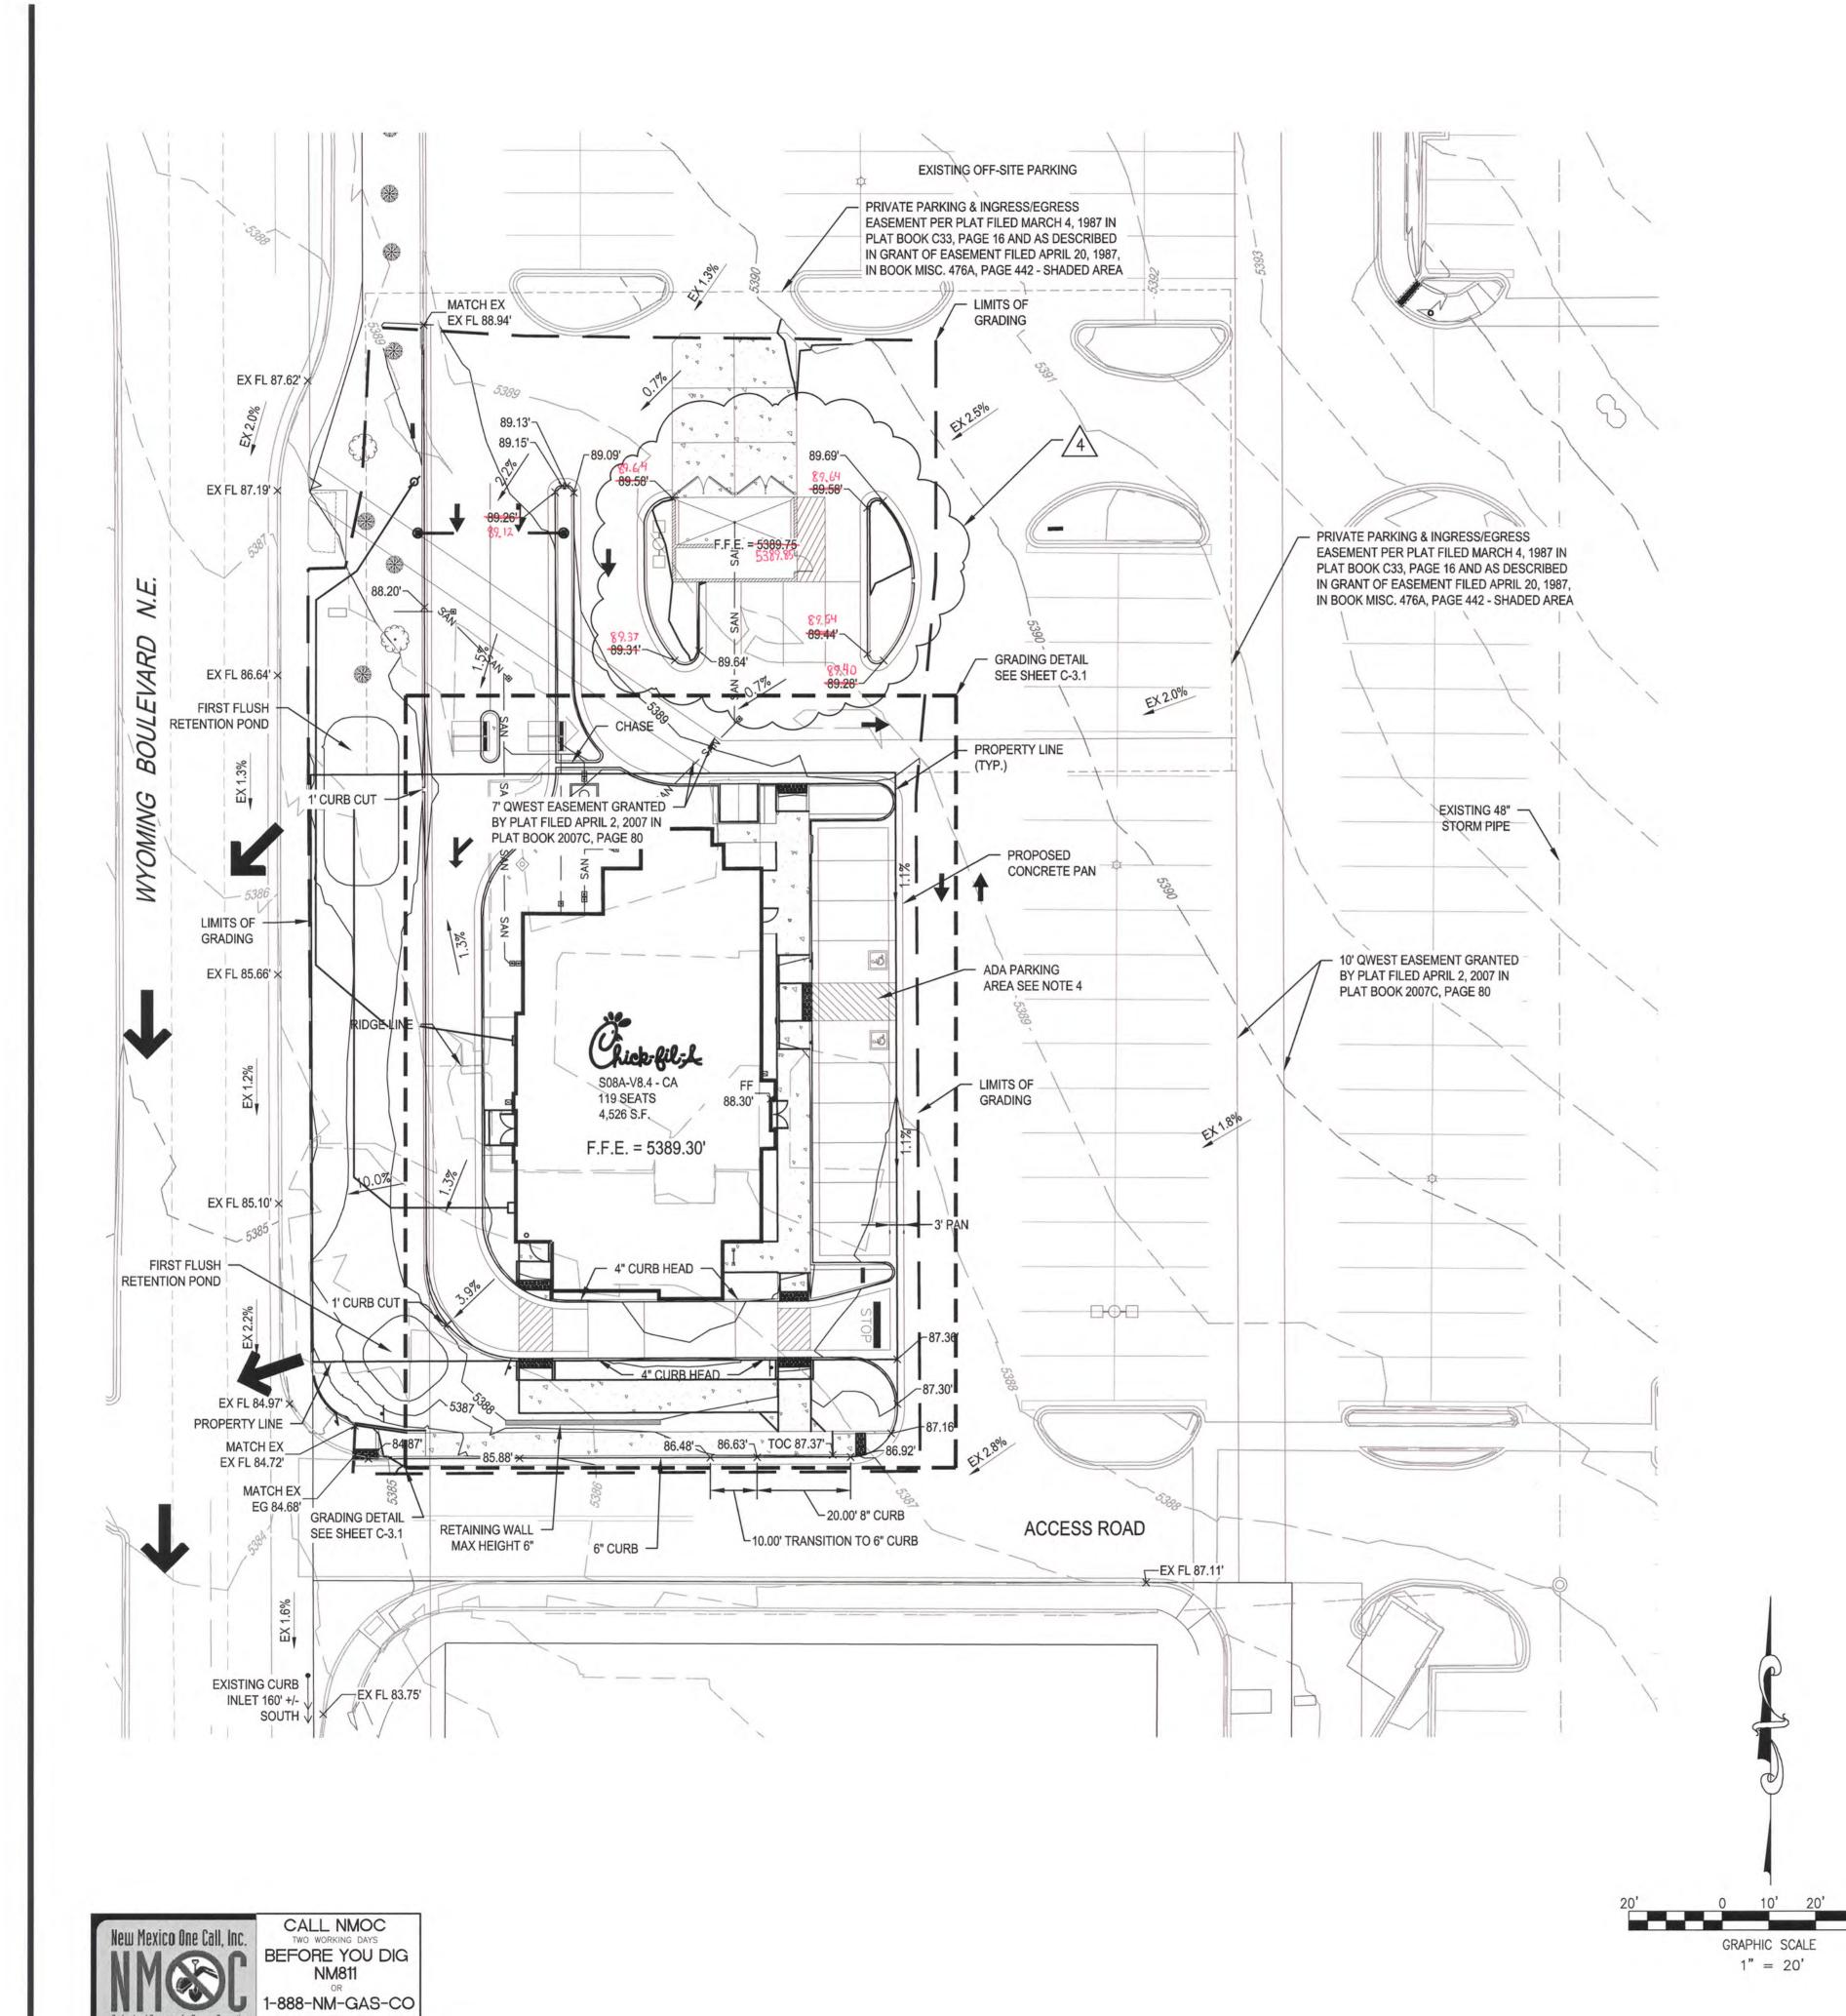

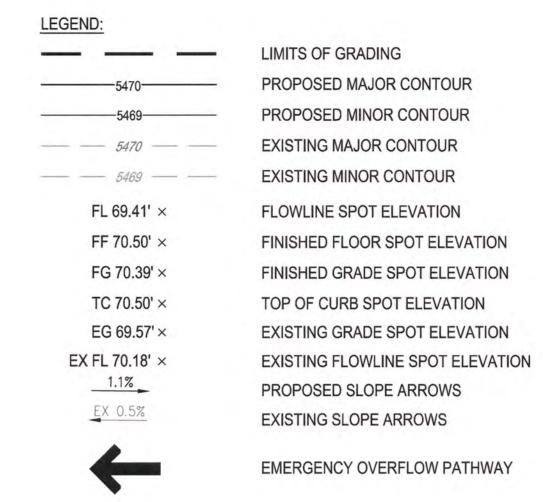

### NOTE

- 1. REFER TO SHEET C-1.0 FOR GENERAL NOTES AND LEGEND.
- . ALL ELEVATIONS SHOWN ARE 53XX.XX'
- 3. ELEVATIONS SHOWN ARE FLOWLINE UNLESS SPECIFIED OTHERWISE
- 4. ADA PARKING STALLS SHALL HAVE A MAXIMUM OF 2.0% SLOPE IN ANY DIRECTION.
- PROPOSED UTILITIES.
- 6. CURB CUTS TO ALLOW FOR SURFACE RUNOFF TO FLOW INTO DEPRESSED COLLECTION AREAS IN PLANTER ISLANDS. REFER TO LANDSCAPE PLAN FOR FURTHER INFORMATION ON BIORETENTION / ON-SITE WATER HARVESTING AREAS & PLANTINGS TO BE UTILIZED.

REFER TO PS-1.0 - UTILITY PLAN FOR FURTHER INFORMATION ON EXISTING AND

- 7. ALL CURB TO BE 6" UNLESS SPECIFIED OTHERWISE
- 8. TRANSITION FROM 4" CURB HEAD TO 6" CURB HEAD IN THIS AREA
- REFER TO DN-1.0 FOR DEVELOPED DRAINAGE MAP

### DRAINAGE NARRATIVE DESCRIPTION

THE SITE IS CURRENTLY A BANK WITH LANDSCAPE ISLANDS SEPARATING WYOMING BLVD FROM THE BUILDING. THE SITE GENERALLY SLOPES FROM NORTHEAST TO SOUTHWEST TOWARDS WYOMING BLVD. EXISTING SLOPES WITHIN THE PARKING LOT ARE LESS THAN 3%. EXISTING SIDEWALK SURROUNDS THE SITE TO THE WEST AND SOUTH. THE STORM WATER SHEET FLOWS ACROSS THE SITE AND SPILLS OVER THE SIDEWALK IN THE SOUTHWEST CORNER INTO WYOMING BLVD. THERE IS NO INLET LOCATED WITHIN THE SITE. AN EXISTING INLET IS LOCATED IN WYOMING BLVD APPROXIMATELY 225' SOUTH OF THE PROPERTY LINE.

THE PROPOSED GRADING WILL IMPROVE THE EXISTING DRAINAGE CONDITIONS FOR THE PROJECT SITE. THE PROPOSED SITE WILL FLOW FROM THE NORTHEAST TO THE SOUTHWEST. THE SITE AREA LOCATED NORTH OF THE BUILDING WILL SHEET FLOW AND FLOW ALONG CURB AND GUTTER, UNTIL IT ENTERS A CURB CHASE LOCATED WITHIN THE DRIVE-THRU, THE CURB CHASE WILL DIRECT RUNOFF INTO THE NORTHERN RETENTION POND. THE NORTHERN RETENTION POND IS SIZED TO RETAIN THE FIRST FLUSH (INITIAL 0.34" OF RAINFALL) FROM THE IMPERVIOUS AREA ON THE NORTHERN SIDE OF THE PROPERTY. THIS DOES NOT INCLUDE THE OFFSITE AREA THAT WILL DRAIN THROUGH THE PROPOSED SITE. THE POND IS SIZED TO RETAIN 345 CUBIC FEET (THE FIRST 0.34" FROM 0.28 ACRES OF IMPERVIOUS AREA). DEVELOPED RUNOFF IN EXCESS OF THIS AMOUNT WILL FLOW ACROSS THE RETENTION POND INTO WYOMING BOULEVARD.THE SOUTHERN PORTION OF THE SITE WILL SHEET FLOW AND FLOW ALONG CURB AND GUTTER, UNTIL IT ENTERS A CURB CHASE. THE CURB CHASE WILL DIRECT RUNOFF INTO THE SOUTHERN RETENTION POND. THE SOUTHERN RETENTION POND IS SIZED TO RETAIN THE FIRST FLUSH (INITIAL 0.34" OF RAINFALL) FROM THE IMPERVIOUS AREA ON THE SOUTHERN SIDE OF THE PROPERTY. THE POND IS SIZED TO RETAIN 115 CUBIC FEET (THE FIRST 0.34" FROM 0.092 ACRES OF IMPERVIOUS AREA). DEVELOPED RUNOFF IN EXCESS OF THIS AMOUNT WILL FLOW ACROSS THE RETENTION POND INTO WYOMING BOULEVARD. THE EASTERN PORTION OF THE SITE WILL SHEET FLOW TOWARDS A PAN, WHERE IT WILL THEN FLOW INTO THE SHARED ACCESS DRIVE LOCATED SOUTH OF THE BUILDING. ALL DEVELOPED RUNOFF THAT ENTERS WYOMING BOULEVARD WILL FLOW TO AN EXISTING INLET LOCATED APPROXIMATELY 225' SOUTH OF THE PROPERTY LINE.

THE PROPOSED SITE WILL INCREASE THE AMOUNT OF PERVIOUS AREA FROM THE EXISTING CONDITIONS, AND DECREASE THE OVERALL DEVELOPED RUNOFF FROM THE PROPERTY TO THE WYOMING BLVD. RIGHT-OF-WAY.

# DRAINAGE CERTIFICATION WITH SURVEY WORK BY PROFESSIONAL SURVEYOR

I, TROY D. KELTS, NMPE 22102, OF FIRM, MERRICK & COMPANY, HEREBY CERTIFY THAT THIS PROJECT HAS BEEN GRADED AND WILL DRAIN IN SUBSTANTIAL COMPLIANCE WITH AND IN ACCORDANCE WITH THE DESIGN INTENT OF THE APPROVED PLAN DATE MARCH 18TH, 2015. THE RECORD INFORMATION EDITED ONTO THE ORIGINAL DESIGN DOCUMENT HAS BEEN OBTAINED BY ANDREW S. MEDINA, NMPS 12649 OF THE FIRM SANDIA LAND SURVEYING. I FURTHER CERTIFY THAT I HAVE PERSONALLY VISITED THE PROJECT SITE ON DECEMBER 9TH, 2015 AND HAVE DETERMINED BY VISUAL INSPECTION THAT THE SURVEY DATA PROVIDED IS REPRESENTATIVE OF ACTUAL SITE CONDITIONS AND IS TRUE AND CORRECT TO THE BEST OF MY KNOWLEDGE AND BELIEF. THIS CERTIFICATION IS SUBMITTED IN SUPPORT OF A REQUEST FOR CERTIFICATE OF OCCUPANCY.

THE RECORD INFORMATION PRESENTED HEREON IS NOT NECESSARILY COMPLETE AND INTENDED ONLY TO VERIFY SUBSTANTIAL COMPLIANCE OF THE GRADING AND DRAINAGE ASPECTS OF THIS PROJECT. THOSE RELYING ON THE RECORD DOCUMENTS ARE ADVISED TO OBTAIN INDEPENDENT VERIFICATION OF ITS ACCURACY BEFORE USING IT FOR ANY OTHER PURPOSE.







5200 Buffington Rd. Atlanta, Georgia 30349-2998

Revisions:


Mark Date By

04/01/2015


OWNER REV

Mark Date By
05/01/2015
AGENCY REV.

Mark Date By
06/05/2015
WASTE REV.

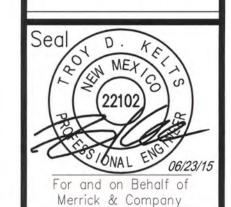



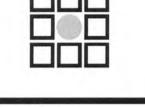

STORE
WYOMING BOULEVARD FSU
SO8H-A-WC

2274 WYOMING BLVD. NE ALBUQUERQUE, NM

GRADING PLAN

SHEET TITLE


VERSION: H-V2 ISSUE DATE: 11-2014

Job No. : 6511837 Store : 03484 Date : 03/18/1

Checked By: TDK
Sheet

Drawn By

C-3.0

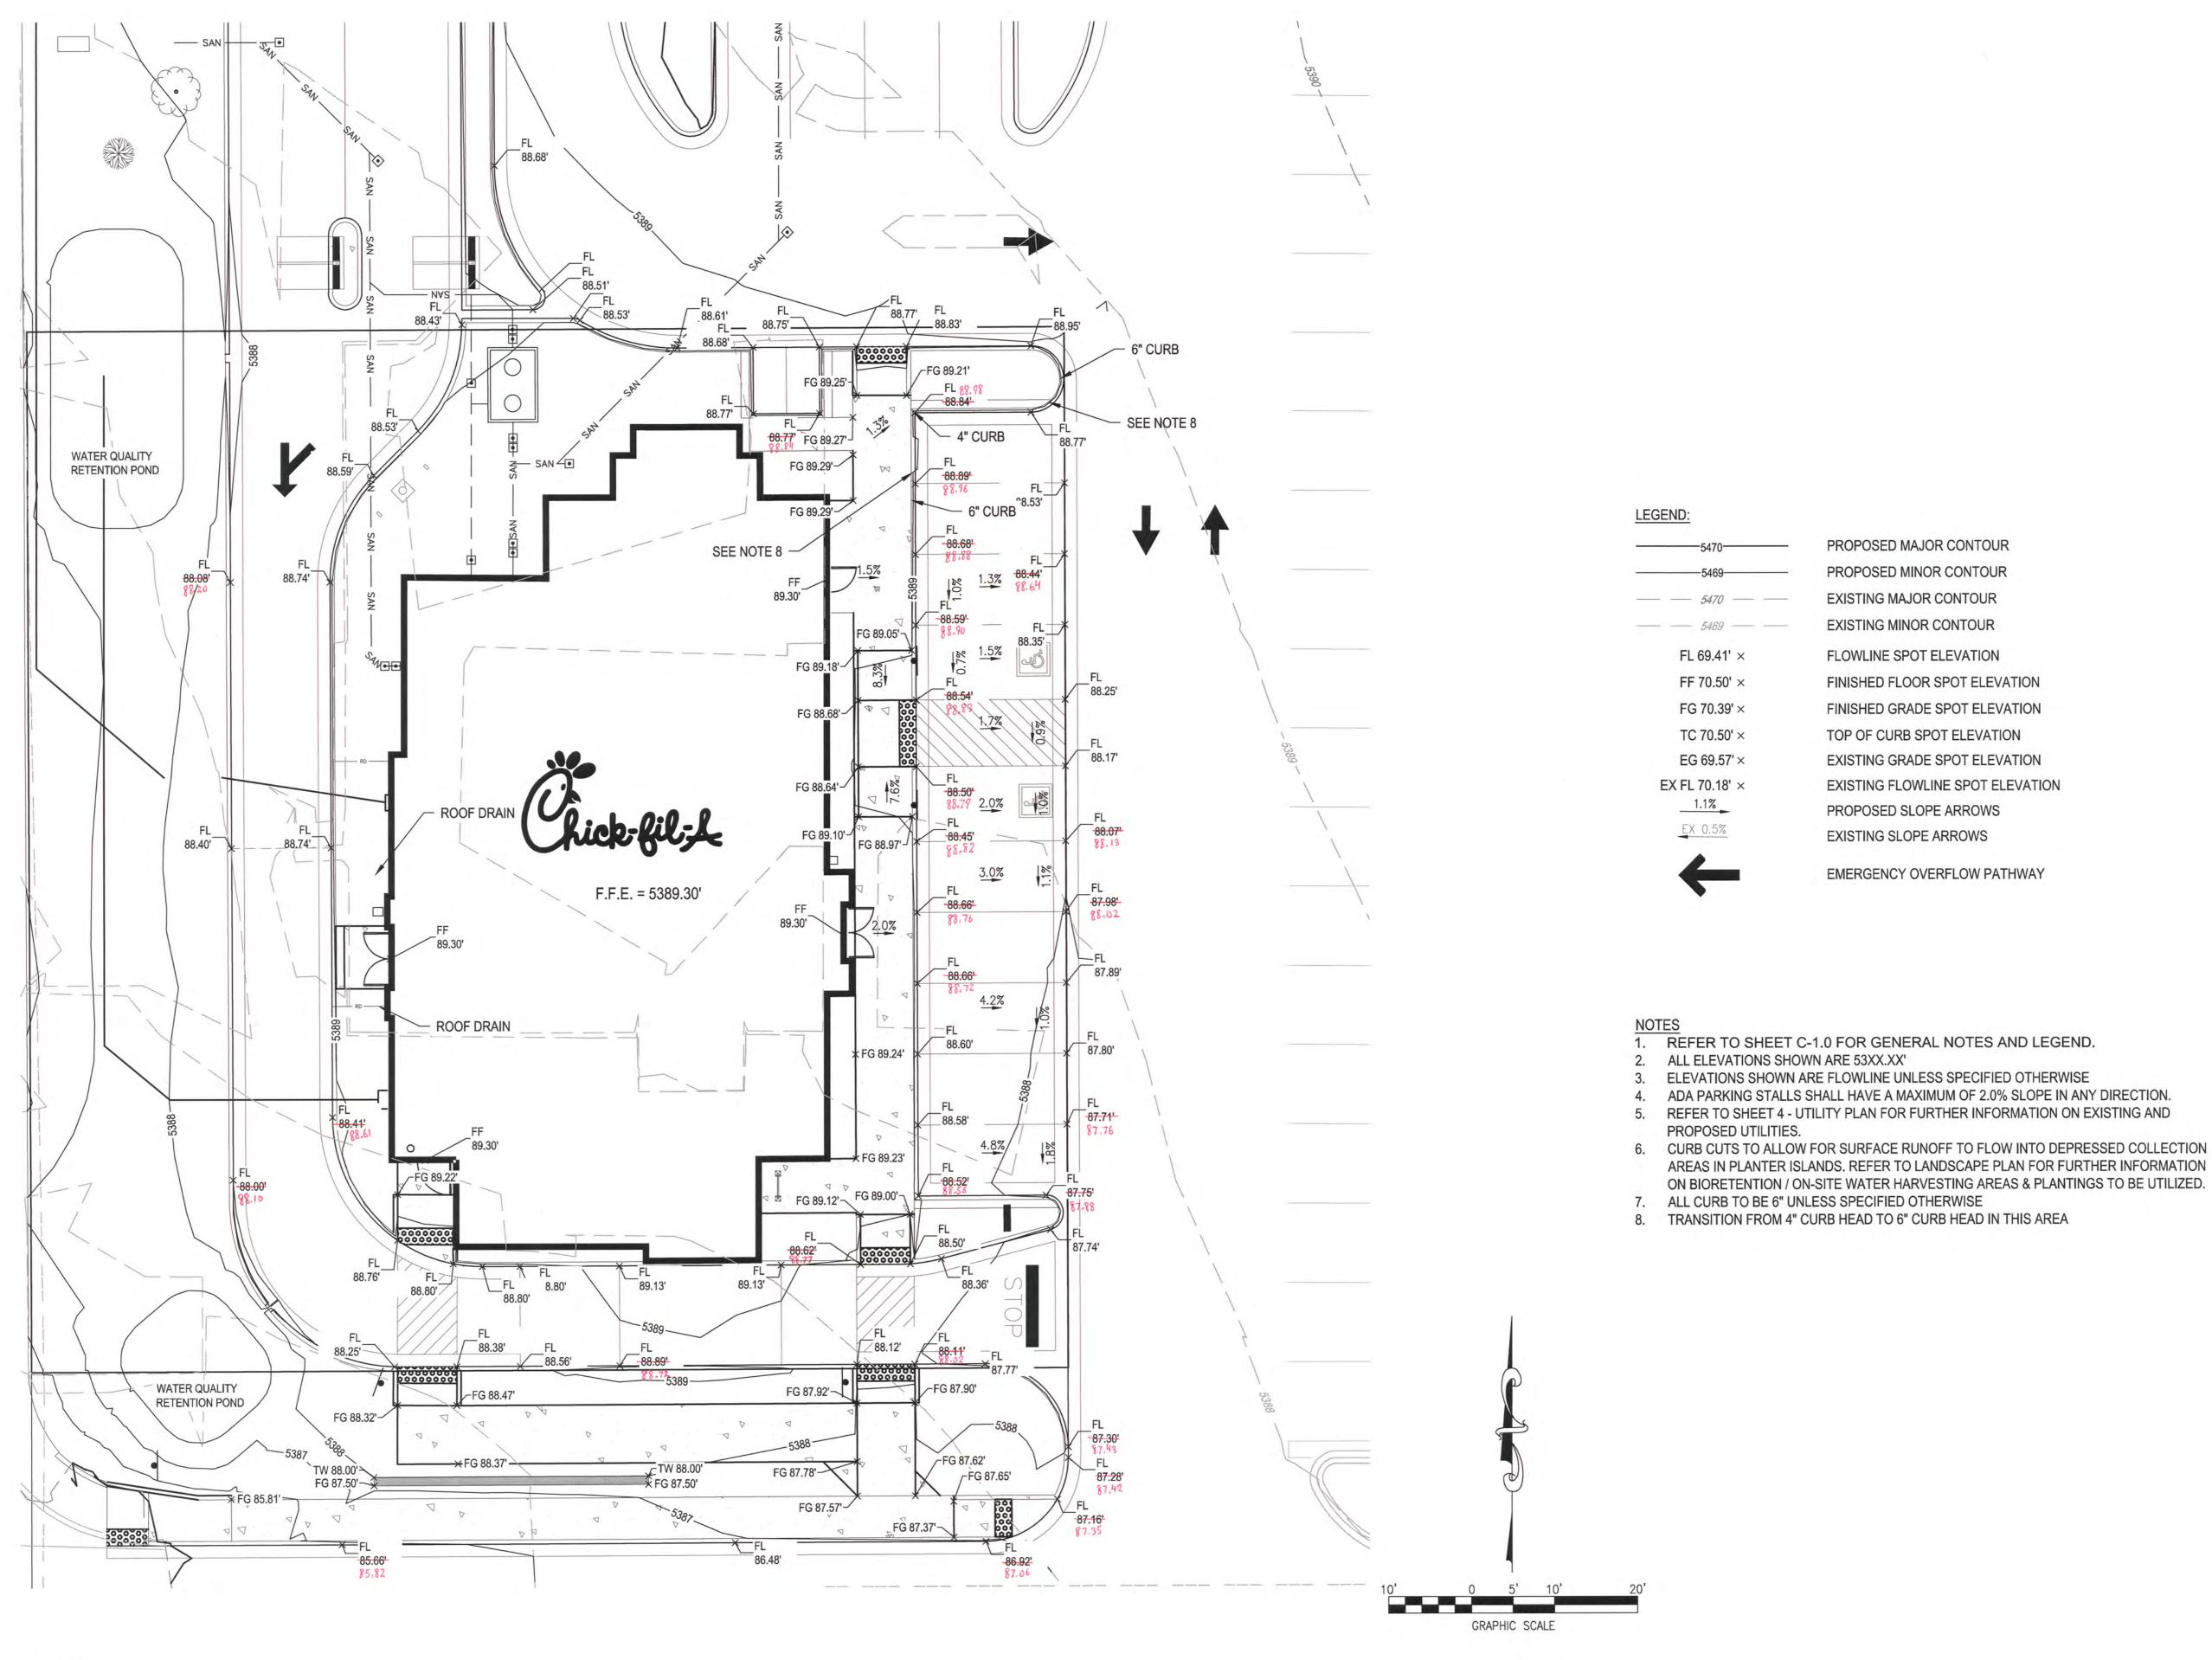



RECORD DOCUMENTS



5200 Buffington Rd. Atlanta, Georgia 30349-2998

Revisions:


Mark Date By

04/01/2015

OWNER REV

Mark Date By
05/01/2015
AGENCY REV.

Mark Date By
06/05/2015
WASTE REV.

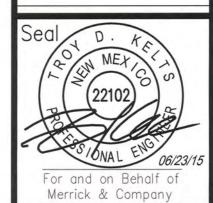

ELLICK & Combank

COMPANY

NWOOD PLAZA BLVD

VILLAGE, CO 80111
3-751-0741



STORE
WYOMING BOULEVARD FSU
SO8H-A-WC

2274 WYOMING BLVD. NE ALBUQUERQUE, NM

SHEET TITLE


GRADING DETAIL

VERSION: H-V2 ISSUE DATE: 11-2014

Job No. : 65118374
Store : 03484
Date : 03/18/15
Drawn By : \_\_JD
Checked By: \_\_TDK

Shee


C-3.1

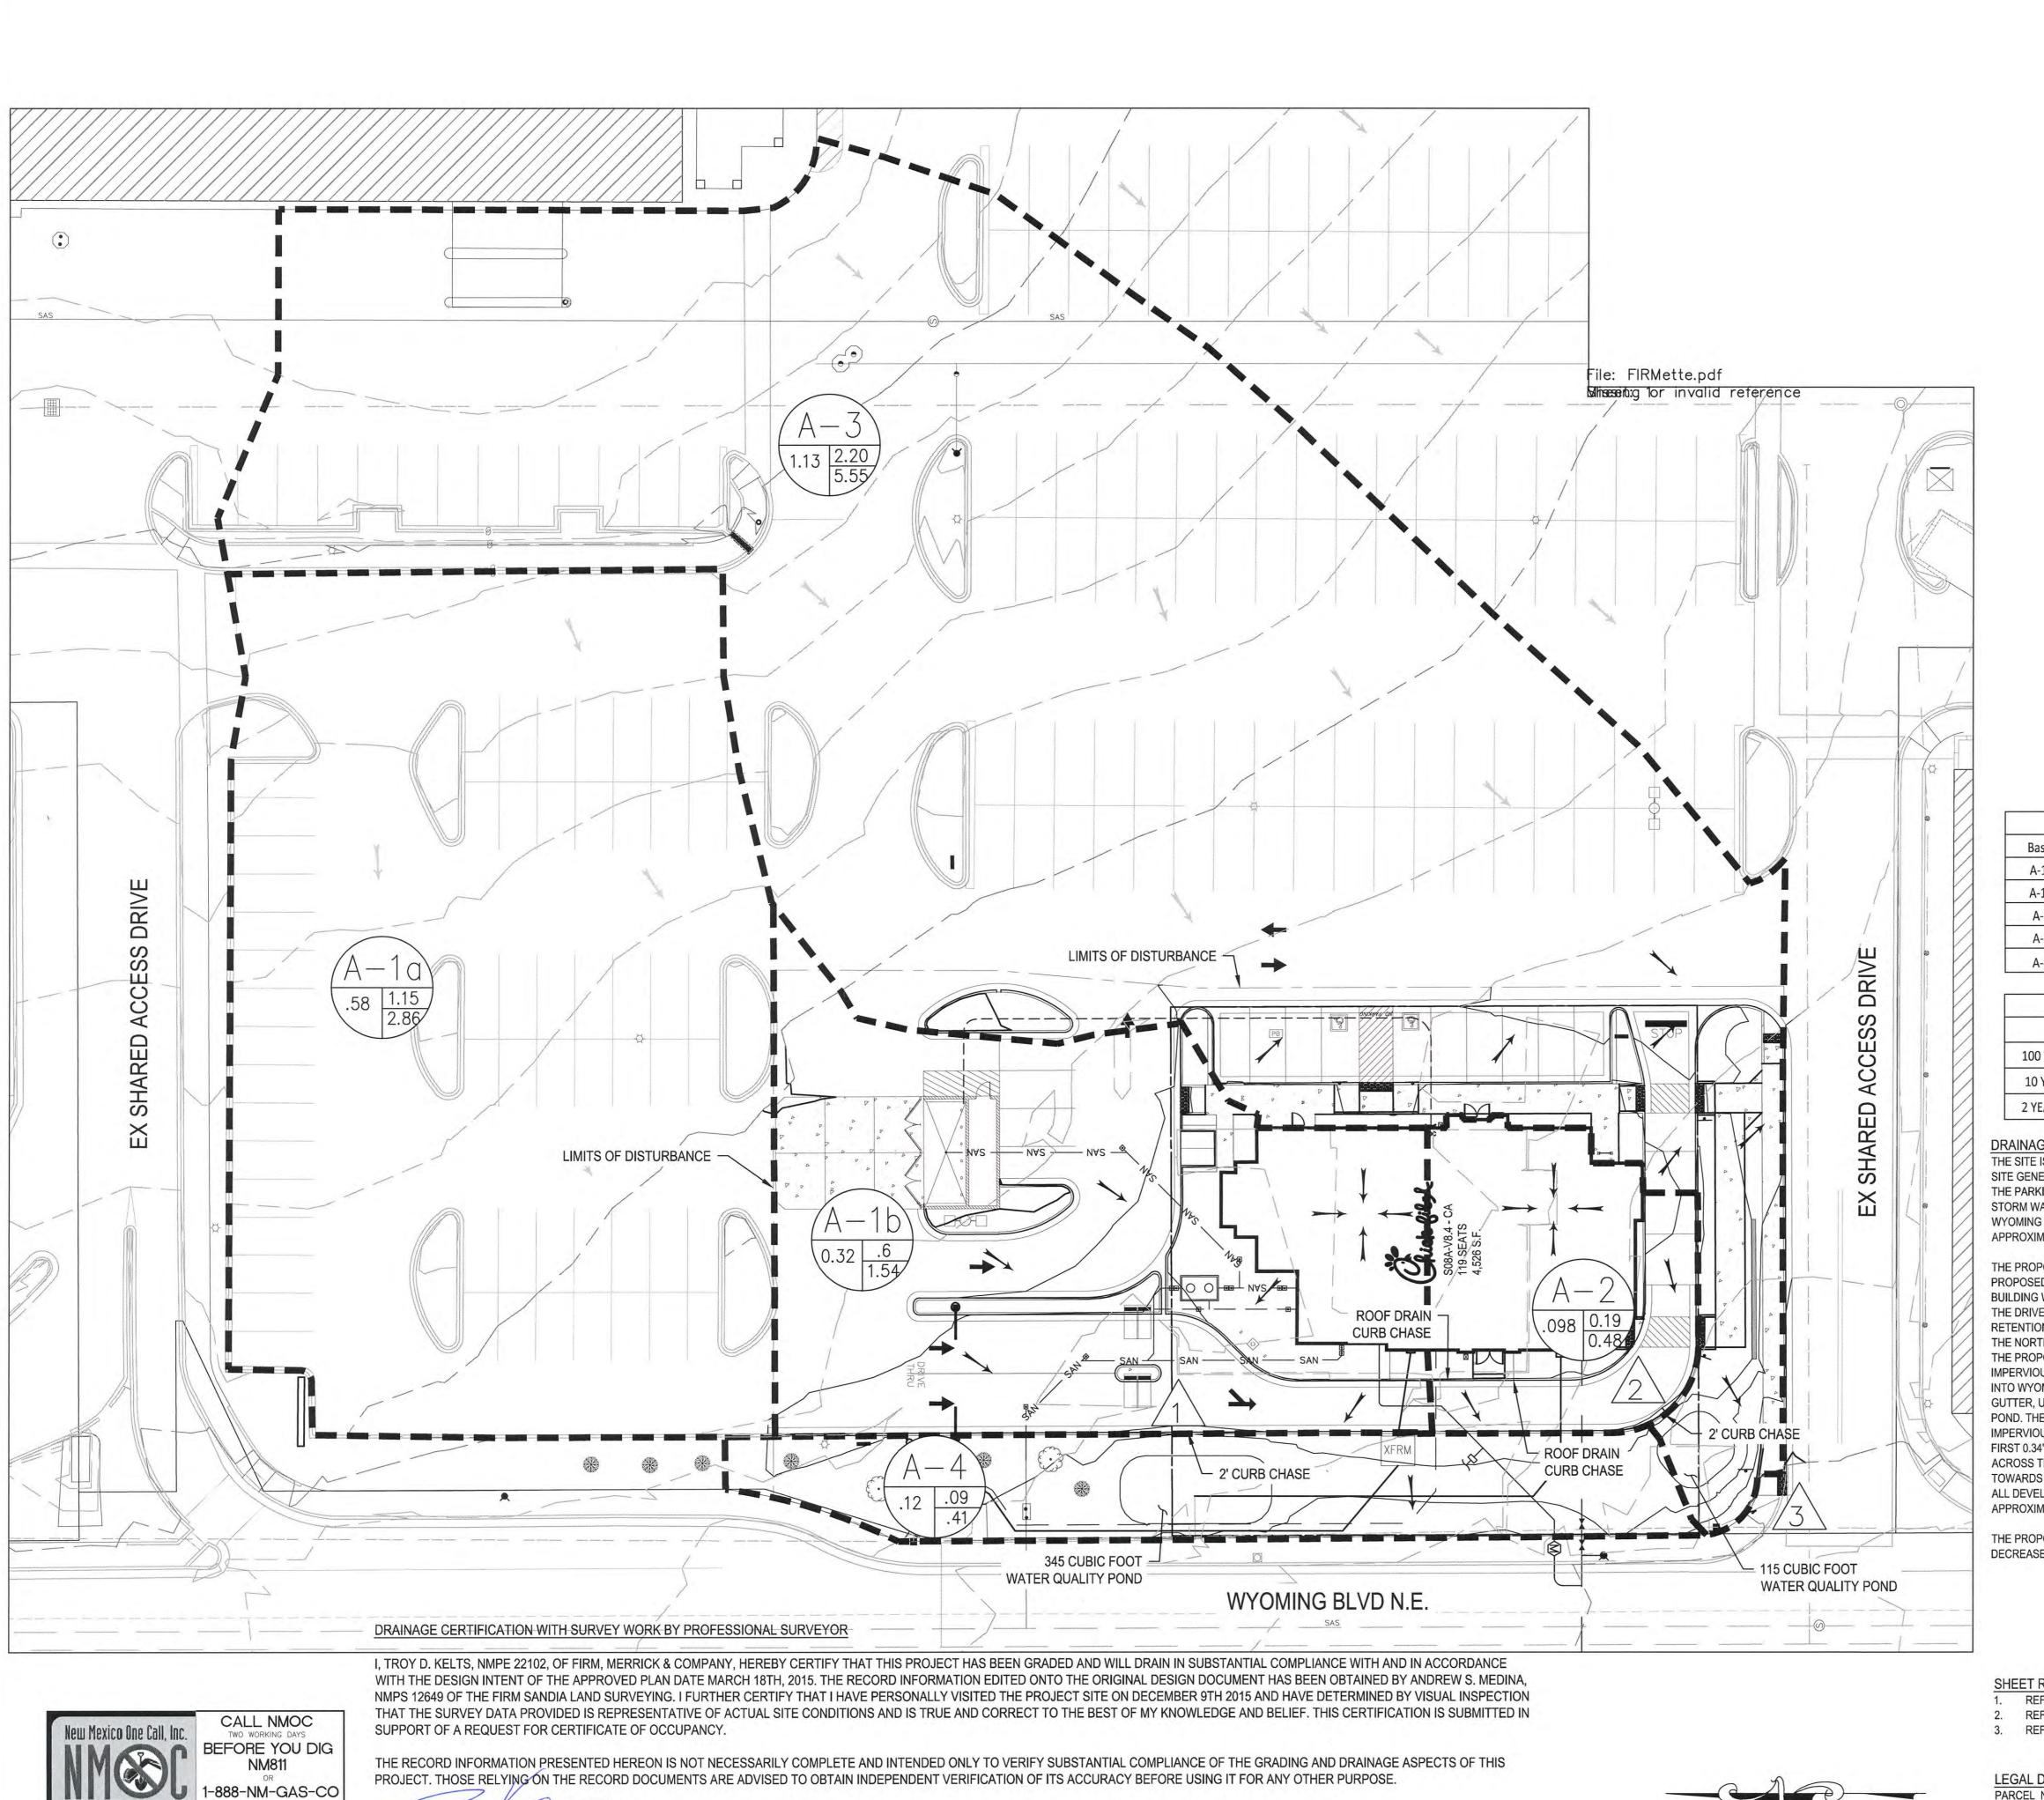


RECORD DOCUMENTS

TROY D. KELTS #22102

ZONE ATLAS: H-19-Z & H-20-Z

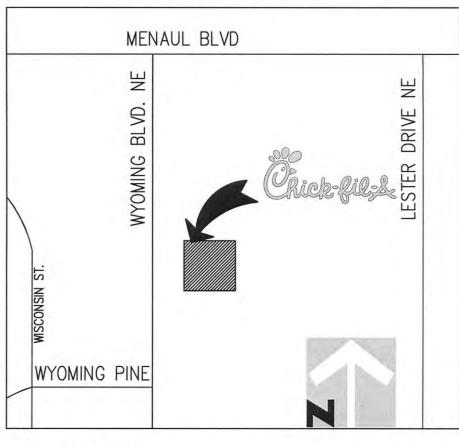

# LEGEND:

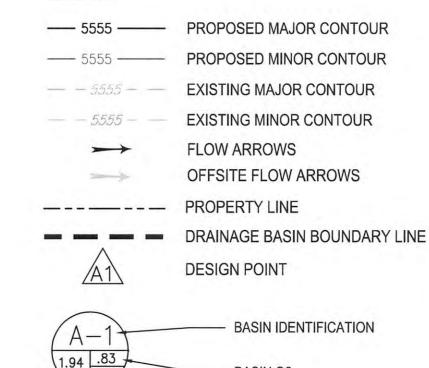

BASIN Q2 BASIN Q100

BASIN AREA (ACRES)

Basin	Land Treatment (ac)					
	Α	В	С	D		
A-1a	0	0	0.03	0.55		
A-1b	0	0	0.04	0.28		
A-2	0	0	0.006	0.092		
A-3	0	0	0.08	1.05		
A-4	0	0	0.12	0		

	Developed R	unoff Summa	ry Table		
	A-1a	A-1b	A-2	A-3	A-4
100 YR PEAK RUNOFF (cfs)	2.86	1.54	0.48	5.55	0.41
10 YR PEAK RUNOFF (cfs)	1.92	1.03	0.32	3.72	0.24
2 YEAR PEAK RUNOFF (cfs)	1.15	0.60	0.19	2.20	0.09

# DRAINAGE NARRATIVE DESCRIPTION

THE SITE IS CURRENTLY A BANK WITH LANDSCAPE ISLANDS SEPARATING WYOMING BLVD FROM THE BUILDING. THE SITE GENERALLY SLOPES FROM NORTHEAST TO SOUTHWEST TOWARDS WYOMING BLVD. EXISTING SLOPES WITHIN THE PARKING LOT ARE LESS THAN 3%. EXISTING SIDEWALK SURROUNDS THE SITE TO THE WEST AND SOUTH. THE STORM WATER SHEET FLOWS ACROSS THE SITE AND SPILLS OVER THE SIDEWALK IN THE SOUTHWEST CORNER INTO WYOMING BLVD. THERE IS NO INLET LOCATED WITHIN THE SITE. AN EXISTING INLET IS LOCATED IN WYOMING BLVD APPROXIMATELY 225' SOUTH OF THE PROPERTY LINE.

THE PROPOSED GRADING WILL IMPROVE THE EXISTING DRAINAGE CONDITIONS FOR THE PROJECT SITE. THE PROPOSED SITE WILL FLOW FROM THE NORTHEAST TO THE SOUTHWEST. THE SITE AREA LOCATED NORTH OF THE BUILDING WILL SHEET FLOW AND FLOW ALONG CURB AND GUTTER, UNTIL IT ENTERS A CURB CHASE LOCATED WITHIN THE DRIVE-THRU. THE CURB CHASE WILL DIRECT RUNOFF INTO THE NORTHERN RETENTION POND. THE NORTHERN RETENTION POND IS SIZED TO RETAIN THE FIRST FLUSH (INITIAL 0.34" OF RAINFALL) FROM THE IMPERVIOUS AREA ON THE NORTHERN SIDE OF THE PROPERTY. THIS DOES NOT INCLUDE THE OFFSITE AREA THAT WILL DRAIN THROUGH THE PROPOSED SITE. THE POND IS SIZED TO RETAIN 345 CUBIC FEET (THE FIRST 0.34" FROM 0.28 ACRES OF IMPERVIOUS AREA). DEVELOPED RUNOFF IN EXCESS OF THIS AMOUNT WILL FLOW ACROSS THE RETENTION POND INTO WYOMING BOULEVARD. THE SOUTHERN PORTION OF THE SITE WILL SHEET FLOW AND FLOW ALONG CURB AND GUTTER, UNTIL IT ENTERS A CURB CHASE. THE CURB CHASE WILL DIRECT RUNOFF INTO THE SOUTHERN RETENTION POND. THE SOUTHERN RETENTION POND IS SIZED TO RETAIN THE FIRST FLUSH (INITIAL 0.34" OF RAINFALL) FROM THE IMPERVIOUS AREA ON THE SOUTHERN SIDE OF THE PROPERTY. THE POND IS SIZED TO RETAIN 115 CUBIC FEET (THE FIRST 0.34" FROM 0.092 ACRES OF IMPERVIOUS AREA). DEVELOPED RUNOFF IN EXCESS OF THIS AMOUNT WILL FLOW ACROSS THE RETENTION POND INTO WYOMING BOULEVARD. THE EASTERN PORTION OF THE SITE WILL SHEET FLOW TOWARDS A PAN, WHERE IT WILL THEN FLOW INTO THE SHARED ACCESS DRIVE LOCATED SOUTH OF THE BUILDING. ALL DEVELOPED RUNOFF THAT ENTERS WYOMING BOULEVARD WILL FLOW TO AN EXISTING INLET LOCATED APPROXIMATELY 225' SOUTH OF THE PROPERTY LINE.

THE PROPOSED SITE WILL INCREASE THE AMOUNT OF PERVIOUS AREA FROM THE EXISTING CONDITIONS, AND DECREASE THE OVERALL DEVELOPED RUNOFF FROM THE PROPERTY TO THE WYOMING BLVD. RIGHT-OF-WAY.

# SHEET REFERENCES

- REFER TO SHEET PS-1.0 FOR UTILITY LOCATION AND CONNECTION DETAILS.
- REFER TO SHEET C-3.0 & C-3.1 FOR SITE GRADING DETAILS. REFER TO SHEET C-3.2 FOR EROSION CONTROL PLANS.

# LEGAL DESCRIPTION

PARCEL NUMBERED THREE (.3), AMENDED SUMMARY PLAT OF THE WYOMING MALL, AS THE SAME ARE SHOWN AND DESIGNATED ON THE PLAT THEREOF, FILED IN THE OFFICE OF THE COUNTY CLERK OF BERNALILLO COUNTY. NEW MEXICO, ON JULY 12, 197B, IN PLOT BOOK D8, PAGE 163 AND RE-RECORDED OCTOBER 18, 1978, IN PLOT BOOK D9, PAGE 11.




Atlanta, Georgia 30349—2998 Revisions:

Mark Date By
04/01/2015
OWNER REV

Mark Date By
05/01/2015
AGENCY REV.

Mark Date By
06/05/2015
WASTE REV.

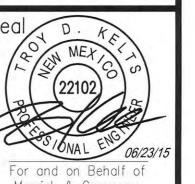

For and on Behalf of Merrick & Company

PACE, CO 80111

PACE, CO 80111

PACE, CO 80111

PACE, CO 80111



STORE
WYOMING BOULEVARD FSU
SO8H-A-WC

2274 WYOMING BLVD. NE ALBUQUERQUE, NM

DRAINAGE MAP

SHEET TITLE


VERSION: H-V2 ISSUE DATE: 11-2014

Job No. : <u>65118374</u> Store : <u>03484</u> Date : <u>03/18/15</u>

Checked By: TDK

eet

DN-1.0

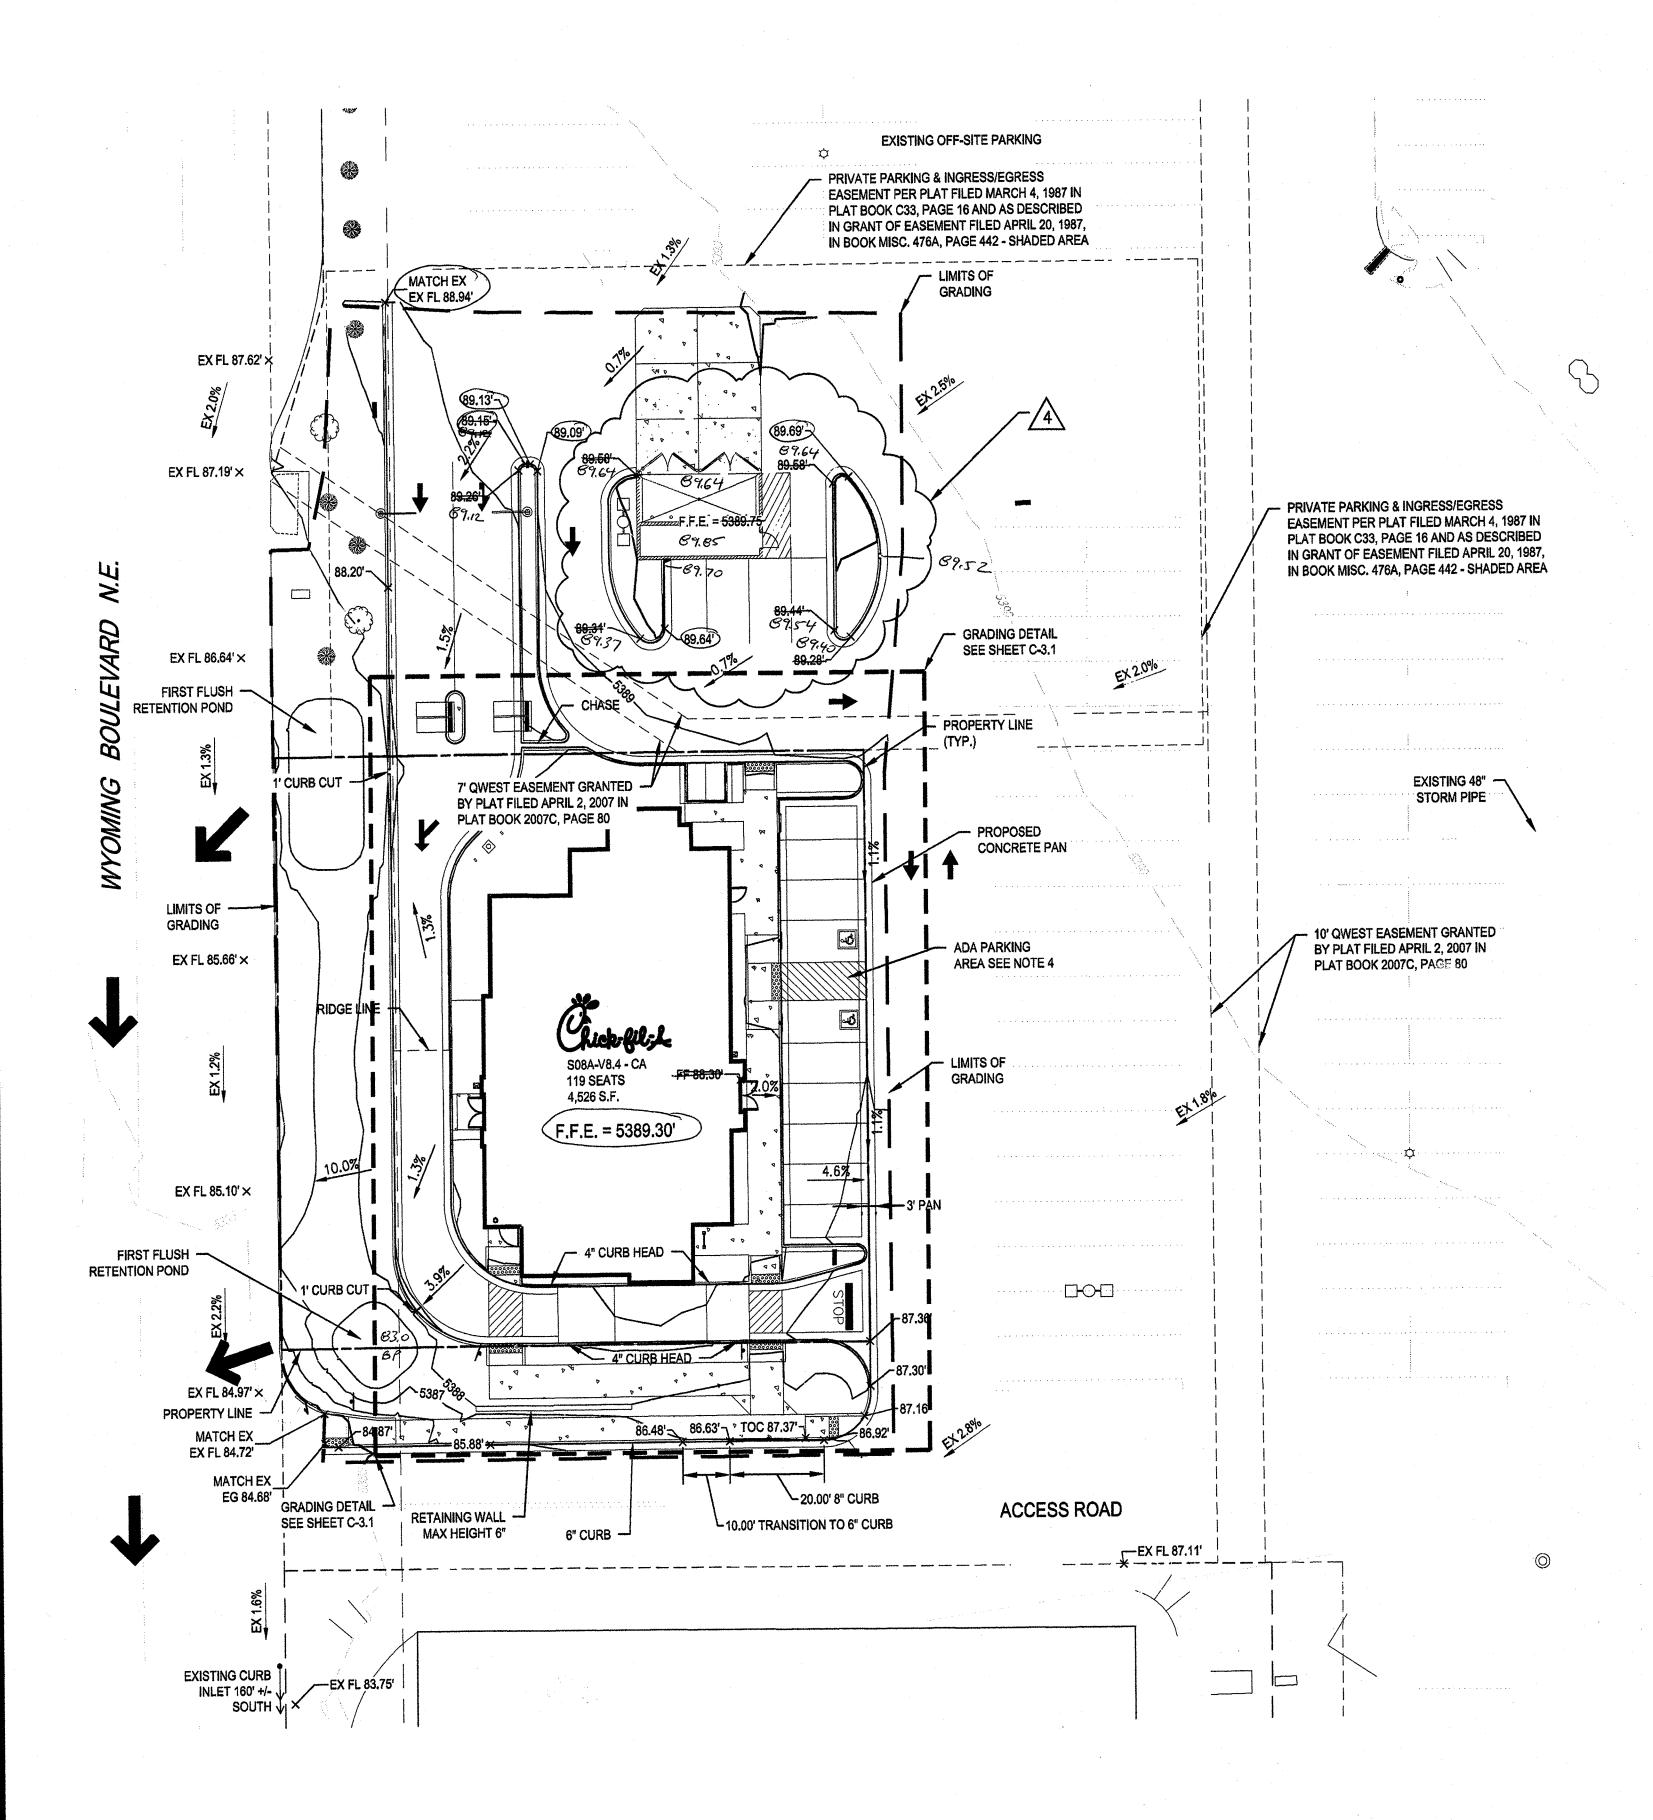

New Mexico One Call, Inc.

CALL NMOC
Two working days
BEFORE YOU DIG
NM811
OR
1-888-NM-GAS-CO
NMONECALL.ORG

LIMITS OF GRADING PROPOSED MAJOR CONTOUR PROPOSED MINOR CONTOUR EXISTING MAJOR CONTOUR EXISTING MINOR CONTOUR FLOWLINE SPOT ELEVATION FL 69.41' × FINISHED FLOOR SPOT ELEVATION FF 70.50' × FINISHED GRADE SPOT ELEVATION FG 70.39' × TOP OF CURB SPOT ELEVATION TC 70.50' × EXISTING GRADE SPOT ELEVATION EG 69.57'× EXISTING FLOWLINE SPOT ELEVATION EX FL 70.18' × 1.1% PROPOSED SLOPE ARROWS EX 0.5% **EXISTING SLOPE ARROWS** EMERGENCY OVERFLOW PATHWAY

**NOTES** 

1. REFER TO SHEET C-1.0 FOR GENERAL NOTES AND LEGEND.

2. ALL ELEVATIONS SHOWN ARE 53XX.XX'

3. ELEVATIONS SHOWN ARE FLOWLINE UNLESS SPECIFIED OTHERWISE

ADA PARKING STALLS SHALL HAVE A MAXIMUM OF 2.0% SLOPE IN ANY DIRECTION.
 REFER TO PS-1.0 - UTILITY PLAN FOR FURTHER INFORMATION ON EXISTING AND

PROPOSED UTILIT

6. CURB CUTS TO ALLOW FOR SURFACE RUNOFF TO FLOW INTO DEPRESSED COLLECTION AREAS IN PLANTER ISLANDS. REFER TO LANDSCAPE PLAN FOR FURTHER INFORMATION ON BIORETENTION / ON-SITE WATER HARVESTING AREAS & PLANTINGS TO BE UTILIZED.

7. ALL CURB TO BE 6" UNLESS SPECIFIED OTHERWISE

8. TRANSITION FROM 4" CURB HEAD TO 6" CURB HEAD IN THIS AREA

9. REFER TO DN-1.0 FOR DEVELOPED DRAINAGE MAP


APPROXIMATELY 225' SOUTH OF THE PROPERTY LINE.

DRAINAGE NARRATIVE DESCRIPTION

THE SITE IS CURRENTLY A BANK WITH LANDSCAPE ISLANDS SEPARATING WYOMING BLVD FROM THE BUILDING. THE SITE GENERALLY SLOPES FROM NORTHEAST TO SOUTHWEST TOWARDS WYOMING BLVD. EXISTING SLOPES WITHIN THE PARKING LOT ARE LESS THAN 3%. EXISTING SIDEWALK SURROUNDS THE SITE TO THE WEST AND SOUTH. THE STORM WATER SHEET FLOWS ACROSS THE SITE AND SPILLS OVER THE SIDEWALK IN THE SOUTHWEST CORNER INTO WYOMING BLVD. THERE IS NO INLET LOCATED WITHIN THE SITE. AN EXISTING INLET IS LOCATED IN WYOMING BLVD

THE PROPOSED GRADING WILL IMPROVE THE EXISTING DRAINAGE CONDITIONS FOR THE PROJECT SITE. THE PROPOSED SITE WILL FLOW FROM THE NORTHEAST TO THE SOUTHWEST. THE SITE AREA LOCATED NORTH OF THE BUILDING WILL SHEET FLOW AND FLOW ALONG CURB AND GUTTER, UNTIL IT ENTERS A CURB CHASE LOCATED WITHIN THE DRIVE-THRU. THE CURB CHASE WILL DIRECT RUNOFF INTO THE NORTHERN RETENTION POND. THE NORTHERN RETENTION POND IS SIZED TO RETAIN THE FIRST FLUSH (INITIAL 0.34" OF RAINFALL) FROM THE IMPERVIOUS AREA ON THE NORTHERN SIDE OF THE PROPERTY. THIS DOES NOT INCLUDE THE OFFSITE AREA THAT WILL DRAIN THROUGH THE PROPOSED SITE. THE POND IS SIZED TO RETAIN 345 CUBIC FEET (THE FIRST 0.34" FROM 0.28 ACRES OF IMPERVIOUS AREA). DEVELOPED RUNOFF IN EXCESS OF THIS AMOUNT WILL FLOW ACROSS THE RETENTION POND INTO WYOMING BOULEVARD. THE SOUTHERN PORTION OF THE SITE WILL SHEET FLOW AND FLOW ALONG CURB AND GUTTER, UNTIL IT ENTERS A CURB CHASE. THE CURB CHASE WILL DIRECT RUNOFF INTO THE SOUTHERN RETENTION POND. THE SOUTHERN RETENTION POND IS SIZED TO RETAIN THE FIRST FLUSH (INITIAL 0.34" OF RAINFALL) FROM THE IMPERVIOUS AREA ON THE SOUTHERN SIDE OF THE PROPERTY. THE POND IS SIZED TO RETAIN 115 CUBIC FEET (THE FIRST 0.34" FROM 0.092 ACRES OF IMPERVIOUS AREA). DEVELOPED RUNOFF IN EXCESS OF THIS AMOUNT WILL FLOW ACROSS THE RETENTION POND INTO WYOMING BOULEVARD. THE EASTERN PORTION OF THE SITE WILL SHEET FLOW TOWARDS A PAN, WHERE IT WILL THEN FLOW INTO THE SHARED ACCESS DRIVE LOCATED SOUTH OF THE BUILDING. ALL DEVELOPED RUNOFF THAT ENTERS WYOMING BOULEVARD WILL FLOW TO AN EXISTING INLET LOCATED APPROXIMATELY 225' SOUTH OF THE PROPERTY LINE.


THE PROPOSED SITE WILL INCREASE THE AMOUNT OF PERVIOUS AREA FROM THE EXISTING CONDITIONS, AND DECREASE THE OVERALL DEVELOPED RUNOFF FROM THE PROPERTY TO THE WYOMING BLVD. RIGHT=OF-WAY.

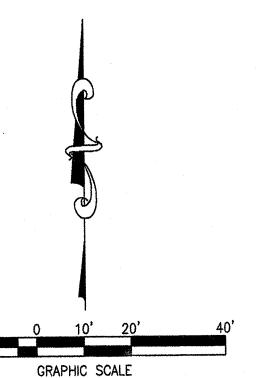


1'' = 20'

SURVEYOR'S CERTIFICATE.

I, Andrew S Medina, a duly qualified Licensed Professional Surveyor under the laws of the State of New Mexico, do hereby certify; that the "as-built" information shown on these drawings was obtained from field construction and "as-built" surveys performed by me or under my supervision that the "as built" information shown on these drawings was added by me of under my supervision; and that this "as-built" information is true and correct to the best of my knowledge and belief. I am not responsible for any of the death S concepts, calculations, engineering, or intent of the record rewings.

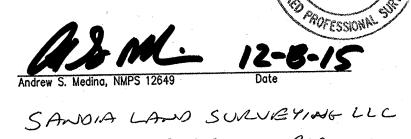

SANDIA LAND SURVEYING LLL 15 CASA TENRENOS PLACITAS NM. 87043 505-259-8130

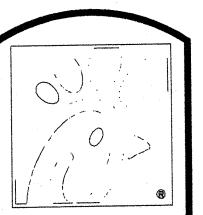

Öhiet-Gil;L

5200 Buffington Rd. Atlanta, Georgia 30349—2998


Revisions:

Mark Date By
04/01/2015

OWNER REV

Mark Date By
05/01/2015
AGENCY REV.

Mark Date By
06/05/2015
WASTE REV.

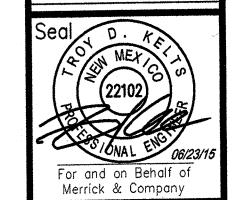

S COMPANY

REENWOOD PLAZA BLVD

REENWOOD VILLAGE, CO 80111



2274 WYOMING BLVD. NE

SHEET TITLE

ALBUQUERQUE, NM

SO8H-A-WC

GRADING PLAN


VERSION: H-V2 ISSUE DATE: 11-2014


Job No. : <u>65118374</u> Store : <u>03484</u> Date : <u>03/18/15</u>

Date : 03/10/1 Drawn By : \_\_JD Checked By:\_\_TDK

Sheet

C - 3.0

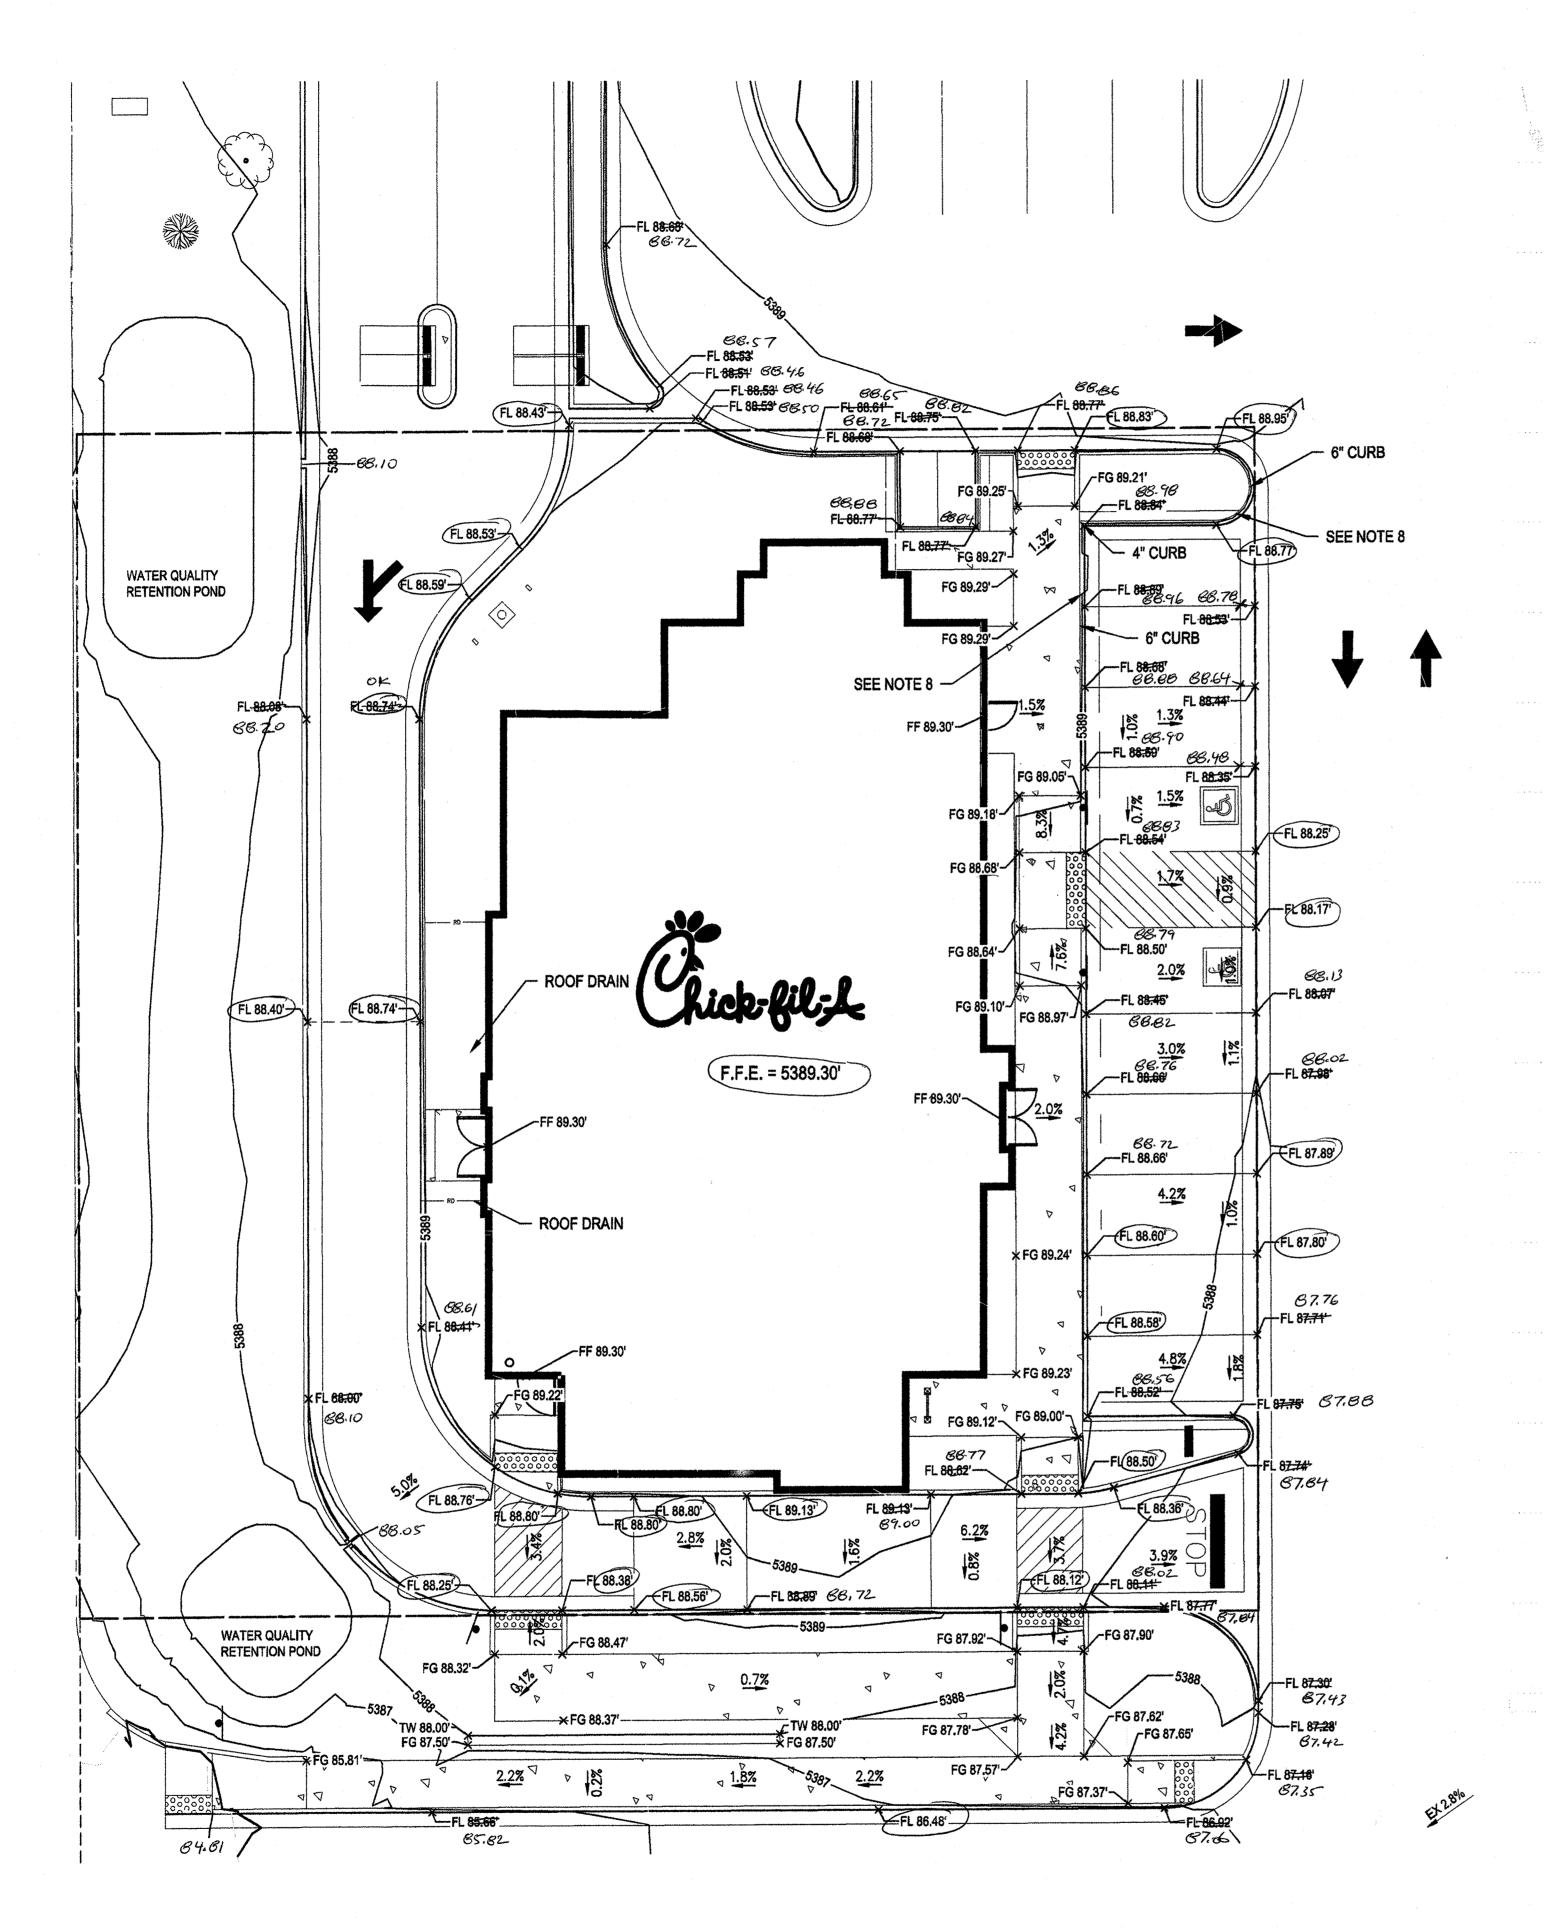

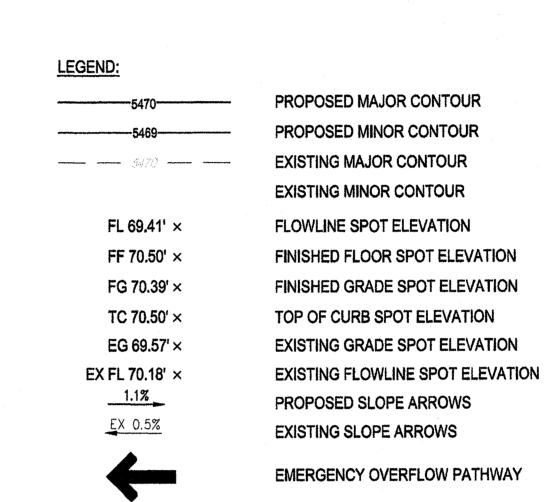

NOTES

1. REFER TO SHEET C-1.0 FOR GENERAL NOTES AND LEGEND.

2. ALL ELEVATIONS SHOWN ARE 53XX.XX'


3. ELEVATIONS SHOWN ARE FLOWLINE UNLESS SPECIFIED OTHERWISE

ADA PARKING STALLS SHALL HAVE A MAXIMUM OF 2.0% SLOPE IN ANY DIRECTION. 5. REFER TO SHEET 4 - UTILITY PLAN FOR FURTHER INFORMATION ON EXISTING AND

PROPOSED UTILITIES.

6. CURB CUTS TO ALLOW FOR SURFACE RUNOFF TO FLOW INTO DEPRESSED COLLECTION AREAS IN PLANTER ISLANDS. REFER TO LANDSCAPE PLAN FOR FURTHER INFORMATION ON BIORETENTION / ON-SITE WATER HARVESTING AREAS & PLANTINGS TO BE UTILIZED.

7. ALL CURB TO BE 6" UNLESS SPECIFIED OTHERWISE 8. TRANSITION FROM 4" CURB HEAD TO 6" CURB HEAD IN THIS AREA

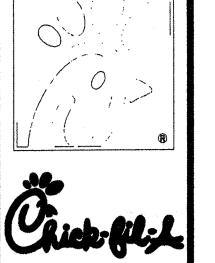

5200 Buffington Rd. Atlanta, Georgia 30349-2998

Revisions:

Mark Date By


04/01/2015

OWNER REV OWNER REV

Mark Date By
05/01/2015
AGENCY REV.

Mark Date By
06/05/2015
WASTE REV.



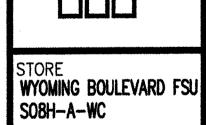

2274 WYOMING BLVD. NE ALBUQUERQUE, NM

SHEET TITLE

GRADING DETAIL

VERSION: H-V2 ISSUE DATE: 11-2014

Job No. : 65118374 : 03484 Store : 03/18/15 Date Drawn By : \_\_JD

Checked By: TDK

Sheet

C - 3.1

