

SEE NOTE 2.

SITE GRADING PLAN

SCALE: 1"=20'

SCHEDULE OF GENERAL NOTES

- THE CONTRACTOR SHALL CALL THE NEW MEXICO ONE CALL SYSTEM AT 1-800-321-2537 TO REQUEST MARKING THE LOCATION OF EXISTING UTILITIES AT LEAST TWO WORKING DAYS PRIOR TO BEGINNING OF EXCAVATION.
- 2. EXISTING UTILITIES ARE SHOWN APPROXIMATELY AND FOR GENERAL INFORMATION PURPOSES ONLY. THE CONTRACTOR SHALL FIELD VERIFY THE LOCATION OF ALL EXISTING UTILITIES PRIOR TO CONSTRUCTION.
- 3. MANHOLE LIDS AND SLEEVES IN PAVED AREAS SHALL BE HS-25 TRAFFIC RATED.
- 4. UNDERGROUND STORM DRAINAGE CONSTRUCTION SHALL BE PERFORMED IN ACCORDANCE WITH CITY OF ALBUQUERQUE STANDARDS.
- 5. PROVIDE PIPE BOLLARDS AT LOCATIONS SHOWN AND AT LOCATIONS SPECIFIED BY THE OWNER, REGULATORY AGENCIES AND UTILITY COMPANIES. COORDINATE BOLLARD INSTALLATION WITH FINISHED PAVING GRADE.
- 6. EQUIPMENT AND MATERIALS SHALL BE INSTALLED IN ACCORDANCE WITH THE MANUFACTURER'S RECOMMENDATIONS AND SPECIFICATIONS.
- UNLESS OTHERWISE SHOWN, NEW PAVING SHALL BE CONSTRUCTED TO ALLOW FOR POSITIVE DRAINAGE TO CATCH BASIN, CURB, GUTTER, AND OTHER RUNOFF COLLECTION DEVICES. NEW PAVEMENT SLOPE SHALL BE MINIMUM 0.50% FOR CONCRETE AND 1.5% FOR ASPHALT UNLESS OTHERWISE INDICATED OR DIRECTED BY THE ARCHITECT/ENGINEER.
- 8. ALL DISTURBED AREAS THAT ARE NOT TO BE PAVED SHALL BE SODDED UNLESS NOTED OTHERWISE.
- 9. CONTRACTOR IS RESPONSIBLE FOR EROSION CONTROL MEASURES AND TO COMPLY WITH NEW MEXICO DEPARTMENT OF NATURAL RESOURCES STANDARDS.
- 10. EXISTING BOUNDARY AND TOPOGRAPHIC SURVEY WAS PREPARED BY SURVEYS SOUTHWEST. LTD., JANUARY 2004. THE CONTRACTOR SHALL NOTIFY THE ENGINEER IF EXISTING GROUND CONDITIONS ARE NOT REPRESENTATIVE IN THE FIELD.
- 11. THE CONTRACTOR SHALL KEEP THE SITE CLEAN AT ALL TIMES AND CONTROL DUST RESULTING FROM THE EARTHWORK OPERATIONS. THE CONTRACTOR SHALL NOT TRACK MUD ONTO THE PUBLIC STREETS.
- 12. NEW CONTOURS DENOTE TOP OF FINISHED PAVING AND GRADED AREA AS INDICATED. ALL SPOT ELEVATIONS ARE TO THE TOP OF CURB UNLESS NOTED OTHERWISE
- 13. STORM DRAIN STRUCTURES SHALL BE CONSTRUCTED IN ACCORDANCE WITH CITY OF ALBUQUERQUE STANDARD DRAWINGS AND SPECIFICATIONS, UNLESS NOTED OTHERWISE.
- 14. ALL ROOF DRAIN PIPES ARE POLYVINYL CHLORIDE (PVC) SCHEDULE 40 OR SDR 30, UNLESS NOTED OTHERWISE ON THE DRAWINGS.
- 15. THE CONTRACTOR SHALL PROTECT EXISTING UTILITIES AND SHALL NOT DAMAGE OR DISTURB ANY SERVICE. THE CONTRACTOR SHALL REPAIR, AT HIS OWN EXPENSE, ANY DAMAGED UTILITIES CAUSED BY HIS CONSTRUCTION OPERATIONS.
- 16. ALL DRAINAGE PIPES, SHALL HAVE A MINIMUM COVER OF (1) FEET TO TOP OF PIPE, UNLESS NOTED OTHERWISE.
- 17. BEDDING MATERIALS SHALL BE OF GRADE AS SPECIFIED IN THE CITY OF ALBUQUERQUE STANDARD SPECIFICATIONS. PIPES SHALL BE PLACED ON AT LEAST 6-INCHES OF BEDDING MATERIALS, AND BACKFILLED WITH SAME MATERIALS.
- 18. ADJUST ALL VALVE BOXES AND MANHOLE COVERS TO FINISHED GRADE WHEN APPLICABLE.
- 19. THE CONTRACTOR SHALL COMPLY WITH THE OCCUPATIONAL SAFETY AND HEALTH ADMINISTRATION (OSHA), TO MAINTAIN A VIABLE TRENCH SAFETY SYSTEM AT ALL TIMES.
- 20. THE CONTRACTOR SHALL FURNISH ALL BONDS AND INSPECTION FEES AS REQUIRED BY THE CITY OF ALBUQUERQUE.
- 21. THE PROPERTY FLOOD ZONE DESIGNATION IS ZONE X, DESIGNATING AREAS DETERMINED TO BE OUTSIDE THE 500-YEAR FLOOD PLAIN ACCORDING TO THE FLOOD INSURANCE RATE MAP, BERNALILLO COUNTY, NEW MEXICO AND INCORPORATED AREAS PER MAP NO. 35001C0365 D, EFFECTIVE DATE SEPTEMBER 20, 1996.
- 22. IF FIELD GRADE ADJUSTMENTS ARE REQUIRED, THE CONTRACTOR SHALL NOTIFY THE
- 23. IF A CONFLICT EXISTS BETWEEN THE PLANS AND SPECIFICATIONS, THE CONTRACTOR SHALL CONTACT THE ARCHITECT/ENGINEER FOR CLARIFICATION PRIOR TO CONSTRUCTION.
- 24. CONTRACTOR SHALL BE RESPONSIBLE FOR OBTAINING REQUIRED PERMITS AND FOR CONTACTING THE CITY TO ARRANGE FOR A PRE CONSTRUCTION CONFERENCE IF SO REQUESTED BY THE CITY, PRIOR TO THE START OF CONSTRUCTION.
- 25. CONTRACTOR SHALL COMPLY WITH LOCAL, STATE AND NATIONAL REQUIREMENTS FOR STORM WATER DISCHARGE ASSOCIATED WITH CONSTRUCTION ACTIVITY.
- 26. FOR PAVEMENT THICKNESSES AND MATERIAL SPECIFICATIONS, REFER TO DETAIL SHEETS.
- 27. UNDERGROUND UTILITIES SHALL BE INSTALLED IN ACCORDANCE WITH LOCAL STANDARDS.


SPECIAL NOTES THIS SHEET

WYOMING BOULEVARD N.E. AND INDIAN SCHOOL ROAD N.E.

SCALE: 1" = 20'

- PAVEMENT GRADES IN MARKED HANDICAPPED AREA SHALL NOT EXCEED 2% IN ALL
- REFER TO PUBLIC IMPROVEMENT PLANS FOR ALL WORK WITHIN THE PUBLIC RIGHT-OF-WAY.

DEERFIELD, IL. 60015 200 WILMOT ROAD 847-940-2500

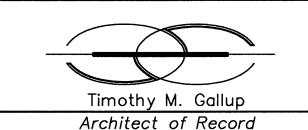

9 East 4th Street • Suite 1000 • Tulsa, Oklahoma 74103 (918) 584-8855 • (918) 584-2880 FAX

cgc@callahangallup.com (e-mail)



Khoury Engineering, Inc. Civil Engineering — Land Development

1435 East 41st Street Tel 918.712.8768 Tulsa, OK 74105 Fax 918.712.1069 CA #375 I, Renewal 06-30-05

PROJECT TYPE

DRAWINGS/SPECIFICATIONS BY: ■ WALGREENS' CONSULTANT
■ LANDLORD'S CONSULTANT

ALL CONSTRUCTION WORK, UNLESS NOTED OTHERWISE, BY

 □ WALGREENS' CONTRACTOR ■ LANDLORD'S CONTRACTOR (TURNKEY CONSTRUCTION)


NEW SHELL ONLY .

STORE		BUILDING		
NEW REMODELING RELOCATION		NEW EXISTING		

/3 4/07/05 MDE AS-BUILT /2\ 9/28/04 MDE ORC #2 1 9/15/04 MDE ADDENDA #2 REBID DATE BY DESCRIPTION CONST. **REVISIONS**

CERTIFICATION AND SEAL

I HEREBY CERTIFY THAT THIS PLAN AND SPECIFI-CATIONS WAS PREPARED BY ME OR UNDER MY DIRECT SUPERVISION AND THAT I AM A DULY REGISTERED ARCHITECT OR ENGINEER UNDER THE LAWS OF THE STATE OF NEW MEXICO AS SIGNIFIED BY MY HAND AND SEAL.

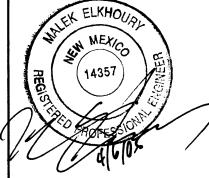

PROJECT NAME

(NEC) WYOMING BLVD & INDIAN SCHOOL RD. ALBUQUERQUE, NM

> DRAWING TITLE SITE GRADING PLAN


DATE 6/24/04 CRITERIA-FISCAL 2004 STORE NO. # 09213 BY: KET

REVIEWED BY: MEE

DRAWING NO. SCALE: AS SHOWN

OF 10 DWGS.

CONTRACTOR SHALL CONTACT NEW MEXICO ONE-CALL SYSTEM **©** (800) 321–2537, AT LEAST 72 HOURS PRIOR TO **BEGINNING CONSTRUCTION**

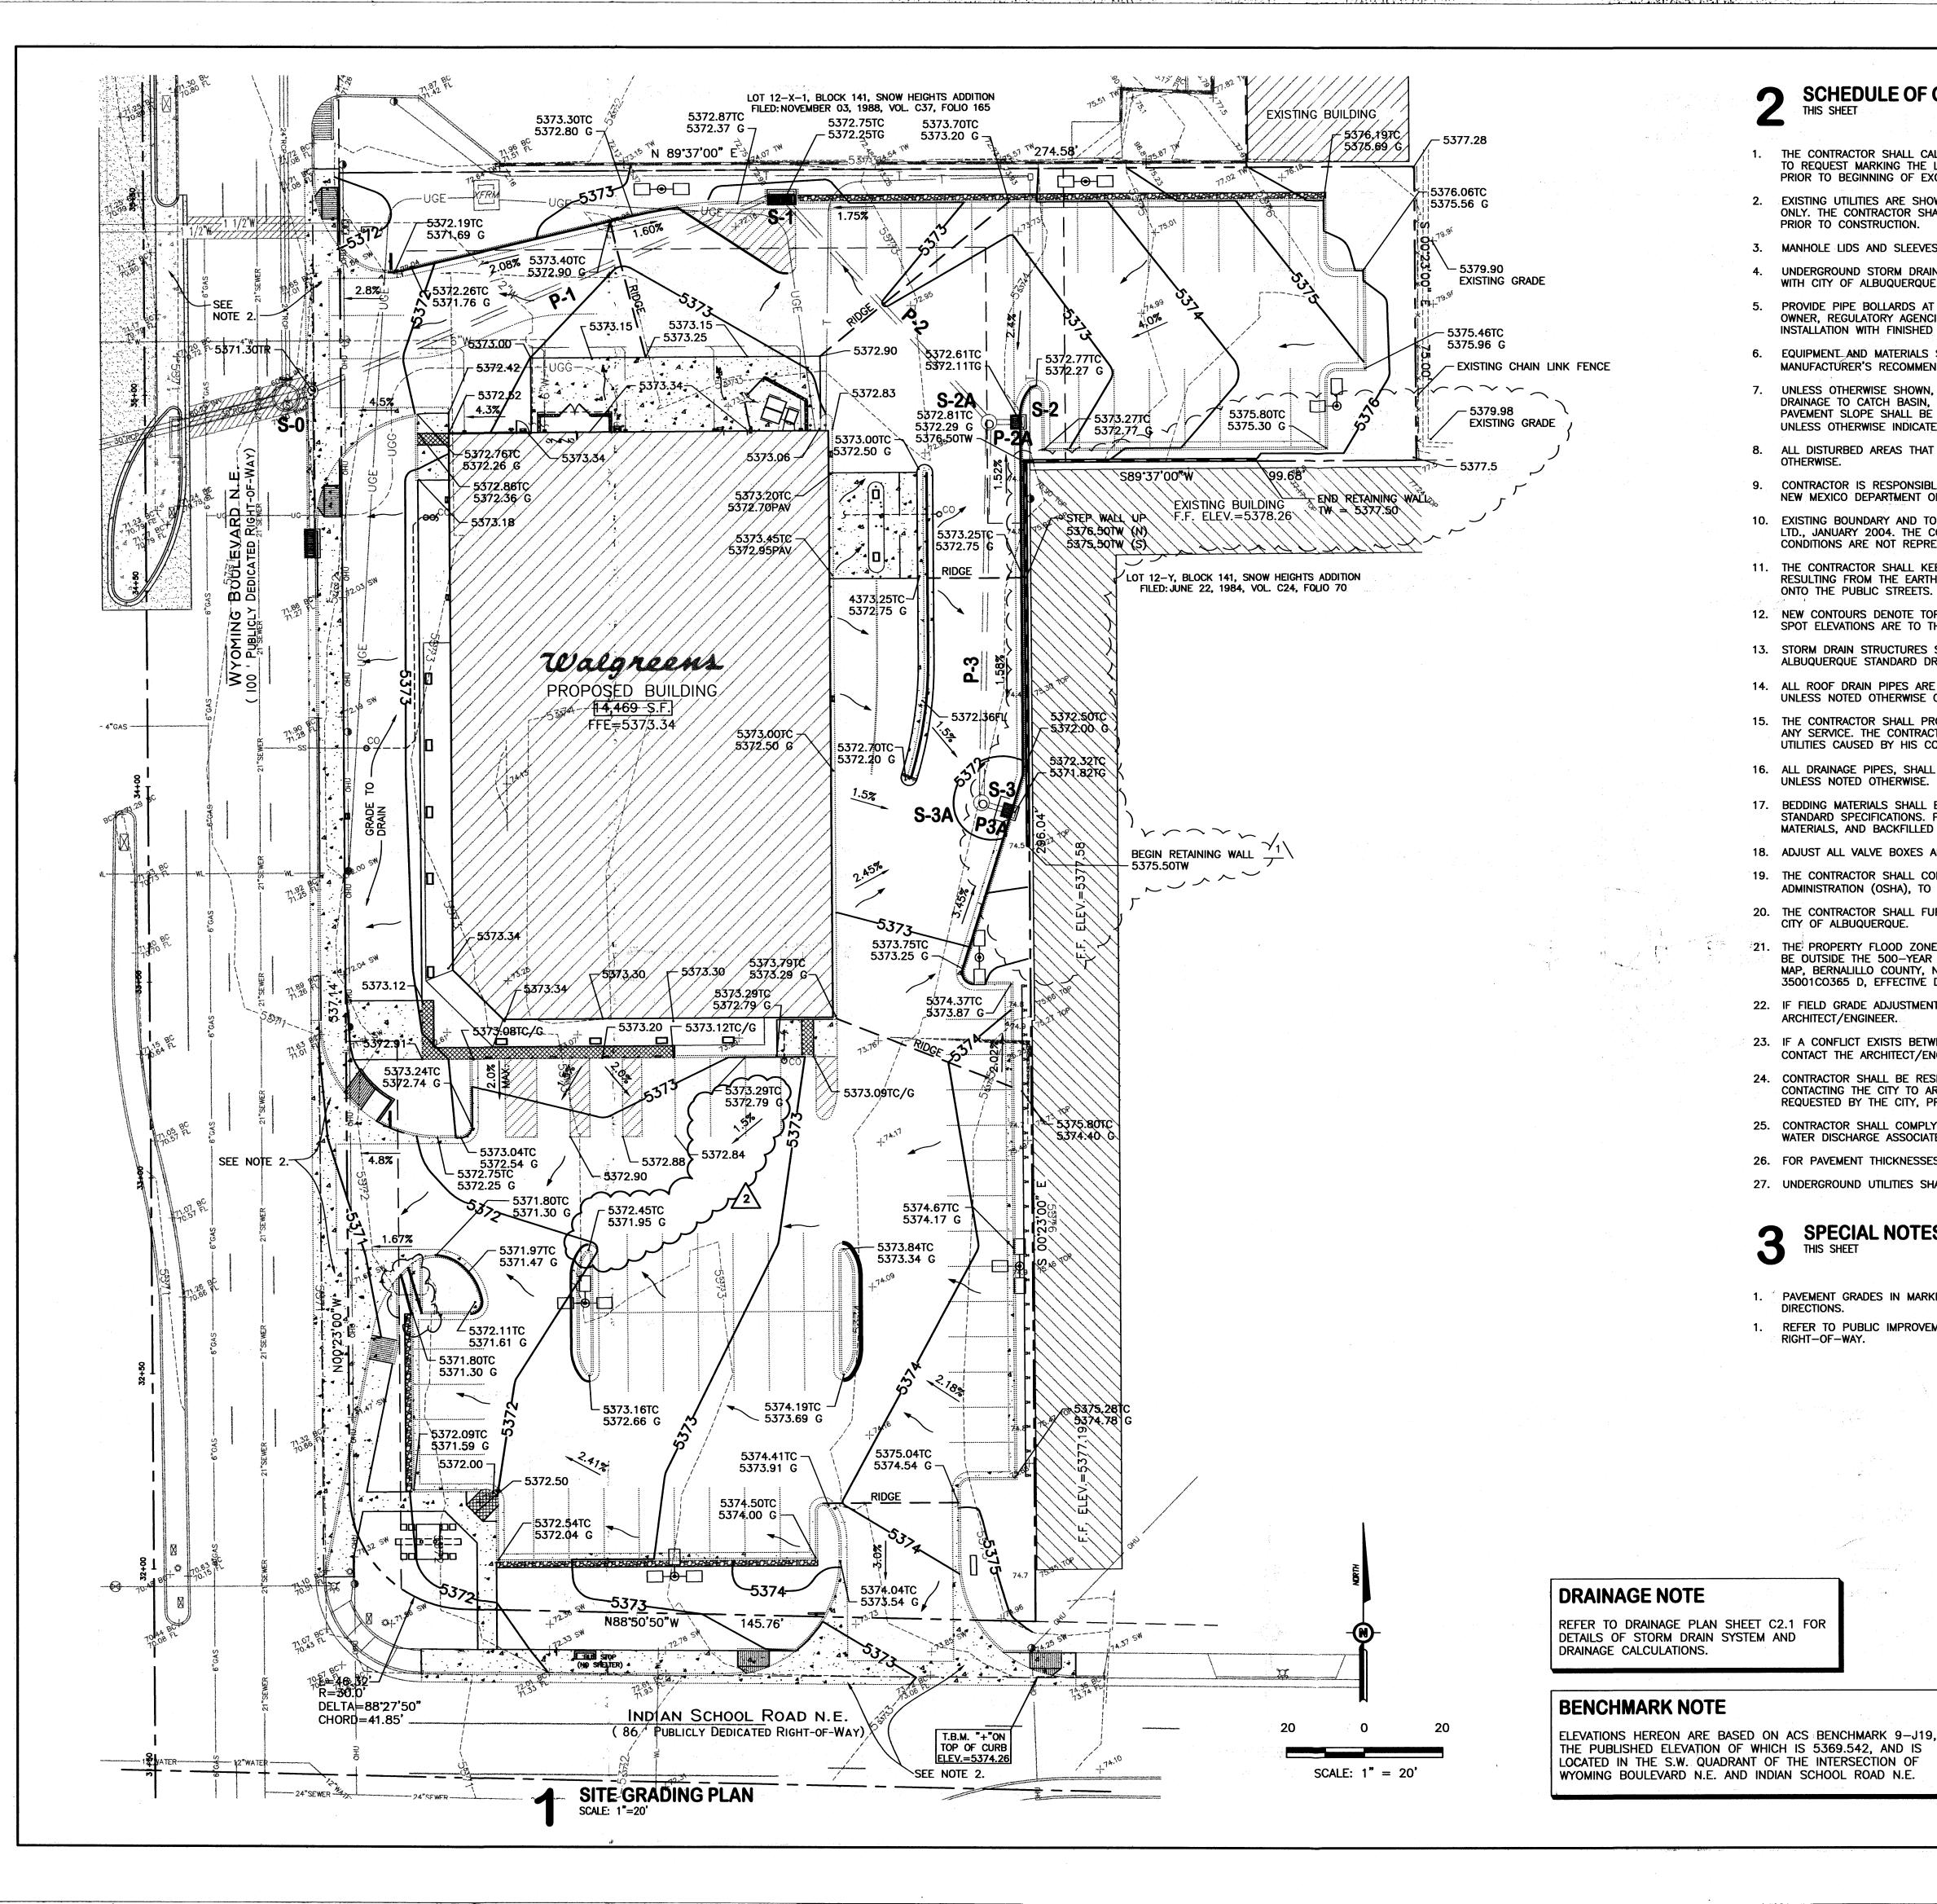

SCHEDULE OF GENERAL NOTES THIS SHEET

- THE CONTRACTOR SHALL CALL THE NEW MEXICO ONE CALL SYSTEM AT 1-800-321-2537 TO REQUEST MARKING THE LOCATION OF EXISTING UTILITIES AT LEAST TWO WORKING DAYS PRIOR TO BEGINNING OF EXCAVATION.
- 2. EXISTING UTILITIES ARE SHOWN APPROXIMATELY AND FOR GENERAL INFORMATION PURPOSES ONLY. THE CONTRACTOR SHALL FIELD VERIFY THE LOCATION OF ALL EXISTING UTILITIES PRIOR TO CONSTRUCTION.
- MANHOLE LIDS AND SLEEVES IN PAVED AREAS SHALL BE HS-25 TRAFFIC RATED.
- UNDERGROUND STORM DRAINAGE CONSTRUCTION SHALL BE PERFORMED IN ACCORDANCE WITH CITY OF ALBUQUERQUE STANDARDS.
- PROVIDE PIPE BOLLARDS AT LOCATIONS SHOWN AND AT LOCATIONS SPECIFIED BY THE OWNER, REGULATORY AGENCIES AND UTILITY COMPANIES. COORDINATE BOLLARD INSTALLATION WITH FINISHED PAVING GRADE.
- EQUIPMENT AND MATERIALS SHALL BE INSTALLED IN ACCORDANCE WITH THE MANUFACTURER'S RECOMMENDATIONS AND SPECIFICATIONS.
- UNLESS OTHERWISE SHOWN, NEW PAVING SHALL BE CONSTRUCTED TO ALLOW FOR POSITIVE DRAINAGE TO CATCH BASIN, CURB, GUTTER, AND OTHER RUNOFF COLLECTION DEVICES. NEW PAVEMENT SLOPE SHALL BE MINIMUM 0.50% FOR CONCRETE AND 1.5% FOR ASPHALT UNLESS OTHERWISE INDICATED OR DIRECTED BY THE ARCHITECT/ENGINEER.
- 8. ALL DISTURBED AREAS THAT ARE NOT TO BE PAVED SHALL BE SODDED UNLESS NOTED OTHERWISE.
- CONTRACTOR IS RESPONSIBLE FOR EROSION CONTROL MEASURES AND TO COMPLY WITH NEW MEXICO DEPARTMENT OF NATURAL RESDURCES STANDARDS.
- 10. EXISTING BOUNDARY AND TOPOGRAPHIC SURVEY WAS PREPARED BY SURVEYS SOUTHWEST, LTD.. JANUARY 2004. THE CONTRACTOR SHALL NOTIFY THE ENGINEER IF EXISTING GROUND CONDITIONS ARE NOT REPRESENTATIVE IN THE FIELD.
- 11. THE CONTRACTOR SHALL KEEP THE SITE CLEAN AT ALL TIMES AND CONTROL DUST RESULTING FROM THE EARTHWORK OPERATIONS. THE CONTRACTOR SHALL NOT TRACK MUD ONTO THE PUBLIC STREETS.
- 12. NEW CONTOURS DENOTE TOP OF FINISHED PAVING AND GRADED AREA AS INDICATED. ALL SPOT ELEVATIONS ARE TO THE TOP OF CURB UNLESS NOTED OTHERWISE.
- 13. STORM DRAIN STRUCTURES SHALL BE CONSTRUCTED IN ACCORDANCE WITH CITY OF ALBUQUERQUE STANDARD DRAWINGS AND SPECIFICATIONS, UNLESS NOTED OTHERWISE.
- 14. ALL ROOF DRAIN PIPES ARE POLYVINYL CHLORIDE (PVC) SCHEDULE 40 OR SDR 30, UNLESS NOTED OTHERWISE ON THE DRAWINGS.
- 15. THE CONTRACTOR SHALL PROTECT EXISTING UTILITIES AND SHALL NOT DAMAGE OR DISTURB ANY SERVICE. THE CONTRACTOR SHALL REPAIR, AT HIS OWN EXPENSE, ANY DAMAGED UTILITIES CAUSED BY HIS CONSTRUCTION OPERATIONS.
- 16. ALL DRAINAGE PIPES, SHALL HAVE A MINIMUM COVER OF (1) FEET TO TOP OF PIPE, UNLESS NOTED OTHERWISE.
- 17. BEDDING MATERIALS SHALL BE OF GRADE AS SPECIFIED IN THE CITY OF ALBUQUERQUE STANDARD SPECIFICATIONS. PIPES SHALL BE PLACED ON AT LEAST 6-INCHES OF BEDDING MATERIALS, AND BACKFILLED WITH SAME MATERIALS.
- 18. ADJUST ALL VALVE BOXES AND MANHOLE COVERS TO FINISHED GRADE WHEN APPLICABLE.
- 19. THE CONTRACTOR SHALL COMPLY WITH THE OCCUPATIONAL SAFETY AND HEALTH ADMINISTRATION (OSHA), TO MAINTAIN A VIABLE TRENCH SAFETY SYSTEM AT ALL TIMES.
- 20. THE CONTRACTOR SHALL FURNISH ALL BONDS AND INSPECTION FEES AS REQUIRED BY THE CITY OF ALBUQUERQUE.
- 21. THE PROPERTY FLOOD ZONE DESIGNATION IS ZONE X, DESIGNATING AREAS DETERMINED TO BE OUTSIDE THE 500-YEAR FLOOD PLAIN ACCORDING TO THE FLOOD INSURANCE RATE MAP, BERNALILLO COUNTY, NEW MEXICO AND INCORPORATED AREAS PER MAP NO. 35001C0365 D, EFFECTIVE DATE SEPTEMBER 20, 1996.
- 22. IF FIELD GRADE ADJUSTMENTS ARE REQUIRED, THE CONTRACTOR SHALL NOTIFY THE ARCHITECT/ENGINEER.
- 23. IF A CONFLICT EXISTS BETWEEN THE PLANS AND SPECIFICATIONS, THE CONTRACTOR SHALL CONTACT THE ARCHITECT/ENGINEER FOR CLARIFICATION PRIOR TO CONSTRUCTION.
- 24. CONTRACTOR SHALL BE RESPONSIBLE FOR OBTAINING REQUIRED PERMITS AND FOR CONTACTING THE CITY TO ARRANGE FOR A PRE CONSTRUCTION CONFERENCE IF SO REQUESTED BY THE CITY, PRIOR TO THE START OF CONSTRUCTION.
- 25. CONTRACTOR SHALL COMPLY WITH LOCAL, STATE AND NATIONAL REQUIREMENTS FOR STORM WATER DISCHARGE ASSOCIATED WITH CONSTRUCTION ACTIVITY.
- 26. FOR PAVEMENT THICKNESSES AND MATERIAL SPECIFICATIONS, REFER TO DETAIL SHEETS.
- 27. UNDERGROUND UTILITIES SHALL BE INSTALLED IN ACCORDANCE WITH LOCAL STANDARDS.

SPECIAL NOTES


- PAVEMENT GRADES IN MARKED HANDICAPPED AREA SHALL NOT EXCEED 2% IN ALL
- REFER TO PUBLIC IMPROVEMENT PLANS FOR ALL WORK WITHIN THE PUBLIC RIGHT-OF-WAY.

HYDROLOGY SECTION

CONTRACTOR SHALL CONTACT NEW MEXICO ONE-CALL SYSTEM **◎** (800) 321–2537, AT LEAST 72 HOURS PRIOR TO BEGINNING CONSTRUCTION



200 WILMOT ROAD 847-940-2500

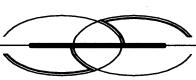

Timothy M. Gallup Architect of Record

9 East 4th Street • Suite 1000 • Tulsa, Oklahoma 74103 (918) 584-8855 • (918) 584-2880 FAX cgc@callahangallup.com (e-mail)



CA #375 I, Renewal 06-30-05

Khoury Engineering, Inc.

Tel 918.712.8768 1435 East 41st Street Fax 918.712.1069 Tulsa, OK 74105

PROJECT TYPE

DRAWINGS/SPECIFICATIONS BY: ■ WALGREENS' CONSULTANT
■ LANDLORD'S CONSULTANT

ALL CONSTRUCTION WORK, UNLESS NOTED OTHERWISE, BY: □ WALGREENS' CONTRACTOR (TURNKEY CONSTRUCTION) LANDLORD'S CONTRACTOR

STORE	BUILDING
NEW	
REMODELING	NEW
RELOCATION	EXISTING
OTHERS	NEW SHELL ONLY .


/2 9/28/04 MDE ORC #2 1 9/15/04 MDE ADDENDA #2 REBID NO. DATE BY CONST. DESCRIPTION **REVISIONS**

CERTIFICATION AND SEAL

I HEREBY CERTIFY THAT THIS PLAN AND SPECIFI-CATIONS WAS PREPARED BY ME OR UNDER MY DIRECT SUPERVISION AND THAT I AM A DULY REGISTERED ARCHITECT OR ENGINEER UNDER THE LAWS OF THE STATE OF NEW MEXICO AS SIGNIFIED BY MY HAND AND SEAL.

KET

REVIEWED BY: MEE

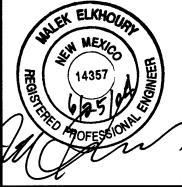

PROJECT NAME


(NEC) WYOMING BLVD & INDIAN SCHOOL RD. ALBUQUERQUE, NM


> DRAWING TITLE SITE GRADING PLAN

DRAWING NO. DATE 6/24/04 CRITERIA-FISCAL 2004 STORE NO. # 09213

SCALE: AS SHOWN

OF 10 DWGS

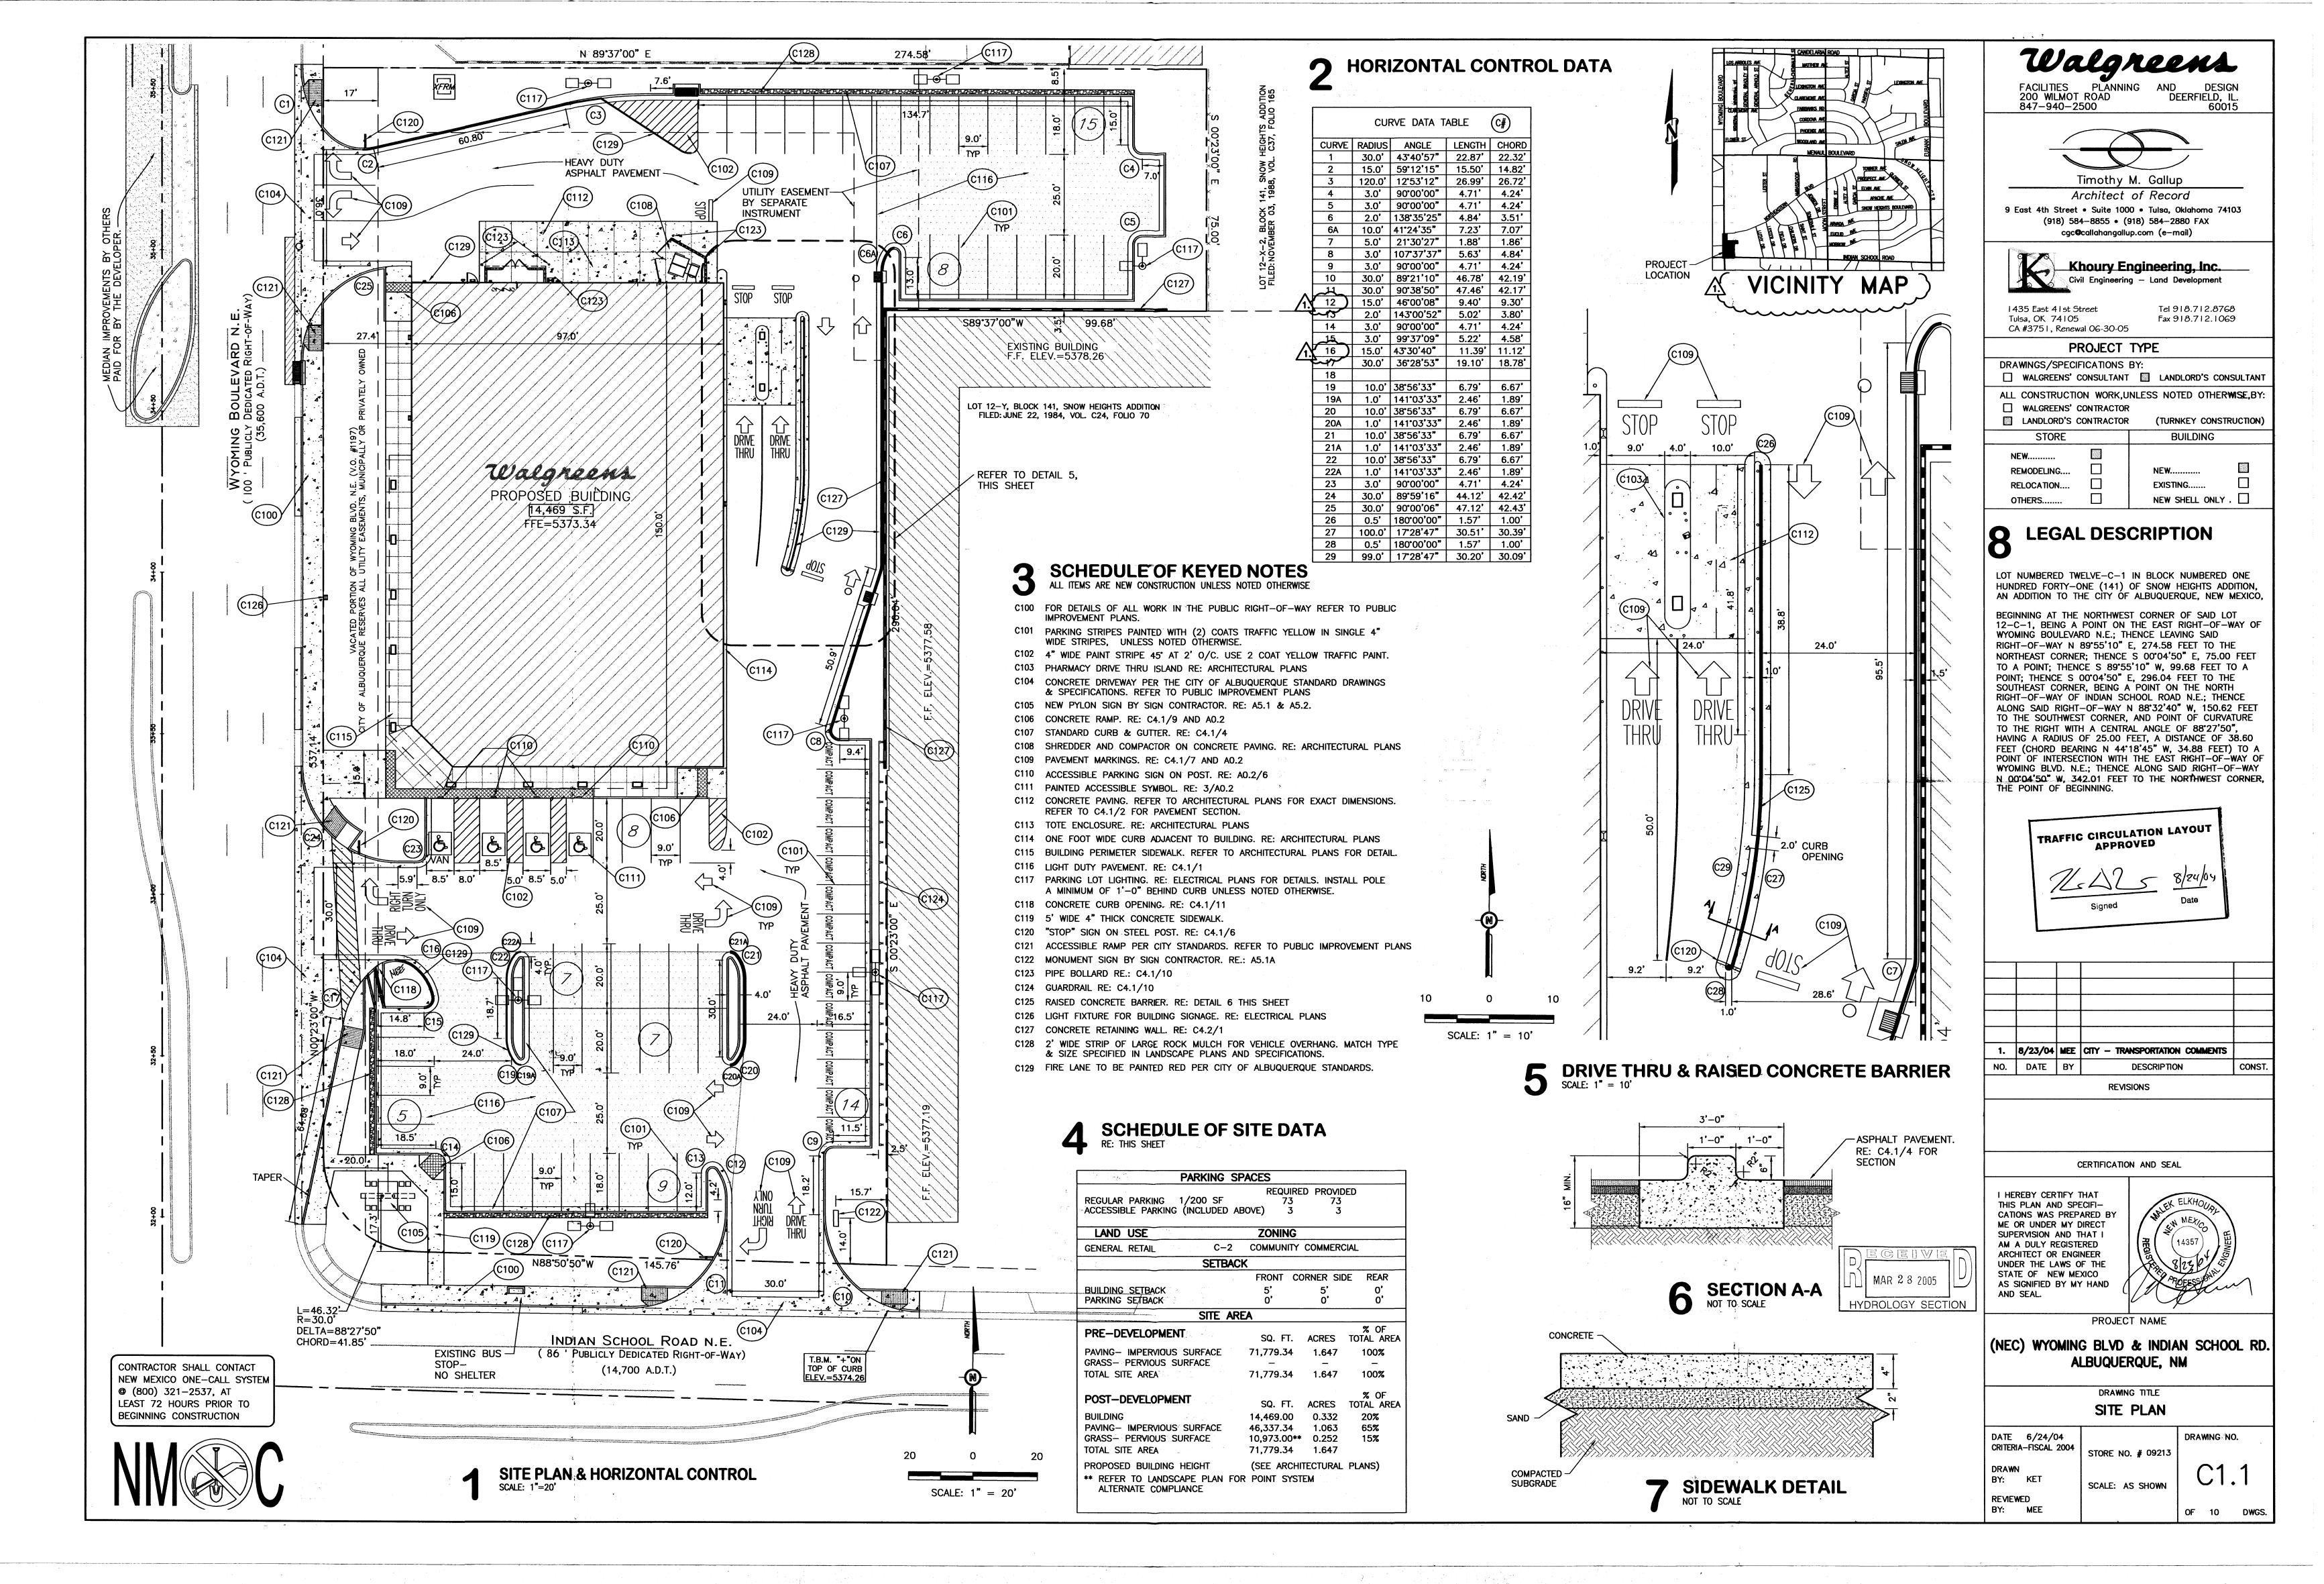

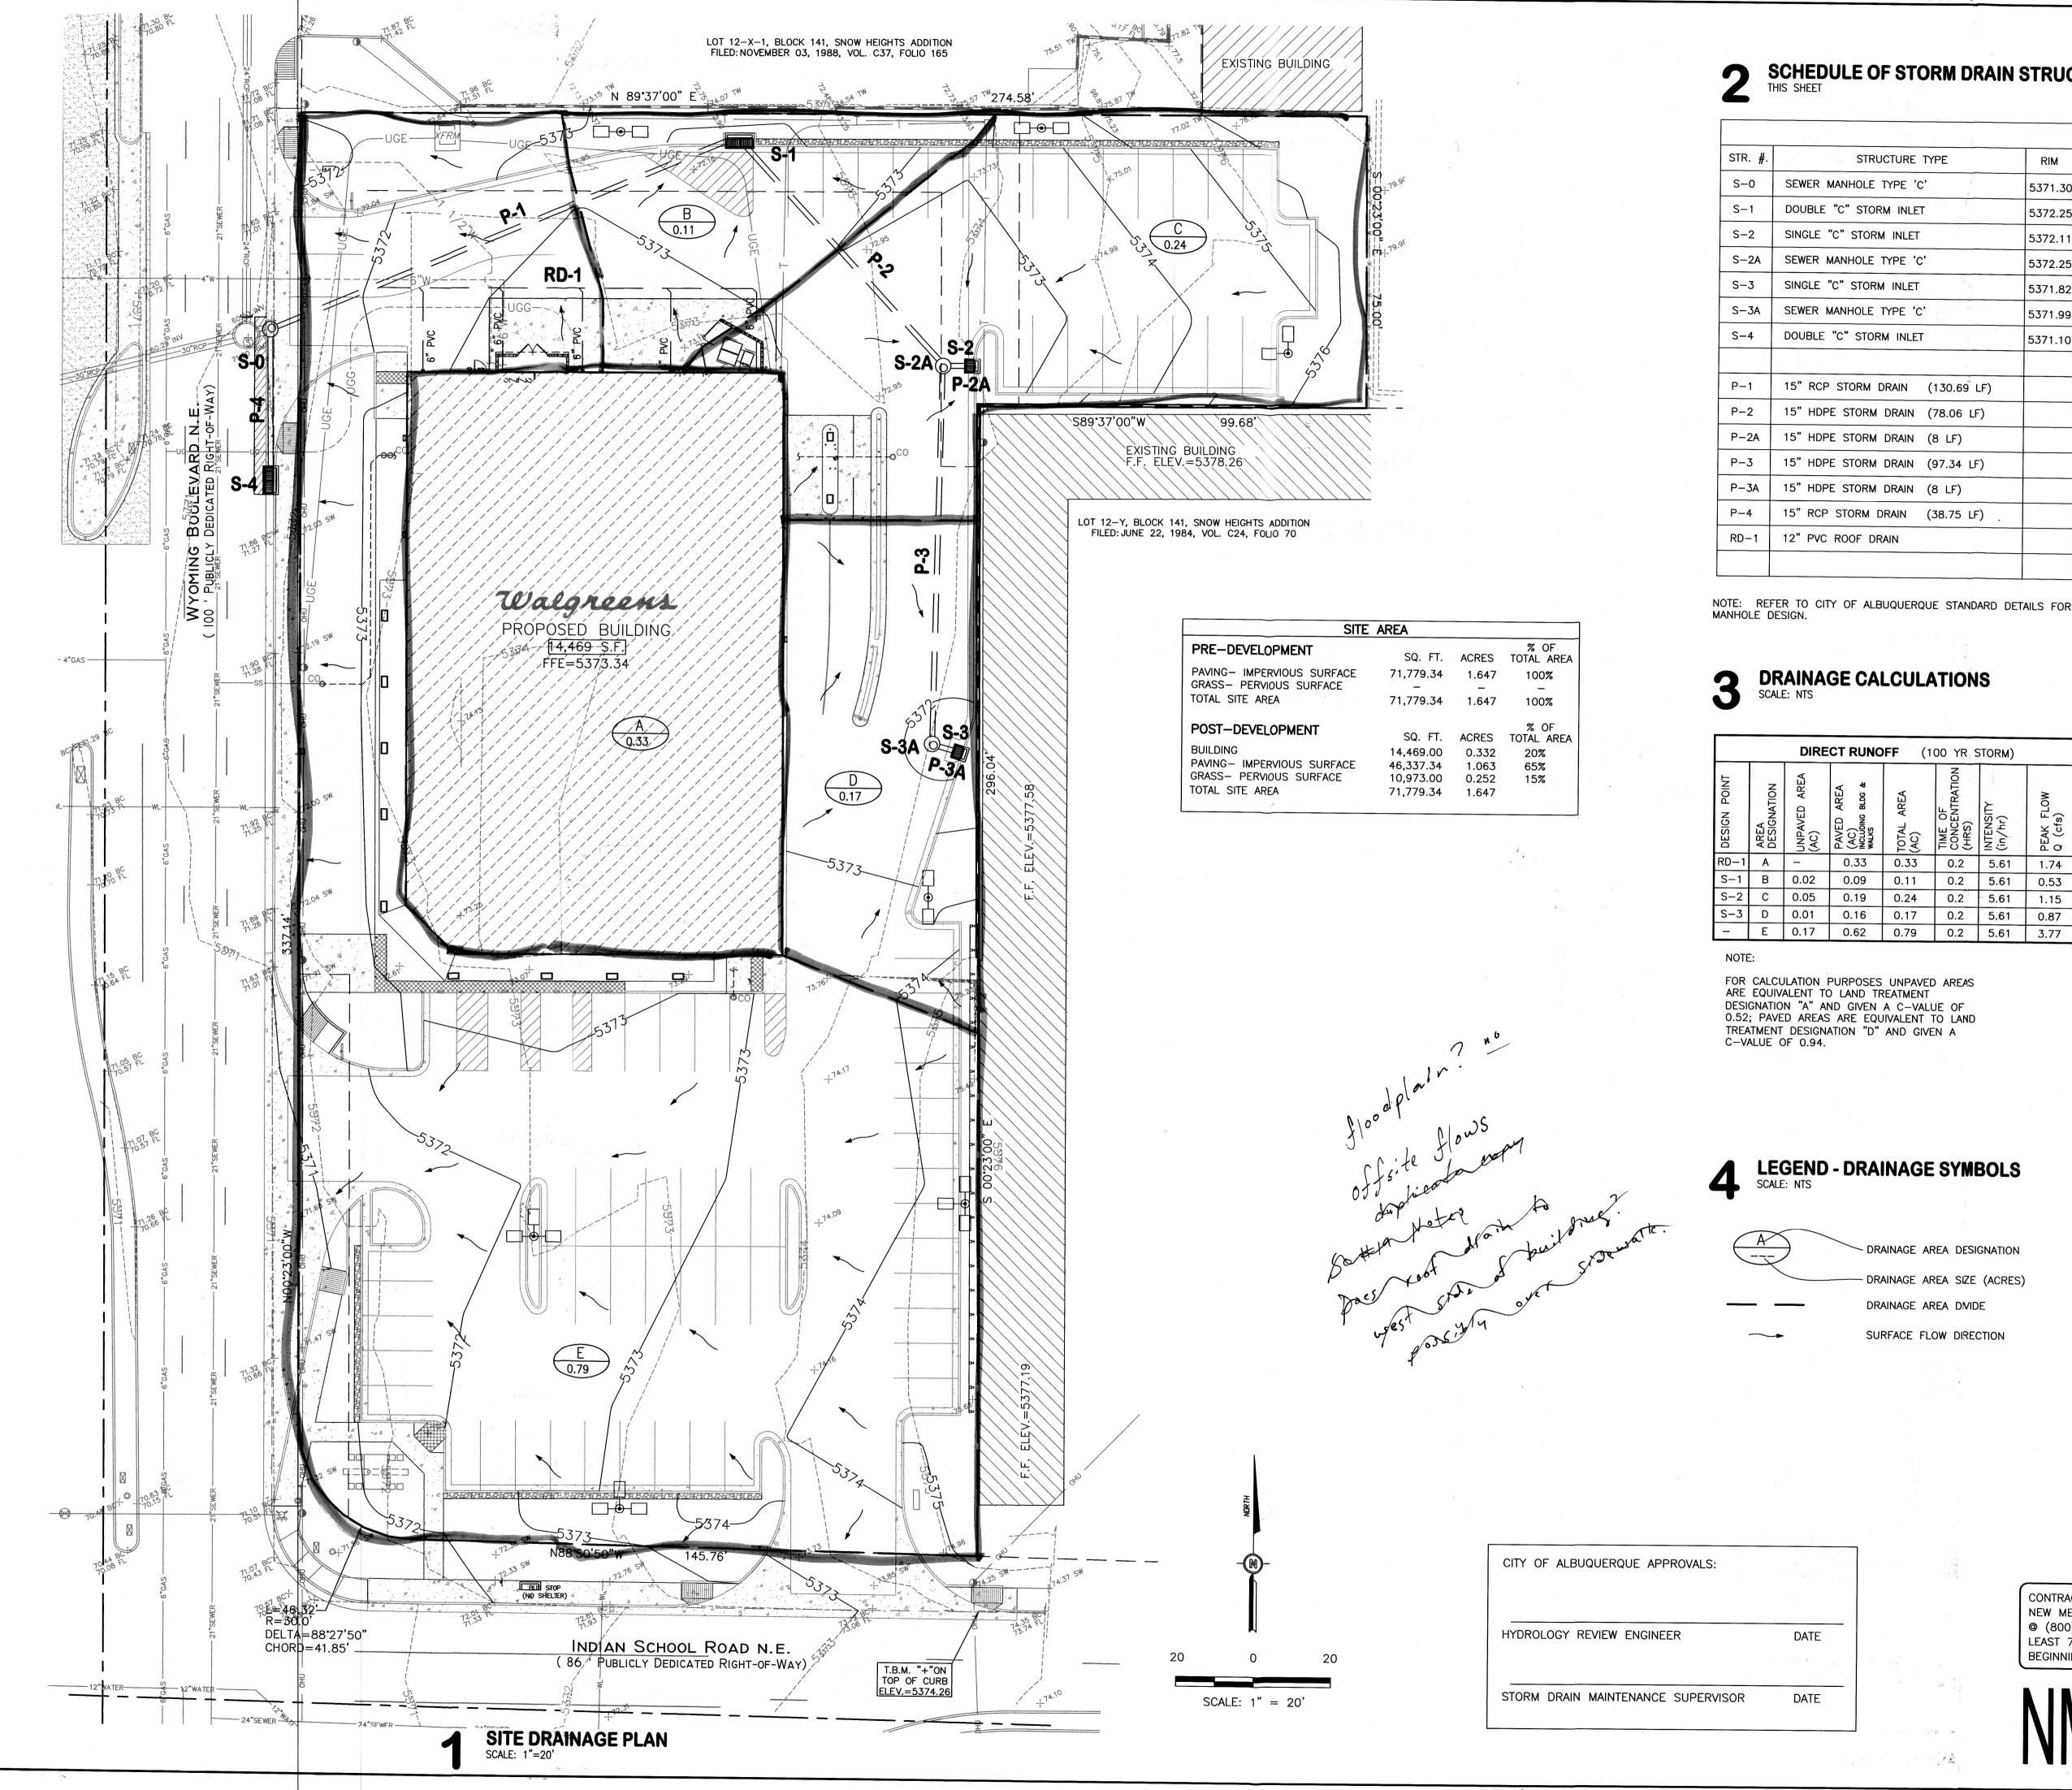

SCHEDULE OF STORM DRAIN STRUCTURES

STRUCTURE TYPE	RIM	INV.
SEWER MANHOLE TYPE 'C'	5371.30	5367.20
DOUBLE "C" STORM INLET	5372.25	5367.86
SINGLE "C" STORM INLET	5372.11	5368.31
SEWER MANHOLE TYPE 'C'	5372.25	5368.25
SINGLE "C" STORM INLET	5371.82	5368.81
SEWER MANHOLE TYPE 'C'	5371.99	5368.75
DOUBLE "C" STORM INLET	5371.10	5367.86
15" RCP STORM DRAIN (130.69 LF)		
15" HDPE STORM DRAIN (78.06 LF)		
15" HDPE STORM DRAIN (8 LF)		
15" HDPE STORM DRAIN (97.34 LF)		
15" HDPE STORM DRAIN (8 LF)		
15" RCP STORM DRAIN (38.75 LF) .		
12" PVC ROOF DRAIN		
	SEWER MANHOLE TYPE 'C' DOUBLE "C" STORM INLET SINGLE "C" STORM INLET SEWER MANHOLE TYPE 'C' SINGLE "C" STORM INLET SEWER MANHOLE TYPE 'C' DOUBLE "C" STORM INLET 15" RCP STORM DRAIN (130.69 LF) 15" HDPE STORM DRAIN (78.06 LF) 15" HDPE STORM DRAIN (8 LF) 15" HDPE STORM DRAIN (97.34 LF) 15" HDPE STORM DRAIN (8 LF) 15" HDPE STORM DRAIN (8 LF)	SEWER MANHOLE TYPE 'C' 5371.30 DOUBLE "C" STORM INLET 5372.25 SINGLE "C" STORM INLET 5372.11 SEWER MANHOLE TYPE 'C' 5372.25 SINGLE "C" STORM INLET 5371.82 SEWER MANHOLE TYPE 'C' 5371.99 DOUBLE "C" STORM INLET 5371.10 15" RCP STORM DRAIN (130.69 LF) 15" HDPE STORM DRAIN (78.06 LF) 15" HDPE STORM DRAIN (8 LF) 15" HDPE STORM DRAIN (97.34 LF) 15" HDPE STORM DRAIN (8 LF) 15" HDPE STORM DRAIN (8 LF) 15" RCP STORM DRAIN (8 LF)


NOTE: REFER TO CITY OF ALBUQUERQUE STANDARD DETAILS FOR INLET AND

DIRECT RUNOFF (100 YR STORM)								
DESIGN POINT	AREA DESIGNATION	UNPAVED AREA (AC)	PAVED AREA (AC) INCLUDING BLDG & WALKS	TOTAL AREA (AC)	TIME OF CONCENTRATION (HRS)	INTENSITY (in/hr)	PEAK FLOW Q (cfs)	
RD-1	Α	_	0.33	0.33	0.2	5.61	1.74	
S-1	В	0.02	0.09	0.11	0.2	5.61	0.53	
S-2	С	0.05	0.19	0.24	0.2	5.61	1.15	
S-3	D	0.01	0.16	0.17	0.2	5.61	0.87	
_	Ε	0.17	0.62	0.79	0.2	5.61	3.77	

CONTRACTOR SHALL CONTACT NEW MEXICO ONE-CALL SYSTEM @ (800) 321-2537, AT LEAST 72 HOURS PRIOR TO BEGINNING CONSTRUCTION





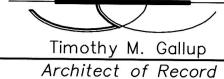

9 East 4th Street • Suite 1000 • Tulsa, Oklahoma 74103 (918) 584-8855 • (918) 584-2880 FAX cgc@callahangallup.com (e-mail)



Tel 918.712.8768 Tulsa, OK 74105 Fax 918.712.1069 CA #375 I, Renewal 06-30-05

PROJECT TYPE


DRAWINGS/SPECIFICATIONS BY:

OTHERS.....

☐ WALGREENS' CONSULTANT ☐ LANDLORD'S CONSULTANT ALL CONSTRUCTION WORK, UNLESS NOTED OTHERWISE, BY: ☐ WALGREENS' CONTRACTOR

LANDLORD'S CONTRACTOR (TURNKEY CONSTRUCTION) STORE BUILDING NEW..... REMODELING.... NEW..... RELOCATION.... EXISTING.....

NEW SHELL ONLY .

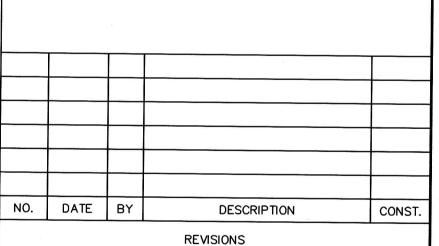

CERTIFICATION AND SEAL

I HEREBY CERTIFY THAT THIS PLAN AND SPECIFI-CATIONS WAS PREPARED BY ME OR UNDER MY DIRECT SUPERVISION AND THAT I AM A DULY REGISTERED ARCHITECT OR ENGINEER UNDER THE LAWS OF THE STATE OF NEW MEXICO AS SIGNIFIED BY MY HAND AND SEAL.

PROJECT NAME

(NEC) WYOMING BLVD & INDIAN SCHOOL RD. ALBUQUERQUE, NM

DRAWING TITLE


SITE DRAINAGE PLAN DATE 6/24/04

CRITERIA-FISCAL 2004 STORE NO. # 09213 DRAWN BY: KET SCALE: AS SHOWN REVIEWED

BY: MEE

DRAWING NO.

OF 10 DWGS.

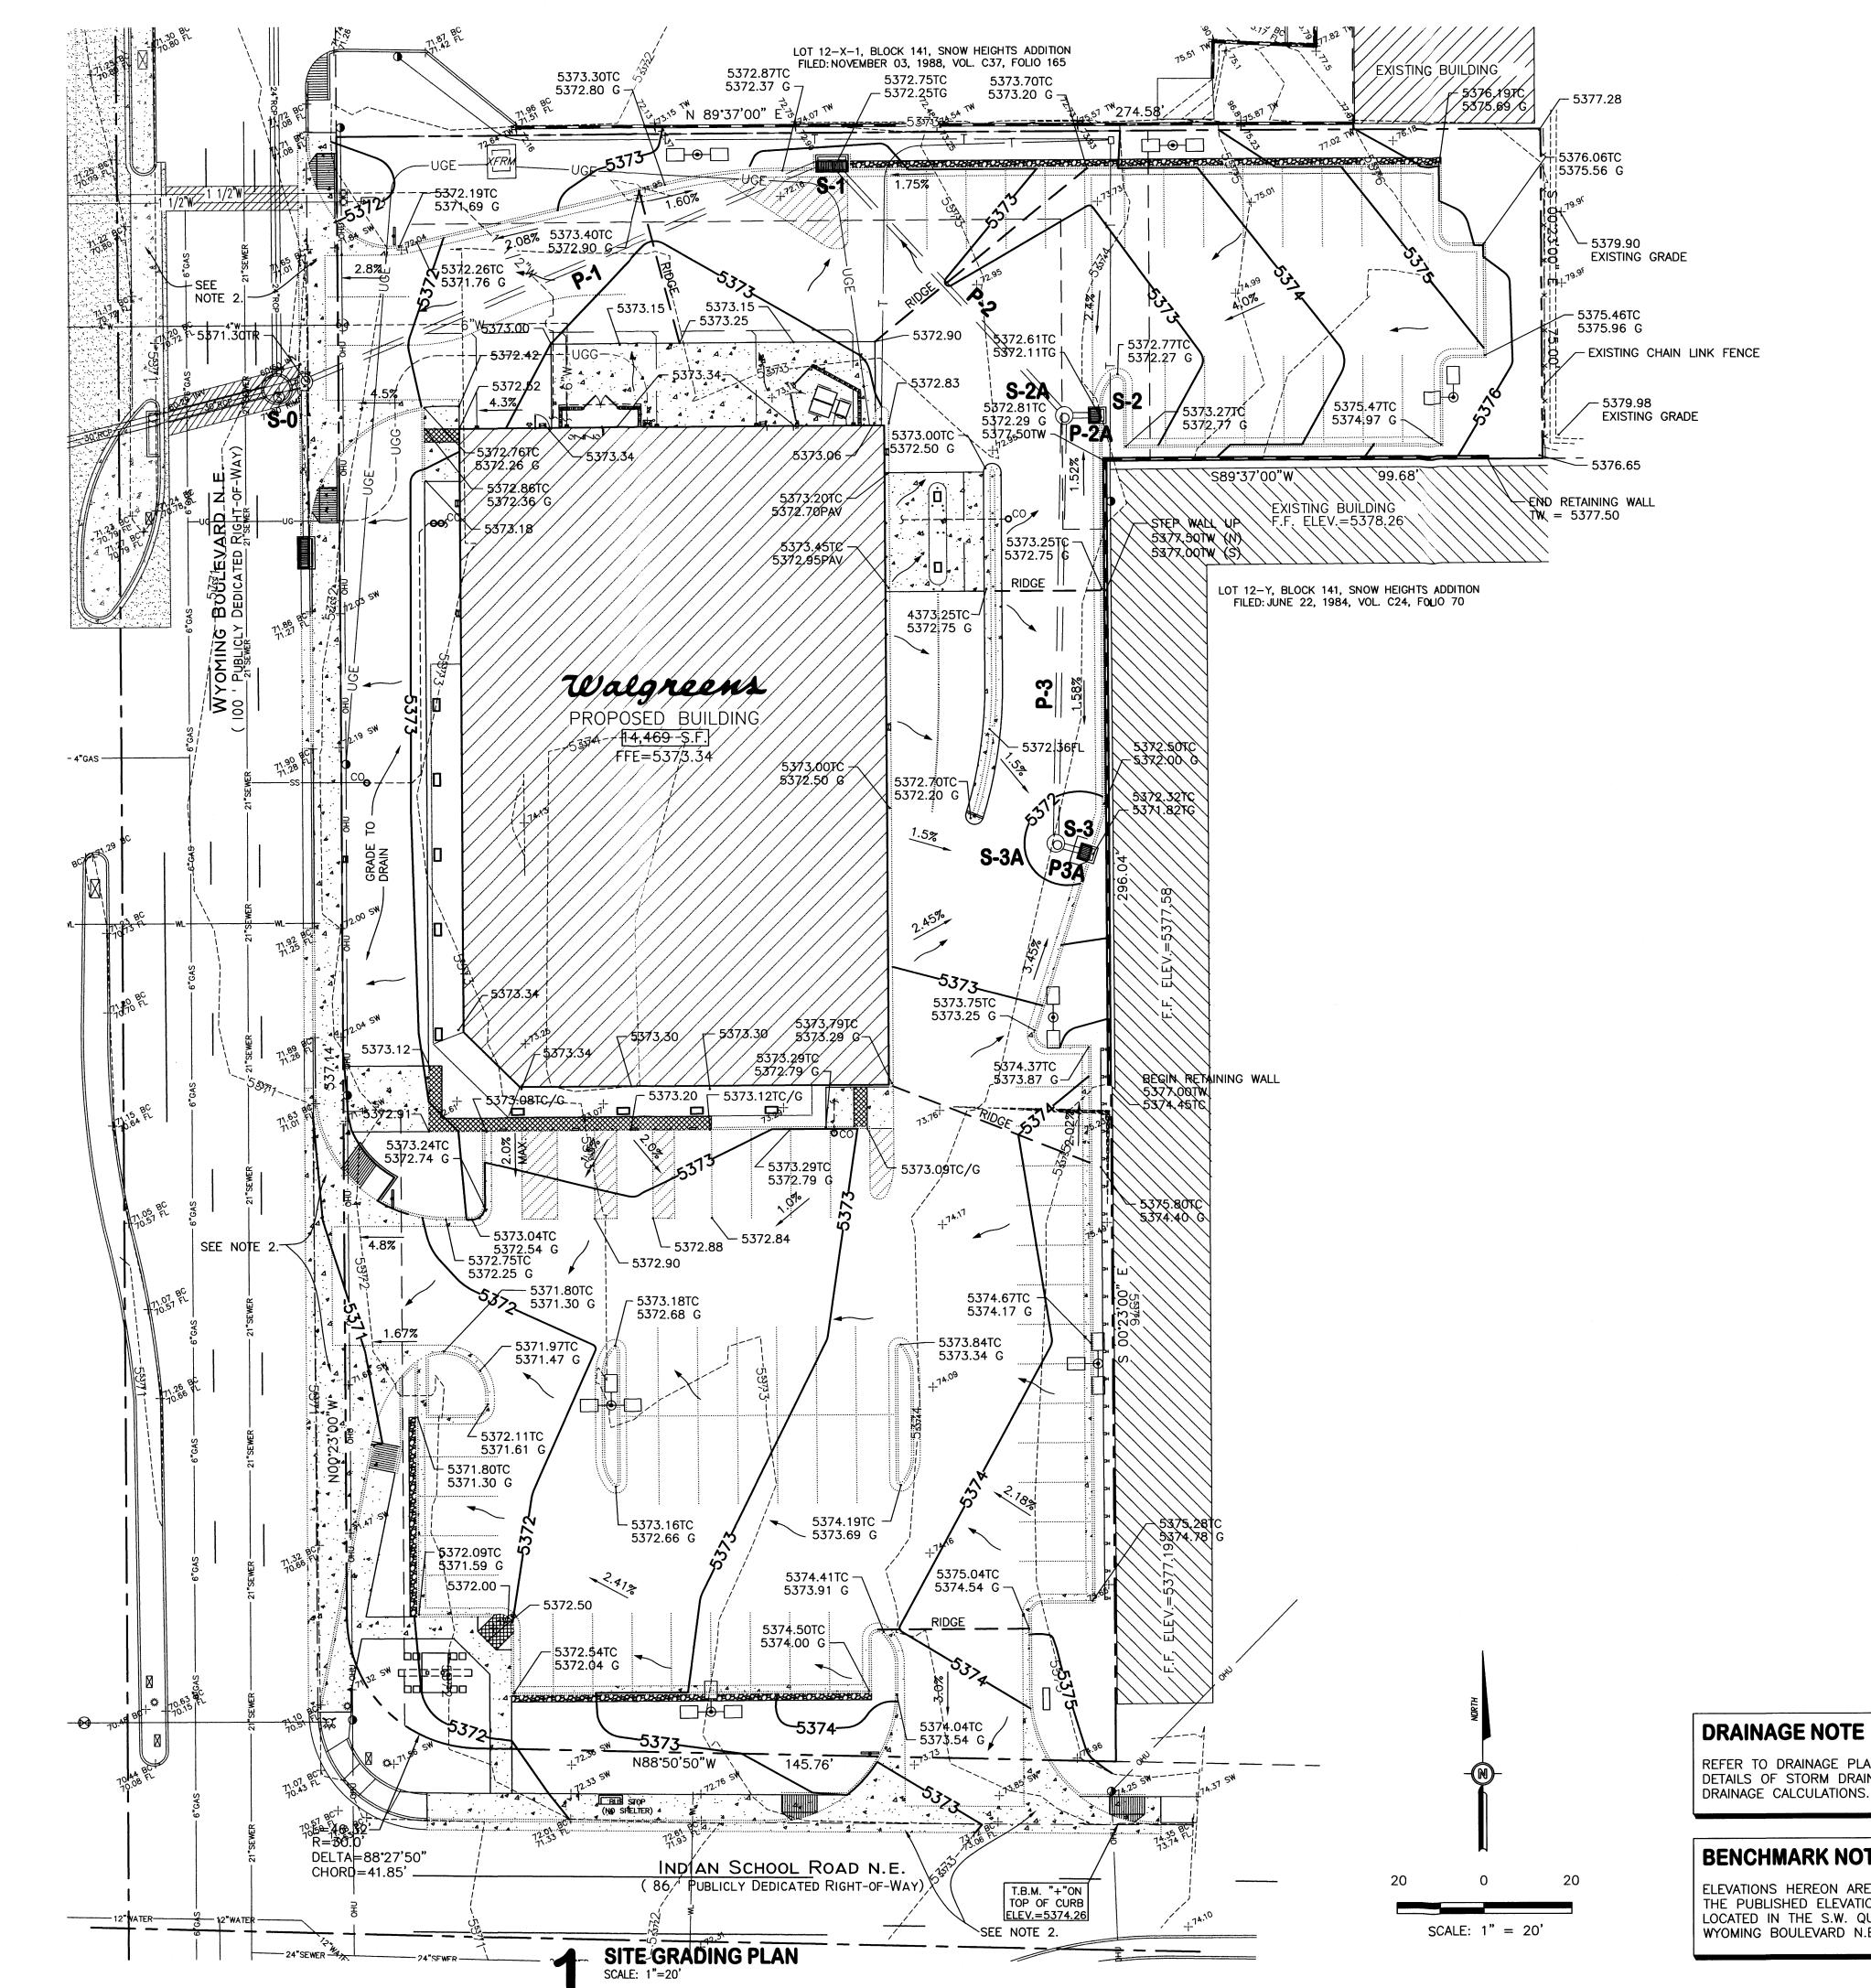

SCHEDULE OF GENERAL NOTES

- THE CONTRACTOR SHALL CALL THE NEW MEXICO ONE CALL SYSTEM AT 1-800-321-2537 TO REQUEST MARKING THE LOCATION OF EXISTING UTILITIES AT LEAST TWO WORKING DAYS PRIOR TO BEGINNING OF EXCAVATION.
- EXISTING UTILITIES ARE SHOWN APPROXIMATELY AND FOR GENERAL INFORMATION PURPOSES ONLY. THE CONTRACTOR SHALL FIELD VERIFY THE LOCATION OF ALL EXISTING UTILITIES
- 3. MANHOLE LIDS AND SLEEVES IN PAVED AREAS SHALL BE HS-25 TRAFFIC RATED.
- UNDERGROUND STORM DRAINAGE CONSTRUCTION SHALL BE PERFORMED IN ACCORDANCE WITH CITY OF ALBUQUERQUE STANDARDS.
- PROVIDE PIPE BOLLARDS AT LOCATIONS SHOWN AND AT LOCATIONS SPECIFIED BY THE OWNER, REGULATORY AGENCIES AND UTILITY COMPANIES. COORDINATE BOLLARD INSTALLATION WITH FINISHED PAVING GRADE.
- EQUIPMENT AND MATERIALS SHALL BE INSTALLED IN ACCORDANCE WITH THE MANUFACTURER'S RECOMMENDATIONS AND SPECIFICATIONS.
- UNLESS OTHERWISE SHOWN, NEW PAVING SHALL BE CONSTRUCTED TO ALLOW FOR POSITIVE DRAINAGE TO CATCH BASIN, CURB, GUTTER, AND OTHER RUNOFF COLLECTION DEVICES. NEW PAVEMENT SLOPE SHALL BE MINIMUM 0.50% FOR CONCRETE AND 1.5% FOR ASPHALT UNLESS OTHERWISE INDICATED OR DIRECTED BY THE ARCHITECT/ENGINEER.
- ALL DISTURBED AREAS THAT ARE NOT TO BE PAVED SHALL BE SODDED UNLESS NOTED
- CONTRACTOR IS RESPONSIBLE FOR EROSION CONTROL MEASURES AND TO COMPLY WITH NEW MEXICO DEPARTMENT OF NATURAL RESOURCES STANDARDS.
- 10. EXISTING BOUNDARY AND TOPOGRAPHIC SURVEY WAS PREPARED BY SURVEYS SOUTHWEST. LTD., JANUARY 2004. THE CONTRACTOR SHALL NOTIFY THE ENGINEER IF EXISTING GROUND CONDITIONS ARE NOT REPRESENTATIVE IN THE FIELD.
- 11. THE CONTRACTOR SHALL KEEP THE SITE CLEAN AT ALL TIMES AND CONTROL DUST RESULTING FROM THE EARTHWORK OPERATIONS. THE CONTRACTOR SHALL NOT TRACK MUD ONTO THE PUBLIC STREETS.
- 12. NEW CONTOURS DENOTE TOP OF FINISHED PAVING AND GRADED AREA AS INDICATED. ALL SPOT ELEVATIONS ARE TO THE TOP OF CURB UNLESS NOTED OTHERWISE.
- 13. STORM DRAIN STRUCTURES SHALL BE CONSTRUCTED IN ACCORDANCE WITH CITY OF ALBUQUERQUE STANDARD DRAWINGS AND SPECIFICATIONS, UNLESS NOTED OTHERWISE.
- 14. ALL ROOF DRAIN PIPES ARE POLYVINYL CHLORIDE (PVC) SCHEDULE 40 OR SDR 30, UNLESS NOTED OTHERWISE ON THE DRAWINGS.
- 15. THE CONTRACTOR SHALL PROTECT EXISTING UTILITIES AND SHALL NOT DAMAGE OR DISTURB ANY SERVICE. THE CONTRACTOR SHALL REPAIR, AT HIS OWN EXPENSE, ANY DAMAGED UTILITIES CAUSED BY HIS CONSTRUCTION OPERATIONS.
- 16. ALL DRAINAGE PIPES, SHALL HAVE A MINIMUM COVER OF (1) FEET TO TOP OF PIPE, UNLESS NOTED OTHERWISE.
- 17. BEDDING MATERIALS SHALL BE OF GRADE AS SPECIFIED IN THE CITY OF ALBUQUERQUE STANDARD SPECIFICATIONS. PIPES SHALL BE PLACED ON AT LEAST 6-INCHES OF BEDDING MATERIALS, AND BACKFILLED WITH SAME MATERIALS.
- 18. ADJUST ALL VALVE BOXES AND MANHOLE COVERS TO FINISHED GRADE WHEN APPLICABLE.
- 19. THE CONTRACTOR SHALL COMPLY WITH THE OCCUPATIONAL SAFETY AND HEALTH ADMINISTRATION (OSHA), TO MAINTAIN A VIABLE TRENCH SAFETY SYSTEM AT ALL TIMES.
- 20. THE CONTRACTOR SHALL FURNISH ALL BONDS AND INSPECTION FEES AS REQUIRED BY THE CITY OF ALBUQUERQUE.
- 21. THE PROPERTY FLOOD ZONE DESIGNATION IS ZONE X, DESIGNATING AREAS DETERMINED TO BE OUTSIDE THE 500-YEAR FLOOD PLAIN ACCORDING TO THE FLOOD INSURANCE RATE MAP, BERNALILLO COUNTY, NEW MEXICO AND INCORPORATED AREAS PER MAP NO. 35001C0365 D, EFFECTIVE DATE SEPTEMBER 20, 1996.
- 22. IF FIELD GRADE ADJUSTMENTS ARE REQUIRED, THE CONTRACTOR SHALL NOTIFY THE
- 23. IF A CONFLICT EXISTS BETWEEN THE PLANS AND SPECIFICATIONS, THE CONTRACTOR SHALL CONTACT THE ARCHITECT/ENGINEER FOR CLARIFICATION PRIOR TO CONSTRUCTION.
- 24. CONTRACTOR SHALL BE RESPONSIBLE FOR OBTAINING REQUIRED PERMITS AND FOR CONTACTING THE CITY TO ARRANGE FOR A PRE CONSTRUCTION CONFERENCE IF SO REQUESTED BY THE CITY, PRIOR TO THE START OF CONSTRUCTION.
- 25. CONTRACTOR SHALL COMPLY WITH LOCAL, STATE AND NATIONAL REQUIREMENTS FOR STORM WATER DISCHARGE ASSOCIATED WITH CONSTRUCTION ACTIVITY.
- 26. FOR PAVEMENT THICKNESSES AND MATERIAL SPECIFICATIONS, REFER TO DETAIL SHEETS.
- 27. UNDERGROUND UTILITIES SHALL BE INSTALLED IN ACCORDANCE WITH LOCAL STANDARDS.

SPECIAL NOTES THIS SHEET

RIGHT-OF-WAY.

- PAVEMENT GRADES IN MARKED HANDICAPPED AREA SHALL NOT EXCEED 2% IN ALL
- REFER TO PUBLIC IMPROVEMENT PLANS FOR ALL WORK WITHIN THE PUBLIC

AS SIGNIFIED BY MY HAND AND SEAL.

NO. DATE BY

I HEREBY CERTIFY THAT

THIS PLAN AND SPECIFI-

AM A DULY REGISTERED

ARCHITECT OR ENGINEER UNDER THE LAWS OF THE STATE OF NEW MEXICO

CATIONS WAS PREPARED BY ME OR UNDER MY DIRECT SUPERVISION AND THAT I

PROJECT NAME

(NEC) WYOMING BLVD & INDIAN SCHOOL RD ALBUQUERQUE, NM

> DRAWING TITLE SITE GRADING PLAN

DATE 6/24/04 CRITERIA-FISCAL 2004 STORE NO. # 09213 SCALE: AS SHOWN

REVIEWED BY:

200 WILMOT ROAD

Timothy M. Gallup

Architect of Record

9 East 4th Street • Suite 1000 • Tulsa, Oklahoma 74103

(918) 584-8855 • (918) 584-2880 FAX

cgc@callahangallup.com (e-mail)

PROJECT TYPE

■ WALGREENS' CONSULTANT
■ LANDLORD'S CONSULTANT

ALL CONSTRUCTION WORK, UNLESS NOTED OTHERWISE, BY

Khoury Engineering, Inc.

Civil Engineering — Land Development

847-940-2500

1435 East 41st Street

CA #375 I, Renewal 06-30-05

DRAWINGS/SPECIFICATIONS BY:

■ WALGREENS' CONTRACTOR

LANDLORD'S CONTRACTOR

REMODELING...

RELOCATION..

OTHERS.....

Tulsa, OK 74105

DEERFIELD, IL.

Tel 918.712.8768

Fax 918.712.1069

(TURNKEY CONSTRUCTION)

NEW SHELL ONLY .

CONST.

DESCRIPTION

REVISIONS

CERTIFICATION AND SEAL

BUILDING

EXISTING...

DRAWING NO.

OF 10 DWGS.

REFER TO DRAINAGE PLAN SHEET C2.1 FOR DETAILS OF STORM DRAIN SYSTEM AND DRAINAGE CALCULATIONS.

BENCHMARK NOTE

ELEVATIONS HEREON ARE BASED ON ACS BENCHMARK 9-J19, THE PUBLISHED ELEVATION OF WHICH IS 5369.542, AND IS LOCATED IN THE S.W. QUADRANT OF THE INTERSECTION OF WYOMING BOULEVARD N.E. AND INDIAN SCHOOL ROAD N.E.

CONTRACTOR SHALL CONTACT NEW MEXICO ONE-CALL SYSTEM @ (800) 321-2537, AT LEAST 72 HOURS PRIOR TO **BEGINNING CONSTRUCTION**



