CITY OF ALBUQUERQUE

Planning Department Alan Varela, Director



Mayor Timothy M. Keller

November 10, 2022

Fred C. Arfman, PE Isaacson & Arfman, Inc. 128 Monroe St. NE Albuquerque, NM 87108

Re: Dutch Bros 2501 Juan Tabo NE Traffic Circulation Layout Engineer's Stamp 10-24-22 (H21-D004A)

Dear Mr. Arfman,

Based upon the information provided in your submittal received 11-02-22, the above referenced plan cannot be approved for Building Permit until the following comments are addressed:

1. Please show a vicinity map showing the location of the development in relation to streets and well known landmarks.

PO Box 1293

2. Identify the right of way width, medians, curb cuts, and street widths on Juan Tabo Blvd, Phoenix Ave. and Muriel St. NE.

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3. Per the DPM Table 7.4.46, Driveway access off Juan Tabo should be 150 ft. away from the intersection of Juan Tabo and Phoenix. Please clearly show this dimension on the site plan.

NM 87103

- 4. List radii for curves for driveway access off Juan Tabo; for passenger vehicles. Radius for delivery trucks, fire trucks, etc. is 25 ft. or larger.
- 5. Minimum throat length for this site should be 50 ft. please show this dimension on the site plan.

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- 6. Minimum width for the ADA parking space is 8.5 ft.
- 7. Driveway access off Muriel should be built as a curb return design (per COA std dwg 2426) and provide the radius.
- 8. ADA curb ramp at the corner of Juan Tabo Blvd. and Phoenix Ave. must be updated to current standards and have truncated domes installed.
- 9. ADA curb ramp at the corner of Phoenix Ave. and Muriel St. must be updated to current standards and have truncated domes installed.
- 10. Please show 12 cars are stacking in the drive-thru lanes on the site plan.
- 11. All bicycle racks shall be designed according to the following guidelines:
 - a. The rack shall be a minimum 30 inches tall and 18 inches wide.
 - The bicycle frame shall be supported horizontally at two or more places.
 Comb/toaster racks are not allowed.

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- c. The rack shall be designed to support the bicycle in an upright position. See the IDO for additional information.
- d. The rack allows varying bicycle frame sizes and styles to be attached.
- e. The user is not required to lift the bicycle onto the bicycle rack.
- f. Each bicycle parking space is accessible without moving another bicycle.
- 12. Bicycle racks shall be sturdy and anchored to a concrete pad.
- 13. A 1-foot clear zone around the bicycle parking stall shall be provided.
- 14. Bicycle parking spaces shall be at least 6 feet long and 2 feet wide.
- 15. Per the IDO, a 6 ft. wide ADA accessible pedestrian pathway is required from the public sidewalk to the building entrances. Please clearly show this pathway and provide details.
- 16. Per DPM, a 6 ft. wide ADA accessible pedestrian pathway is required from the ADA parking stall access aisles to the building entrances. Please clearly show this pathway and provide details.

PO Box 1293

- 17. Refuse vehicle maneuvering shall be contained on-site. The refuse vehicle shall not back into the public right of way, provide a copy of refuse approval.
- 18. Provide a copy of Fire Marshal approval.

Albuquerque

- 19. Please provide "One Way" and "Do Not Enter" signage. And provide face signs details.
- 20. Please provide a sight distance exhibit

NM 87103

21. Show the clear sight triangle and add the following note to the plan: "Landscaping and signage will not interfere with clear sight requirements. Therefore, signs, walls, trees, and shrubbery between 3 and 8 feet tall (as measured from the gutter pan) will not be acceptable in the clear sight triangle.

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- 22. Please specify the City Standard Drawing Number when applicable.
- 23. Add a note stating "All broken or cracked sidewalk must be replaced with sidewalk and curb & gutter." A build note must be provided referring to the appropriate City Standard drawing.
- 24. Please provide a letter of response for all comments given.
- 25. Traffic Studies: See the Traffic Impact Study (TIS) thresholds. In general, a minimum combination of 100 vehicles entering and exiting in the peak hour warrants a Traffic Impact Study. Visit with Traffic Engineer for determination, and fill out a TIS Form that states whether one is warranted. In some cases, a trip generation may be requested for determination (Contact Matt Grush: mgrush@cabq.gov).

Once corrections are complete resubmit

1. The Traffic Circulation Layout

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- 2. A Drainage Transportation Information Sheet (DTIS)
- 3. Send an electronic copy of your submittal to PLNDRS@cabq.gov.
- 4. The \$75 re-submittal fee.

For log in and evaluation by Transportation.

If you have any questions, please contact me at (505) 924-3675.

Sincerely,

Marwa Al-najjar

PO Box 1293 Associate Engineer, Planning Dept.

Development Review Services


Albuquerque

\ma via: email

C: CO Clerk, File

NM 87103

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PROJECT DATA

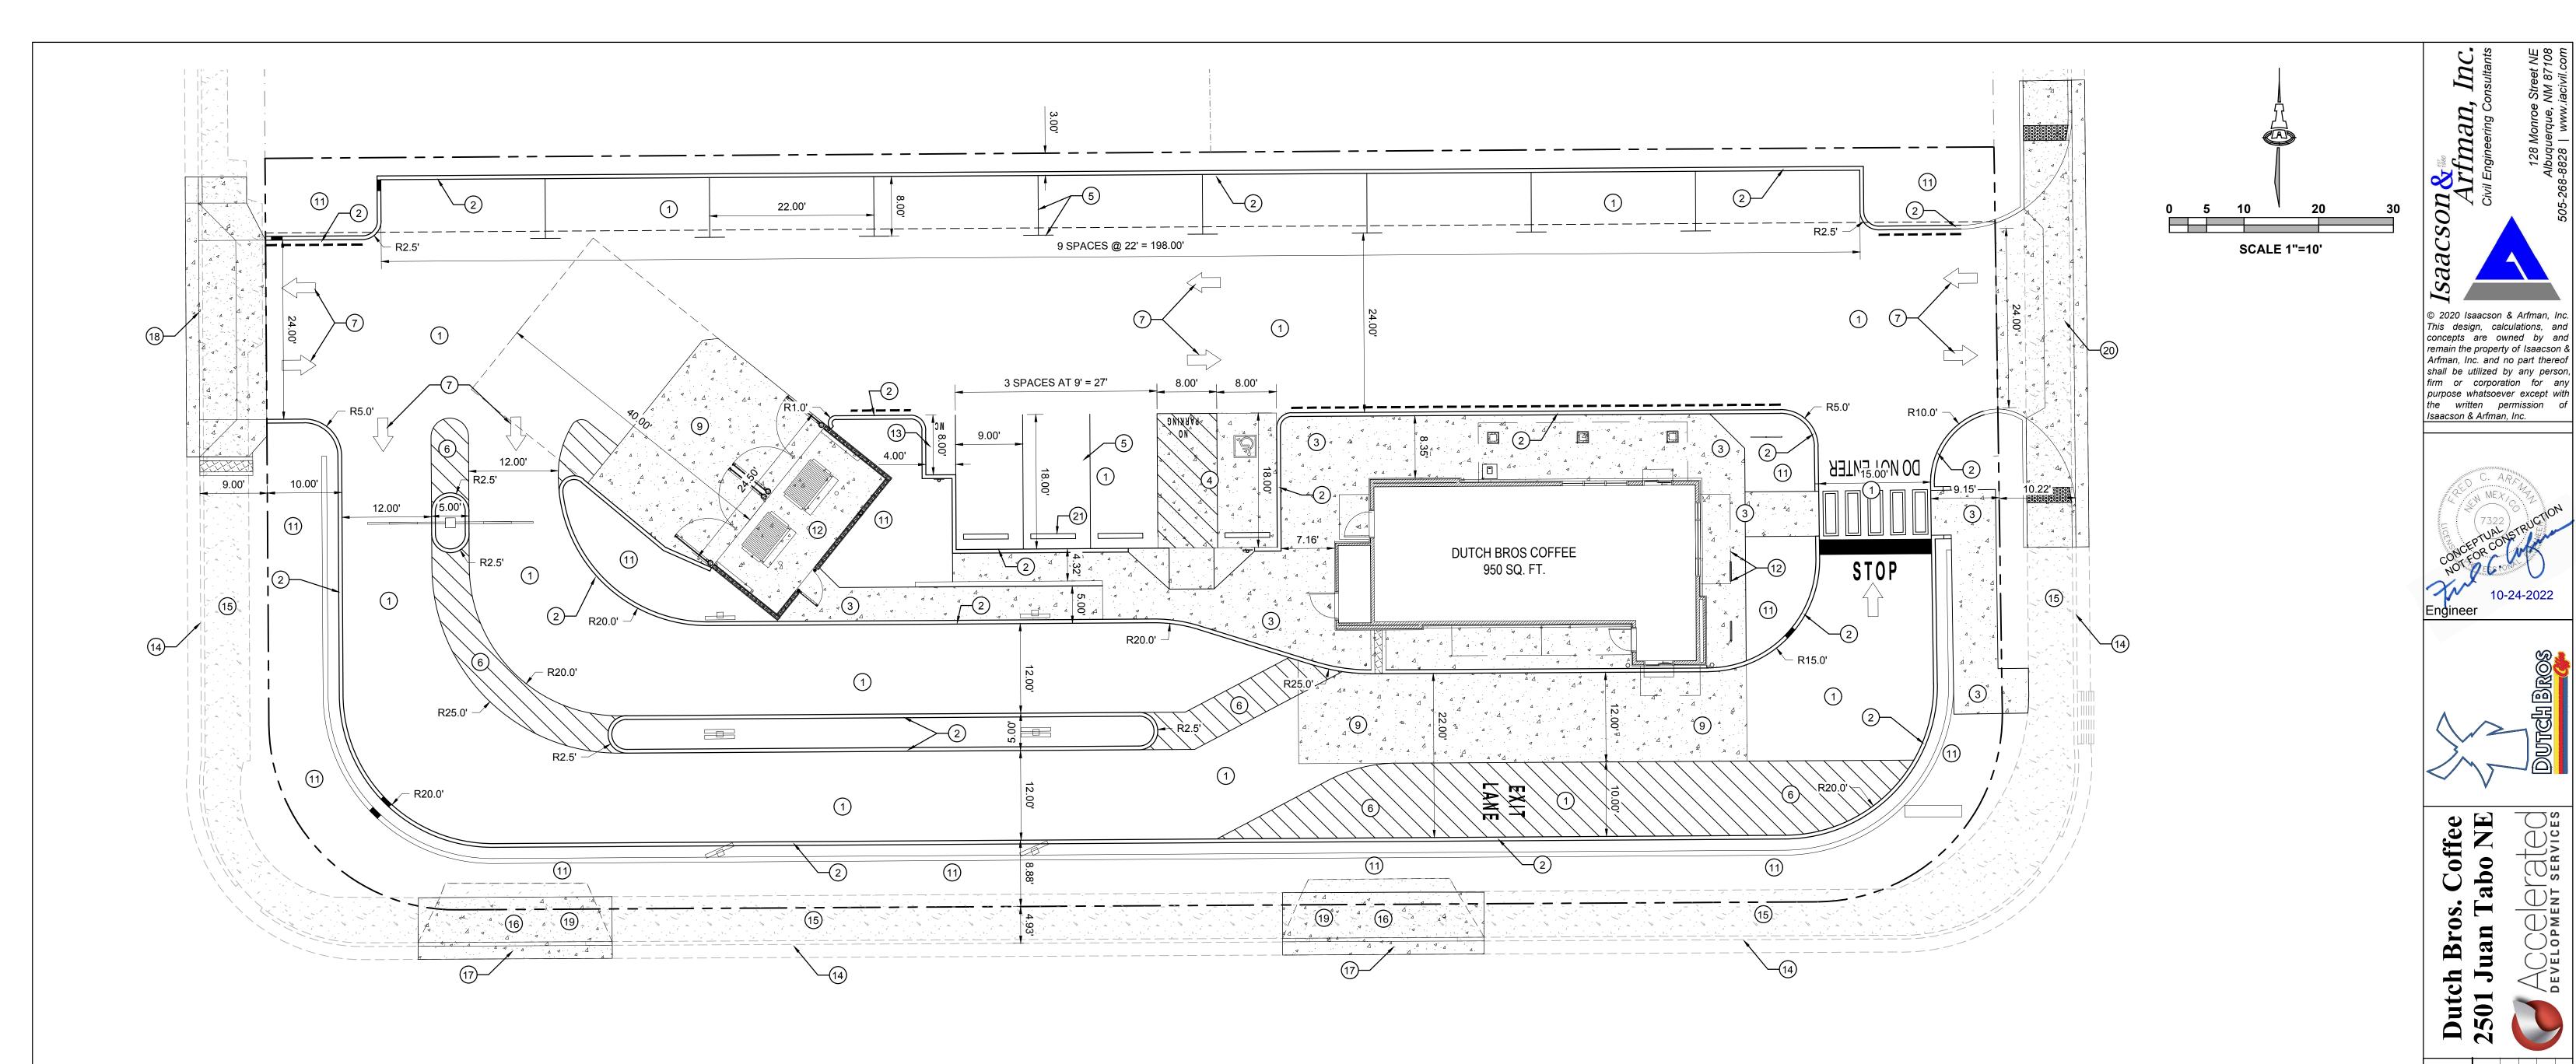PARKING CALCULATION (IDO Table 5-5-1):
5 SPACES PER 1,000 GFA = 8 PARKING SPACES REQUIRED
TOTAL PARKING REQUIRED= 8
TOTAL PARKING PROVIDED = 13

DRIVETHRU STACKING SPACES REQUIRED PER IDO TABLE 5-5-8=12 DRIVETHRU STACKING SPACES PROVIDED=14

MOTORCYCLE PARKING REQUIRED = 1 (IDO Table 5-5-4)
MOTORCYCLE PARKING PROVIDED = 1

(including 1 ADA Van space)

BICYCLE PARKING REQUIRED = 3 (IDO Table 5-5-5)
BICYCLE PARKING PROVIDED = 3 (3 bicycles per 1 bike rack)

GENERAL NOTES

- A. DIMENSIONS ARE TO FACE OF CURB, OR WALL, OR EDGE OF PAVEMENT UNLESS OTHERWISE NOTED.
- B. ALL CURB RADII ARE 2' UNLESS OTHERWISE NOTED.
- C. CURBS AND ACCESSIBLE RAMPS WILL BE DESIGNED AND BUILT ACCORDING TO THE CITY OF ALBUQUERQUE STANDARDS.
- D. STREETS, PARKING SPACES AND ASSOCIATED DRIVES TO BE ASPHALT UNLESS NOTED OTHERWISE.
- E. LANDSCAPE AND SIGNAGE WILL NOT INTERFERE WITH CLEAR SIGHT REQUIREMENTS. SIGNS, WALLS AND PLANTING BETWEEN 3 FEET AND 8 FEET TALL (AS MEASURED FROM THE GUTTER PAN) WILL NOT BE PERMITTED IN THE CLEAR SIGHT TRIANGLE.

KEYED NOTES

- 1. ASPHALT PAVING.
- 2. PCC MEDIAN CURB AND GUTTER, PER DETAIL ON SHEET CP-501.
- 3. PCC FLATWORK, PER DETAIL ON SHEET CP-501.
- 4. ADA ACCESSIBLE RAMP, PER DETAIL ON SHEET CP-501.
- 5. 4" WHITE STRIP.
- 6. CROSS WALK / EXIT LANE STRIPING.
- 7. DIRECTION ARROW.

9. PCC PAVING, SEE PAVING PLAN.

- 8. ADA PARKING, PER DETAIL ON SHEET CP-501.
- 10. REFUSE ENCLOSURE, SEE ARCHITECTAL.
- 11. LANDSCAPING.
- 12. BIKE RACK, PER DETAIL ON SHEET ____.13. MOTORCYCLE PARKING, SIGNAGE PER DETAIL ON SHEET CP-501.
- 14. EXISTING CURB & GUTTER TO REMAIN.
- 15. EXISTING SIDEWALK TO REMAIN.
- 16. EXISTING CURB & GUTTER, SIDEWALK, AND DRIVE PAD TO BE REMOVED & DISPOSED.
- 17. STANDARD CURB & GUTTER, PER COA STD DWG 2415A.
- 18. MODIFIED EXISTING DRIVEPAD WITH SIDEWALK AT BACK OF CURB, PER COA STD DWG
- 19. SIDEWALK (WIDTH PER PLAN) PER COA STD DWG 2430.
- 20. NEW DRIVEPAD PER COA STD DWG 2426.
- 21. PARKING BUMPER, PER DETAIL ON SHEET _____.

LEGEND

 \equiv \equiv \equiv \equiv EXISTING CURB AND GUTTER

PROPOSED CURB AND GUTTER

No Date Description

DESIGN
ISSUE: DEVELOPMENT
PROJECT NUMBER: IA 257
FILE:
DRAWN BY:
CHECKED BY:


SHEET TITLE

TRAFFIC CIRCULATION LAYOUT PLAN

SHEET NUMBER

DATE

CP-401

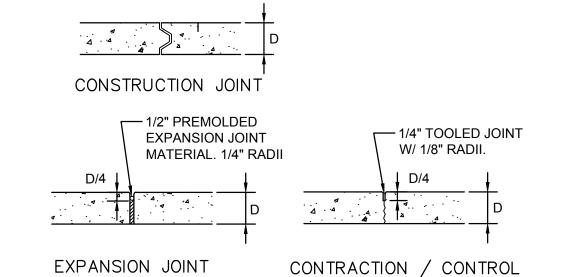

GENERAL NOTES


1. ODD-SHAPED AREAS OF PAVEMENT SHOULD BE AVOIDED TO MINIMIZE RANDOM CRACKING


JOINT

- 2. LONGITUDINAL JOINT SPACING SHALL NOT EXCEED 12.5'
- 3. TRANSVERSE JOINT SPACING SHALL BE AT REGULAR INTERVALS OF 15' OR LESS
- 4. OFFSETS AT RADIUS POINTS SHALL BE AT LEAST 1.5' WIDE

CONCRETE JOINTS

SCALE: N.T.S.

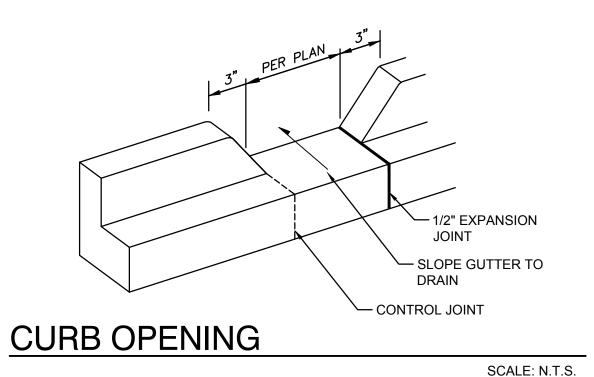

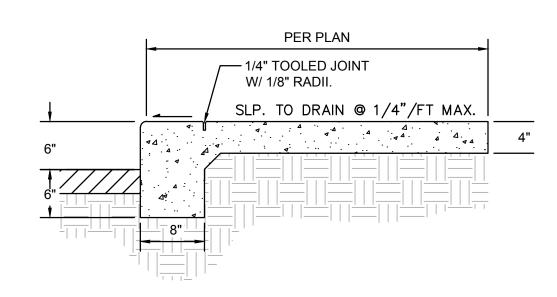

GENERAL NOTES

8' @ CROSSWALKS AND

VAN AISLES

5' @ NON-VAN ACCESSIBLE PARKING **AISLES**

- 1. CONTRACTION / CONTROL JOINTS @ 6' O.C. MAX.
- 2. 1/2" EXPANSION JOINTS @ 24' O.C., CURB RETURNS AND EACH SIDE OF
- 3. REQUIRES FULL FORM ON ALL FACES.
- 4. 3/8" RADII AT ALL EXPOSED EDGES.

PAINTED ACCESSIBLE CROSSWALK

WIDE STROKES

PAINTED 'NO PARKING'

SIDEWALK - TURNED DOWN EDGE


" WHITE PAINTED

STRIPING

PAINT SOLID WHITE

SCALE: N.T.S.

SCALE: N.T.S.

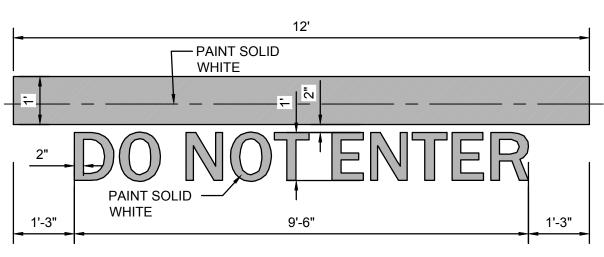

(W)


3. FINISHED EDGE OF ASPHALT PAVING TO BE 1/2" ABOVE EDGE OF

4 X (W) O.C

TYPICAL

1/2 EXPANSION JOINT SPACING



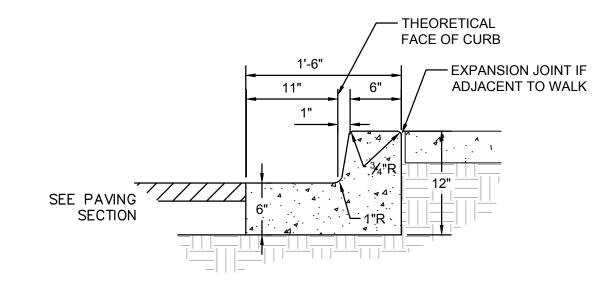


GENERAL NOTES

- 1. REQUIRES FULL FORM ON ALL FACES.
- 2. CONTRACTION / CONTROL JOINTS @ 6' O.C. MAX.
- 3. EXPANSION JOINTS @ 48' O.C., CURB RETURNS AND EACH SIDE OF
- 4. EDGES NOT SPECIFICALLY DIMENSIONED SHALL BE EDGED WITH A 3/8"

MEDIAN CURB AND GUTTER


8" WIDE THEORETICAL FACE OF CURB

SCALE: N.T.S.

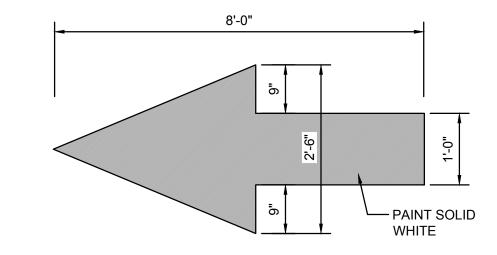

PAINTED TRAFFIC ARROW

SCALE: N.T.S.

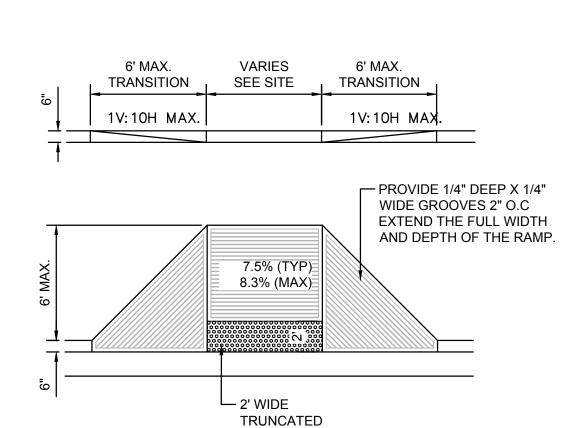

FLARED ACCESSIBLE RAMP

7.5% (TYP) 8.3% (MAX)


PARKING

8' AISLE

ADA PARKING DETAIL

- PAINT 12" LETTERS

SCALE: N.T.S.

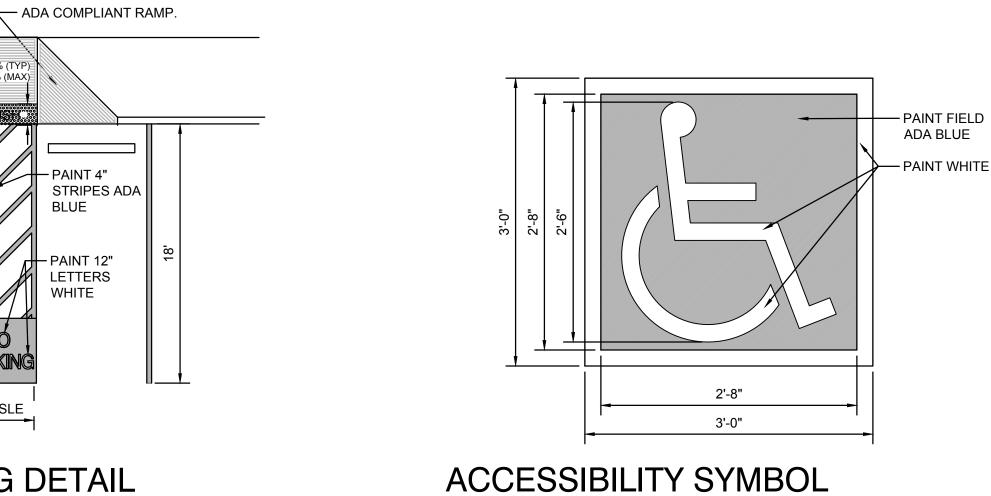

RESERVED PARKING 12"X18" WHITE SIGN WITH - 12"X18" WHITE SIGN WITH GREEN FRAME, GREEN TEXT. GREEN FRAME, GREEN TEXT, MOTORCYCLE* WHITE ISA SYMBOL ON ADA BLUE PER STATE / LOCAL Parking CODE. ONLY VIOLATORS ARE SUBJECTO A FINE AND/OR TOWING VAN≺ · 12"X6" WHITE SIGN WITH ACCESSIBLE GREEN FRAME, GREEN TEXT WHERE INDICATED ON PLAN. −1.5" O.D. GALVANIZED STEEL PIPE BREAKAWAY \$CALE: N.T.S **GALVANIZED POST** COUPLER. CROWN CONC. TO DRAIN AWAY. - 2-3/8" 0.D. STEEL PIPE SLEEVE 8" X 2.0'

CONCRETE FOOTING

SCALE: N.T.S.

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10-24-2022

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SHEET TITLE

PAVING DETAILS

SHEET NUMBER **CP-501**

SCALE: N.T.S.

SCALE: N.T.S.

CONCRETE WALK BROOM FINISH

2. SEE CONCRETE JOINTS DETAIL

4. 3/8" RADII AT ALL EXPOSED EDGES.

1. 4000 PSI COMPRESSIVE STRENGTH CONCRETE

STANDARD CONCRETE -

— CONTRACTION /

CONTROL JOINT

(W) WIDTH SEE PLAN

SCALE: N.T.S.

SIDEWALK. LIGHT BROOM

DIRECTION OF WALK.

GENERAL NOTES

GENERAL NOTES

CONCRETE (TYP).

FINISH PERPENDICULAR TO

PAINTED 'DO NOT ENTER'

SCALE: N.T.S.

SIGNAGE



City of Albuquerque

Planning Department

Development & Building Services Division

DRAINAGE AND TRANSPORTATION INFORMATION SHEET

Legal Description: Tract "H" Juan Tabo Subdivision City Address OR Parcel 2501 Juan Tabo NE Applicant/Agent: Isaacson & Arfman, Inc. Contact: Fred C. Arfman / Justin Thor Simenson / Address: 128 Monroe St NE, ABQ , NM 87108 Phone: (505)268-8828 Email: Ireda@iacivil.com / thors@iacvicil.com / bryanb@iacivil.com Applicant/Owner: Accelerated Development Contact: Jake Palmer Address: 2415 E, Camelback Rd Ste 400 Phoenix AZ, 85016 Phone: 602.682.8153 Email: Jake.Palmer@accelerateddevco.com TYPE OF DEVELOPMENT: PLAT (#of lots) RESIDENCE DRB SITE ADMIN SITE: X RE-SUBMITTAL: YES X NO DEPARTMENT: X TRANSPORTATION HYDROLOGY/DRAINAGE Check all that apply: TYPE OF SUBMITTAL: TYPE OF APPROVAL/ACCEPTANCE SOUGHT: BUILDING PERMIT APPROVAL CONCEPTUAL G&D PLAN CERTIFICATION CERTIFICATE OF OCCUPANCY CONCEPTUAL G&D PLAN PRELIMINARY PLAT APPROVAL SITE PLAN FOR SUB'D APPROVAL SIA/RELEASE OF FINANCIAL GUARANTE CLOMR/LOMR SIA/RELEASE OF FINANCIAL GUARANTE CLOMR/LOMR FOUNDATION PERMIT APPROVAL ADMINISTRATIVE SO-19 APPROVAL PAPPROVAL PAPPROVAL SIA/RELEASE OF FINANCIAL GUARANTE FOUNDATION PERMIT APPROVAL ADMINISTRATIVE SO-19 APPROVAL PAPPROVAL PAPPRO	uilding Per	Bı	Tabo	n Tabo	abo	0]	_Bu	uil	ldi	inş	g l	Per	mi	it #	#					_H	ydı	ro	loş	gy	Fi	le	#_	Н	l-2	1	_	
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Address: 2415 E, Camelback Rd Ste 400 Phoenix AZ, 85016 Email: Jake.Palmer@accelerateddevco.com TYPE OF DEVELOPMENT:PLAT (#of lots)RESIDENCEDRB SITE ADMIN SITE:X RE-SUBMITTAL:YESXNO DEPARTMENT:X_TRANSPORTATION HYDROLOGY/DRAINAGE Check all that apply: TYPE OF SUBMITTAL:TYPE OF APPROVAL/ACCEPTANCE SOUGHT:ENGINEER/ARCHITECT CERTIFICATIONBUILDING PERMIT APPROVAL																_ <u>o</u> m				_		1	/-												_	
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