
## CITY OF ALBUQUERQUE

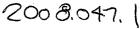



September 30, 2009

J. Graeme Means, P.E. High Mesa Consulting Group 6010-B Midway Park Blvd. NE Albuquerque, NM 87109

Re: Onate Elementary School Grading and Drainage Plan Engineer's Stamp date 9-25-09 (H22/D035)

Dear Mr. Means,

PO Box 1293

Albuquerque

NM 87103

www.cabq.gov

Based upon the information provided in your submittal received 9-25-09, the above referenced plan is approved for Building Permit. Please attach a copy of this approved plan to the construction sets prior to sign-off by Hydrology.

Prior to Temporary or Permanent Certificate of Occupancy release:

- Engineer Certification per the DPM checklist will be required.
- The fire lane road and the concrete rundown east of the existing Admin and classroom building are required to be built and certified.

This project requires a National Pollutant Discharge Elimination System (NPDES) permit for storm water discharge.

If you have any questions, I can be reached at 924-3695.

Sincerely,

प्रदर्शकार है। के <sub>प</sub>र सम्बद्ध करते हैं के किस्ता है

Curtis A. Cherne, P.E.

Senior Engineer, Planning Dept.

the dro conorde transpoyn past of the extractly Admin sal-

Development and Building Services

C: file

Kathy Verhage, DMD upon by the Dear of Occupency releases

The chart poor of the control of the chart o	A PRESENTATION OF BEAUTY STATES OF S	## COLUMN   S.   DISTORY   CONTROL   CONTROL   S.   DISTORY   CONTROL   CONTROL   S.   DISTORY   CONTROL   S.   DISTORY	VICINITY MAP  SCALE: 1" = 750'  SCALE: 1" = 750'  F.I.R.M. PANEL 357G  SCALE: 1" = 500'  LEGAL DESCRIPTION  AN UNPLATED TRACT OF LAND LOCATED WITHIN THE CORPORATE LIMITS OF THE CITY OF ALBUQUEROUE, BERNALILLO COUNTY, NEW MEXICO, SECTION 10, TOWNSHIP 10 NORTH, RANGE 4 EAST, N.M.P.M., (a.K.a. ONATE ELEMENTARY SCHOOL, UPG \$102059364 16040917), AS DESCRIBED BY WARRANTY DEED FILED IN THE OFFICE OF THE COUNTY CLERK OF BERNALILLO COUNTY, NEW MEXICO ON JULY 06, 1964, BOOK D 749, PAGE 989, DOCUMENT NO. 5644. C  BENCHMARKS  PROJECT BENCHMARK  ACS 1 3/4" ALUMINUM DISK, STAMPED 'ACS BM, 14—H22", EPOXIED ON	ACCHITECTS  STUDIO SOUTHWEST ARCHITECTS, INC. 2101 Mountain Rd, NW, Albuquerque, NM 87104 505 BA3 963 FA 905 BA3 963 Web Site; www.studioswarch.com E-Mall; mail@studioswarch.com Recerved, for expectate, rice is obtain—related to a be supported to the obtain—related to a be supported to a support
Hie Path:    File Name: 2	$Q_{p} = Q_{pA}A_{A} + Q_{pB}A_{B} + Q_{pC}A_{C} + Q_{pD}A_{D}$ $Q_{p} = Q_{100} = ((2.20*0.00) + (2.92*0.28) + (3.73*0.13) + (5.25*1.43)) = 8.8 \text{ CFS}$ 3	4 <b> </b> 5	HMCG PROJECT NO: 2008.047.1	C001

3. BASIN C


CALCULATIONS<sup>3</sup>

I. SITE CHARACTERISTICS

A. PRECIPITATION ZONE =

DRAINAGE PLAN 1

I. INTRODUCTION AND EXECUTIVE SUMMARY

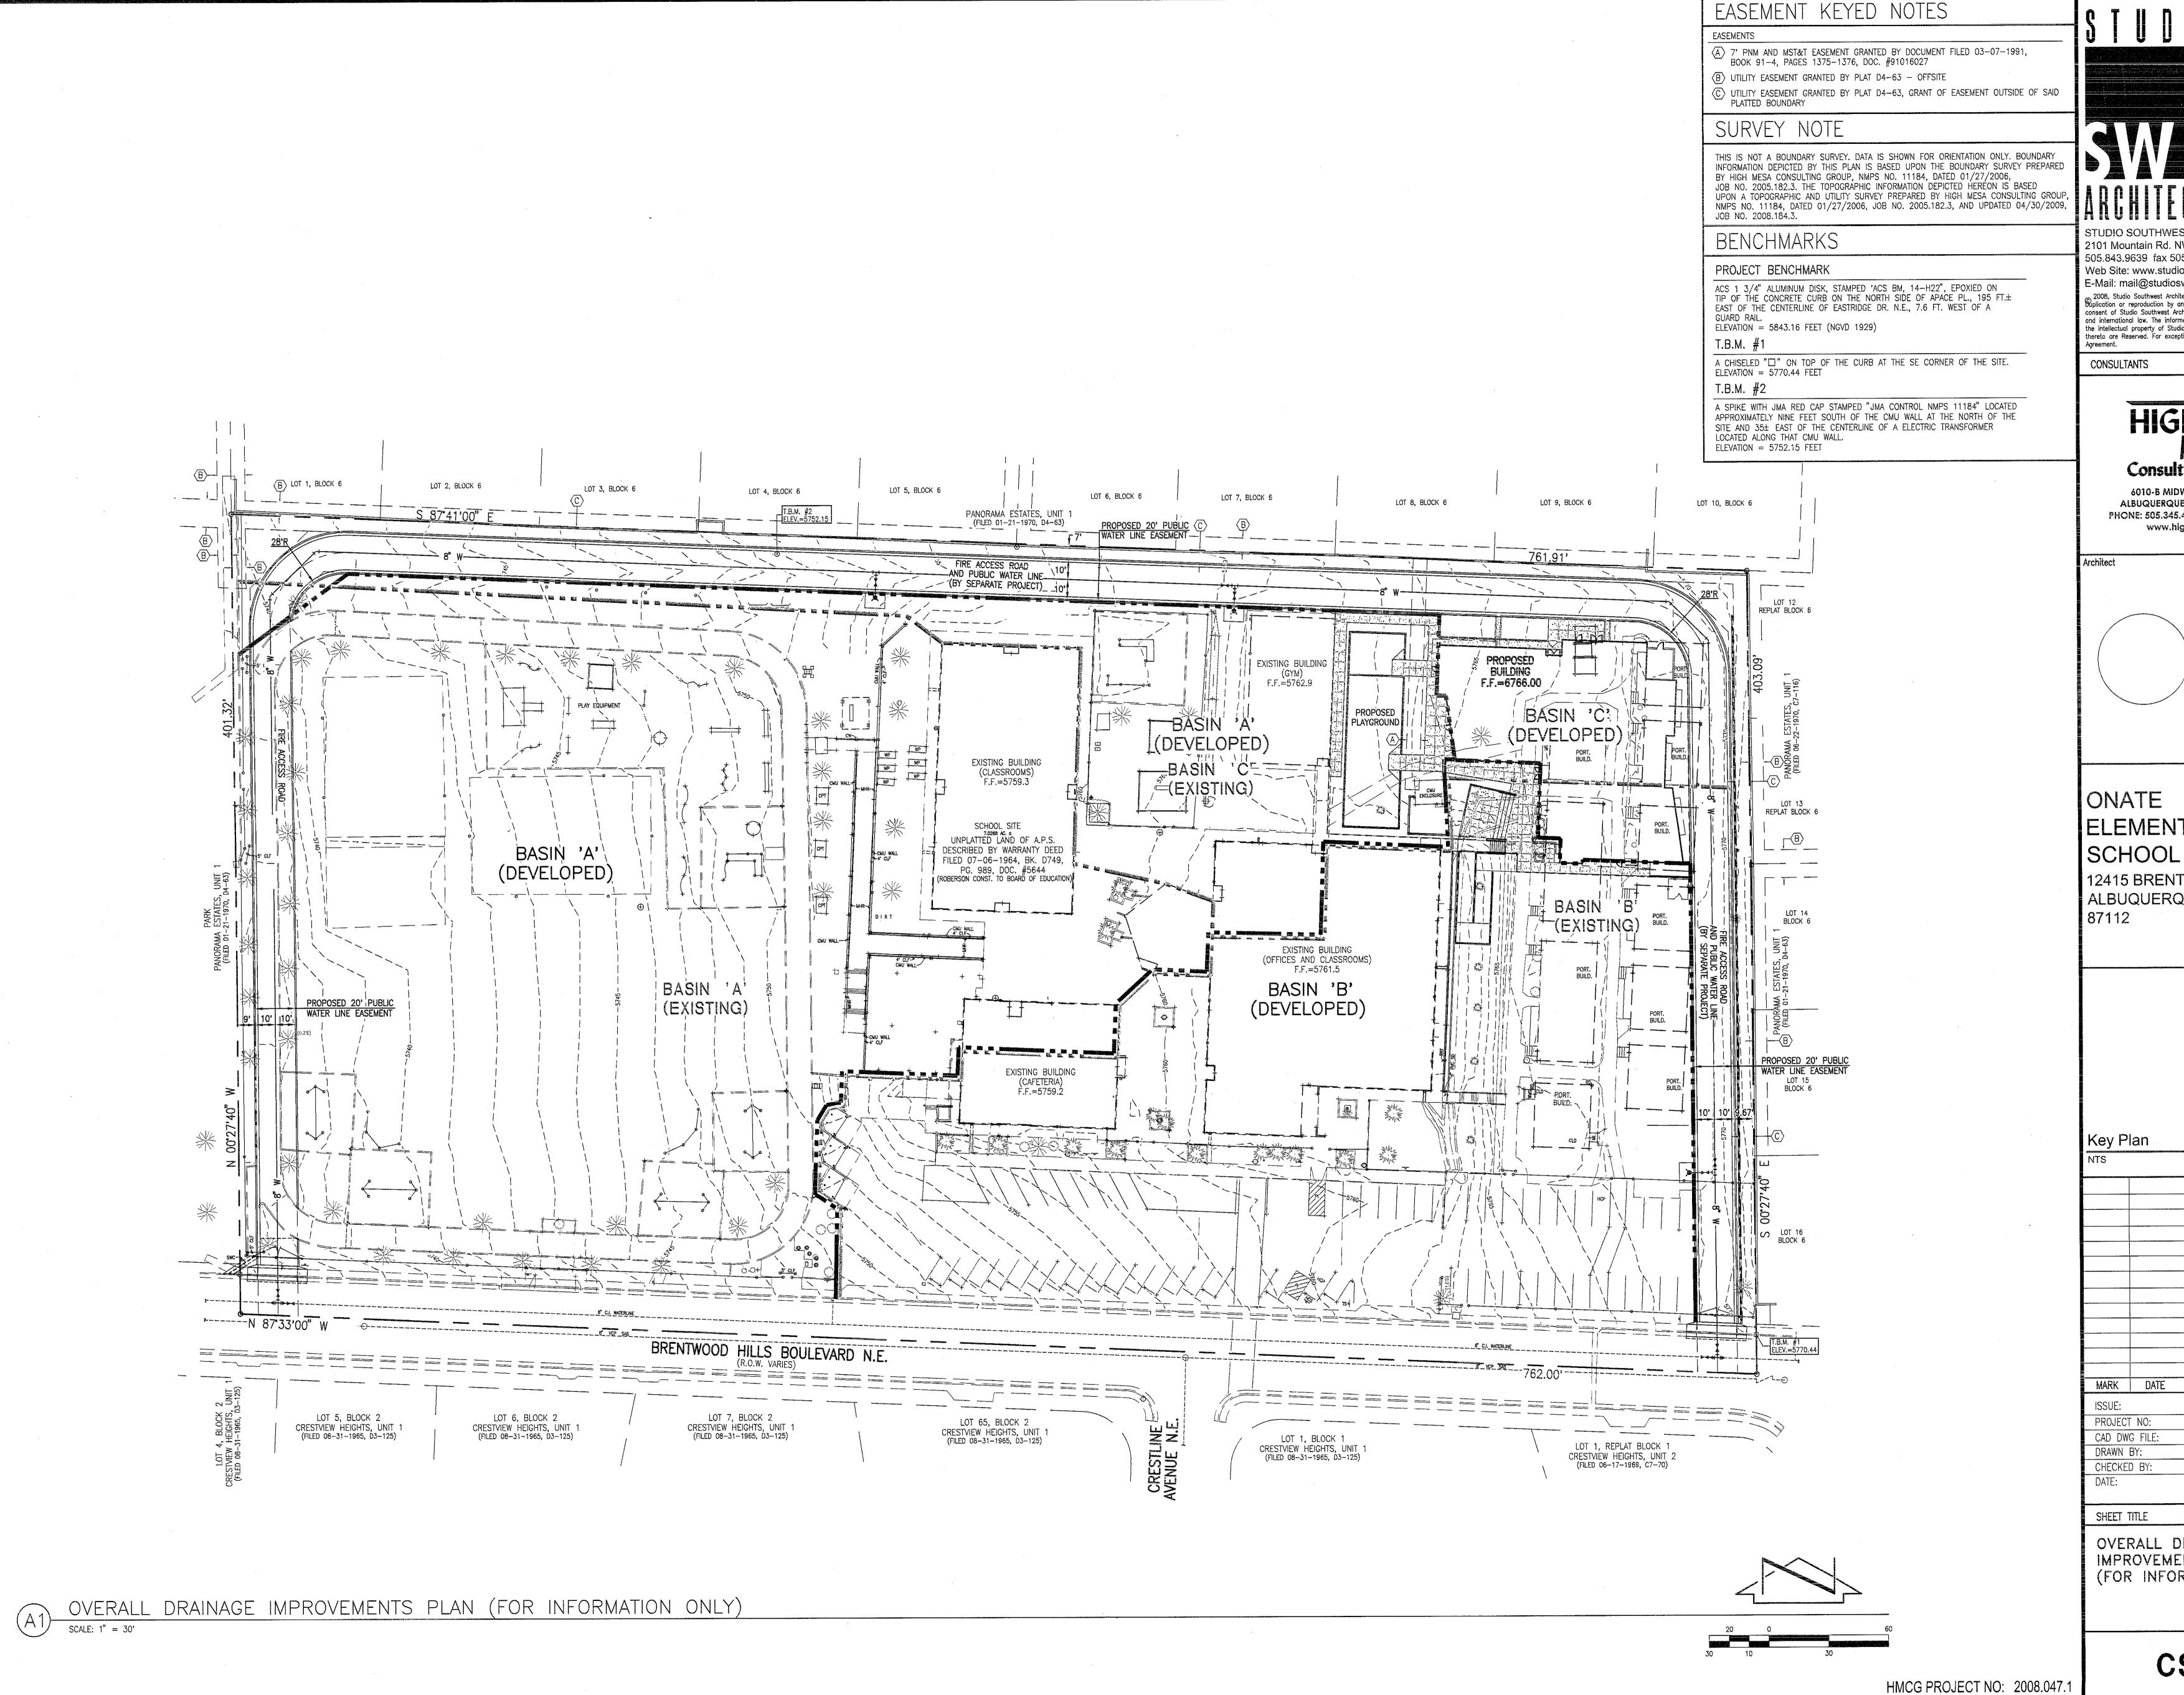


STUDIO SOUTHWEST ARCHITECTS, INC. 2101 Mountain Rd. NW, Albuquerque, NM 87104 505.843.9639 fax 505.843.9683 Web Site: www.studioswarch.com E-Mail: mail@studioswarch.com

2008, Studio Southwest Architects, Inc.
Suplication or reproduction by any means without the express written consent of Studio Southwest Architects, Inc. is a violation of Federal and international law. The information contained on this document is the intellectual property of Studio Southwest, Inc. and all rights thereto are Reserved. For exceptions, refer to the Owner-Architect

**Consulting Group** 

6010-B MIDWAY PARK BLVD. NE ALBUQUERQUE, NEW MEXICO 87109 PHONE: 505.345.4250 FAX: 505.345.4254 www.highmesacg.com

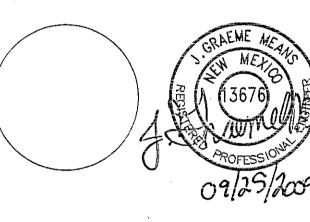


ELEMENTARY

12415 BRENTWOOD HILLS, NE ALBUQUERQUE, NM

MARK DATE DESCRIPTION PERMIT SET 0822 80471CS-101 BLE/DMH/CFA G.M. 11/30/2009

OVERALL DRAINAGE IMPROVEMENTS PLAN (FOR INFORMATION ONLY)

**CS-101** 

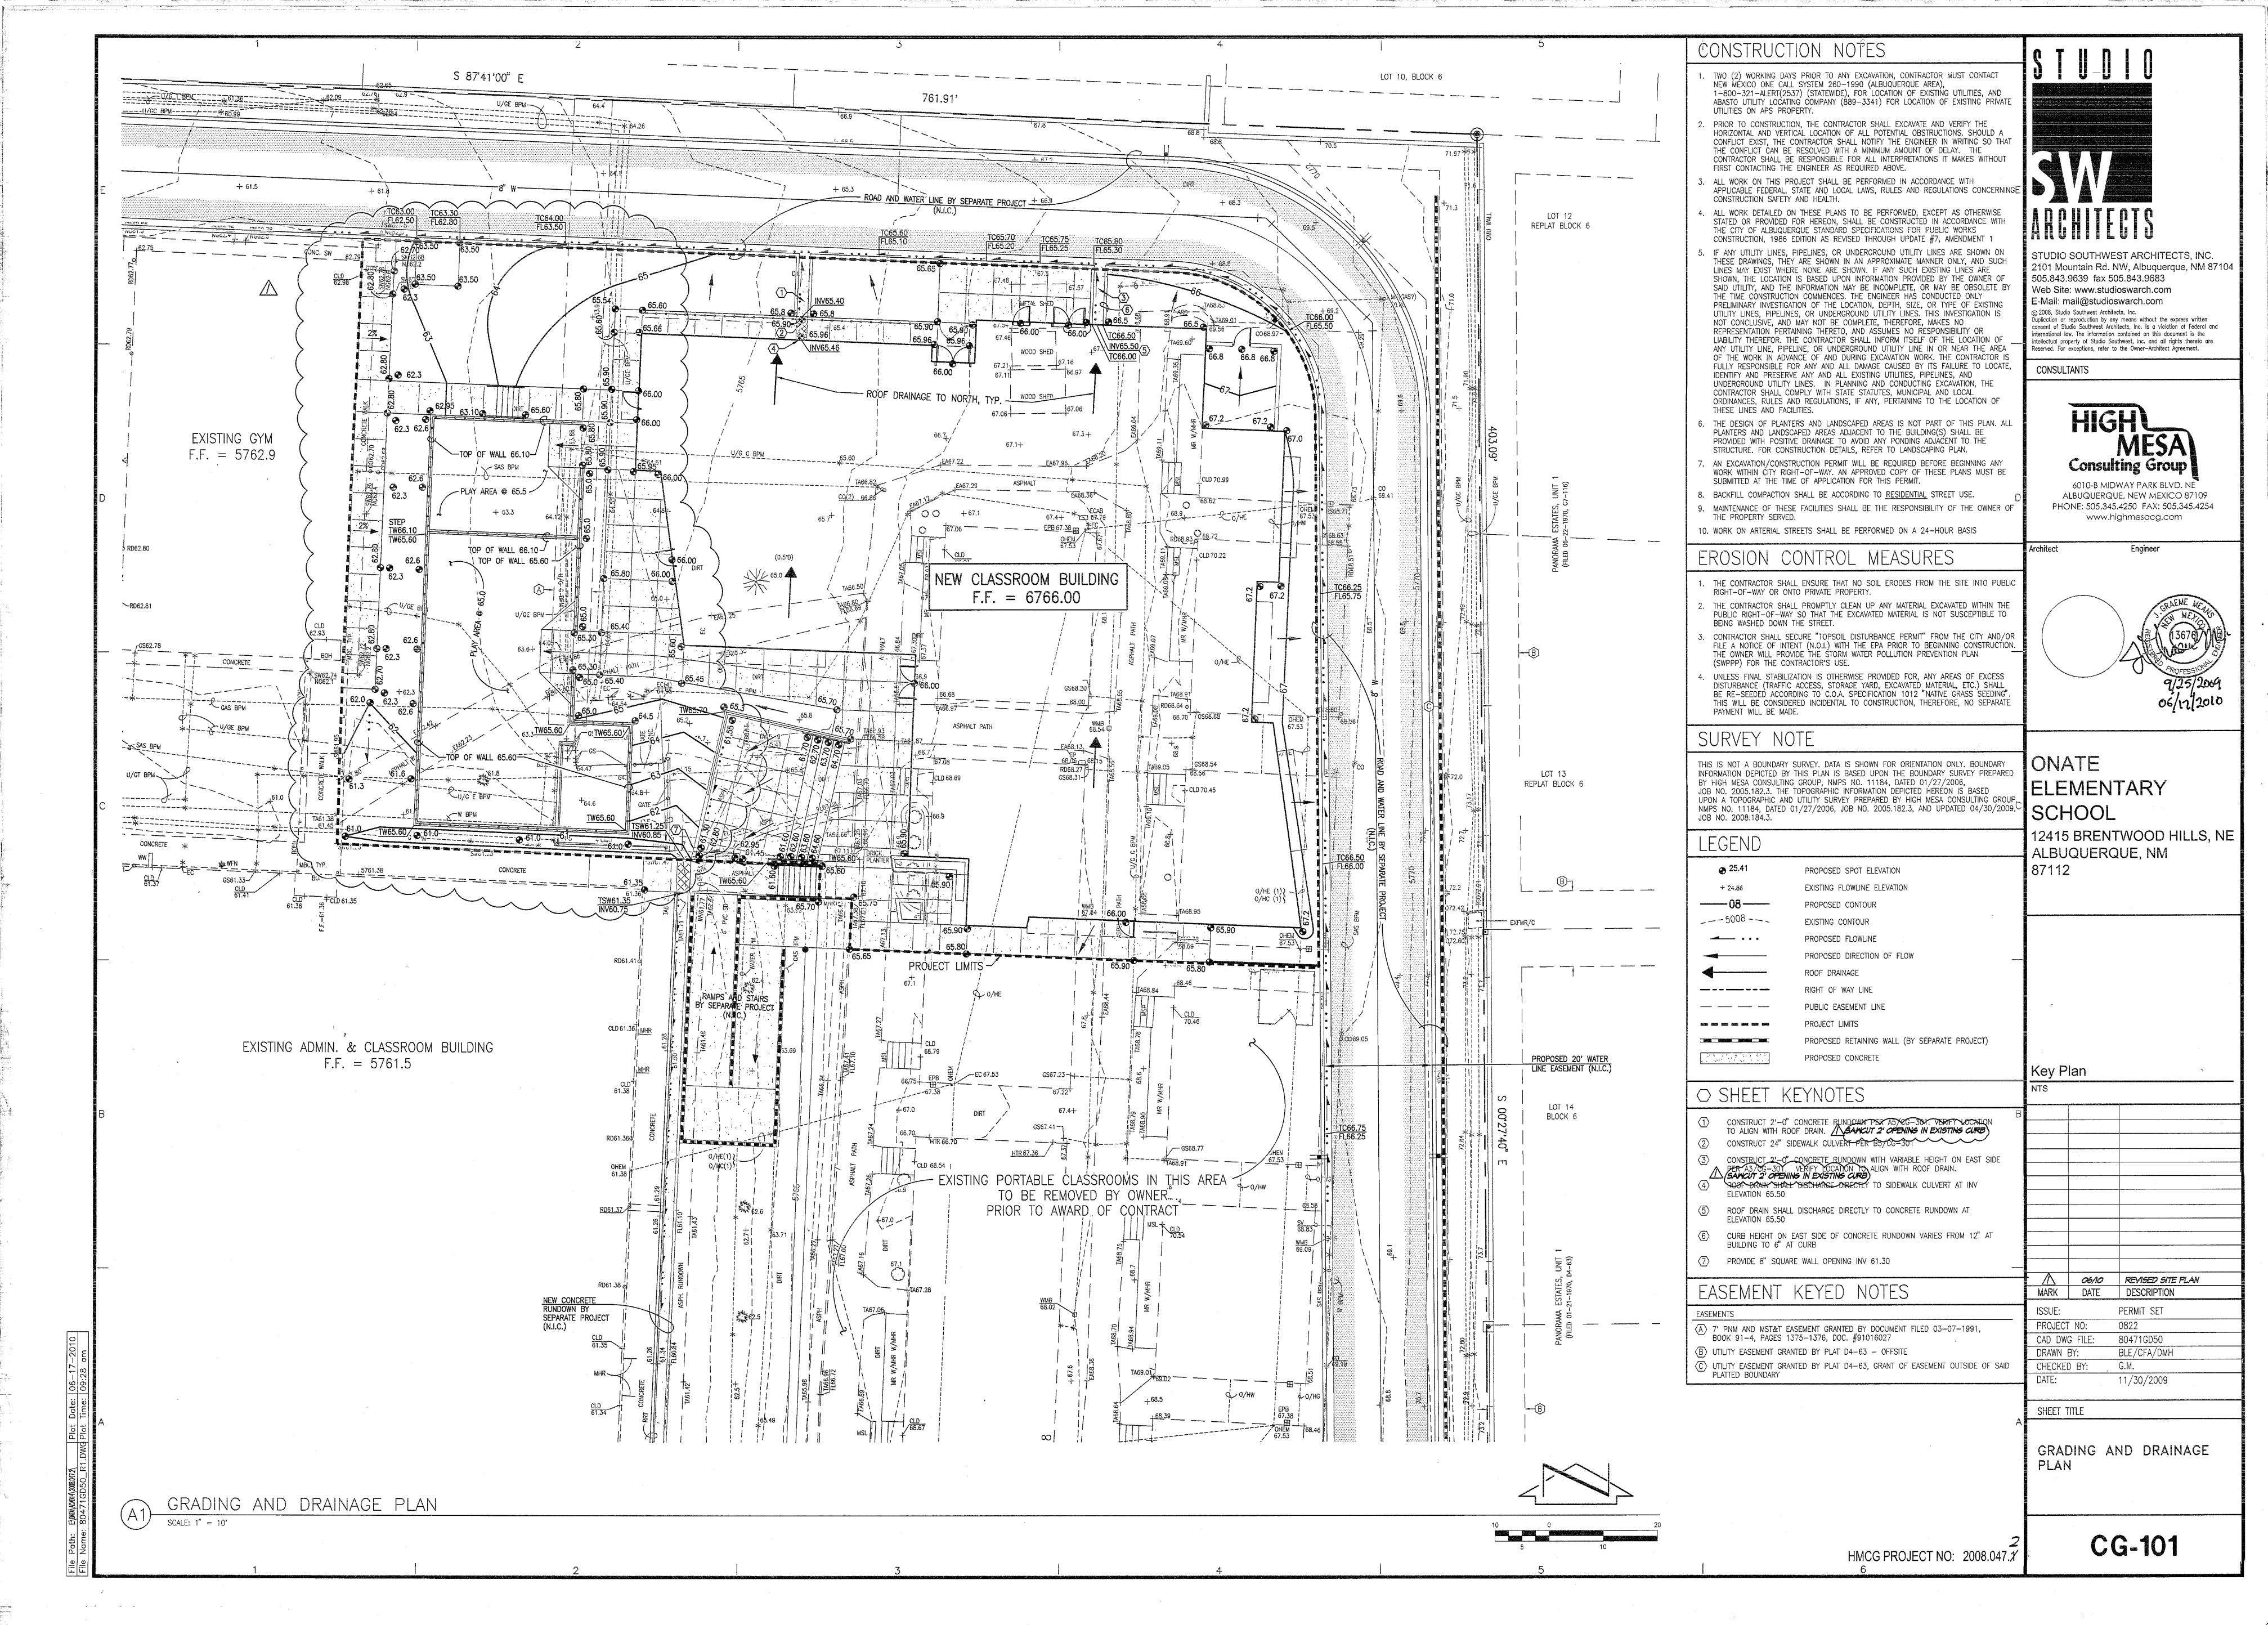

STUDIO SOUTHWEST ARCHITECTS, INC. 2101 Mountain Rd. NW, Albuquerque, NM 87104 505.843.9639 fax 505.843.9683 Web Site: www.studioswarch.com E-Mail: mail@studioswarch.com © 2008, Studio Southwest Architects, Inc.

Duplication or reproduction by any means without the express written consent of Studio Southwest Architects, Inc. is a violation of Federal and international law. The information contained on this document is the intellectual property of Studio Southwest, Inc. and all rights thereto are Reserved. For exceptions, refer to the Owner—Architect Agreement. CONSULTANTS **Consulting Group** 6010-B MIDWAY PARK BLVD. NE ALBUQUERQUE, NEW MEXICO 87109 PHONE: 505.345.4250 FAX: 505.345.4254 www.highmesacg.com 09/25/2009 ONATE ELEMENTARY SCHOOL 12415 BRENTWOOD HILLS, NE ALBUQUERQUE, NM 87112 Key Plan CONSTRUCTION NOTES: D. 3/8" CHECKERED STEEL PLATE.

E. ROD ANCHOR 1" x 5"

G. SIDEWALK GRADE

H. DOWEL AND JOINT, (OPTIONAL).

J. GUTTER FLOWLINE ELEV.

K. 3/8" x 1" F.H. C'SUNK STAINLESS STEEL MACHINE SCREW.

M. DRAIN WIDTH, 24" MAX. 12" MIN.

N. AFTER CLEANING SURFACE OF SCALE, RUST, OILS, ETC.,

PAINT GRATE WITH ONE SHOP COAT RED OXIDE, TWO FINISH

COATS OF ALUMINUM PAINT (AASHTO M 69). NO.3 DEFORMED BAR 3" -DOWEL DETAIL TYPICAL SIDEWALK CULVERT DETAILS NOT TO SCALE MARK DATE DESCRIPTION PERMIT SET PROJECT NO: CAD DWG FILE: 80471SD

DRAWN BY: BLE/CFA

CHECKED BY: G.M.

DATE: 11/30/20 11/30/2009 SHEET TITLE └ 6" SUBGRADE COMPACTED @ 90% ASTM D-1557 └ 6" SUBGRADE COMPACTED @ 90% ASTM D-1557 SECTIONS AND DETAILS 3000 PSI CONCRETE 3000 PSI CONCRETE TYPICAL RUNDOWN SECTION WITH VARIABLE HEIGHT ON EAST CURB A5 TYPICAL 6" RUNDOWN SECTION

SCALE: 1" = 1'-0" SCALE: 1" = 1'-0" CG-301 HMCG PROJECT NO: 2008.047.1