


CATCH BASIN GRATE

-XX.XX-

RECORD SPOT ELEVATION

taurant S 0 9 Siscuits $\mathbf{\Omega}$ 6 Chicken 68


DATE: 20 JUNE 2006

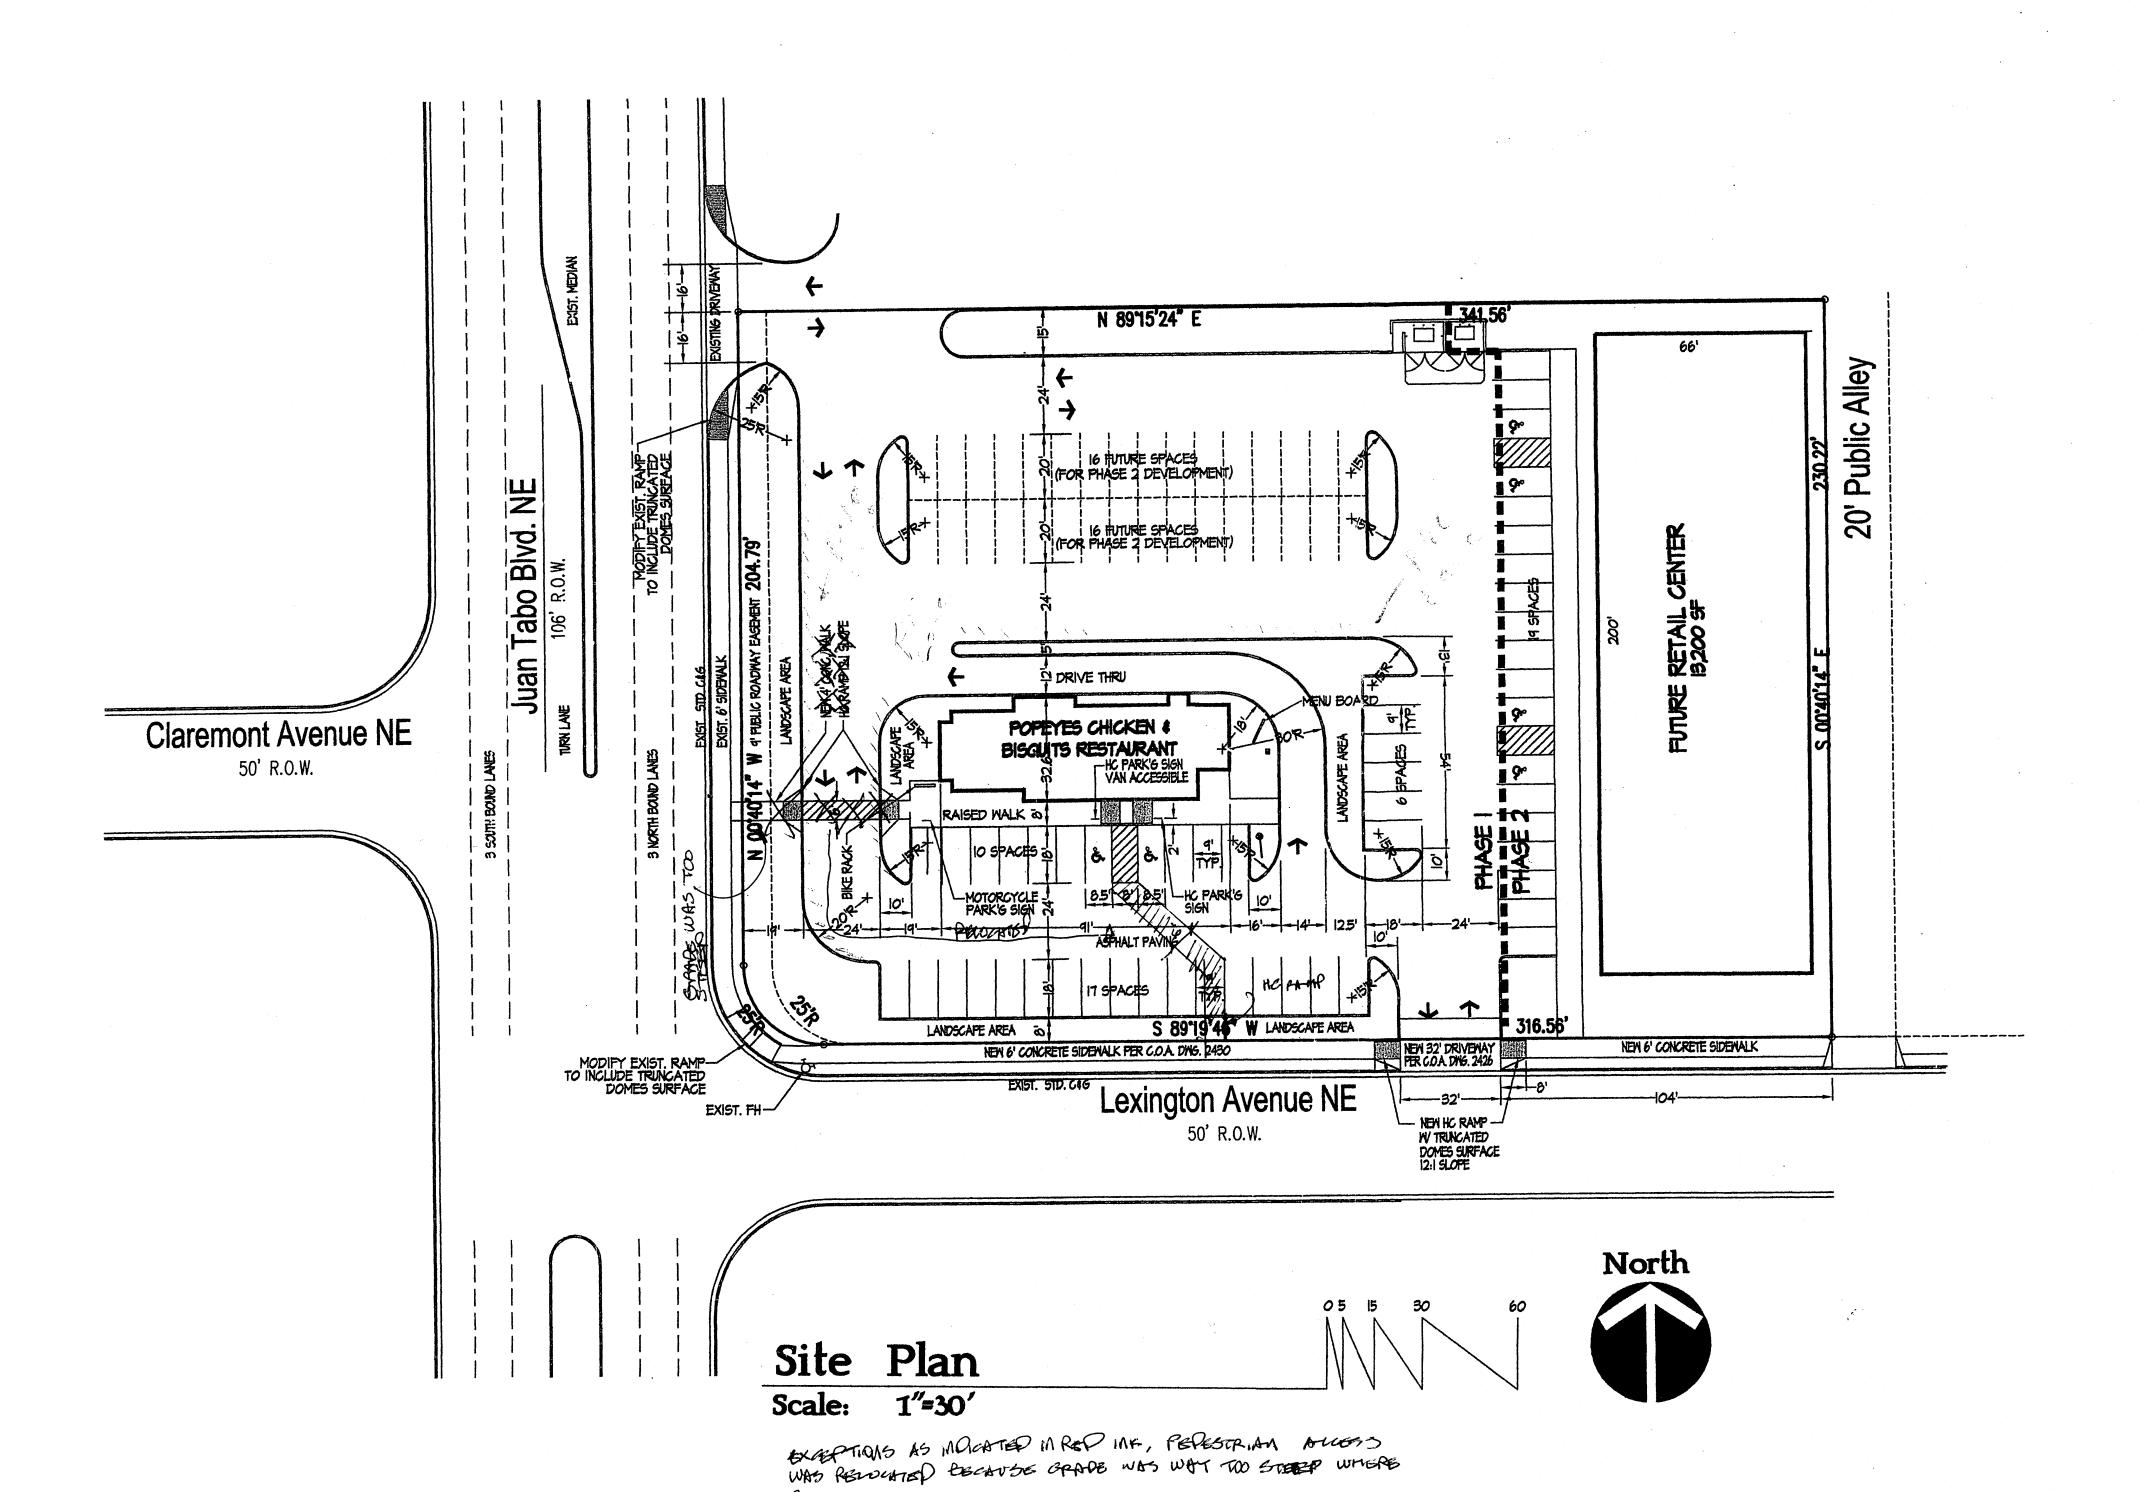

6-28-07

SHOWN ORIGINATUY,

Site

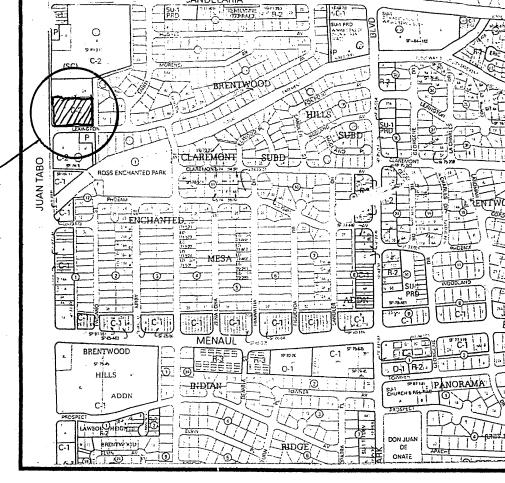

Vicinity Map

H-22

Design Data

	TRACT 1 BLOCK 10' BRENTWOOD HILLS SUBDIVISIO ALBUQUERQUE, NEW MEXIC
CURRENT ZONING:	<u>C-</u>
ZONE ATLAS PAGE:	H-22-
CURRENT USE:	UNDEVELOPE
PROPOSED USE:	
PHASE 1: POPEYES CH PHASE 2:	iichken & Biscuit Restaurant Retail Shops
APPLICABLE BUILDING CODE:	IBC-200
SEISMIC DESIGN CATAGORY:	
MIND DESIGN SPEED (3—SECO	ND GUST): 90 MF
EXPOSURE:	
TYPE OF CONSTRUCTION:	V~
FIRE SPRINKLERED:	No
NUMBER OF STORIES:	ON
TOTAL BUILDING AREA:	2,532 SQ. FT
OCCUPANCY GROUP:	GROUP A-
OCCUPANT LOAD:	IBC TABLE 1004.1
RESTAURANT FIXED SEATIN	NG: 48 SEATS = 48 OCC 1,308 SF/200 = 7 OCC
RESTAURANT FIXED SEATH COMMERCIAL KITCHEN:	NG: 48 SEATS = 48 OCC 1,308 SF/200 = 7 OCC 55 OCCUPANT INING RM: YE
RESTAURANT FIXED SEATING COMMERCIAL KITCHEN: TOTAL: TWO EXITS REQUIRED FROM DI	NG: 48 SEATS = 48 OCC 1,308 SF/200 = 7 OCC 55 OCCUPANT INING RM: YE TWO EXITS PROVIDE
RESTAURANT FIXED SEATING COMMERCIAL KITCHEN: TOTAL: TWO EXITS REQUIRED FROM DIPPLUMBING SYSTEMS: WATER CLOSETS REQ'D:	NG: 48 SEATS = 48 OCC 1,308 SF/200 = 7 OCC 55 OCCUPANT INING RM: YE TWO EXITS PROVIDE IBC TABLE 2902
RESTAURANT FIXED SEATING COMMERCIAL KITCHEN: TOTAL: TWO EXITS REQUIRED FROM DI PLUMBING SYSTEMS:	NG: 48 SEATS = 48 OCC 1,308 SF/200 = 7 OCC 55 OCCUPANT INING RM: YE TWO EXITS PROVIDE IBC TABLE 2902
RESTAURANT FIXED SEATH COMMERCIAL KITCHEN: TOTAL: TWO EXITS REQUIRED FROM DI PLUMBING SYSTEMS: WATER CLOSETS REQ'D: WATER CLOSETS PROVIDED: LAVATORIES PROVIDED:	NG: 48 SEATS = 48 OCC 1,308 SF/200 = 7 OCC 55 OCCUPANT INING RM: YE TWO EXITS PROVIDE IBC TABLE 2902
RESTAURANT FIXED SEATING COMMERCIAL KITCHEN: TOTAL: TWO EXITS REQUIRED FROM DI PLUMBING SYSTEMS: WATER CLOSETS REQ'D: WATER CLOSETS PROVIDED: LAVATORIES REQ'D: LAVATORIES PROVIDED: SERVICE SINK REQ'D: SERVICE SINK PROVIDED	NG: 48 SEATS = 48 OCC 1,308 SF/200 = 7 OCC 55 OCCUPANT INING RM: YE TWO EXITS PROVIDE IBC TABLE 2902
RESTAURANT FIXED SEATING COMMERCIAL KITCHEN: TOTAL: TWO EXITS REQUIRED FROM DI PLUMBING SYSTEMS: WATER CLOSETS REQ'D: WATER CLOSETS PROVIDED: LAVATORIES REQ'D: LAVATORIES PROVIDED: SERVICE SINK REQ'D:	NG: 48 SEATS = 48 OCC 1,308 SF/200 = 7 OCC 55 OCCUPANT INING RM: YE TWO EXITS PROVIDE IBC TABLE 2902
RESTAURANT FIXED SEATING COMMERCIAL KITCHEN: TOTAL: TWO EXITS REQUIRED FROM DI PLUMBING SYSTEMS: WATER CLOSETS REQ'D: WATER CLOSETS PROVIDED: LAVATORIES REQ'D: LAVATORIES PROVIDED: SERVICE SINK REQ'D: SERVICE SINK PROVIDED DRINKING FOUNTAIN REQ'D:	1,308 SF/200 = 7 OCC 55 OCCUPANT INING RM: YE TWO EXITS PROVIDE IBC TABLE 2902

Albuquerque
Building & Safety

OCT 1 6 2006


I.B.C.

Plan Check Section

TRAFFIC CIRCULATION LAYOUT APPROVED

OCT 1 2 2006

LAND DEVELOPMENT SECTION

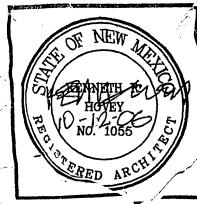

Biscuits Restaurant

Popeyes Chicken & Biscuits

KEN HOVEY, ARCHITCG

JOB NO: 0612


DATE: 20 JUNE 2006

REVISIONS

24 SEPTEMBER

11 OCTOBER 2

C.1

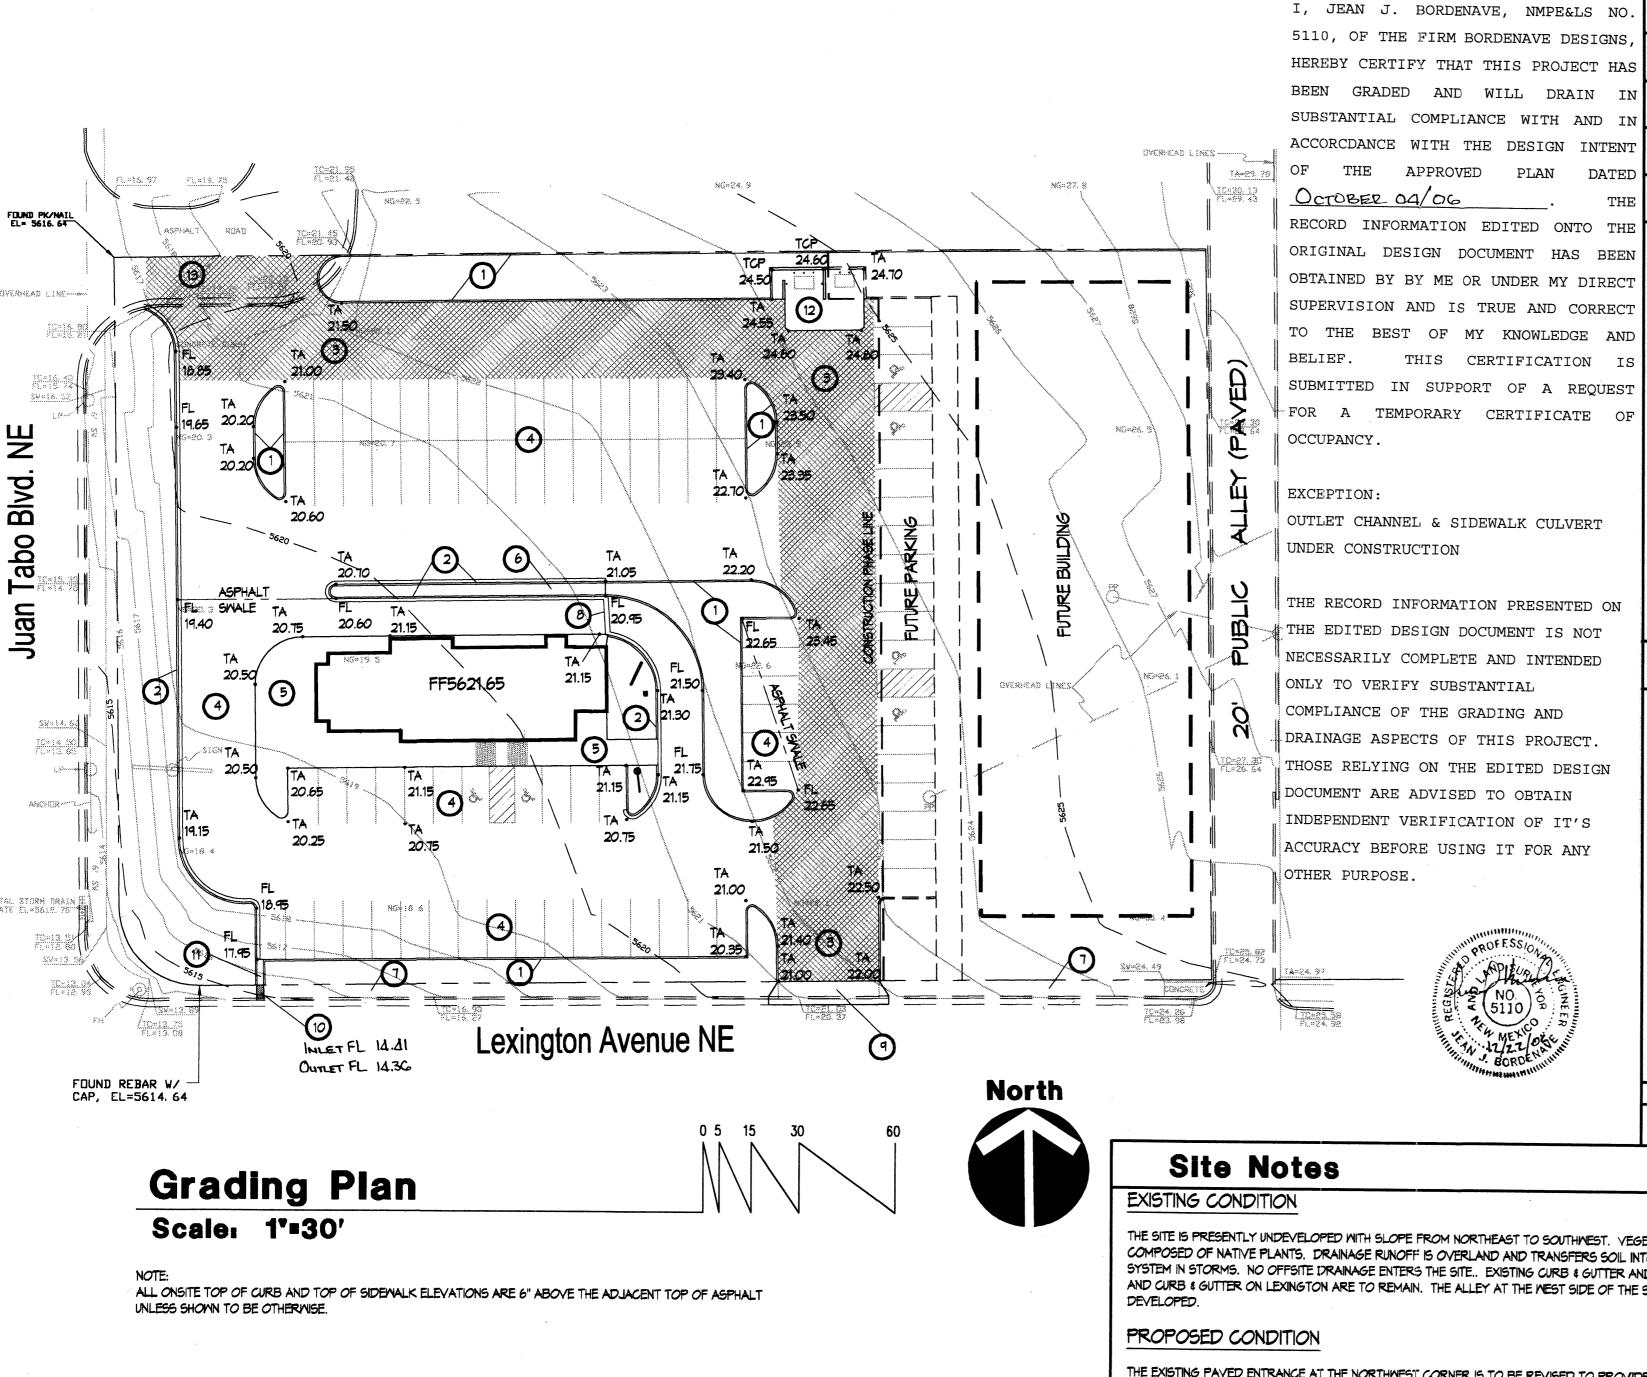

Legal Description Vicinity Map No. H-22 TRACT 1-A, BLOCK 101, BRENTWOOD HILLS SUBDIVISION **Permanent Benchmark** ACS 10-H22 ELEVATION 5613.80 (NAVD88) SITE

O Keyed Notes

- 1. HEADER CURB. SEE DETAIL SHEET C.3.
- 2. CONCRETE CURB AND GUTTER. SEE DETAIL SHEET C.3.
- 3. HEAVY DUTY PAVING (CROSS HATCHED AREA). SEE DETAIL SHEET C.3.
- 4. LIGHT DUTY PAYING (PARKING & DRIVE-UP AISLE). SEE DETAIL SHEET C.3.
- 5. TURNDOWN SIDEWALK, SEE DETAIL SHEET C.3.
- 6. SITE SIDEMALK. SEE DETAIL SHEET C3.
- 7. CITY SIDEMALK. SEE COA STD. DWG. 2430.
- 8. VALLEY GUTTER. SEE DETAIL SHEET C.3.
- 9. INSTALL 24' CONCRETE DRIVEPAD. SEE COA STD. DWG. 2425, SECTION D-D.
- 10. 24" SIDEMALK CULVERT. SEE COA STD. DMG. 2236.
- 11. 24" CONCRETE CHANNEL. SEE DETAIL SHEET C3.
- 12. REFUSE ENCLOSURE. SEE ARCHITECTURAL & PLUMBING FOR DETAILS.
- 13. REMOVE EXISTING CURB, GUTTER AND ASPHALT IN HATCHED AREA..

Notice to Contractor

- 1. AN EXCAVATION PERMIT WILL BE REQUIRED BEFORE BEGINNING ANY WORK WITHIN CITY RIGHT-OF-WAY.
- 2. ALL WORK WITHIN CITY RIGHT-OF-WAY SHALL BE CONSTRUCTED IN ACCORDANCE WITH THE CITY OF ALBUQUERQUE STANDARD SPECIFICATIONS FOR PUBLIC WORKS CONSTRUCTION, 1986 EDITION AS REVISED THROUGH UPDATE #7, AMENDMENT 1.
- 3. TWO MORKING DAYS PRIOR TO ANY EXCAVATION, THE CONTRACTOR MUST CONTACT THE LINE LOCATING SERVICE, NEW MEXICO ONE CALL AT 260-1990 FOR THE LOCATION OF EXISTING UTILITIES.
- 4. PRIOR TO CONSTRUCTION, THE CONTRACTOR SHALL EXCAVATE AND VERIFY THE LOCATIONS OF ALL OBSTRUCTIONS. SHOULD A CONFLICT EXIST, THE CONTRACTOR SHALL NOTIFY THE ENGINEER SO THAT THE CONFLICT CAN BE RESOLVED WITH A MINIMUM AMOUNT OF DELAY.
- 5. BACKFILL COMPACTION WITHIN THE CITY RIGHT-OF-WAY SHALL BE ACCORDING TO TRAFFIC/STREET USE.
- 6. MAINTENANCE OF THE SIDEWALK CULVERT SHALL BE THE RESPONSIBILITY OF THE OWNER OF THE PORPERTY BEING SERVED.
- 7. WORK ON ARTERIAL STREETS SHALL BE PERFORMED ON A 24-HOUR BASIS.

APPROVAL NAME

SITE

FEMA FIRM Panel No. 329

ZONE X

CITY OF ALBUQUERQUE

Onsite Grading Notes


- 1. TWO (2) WORKING DAYS PRIOR TO ANY EXCAVATION, THE CONTRACTOR MUST CONTACT THE NEW MEXICO ONE CALL SYSTEM AT 260-1990 FOR LOCATION OF EXISTING
- 2. PRIOR TO CONSTRUCTION, THE CONTRACTOR SHALL EXCAVATE AND VERIFY THE HORIZONTAL AND VERTICAL LOCATION OF ALL OBSTRUCTIONS. SHOULD A CONFLICT EXIST, THE CONTRACTOR SHALL NOTIFY THE ENGINEER SO THAT THE CONFLICT CAN BE RESOLVED WITH A MINIMUM AMOUNT OF DELAY.
- 3. ALL WORK ON THIS PROJECT SHALL BE PERFORMED IN ACCORDANCE WITH ALL APPLICABLE FERDERAL, STATE AND LOCAL LANG, RULES AND REGULATIONS CONCERNING CONSTRUCTION SAFETY AND HEALTH.
- 4. ALL CONSTRUCTION WITHIN THE PUBLIC RIGHT-OF-WAY SHALL BE PERFORMED IN ACCORDANCE WITH APPLICABLE CITY OF ALBUQUERQUE STANDARDS AND PROCEDURES.

Erosion Control Notes

- . THE CONTRACTOR SHALL ENSURE THAT NO SOIL ERODES FROM THE SITE ONTO PUBLIC RIGHT-OF-WAY OR PRIVATE PROPERTY. THIS CAN BE ACHIEVED BY THE CONSTRUCTION OF SOIL BERMS OR SILT FENCES AT PROPERTY LINES AND BY WETTING SOIL TO PREVENT IT FROM BLOWING.
- 2. THE CONTRACTOR SHALL PROMPTLY CLEAN-UP ANY MATERIAL EXCAVATED WITHIN THE PUBLIC RIGHT-OF-WAY SO THAT THE EXCAVATED MATERIAL IS NOT SUSCEPTIBLE TO BEING WASHED DOWN THE STREET.
- 3. THE CONTRACTOR SHALL SECURE A "TOPSOIL DISTURBANCE PERMIT" PRIOR TO BEGINNING CONSTRUCTION.
- 4. THE SITE IS MORE THAN ONE (1) ACRE IN AREA AND A SMPPP IS REQUIRED FOR THE PROJECT.

bassal

Lege	na	•	
TBM	TEMPORARY BENCHMARK	GM	GAS MATER
FF	FINISH FLOOR	GV	GAS VALVE
FG	FINISH GRADE	LP	LIGHT POLE
FL	FLOWLINE	PP	POWER POLE
TA	TOP OF ASPHALT	GM	GUY MIRE
TOP	TOP OF CONCRETE	PED	ELEC. OR TEL. PEDESTAL
TC	TOP OF CURB	RD #	ROOF DRAINAGE POINT
TP	TOP OF EARTH PAD		FEMA FLOODPLAIN BOUNDARY
TS	TOP OF SIDEMALK		DRAINAGE BASIN BOUNDARY
. TM	TOP OF WALL	•	EROSION SETBACK LINE
FH	FIRE HYDRANT	James manamananananananananananananananananan	EXISTING CONTOUR
MM	WATER METER		PROPOSED CONTOUR
MY	MATER VALVE	XXXX	EXISTING SPOT ELEVATION
MH	MANHOLE	•xx.xx	PROPOSED SPOT ELEVATION
CB	CATCH BASIN GRATE		RECORD SPOT ELEVATION

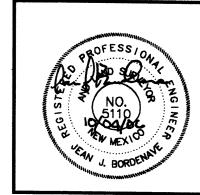

staurant **(1)** α S **Biscuit** Chicken S opeye


0612 DATE: 20 JUNE 2006 REVISIONS

DEC 2 7 2006 HYDROLOGY SECTION

THE SITE IS PRESENTLY UNDEVELOPED WITH SLOPE FROM NORTHEAST TO SOUTHWEST. VEGETATION IS QUITE SPARSE, COMPOSED OF NATIVE PLANTS. DRAINAGE RUNOFF IS OVERLAND AND TRANSFERS SOIL INTO THE ADJACENT STREET SYSTEM IN STORMS. NO OFFSITE DRAINAGE ENTERS THE SITE .. EXISTING CURB & GUTTER AND SIDEWALK ON JUAN TABO AND CURB & GUTTER ON LEXINGTON ARE TO REMAIN. THE ALLEY AT THE WEST SIDE OF THE SITE IS COMPLETELY

THE EXISTING PAVED ENTRANCE AT THE NORTHWEST CORNER IS TO BE REVISED TO PROVIDE A SMOOTHER ENTRANCE TO THE PROPOSED DEVELOPMENT. LANDSCAPED AREAS ARE PLANNED FOR THE NORTH, SOUTH AND WEST SIDES OF THE PROPERTY. THE SITE WILL DEVELOPED IN TWO OR MORE PHASES WITH PHASE ONE PROVIDING INGRESS/EGRESS FOR REFUSE AND A DEVELOPED DRAINAGE OUTFALL FACILITY. THE FUTURE BUILDING ROOF WILL DRAIN TO THE ALLEY. THE ENTIRE SITE WILL BE ROUTED ON PAVED SURFACES TO LEXINGTON AVENUE. SIDEMALK ON LEXINGTON WILL BE CONSTRUCTED WITH THIS PROJECT.

THE SITE IS LOCATED IN ZONE X PER FEMA FIRM NO. 357.

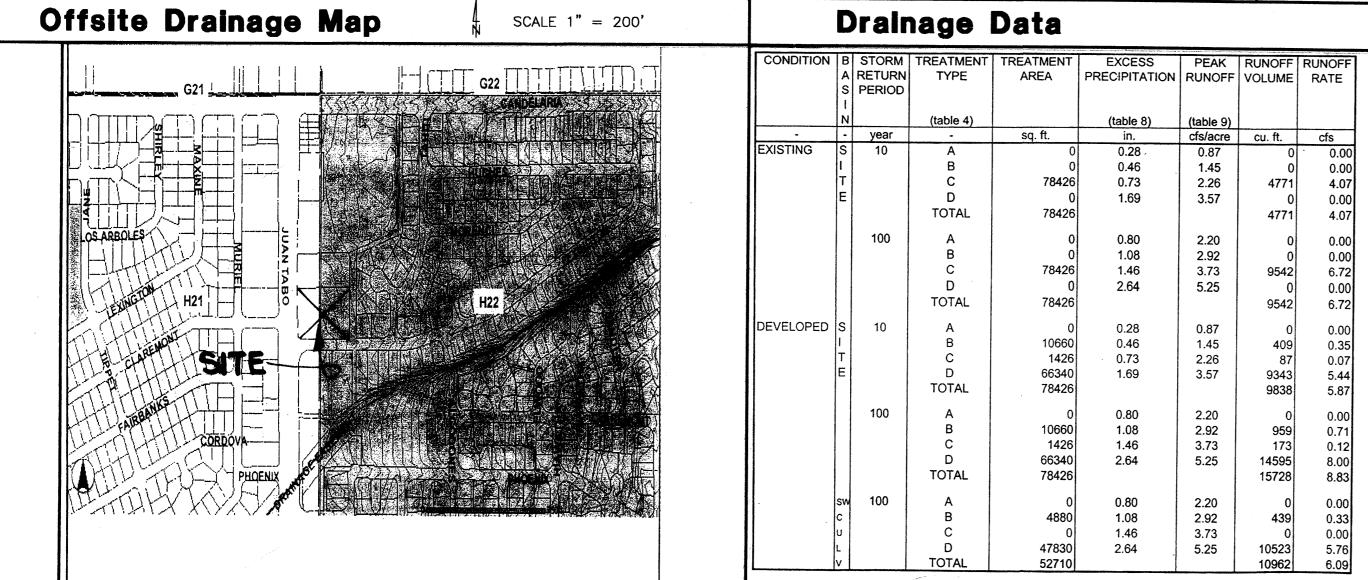


CHANNEL TO SW CULVERT BROAD CRESTED WEIR $Q=CLH^{0.67}$ where Q=6.09cfs, C=3.0, H=0.5ft

INSPECTOR

therefore L=5.66 ft, Use 6 ft

SIDEWALK CULVERT FLOWMASTER Q=6.09cfs, H=0.5ft, S=0.02ft/ft, n=0.013

therefore W=1.65 ft, Use 2 ft

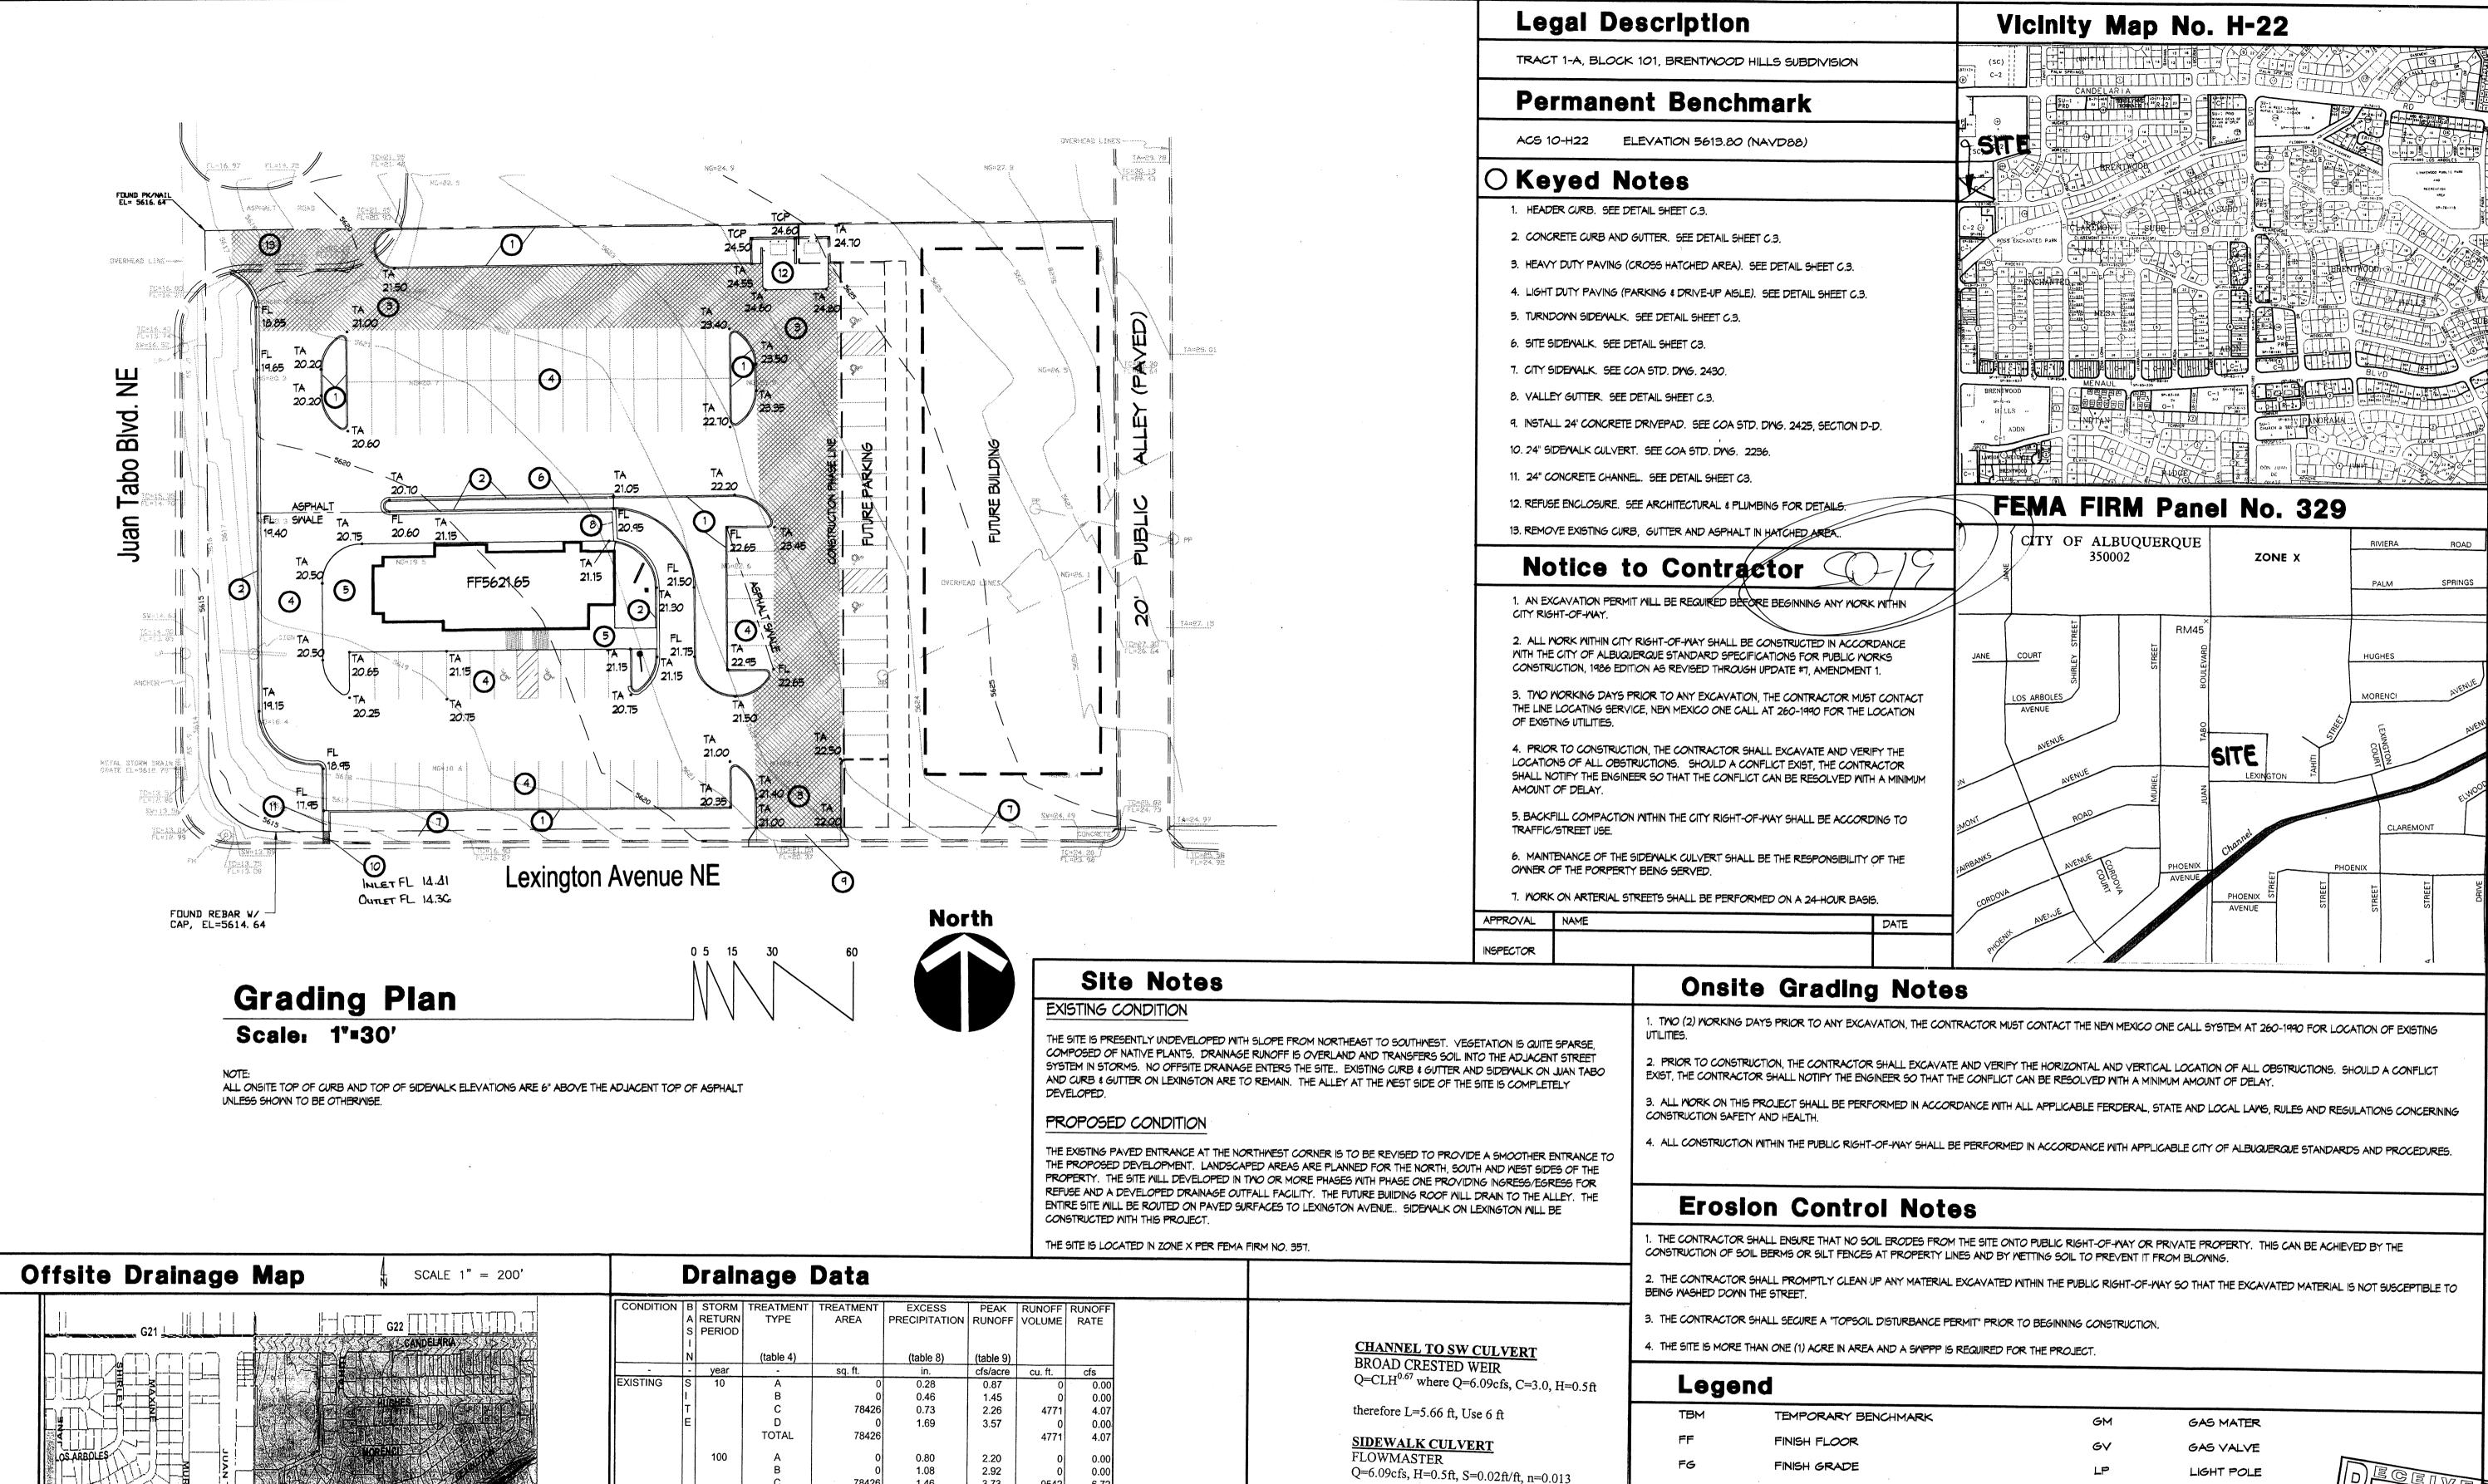

therefore W=1.65 ft, Use 2 ft

FLOWLINE

TOP OF ASPHALT

TOP OF CONCRETE

TOP OF EARTH PAD

TOP OF SIDEWALK

TOP OF CURB

TOP OF WALL

FIRE HYDRANT

WATER METER

WATER VALVE

CATCH BASIN GRATE

MANHOLE

3.73

5.25

2.26

3.57

2.92

3.73

5.25

2.20 2.92

3.73

5.25

9542

9542

9343 9838

959 173

14595

15728

439

10523

10962

78426

66340

78426

10660

1426

TOTAL

TOTAL

TOTAL

DEVELOPED S

1.46

1.08

1.08

1.46

2.64

estaurant Œ **Biscuits** Chicken opeye 0

¥

DATE: 20 JUNE 2006 REVISIONS

POWER POLE

ELEC. OR TEL. PEDESTAL

FEMA FLOODPLAIN BOUNDARY

DRAINAGE BASIN BOUNDARY

ROOF DRAINAGE POINT

EROSION SETBACK LINE

PROPOSED CONTOUR

EXISTING SPOT ELEVATION

RECORD SPOT ELEVATION


PROPOSED SPOT ELEVATION

EXISTING CONTOUR

 \times

_XX.XX

-XX.XX

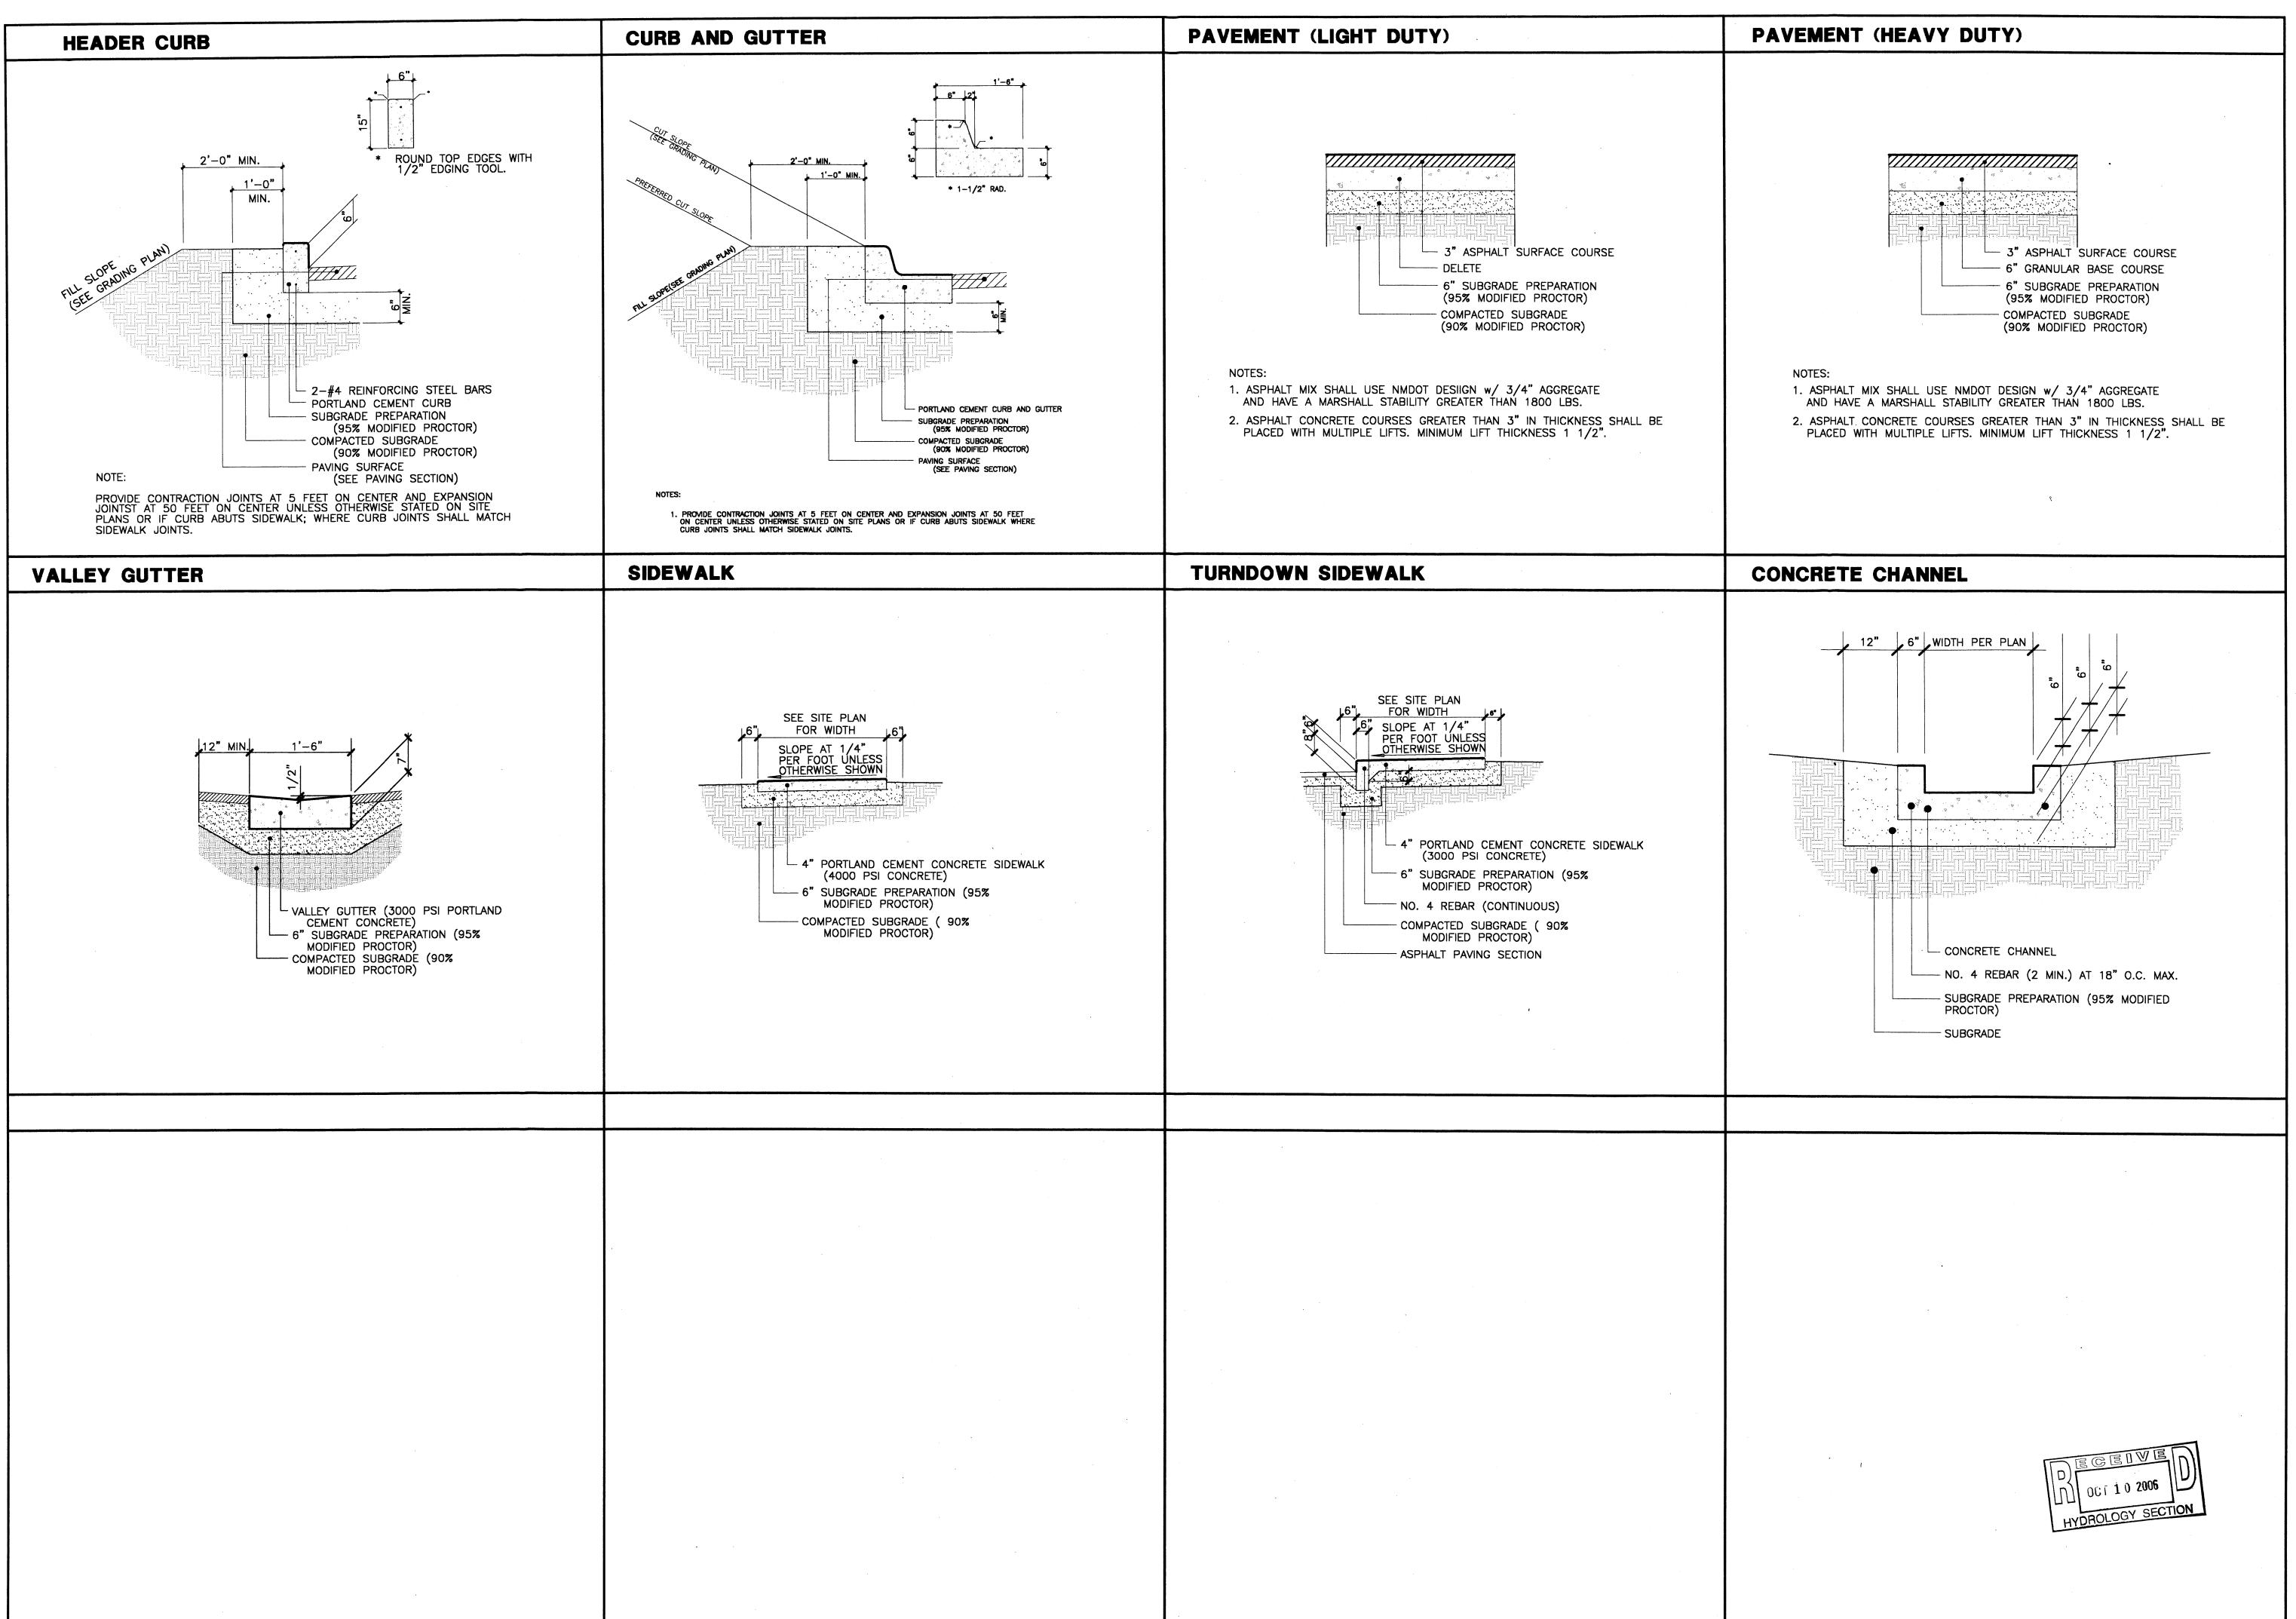



Popeyes Chicken & Biscuits Restault JUAN TABO NE AT LEXINGTON AVENUE NE, ALBUQUERQUE, NEW MEXIN

KCHITCCI MACHITCCI 505) 259-8458 * 3808 Simms Avenue SE * Albuquerque, NM * 87108

JOB NO: jjb0626

DATE: August 03, 2006

REVISIONS

SHEET NO.

ORYLINGO

RESTRICTION

RESTRICT

Vicinity Map

Site

TRAFFIC CIRCULATION LAYOUT

APPROVED

Date

H-22


Design Data


TRACT 1-A

BLOCK 101,
BRENTWOOD HILLS SUBDIVISION
ALBUQUERQUE, NEW MEXICO LEGAL DESCRIPTION: CURRENT ZONING ZONE ATLAS PAGE: UNDEVELOPED PROPOSED USE:

PHASE 1: POPEYES CHICHKEN & BISCUIT RESTAURANT PHASE 2: RETAIL SHOPS APPLICABLE BUILDING CODE IBC-2003 SEISMIC DESIGN CATAGORY: TYPE OF CONSTRUCTION: FIRE SPRINKLERED: NUMBER OF STORIES: 2,532 SQ. FT. TOTAL BUILDING AREA: OCCUPANCY GROUP: GROUP A-2 IBC TABLE 1004.1.2 OCCUPANT LOAD: RESTAURANT FIXED SEATING: 48 SEATS = 48 OCC.1,308 SF/200 = 7 OCC.COMMERCIAL KITCHEN: TOTAL: 55 OCCUPANTS TWO EXITS REQUIRED FROM DINING RM: TWO EXITS PROVIDED IBC TABLE 2902.1 PLUMBING SYSTEMS: WATER CLOSETS REQ'D: WATER CLOSETS PROVIDED: LAVATORIES REQ'D: LAVATORIES PROVIDED: SERVICE SINK REQ'D: SERVICE SINK PROVIDED DRINKING FOUNTAIN REQ'D: COMPLIMENTARY WATER SERVICE PROVIDED REQUIRED OFF-STREET PARKING: 12 SPACES 48 SEATS/4 =33 SPACES OFF-STREET PARKING PROVIDED:

TWO HC SPACES; ONE DESIGNATED VAN ACCESSIBLE TWO MOTORCYCLE SPACES

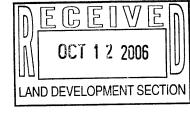

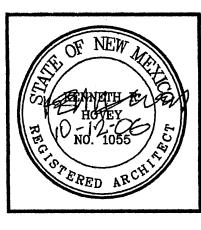

Popeyes Chicken & Biscuits Restaurant

COS) 259-6450 * 3808 Simms Avenue SE * Albuquerque, NM * 87108

JOB NO: 0612


DATE: 20 JUNE 2006


REVISIONS

24 SEPTEMBER 2006

11 OCTOBER 2006

SHEET NO.

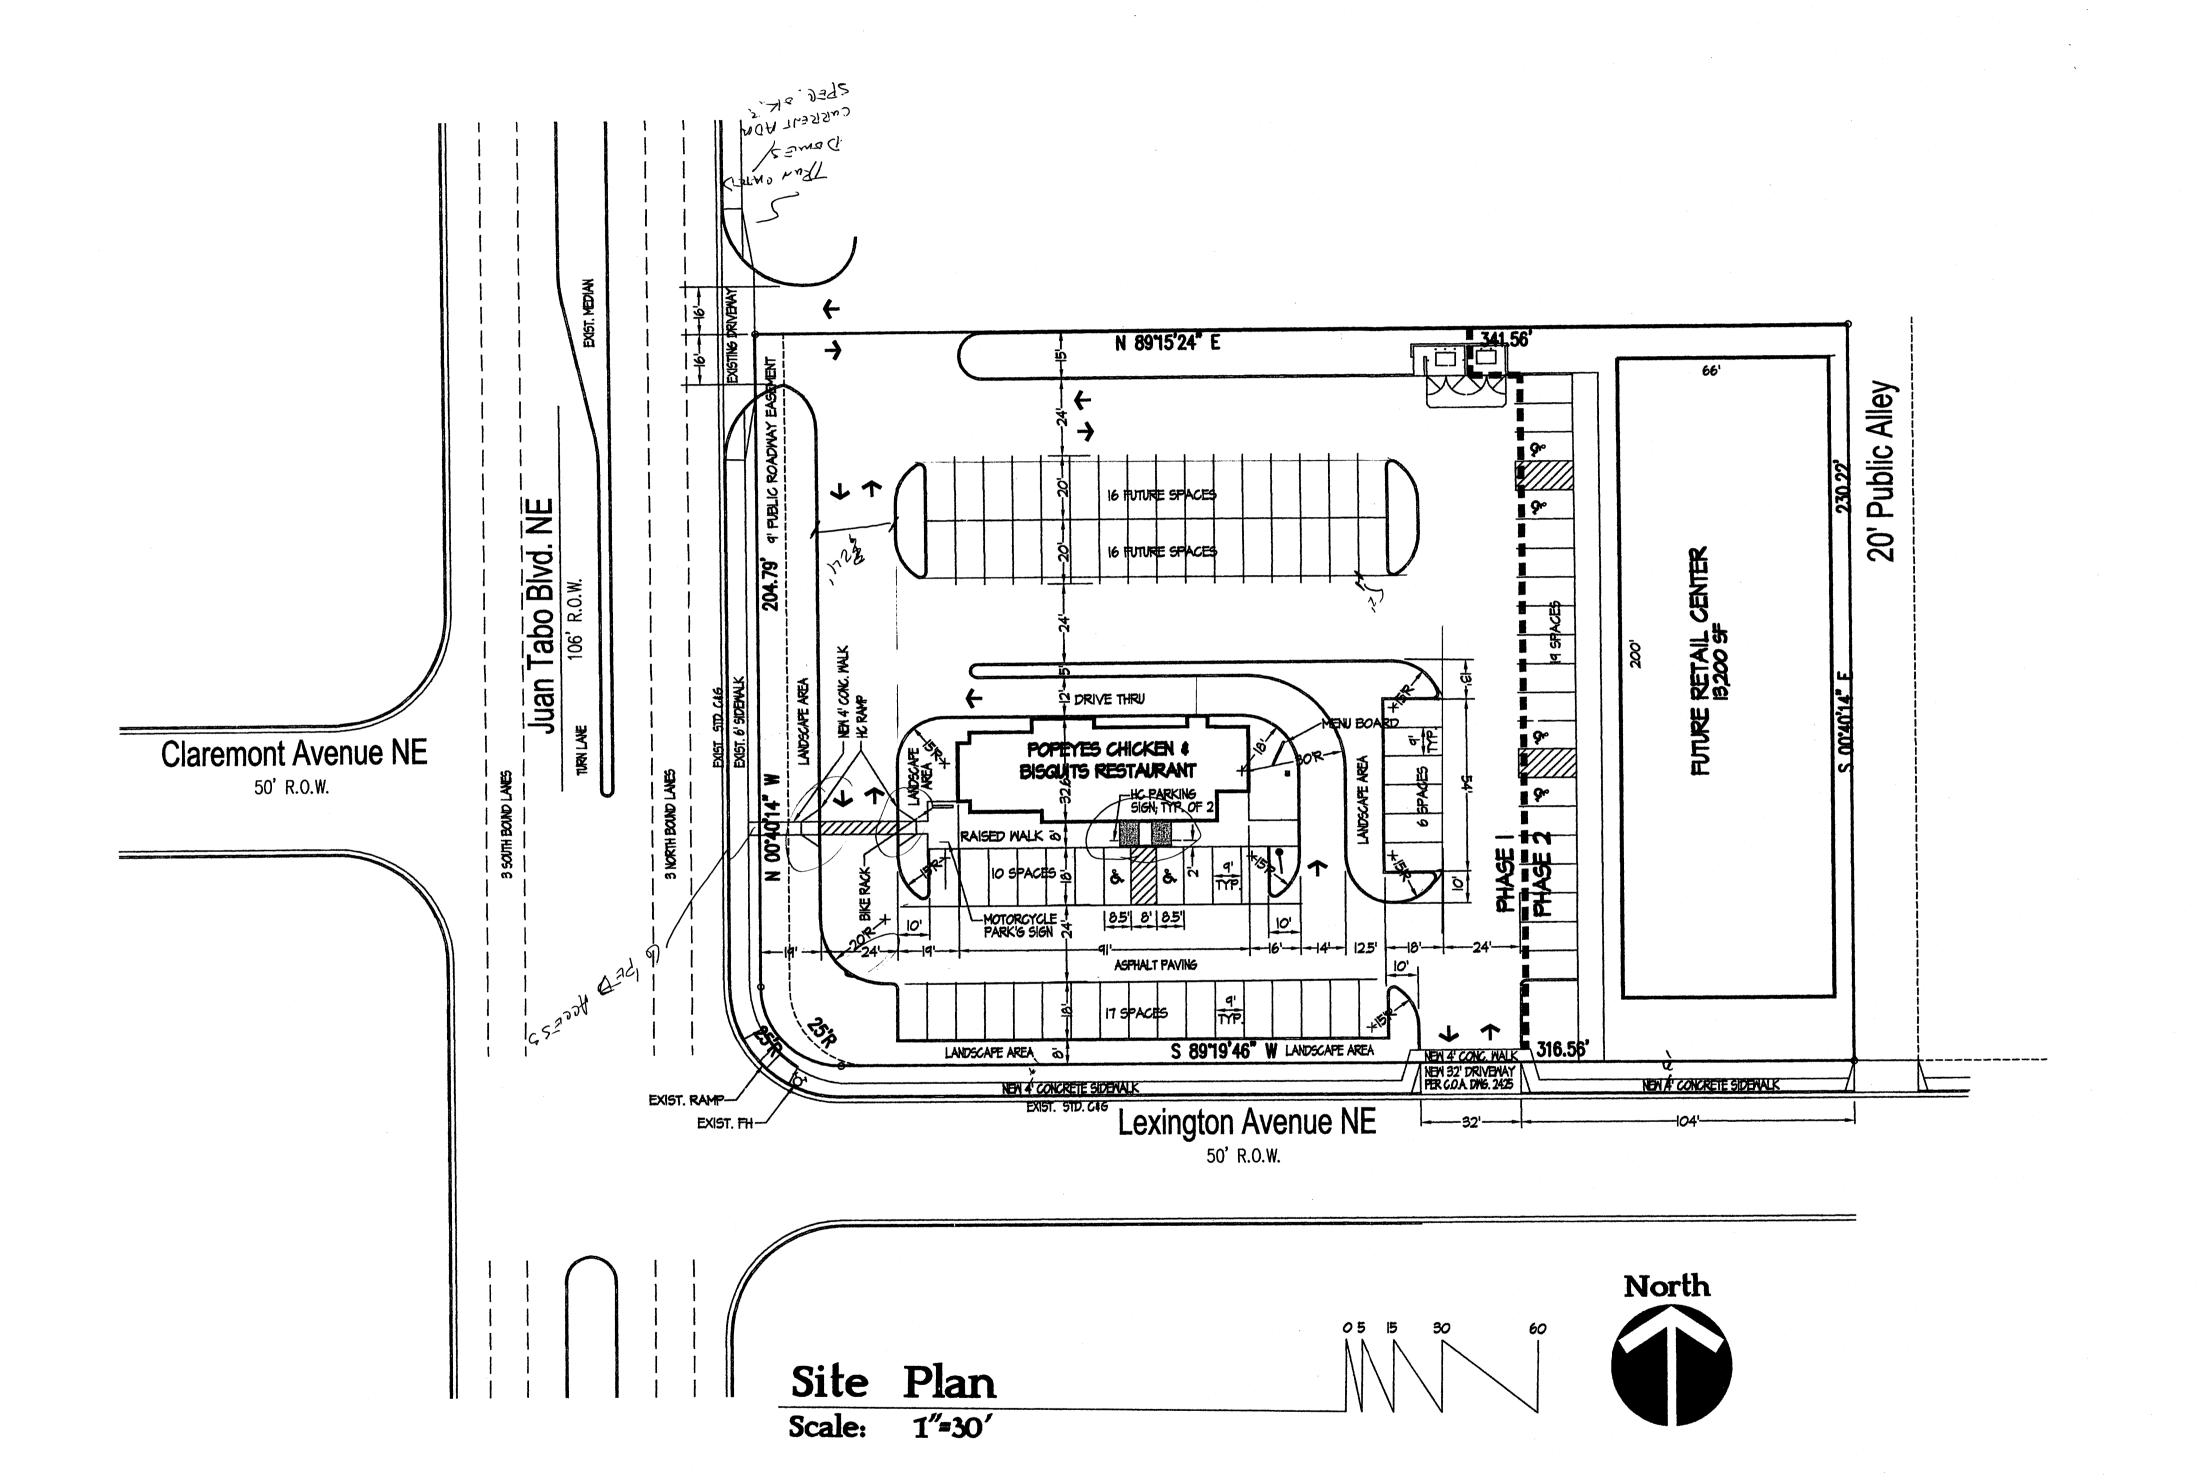

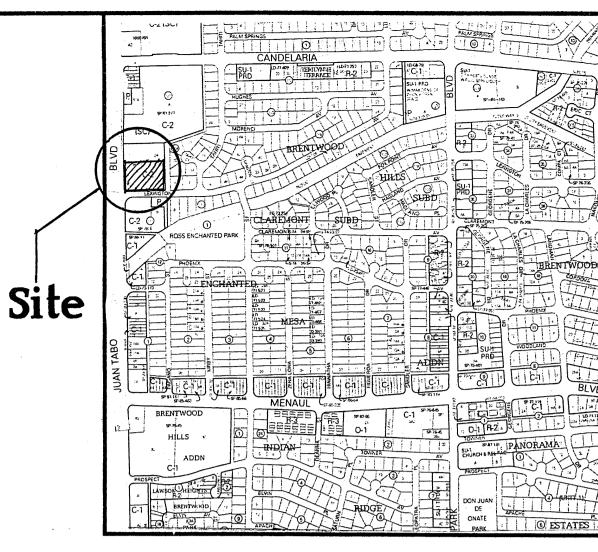

Vicinity Map


H-22

Design Data

Design D	aia
LEGAL DESCRIPTION:	TRACT 1
	BLOCK 1
	BRENTWOOD HILLS SUBDIVISE ALBUQUERQUE, NEW MEX
	ALBOQUERQUE, NEW MEX
CURRENT ZONING:	<u>C</u>
ZONE ATLAS PAGE:	H-22
APPLICABLE BUILDING CODE:	
THE PERSON OF TH	100 20
SEISMIC DESIGN CATAGORY:	
WIND DESIGN SPEED (3-SECO	ND GUST): 90 M
EXPOSURE:	
TYPE OF CONSTRUCTION:	V
EIDE CODINIZIEDED.	
FIRE SPRINKLERED:	<u> </u>
NUMBER OF STORIES:	Of
TOTAL BUILDING AREA:	2,532 SQ. F
TOTAL BOILDING FACES.	Z,302 3W. 1
OCCUPANCY GROUP:	GROUP A-
ODDUDANT LOAD	
OCCUPANT LOAD:	IBC TABLE 1004.1
RESTAURANT FIXED SEATIN COMMERCIAL KITCHEN:	IG: $48 \text{ SEATS} = 48 \text{ OC}$ 1,308 SF/200 = 7 OC
TOTAL:	55 OCCUPAN
DNO EVITO DECLIDED EDOM DIN	
TWO EXITS REQUIRED FROM DIN	NING RM: YE TWO EXITS PROVIDE
DI LIMBINO COSTELIO	
PLUMBING SYSTEMS:	IBC TABLE 2902
WATER CLOSETS REQ'D: WATER CLOSETS PROVIDED:	
LAVATORIES REQ'D:	
LAVATORIES PROVIDED:	
SERVICE SINK REQ'D: SERVICE SINK PROVIDED	
DRINKING FOUNTAIN REQ'D:	
COMPLIMENTARY WATER SER	VICE PROVIDED
REQUIRED OFF-STREET PARKIN	**************************************
48 SEATS/4 =	12 SPACE


12 SPACES 33 OFF-STREET PARKING PROVIDED:

TWO HC SPACES ALL DESIGNATED VAN ACCESSIBLE
TWO MOTORCYCLE SPACES Cone's van accessible

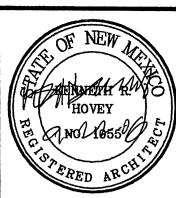

Biscuits

DATE: 20 JUNE 2006 24 SEPTEMBER 2006

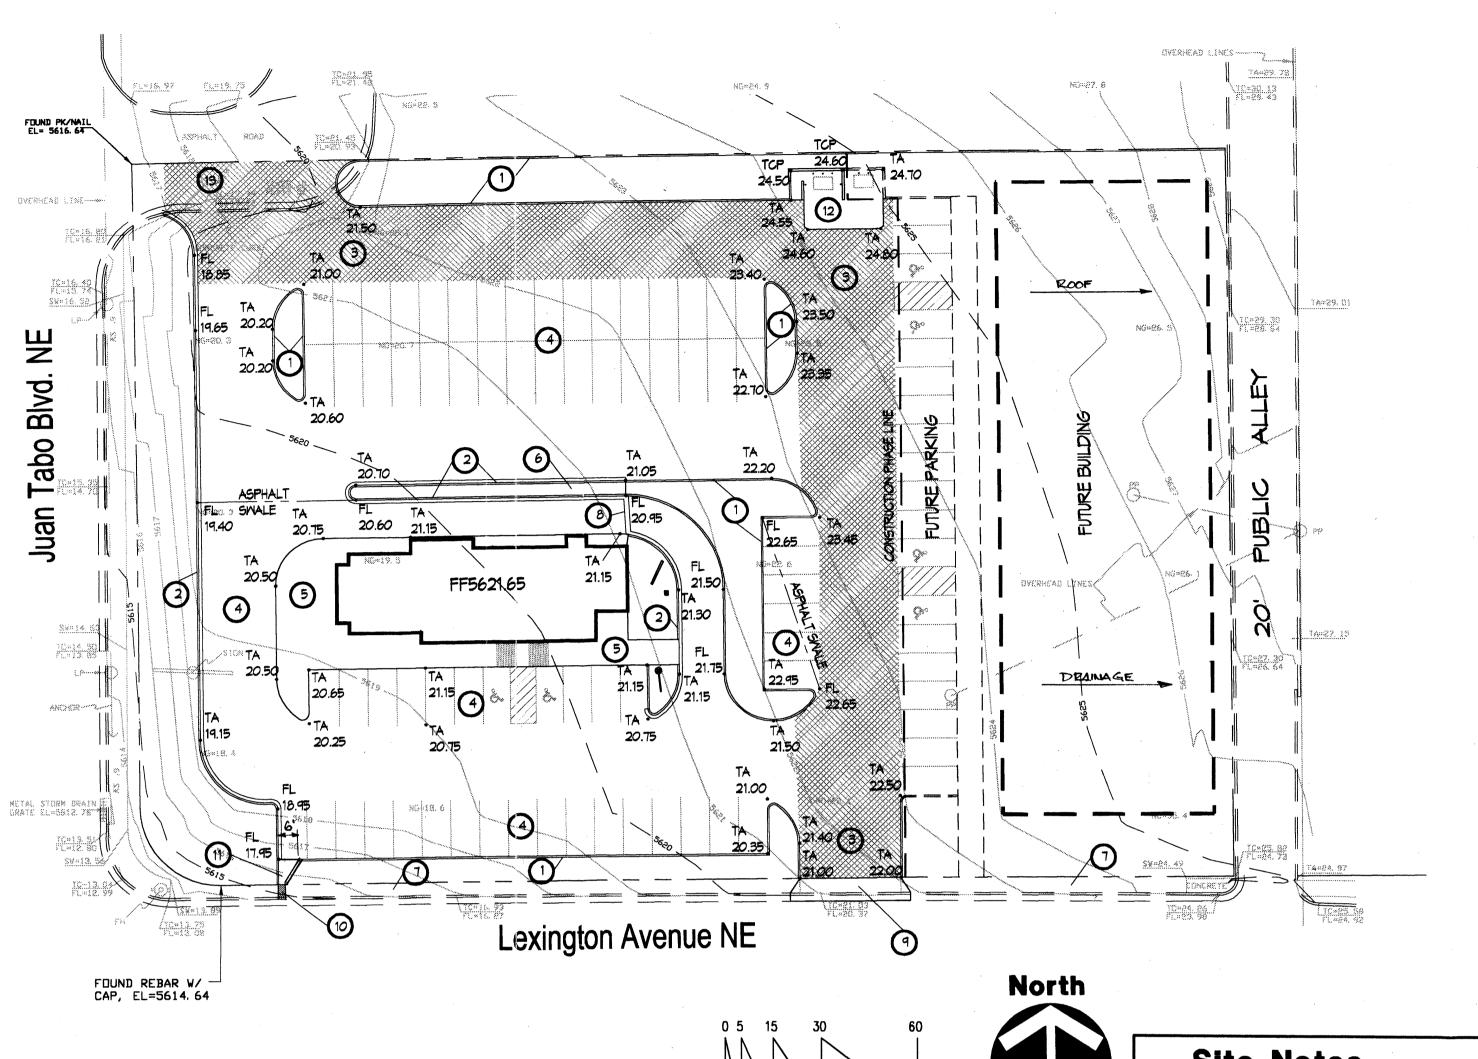

Drainage Data

TOTAL

TOTAL

TOTAL

TOTAL

A RETURN S PERIOD

100

DEVELOPED S

Legal Description Vicinity Map No. H-22 TRACT 1-A, BLOCK 101, BRENTWOOD HILLS SUBDIVISION Permanent Benchmark SITE ACS 10-H22 ELEVATION 5613.80 (NAVD88) O Keyed Notes 1. HEADER CURB. SEE DETAIL SHEET C.3. 2. CONCRETE CURB AND GUTTER. SEE DETAIL SHEET C.3. 3. HEAVY DUTY PAVING (MAIN AISLES ONLY). SEE DETAIL SHEET C.3. 4. LIGHT DUTY PAVING (PARKING & DRIVE-UP AISLE). SEE DETAIL SHEET C.3. 5. TURNDOMN SIDEMALK. SEE DETAIL SHEET C.3. 6. SITE SIDEWALK. SEE DETAIL SHEET C3. 7. CITY SIDEMALK. SEE COA STD. DWG. 2430. 8. VALLEY GUTTER. SEE DETAIL SHEET C.3. 9. INSTALL 24' CONCRETE DRIVEPAD. SEE COA STD. DWG. 2425, SECTION D-D. 10. 24" SIDEWALK CULVERT. SEE COA STD. DMG. 2236. FEMA FIRM Panel No. 357 11. CONCRETE CHANNEL. SEE DETAIL SHEET C3. CITY OF ALBUQUERQUE 12. REFUSE ENCLOSURE. SEE ARCHITECTURAL & PLUMBING FOR DETAILS. ZONE X 13. REMOVE EXISTING CURB, GUTTER AND ASPHALT IN HATCHED AREA. INSTALL HEAVY Notice to Contractor 5019 1. AN EXCAVATION PERMIT WILL BE REQUIRED BEFORE BEGINNING ANY WORK WITHIN CITY RIGHT-OF-WAY.

LOS ARBOLE

Grading Plan

Scale: 1"=30'

Offsite Drainage Map

ALL ONSITE TOP OF CURB AND TOP OF SIDEMALK ELEVATIONS ARE 6" ABOVE THE ADJACENT TOP OF ASPHALT UNLESS SHOWN TO BE OTHERWISE.

Site Notes

EXISTING CONDITION

THE SITE IS PRESENTLY UNDEVELOPED WITH SLOPE FROM NORTHEAST TO SOUTHWEST. VEGETATION IS QUITE SPARSE, COMPOSED OF NATIVE PLANTS. DRAINAGE RUNOFF IS OVERLAND AND TRANSFERS SOIL INTO THE ADJACENT STREET SYSTEM IN STORMS.

PROPOSED CONDITION

EXCESS PEAK RUNOFF RUNOFF PRECIPITATION RUNOFF VOLUME RATE

1.45

2.26

3.57

2.20

2.92 3.73

5.25

0.87 1.45 2.26 3.57

2.20 2.92

3.73

5.25

2.20 2.92

3.73

5.25

0.73

1.69

2.64

66340

66340

78426

47830

cfs/acre cu. ft. cfs

4771

4771

9542

9542

9343 9838

173

14595

15728

439

10523

THE EXISTING PAVED ENTRANCE AT THE NORTHWEST CORNER IS TO BE REVISED TO PROVIDE A SMOOTHER ENTRANCE TO THE PROPOSED DEVELOPMENT. LANDSCAPED AREAS ARE PLANNED FOR THE NORTH, SOUTH AND WEST SIDES OF THE PROPERTY. THE SITE WILL DEVELOPED IN TWO OR MORE PHASES WITH PHASE ONE PROVIDING INGRESS/EGRESS FOR REFUSE AND A DEVELOPED DRAINAGE OUTFALL FACILITY. THE EXISTING PUBLIC ALLEY IS DEVELOPED AND THE FUTURE BUILDING ROOF WILL DRAIN TO THE ALLEY. THE ENTIRE SITE WILL BE ROUTED ON PAVED SURFACES TO LEXINGTON

CHANNEL TO SW CULVERT BROAD CRESTED WEIR

therefore L=5.66 ft, Use 6 ft

SIDEWALK CULVERT

therefore W=1.65 ft, Use 2 ft

FLOWMASTER

Q=CLH^{0.67} where Q=6.09cfs, C=3.0, H=0.5ft

Q=6.09cfs, H=0.5ft, S=0.02ft/ft, n=0.013

THE SITE IS LOCATED IN ZONE X PER FEMA FIRM NO. 357.

Onsite Grading Notes

. TWO (2) WORKING DAYS PRIOR TO ANY EXCAVATION, THE CONTRACTOR MUST CONTACT THE NEW MEXICO ONE CALL SYSTEM AT 260-1990 FOR LOCATION OF EXISTING

2. PRIOR TO CONSTRUCTION, THE CONTRACTOR SHALL EXCAVATE AND VERIFY THE HORIZONTAL AND VERTICAL LOCATION OF ALL OBSTRUCTIONS. SHOULD A CONFLICT EXIST, THE CONTRACTOR SHALL NOTIFY THE ENGINEER SO THAT THE CONFLICT CAN BE RESOLVED WITH A MINIMUM AMOUNT OF DELAY.

3. ALL WORK ON THIS PROJECT SHALL BE PERFORMED IN ACCORDANCE WITH ALL APPLICABLE FERDERAL, STATE AND LOCAL LAWS, RULES AND REGULATIONS CONCERNING CONSTRUCTION SAFETY AND HEALTH.

4. ALL CONSTRUCTION WITHIN THE PUBLIC RIGHT-OF-WAY SHALL BE PERFORMED IN ACCORDANCE WITH APPLICABLE CITY OF ALBUQUERQUE STANDARDS AND PROCEDURES.

Erosion Control Notes

- I. THE CONTRACTOR SHALL ENSURE THAT NO SOIL ERODES FROM THE SITE ONTO PUBLIC RIGHT-OF-WAY OR PRIVATE PROPERTY. THIS CAN BE ACHIEVED BY THE CONSTRUCTION OF SOIL BERMS OR SILT FENCES AT PROPERTY LINES AND BY WETTING SOIL TO PREVENT IT FROM BLOWING.
- 2. THE CONTRACTOR SHALL PROMPTLY CLEAN UP ANY MATERIAL EXCAVATED WITHIN THE PUBLIC RIGHT-OF-WAY SO THAT THE EXCAVATED MATERIAL IS NOT SUSCEPTIBLE TO BEING WASHED DOWN THE STREET.
- 3. THE CONTRACTOR SHALL SECURE A "TOPSOIL DISTURBANCE PERMIT" PRIOR TO BEGINNING CONSTRUCTION.
- 4. THE SITE IS MORE THAN ONE (1) ACRE IN AREA AND A SWPPP IS REQUIRED FOR THE PROJECT.

_					
l	-8	g	0	n	d

2. ALL WORK ON THIS PROJECT SHALL BE PERFORMED IN ACCORDANCE WITH

CONSTRUCTION SAFETY AND HEALTH.

OF EXISTING UTILITIES.

AMOUNT OF DELAY.

APPLICABLE FEDERAL, STATE AND LOCAL LAWS, RULES AND REGULATIONS CONCERNING

3. TWO WORKING DAYS PRIOR TO ANY EXCAVATION, THE CONTRACTOR MUST CONTACT THE LINE LOCATING SERVICE, NEW MEXICO ONE CALL AT 260-1990 FOR THE LOCATION

4. PRIOR TO CONSTRUCTION, THE CONTRACTOR SHALL EXCAVATE AND VERIFY THE LOCATIONS OF ALL OBSTRUCTIONS. SHOULD A CONFLICT EXIST, THE CONTRACTOR SHALL NOTIFY THE ENGINEER SO THAT THE CONFLICT CAN BE RESOLVED WITH A MINIMUM

5. BACKFILL COMPACTION WITHIN THE CITY RIGHT-OF-WAY SHALL BE ACCORDING TO

THESE FACILITIES

6. MAINTENANCE OF THE SIDEMALK GULVERT SHALL BE THE RESPONSIBILITY OF THE

7. WORK ON ARTERIAL STREETS SHALL BE PERFORMED ON A 24-HOUR BASIS.

Lege	nd	I	
TBM	TEMPORARY BENCHMARK	GM	GAS MATER
FF	FINISH FLOOR	GV	GAS VALVE
FG	FINISH GRADE	LP	LIGHT POLE DEGEOVE
FL	FLONLINE	PP	POWER POLE SEP 2 6 2006
TA	TOP OF ASPHALT	GM	GUY MIRE HYDROLOGY SECTION
TCP	TOP OF CONCRETE	PED	ELEC. OR TEL. PEDESTAL
TC	TOP OF CURB	RD /	ROOF DRAINAGE POINT
TP	TOP OF EARTH PAD		FEMA FLOODPLAIN BOUNDARY
TS	TOP OF SIDEWALK		DRAINAGE BASIN BOUNDARY
TM	TOP OF WALL	•	EROSION SETBACK LINE
FH '	FIRE HYDRANT	gain communication of	EXISTING CONTOUR
MM	MATER METER		PROPOSED CONTOUR
WY	MATER VALVE	***	EXISTING SPOT ELEVATION
MH	MANHOLE	•xx.xx	PROPOSED SPOT ELEVATION
CB	CATCH BASIN GRATE		RECORD SPOT ELEVATION


XX.XX




staurant Ö cuits Bis(6 Chicken opey

*

0612 DATE: 20 JUNE 2006

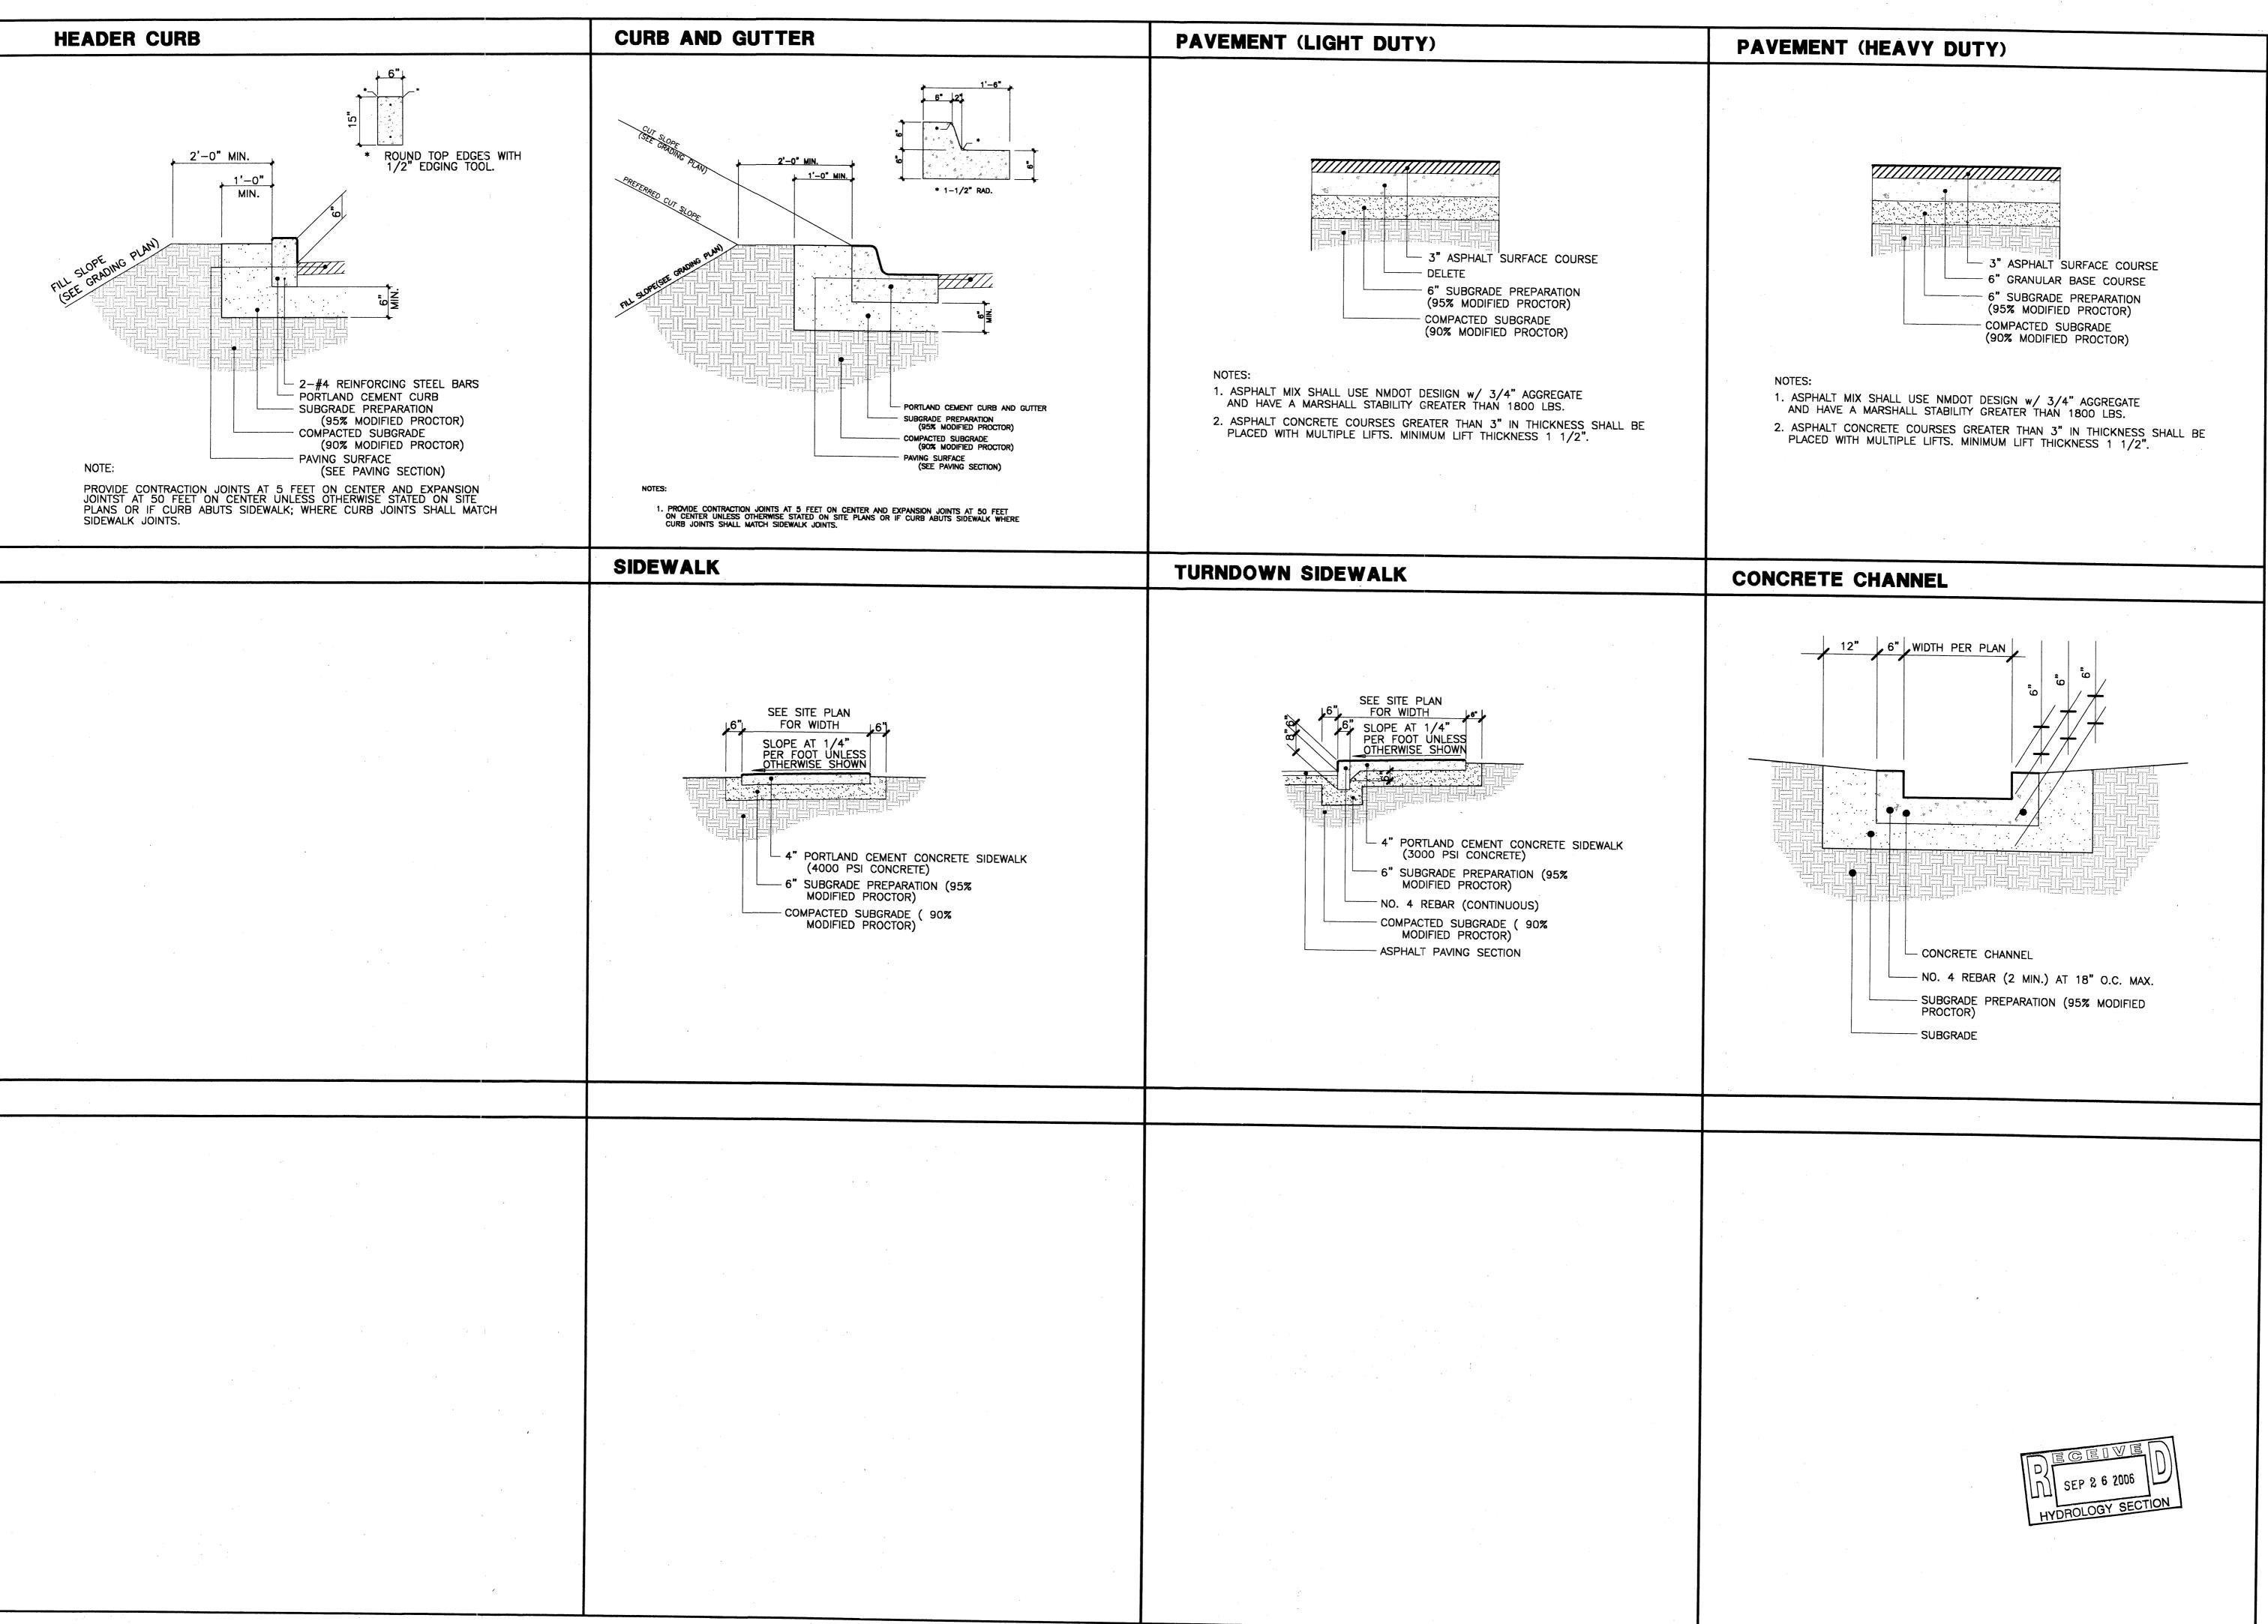

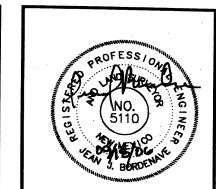

----<u>dn</u> dur GS \triangle \bigcirc ---• ----Biscl \approx Chicken eye \bigcirc

KCH HOVEY, ARCHITECT 505) 259-8458 * 3808 Simms Avenue SE * Albuquerque, NM * 87108

JOB NO): jjb0626
DATE:	August 03, 2006
	REVISIONS

SHEET NO.