

CITY OF ALBUQUERQUE

PLANNING DEPARTMENT – Development Review Services



July 8, 2014

Jeffrey G. Mortensen, P.E.
High Mesa Consulting Group
6010-B Midway Park Blvd NE
Albuquerque, NM 87109

Richard J. Berry, Mayor

RE: **Hotel Albuquerque** – 800 Rio Grande Blvd., NW
Conceptual Grading and Drainage Plan
Engineer's Stamp Date 6-20-2014 (File: J13D066)

Dear Mr. Mortensen:

The **Conceptual Grading and Drainage Plan** received 6-23-14 was submitted in order to support an amendment to an existing Site Development Plan for the Sheraton Old Town Inn Complex. The amendment to the existing Site Development Plan is to remove Tract D from the Site Plan and will only include Tracts A and B. It is noted that Tracts A, B, and D will share parking, access, cross-lot drainage, and private utilities. Since the **Conceptual Grading and Drainage Plan** is essentially the approved Drainage Management Plan from the Sheraton Old Town Drainage Master Plan (Engineer's Stamp Date 6-23-2014), this plan is also approved for DRB action.

PO Box 1293

Albuquerque

If you have any questions, you can contact me at 924-3695.

New Mexico 87103

www.cabq.gov


Sincerely,

Rita Harmon, P.E.
Senior Engineer, Planning Dept.
Development Review Services


Orig: Drainage file
c.pdf Addressee via Email, Tim Sims, Monica Ortiz

DESIGN SURVEY NOTE:

THIS IS NOT A BOUNDARY SURVEY; DATA IS SHOWN FOR ORIENTATION ONLY. THE BOUNDARY INFORMATION DEPICTED BY THIS PLAN IS BASED UPON AN BOUNDARY SURVEY PREPARED BY HIGH MESA CONSULTING GROUP, NMPS 11184, DATED 11/06/2013 (2013.002.2). THE TOPOGRAPHIC INFORMATION DEPICTED HEREON IS BASED UPON THE TOPOGRAPHIC AND UTILITY SURVEY PREPARED BY HIGH MESA CONSULTING GROUP, NMPS 11184, DATED 11/06/2013 (2013.002.2).

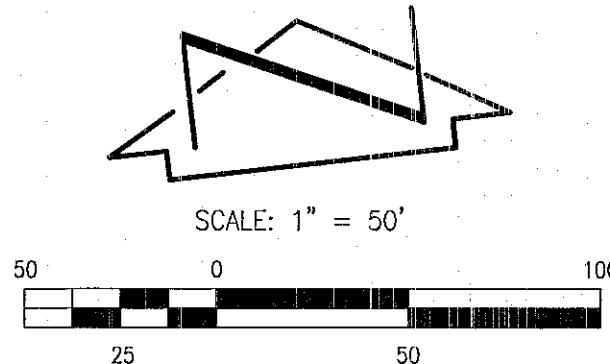

MOUNTAIN ROAD N.W.
 (60' R.O.W. PER ASC 4078 SURVEY 09-19-1986)

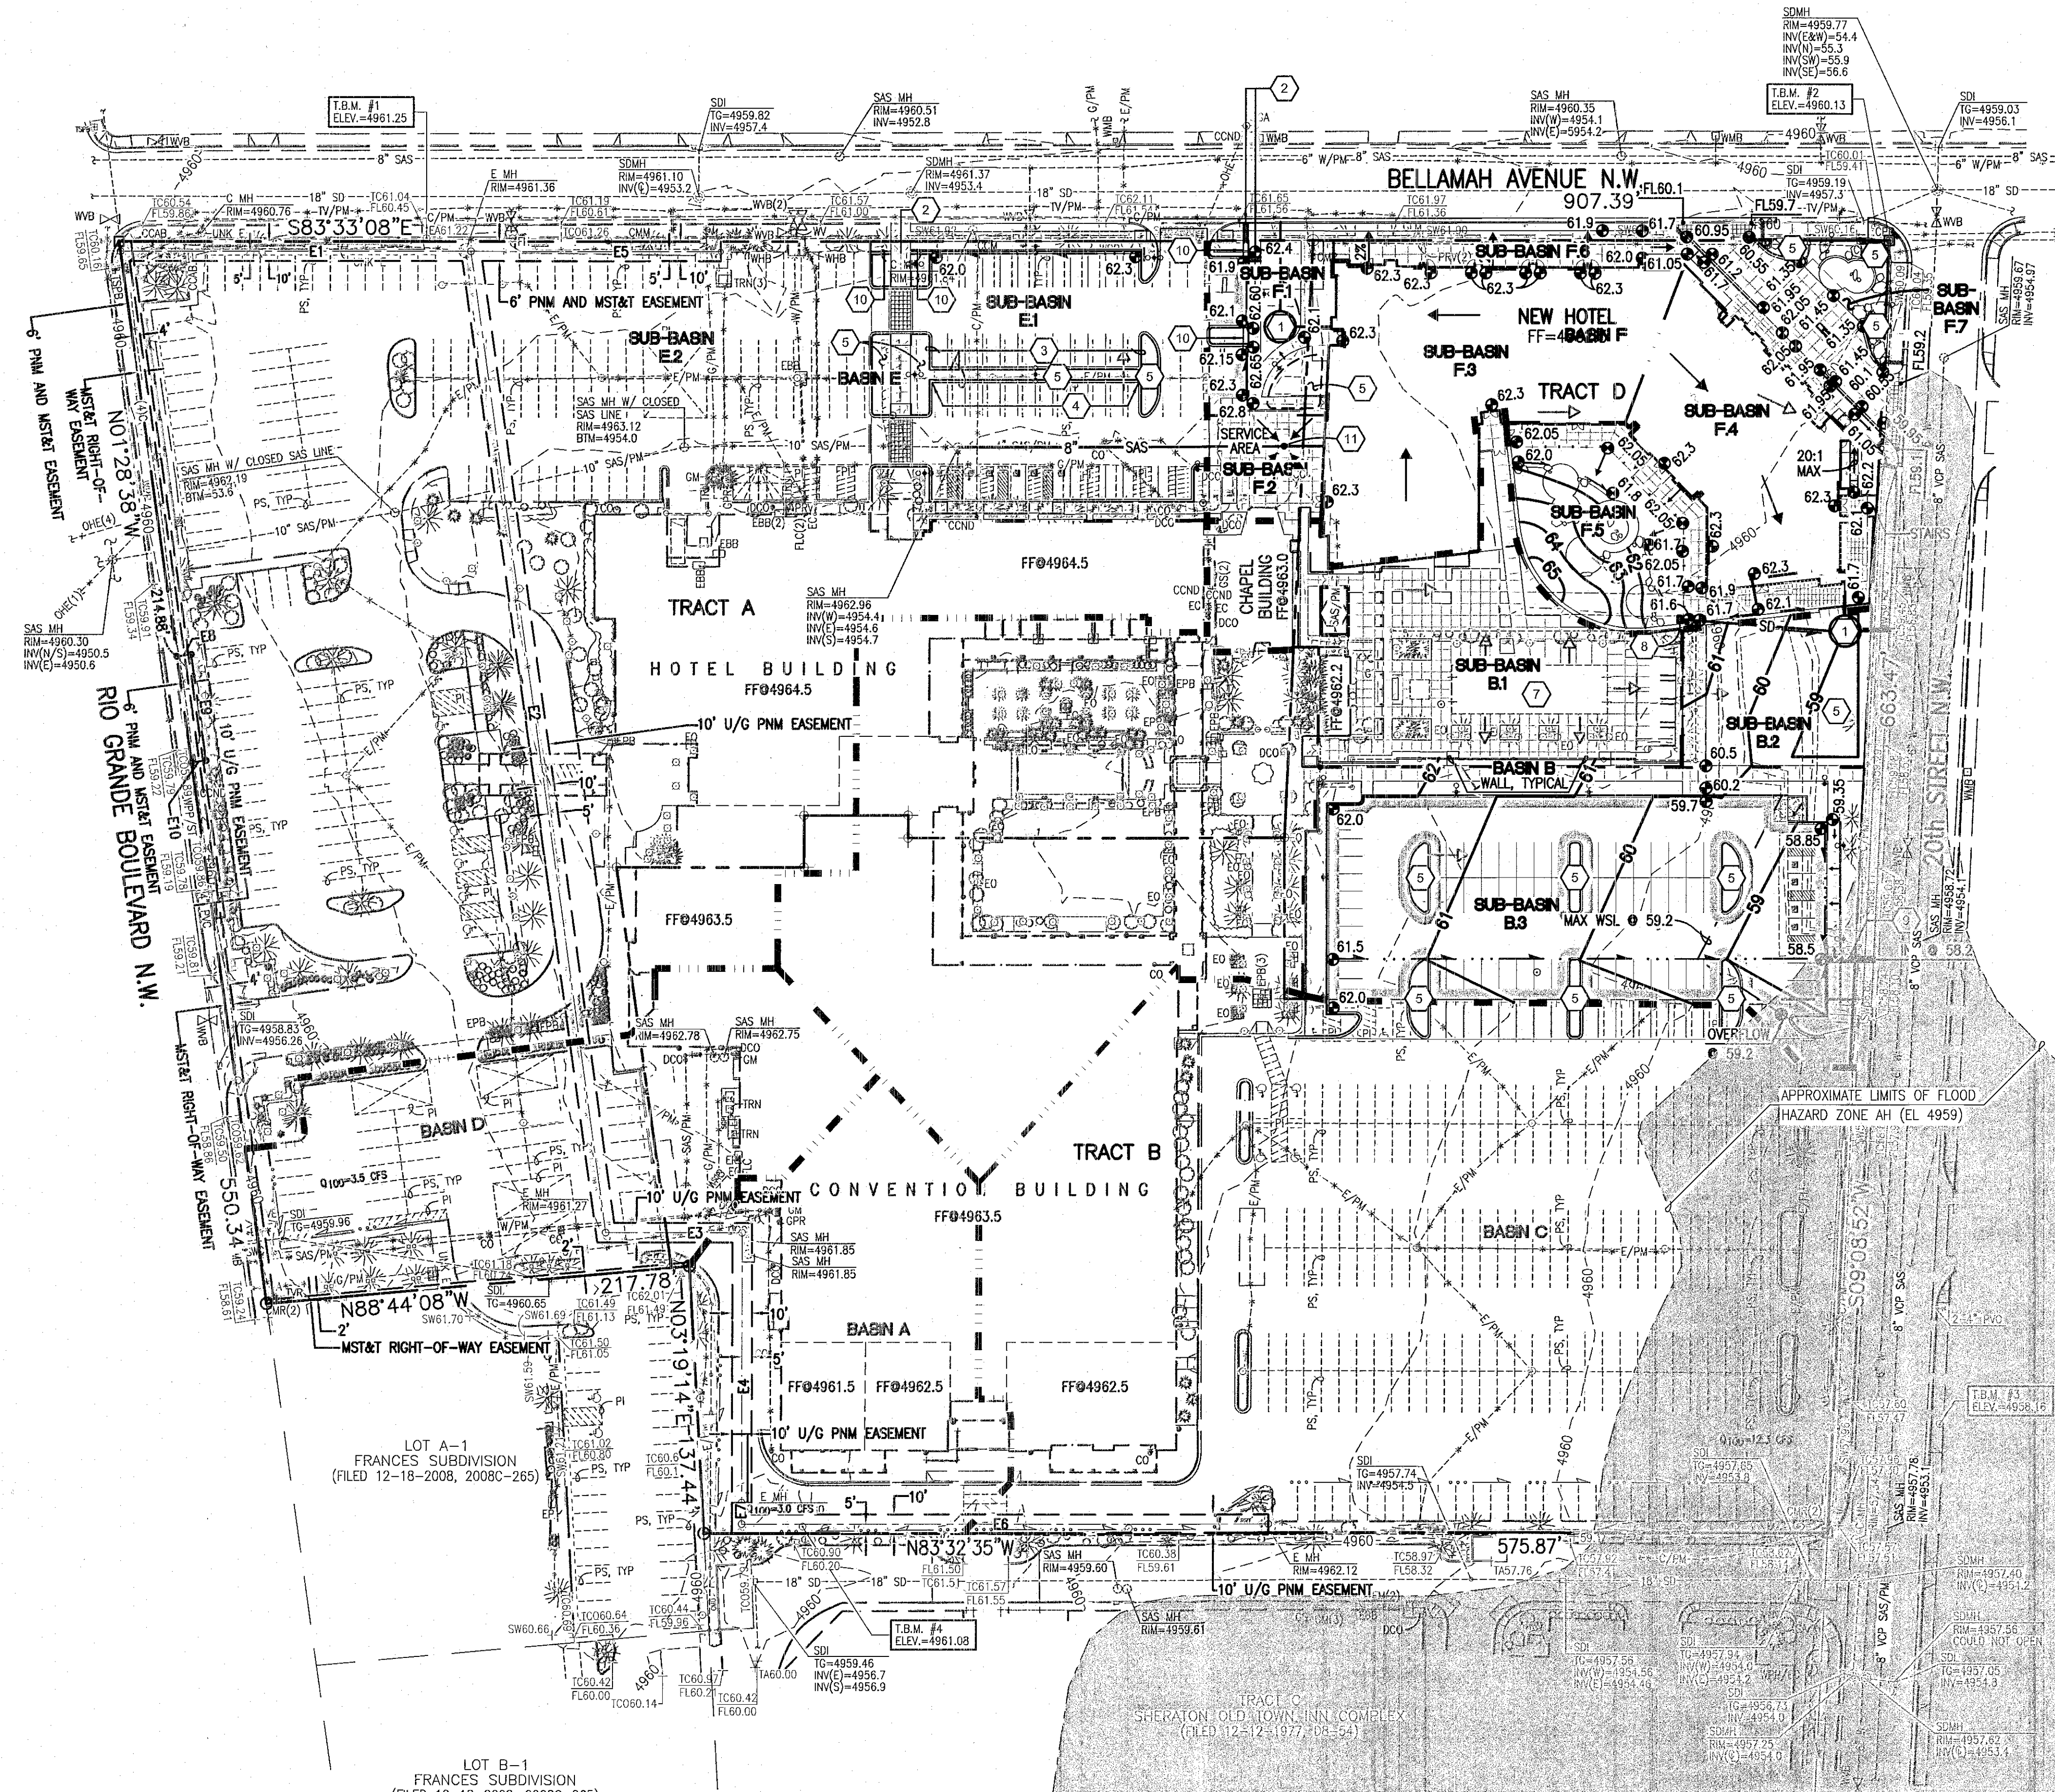


PHASING NOTES:

1. THIS PLAN SUPPORTS AN AMENDMENT TO AN EXISTING SITE DEVELOPMENT PLAN FOR BUILDING PERMIT FOR THE SHERATON OLD TOWN INN COMPLEX. THE AMENDMENT COVERS TRACTS A AND B.
2. TRACT D, SITE OF A PROPOSED NEW HOTEL DEVELOPMENT, IS BEING REMOVED FROM THE PREVIOUSLY APPROVED PLAN AND ADDRESSED BY SEPARATE CONCURRENT SUBMITTAL.
3. TRACTS A, B AND D WILL SHARE PARKING, ACCESS, CROSS-LOT DRAINAGE, AND PRIVATE UTILITIES.
4. THE MODIFICATIONS TO PARKING, ACCESS, DRAINAGE AND UTILITIES, ALTHOUGH COVERED BY SEPARATE SUBMITTALS, WILL BE CONSTRUCTED CONCURRENTLY.
5. THIS SUBMITTAL IS SUPPORTED BY A DRAINAGE MANAGEMENT PLAN.

DESIGN GRADING LEGEND:

INV	INVERT
TA	TOP OF ASPHALT PAVEMENT
TC	TOP OF CURB
TG	TOP OF GRATE
+ 20.05	EXISTING SPOT ELEVATION
14.00	PROPOSED SPOT ELEVATION
4920	EXISTING FLOWLINE
20	PROPOSED FLOWLINE
	EXISTING CONTOUR
	PROPOSED CONTOUR
	EXISTING DIRECTION OF FLOW
	PROPOSED DIRECTION OF FLOW
	PROPERTY LINE
	PUBLIC EASEMENT LINE
	HIGH POINT / DIVIDE
	PROPOSED CONCRETE
	PROPOSED ASPHALT PAVING

FEDERAL EMERGENCY MANAGEMENT AGENCY

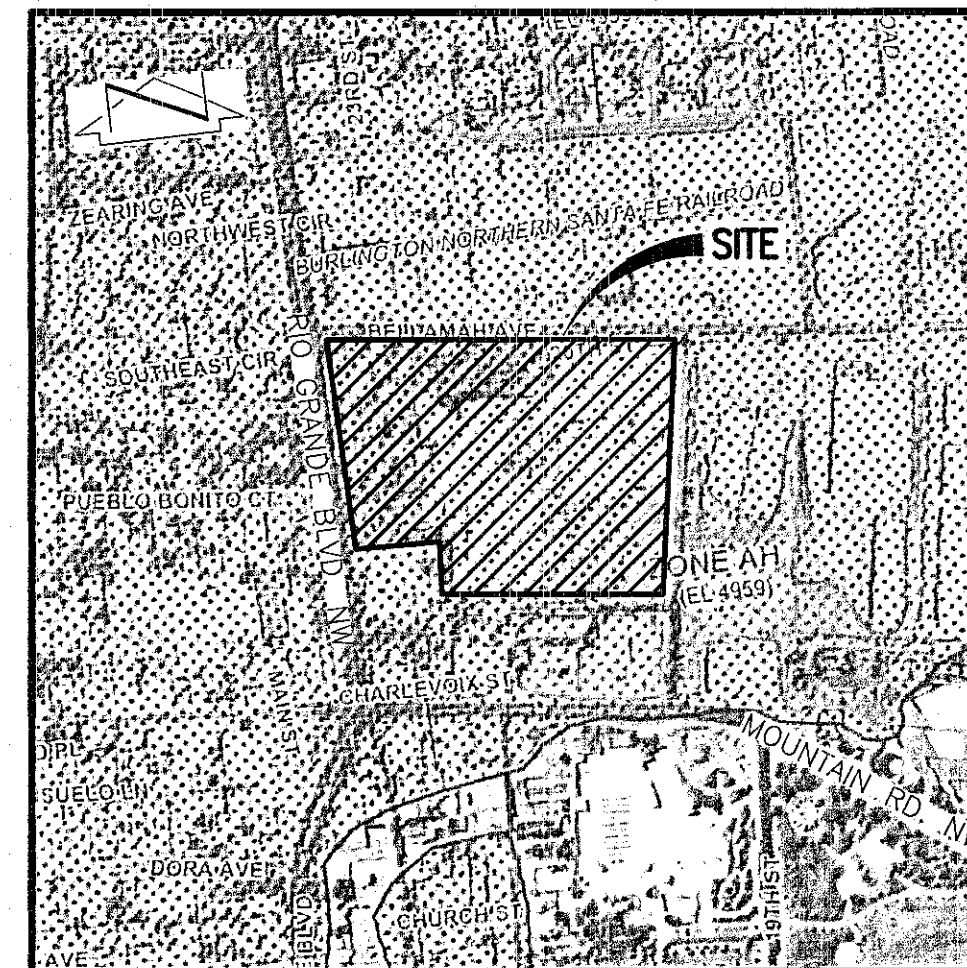

F.I.R.M. PANEL 331 of 825
 SCALE: 1" = 500' DATED 08-16-2012

CONCEPTUAL GRADING & DRAINAGE KEYED NOTES:

1. NEW CISTERN SIZED TO CONTAIN FIRST 1/2-INCH OF ROOF RUNOFF WITH OVERFLOW TO STREET VIA 4" PVC CURB PENETRATION.
2. NEW SIDEWALK CULVERT.
3. SET NEW CURB AT 6-INCHES ABOVE EXISTING TOP OF ASPHALT ELEVATION, TYPICAL.
4. PROVIDE CURB OPENINGS FOR POSITIVE DRAINAGE.
5. GRADE WATER HARVESTING AREA SIZED TO MANAGE THE FIRST FLUSH OF RUNOFF AND CONTROL RUNOFF GENERATED BY CONTRIBUTING IMPERVIOUS AREA TO THE EXTENT PRACTICABLE.
6. NEW POOL ACCESSORY BUILDING WITH FF = 4962.2.
7. EXISTING POOL NO GRADE CHANGES PROPOSED. POOL DECK RUNOFF TO BE SELF-CONTAINED VIA DISCHARGE TO LANDSCAPED AREAS OR DECK DRAINS.
8. NEW STORM INLET WITH DISCHARGE TO CISTERN.
9. NEW 4-INCH PVC CURB PENETRATION FOR CONTROLLED RELEASE OF PARKING LOT RUNOFF TO STREET.
10. NEW DRAINAGE RUNDOWN FOR POSITIVE DRAINAGE THROUGH CURBS.
11. GRATED SANITARY SEWER MANHOLE TO ACCEPT AND DRAIN RUNOFF FROM REFUSE BIN AREA.

DRAINAGE CONCEPTS:

PROPOSED FINISHED FLOOR ELEVATION IS A MINIMUM ONE-FOOT ABOVE THE CORRESPONDING DESIGNATED FLOOD PLAIN ELEVATION AS PUBLISHED BY FEMA.

DEVELOPED RUNOFF FROM THE PROPOSED NEW HOTEL AND/OR REDEVELOPED AREAS ADJACENT TO THE NEW HOTEL SHALL BE MANAGED BY A COMBINATION OF THE FOLLOWING TECHNIQUES:

- LIMITING POST DEVELOPMENT PEAK DISCHARGE FROM UNDEVELOPED PORTIONS OF SITE TO 2.75 CFS/ACRE
- REDUCING THE PEAK RATE OF DISCHARGE BY IMPROVED LAND TREATMENTS
- REDUCING THE PEAK RATE OF DISCHARGE BY DETENTION PONDING
- REDUCING THE PEAK RATE OF DISCHARGE BY CAPTURING THE FIRST 1/2-INCH OF RUNOFF IN CISTERNS
- MANAGE AND CONTROL THE FIRST FLUSH OF RUNOFF FROM ALTERED EXISTING AND NEW CONTRIBUTING IMPERVIOUS AREAS TO THE EXTENT PRACTICABLE IN ACCORDANCE WITH THE CITY OF ALBUQUERQUE DRAINAGE ORDINANCE AS REVISED EFFECTIVE MAY 12, 2014.

HIGH MESA Consulting Group

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 landscape
 planning
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ARCHITECT

Gensler

ENGINEER




PROJECT

Hotel Albuquerque
 800 Rio Grande Blvd. NW
 Albuquerque, NM 87104
 Tract D

DRB SUBMITAL
 June 24, 2014

REVISIONS

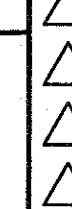

DRAWN BY J.Y.R.

REVIEWED BY J.G.M.

DATE 6.24.2014

PROJECT NO. 13-0020

DRAWING NAME

CONCEPTUAL GRADING AND DRAINAGE PLAN

SHEET NO.

SDP-3.1

OF