## CITY OF ALBUQUERQUE

PLANNING DEPARTMENT - Development Review Services



July 10, 2014

Martin J. Garcia, P.E. Anchor Engineering, LLC 1035 South Bosque Loop Bosque Farms, NM 87102 Richard J. Berry, Mayor

Re: Garcias Kitchen Food Prep & Catering

**Grading and Drainage Plan** 

Engineer's Stamp Date: not stamped (J13/D096)

Dear Mr. Garcia:

PO Box 1293

Albuquerque

www.cabq.gov

Based upon the information provided in your submittal received 6-4-14, the above referenced plan cannot be approved for Building Permit until the comments below are addressed.

- 1. All plans and calculations need to be stamped by an engineer.
- 2. Onsite flows from the existing restaurant and apartments must be accounted for. The proposed curb south of these existing structures does not allow roof runoff from these structures to drain to Pond 2.
- 3. Roof runoff from the apartments appear to drain offsite to east and then reenter the property and drain to south west, along with some amount of offsite flows. LIDAR contours support this and so this onsite/offsite flows need to be accounted for. In addition, it appears that a wall is to be built along west property boundary. How will flows from apartments reenter?
- 4. Sections thru pond on East and West property boundaries need to be shown to indicate how flows will reenter, or how overflows will be contained on site.
  - 5. It appears that Pond #2 Volume should be the total volume of both ponds #2 and #3 from the previous submittal. With a combined larger volume, the WSEL will be lower.
  - 6. While a check valve is indicated on the plans, it is not clear where the check valve will be located. Indicate location of check valve. Also indicate what construction will be done thru Work Order and the CPN #.
  - 7. Details 1/C-5 and 3/C-5 show retaining walls that need to be designed, detailed, and dimensioned.
  - 8. Pump cut sheets provided show general information but do not show where on the curve the pump will operate (which is typically shown on a system curve), nor are there supporting calculations. Please provide.

Since the disturbed area on this site exceeds 1.0 acre, an Erosion and Sediment Control (ESC) Plan, prepared by a NM PE and approved by the City's Stormwater Engineer, will be required for this site, prior to Hydrology approval of a Building Permit or Work Order.

If you have any questions, you can contact me at 924-3695.

Sincerely,

Rita Harmon, P.E.

Senior Engineer, Planning Dept. Development Review Services

Orig: Drainage file

c.pdf Addressee via Email



## City of Albuquerque

#### Planning Department

#### Development & Building Services Division DRAINAGE AND TRANSPORTATION INFORMATION SHEET

(REV 02/2013)

Project Title:	City Drainage #:			
DRB#: EPC#:	Work Order#:			
Legal Description:				
City Address:				
Engineering Firm:	Contact:			
Address:				
Phone#: Fax#:	E-mail:			
Owner:	Contact:			
Address:				
Phone#: Fax#:	E-mail:			
Architect:	Contact:			
Address:				
Phone#: Fax#:	E-mail:			
Surveyor:	Contact:			
Address:				
Phone#: Fax#:	E-mail:			
Contractor:	Contact:			
Address:				
Phone#: Fax#:	E-mail:			
TYPE OF SUBMITTAL:	CHECK TYPE OF APPROVAL/ACCEPTANCE SOUGHT:			
DRAINAGE REPORT	SIA/FINANCIAL GUARANTEE RELEASE			
DRAINAGE PLAN 1st SUBMITTAL	PRELIMINARY PLAT APPROVAL			
DRAINAGE PLAN RESUBMITTAL	S. DEV. PLAN FOR SUB'D APPROVAL			
CONCEPTUAL G & D PLAN	S. DEV. FOR BLDG. PERMIT APPROVAL			
GRADING PLAN	SECTOR PLAN APPROVAL			
EROSION & SEDIMENT CONTROL PLAN (ESC)	FINAL PLAT APPROVAL			
ENGINEER'S CERT (HYDROLOGY)	CERTIFICATE OF OCCUPANCY (PERM)			
CLOMR/LOMR	CERTIFICATE OF OCCUPANCY (TCL TEMP)			
TRAFFIC CIRCULATION LAYOUT (TCL)	FOUNDATION PERMIT APPROVAL			
ENGINEER'S CERT (TCL)	BUILDING PERMIT APPROVAL			
ENGINEER'S CERT (DRB SITE PLAN)	GRADING PERMIT APPROVAL SO-19 APPROVAL			
ENGINEER'S CERT (ESC)	PAVING PERMIT APPROVAL ESC PERMIT APPROVAL			
SO-19	WORK ORDER APPROVAL ESC CERT. ACCEPTANCE			
OTHER (SPECIFY)	GRADING CERTIFICATION OTHER (SPECIFY)			
WAS A PRE-DESIGN CONFERENCE ATTENDED:	Yes No Copy Provided			
DATE SUBMITTED:	By:			

Requests for approvals of Site Development Plans and/or Subdivision Plats shall be accompanied by a drainage submittal. The particular nature, location, and scope to the proposed development defines the degree of drainage detail. One or more of the following levels of submittal may be required based on the followin

1 Conceptual Grading and Drainage Plan. Required for approval of Site Development Plans greater than five (5) acres and Sector Plans

- Drainage Plans: Required for building permits, grading permits, paving permits and site plans less than five (5) acres
- Drainage Report: Required for subdivision containing more than ten (10) lots or constituting five (5) acres or more
- Erosion and Sediment Control Plan: Required for any new development and redevelopment site with 1-acre or more of land disturbing area, including project less than 1-acre than are part of a larger common plan of development



Vicinity Map

#### **Drainage Calculations**

Hydrology Calculations				
Garcia's Restaurant				
DPM - Section 22.2				
Volume 2, January 1993				
Precipitation Zone	1			
100 Year Storm Depth, P (360)	2.2			
Treatment Area	Α	В	С	D
Excess Precipitation Factors	0.44	0.67	0.99	1.97
Peak Discharge Factors	1.29	2.03	2.87	4.37
Land Treatment Area	Acres	Existing		Proposed
Type "D" (Roof)		0.76		1.76
Type "C" (Unpaved Roadway)				
Type & (onpaved Readway)		0		0.00
Type "B" (Irrigated Lawns)		0 0.26		0.00 0.44
* 1		Ψ.		

Land Treatment Area	Acres	Existing	Proposed
Type "D" (Roof)		0.76	1.76
Type "C" (Unpaved Roadway)		0	0.00
Type "B" (Irrigated Lawns)		0.26	0.44
Type "A" (Undeveloped)		1.18	0.00
Total (Acres)		2.2	2.20
Excess Precipitation(in)		1.00	1.71
Volume (100) 24 hr, cf		7951.88	13656.06
Volume (10),cf		5327.76	9149.56
Q (100), cfs		5.37	8.58
Q (10), cfs		3.60	5.75

**Pond Volumes** 

POND VOLUME REQUIRED

POND VOLUME PROVIDED: SUMP : 2.33 FT X 400 SF = 932 CF

POND 1: 2.00 FT X 2731 SF = 5,462 CF


POND 2: 1.50 FT X 4004 SF = 7,363 CF

# TOTAL POND VOLUME PROVIDED — 13,757 CF

Legend

Drainage Narrative THE PURPOSE OF THIS GRADING PLAN IS FOR THE CONSTRUCTION OF A NEW FOOD PREPARATION FACILITY AND CATERING FACILITY LOCATED BEHIND THE EXISTING GARCIA'S RESTAURANT AT 1736 CENTRAL AVENUE S.W.THIS GRADING AND DRAINAGE PLAN TAKES INTO CONSIDERATION LOT 1 AND LOT 2 GARCIA DEVELOPMENT PROPERTIES. THE SITE IS BOUND ON THE NORTH BY CENTRAL BOULEVARD, THE WEST BY EXISTING DEVELOPMENT, AND THE SOUTH BY EXISTING RESIDENTIAL DEVELOPMENT AND THE EAST BY EXISTING DEVELOPMENT. THE EXISTING SITE CURRENTLY DRAINS FROM THE NORTHEAST TO THE SOUTHWEST CORNER OF THE SITE (LOTS 1 AND 2). THERE IS NOT ANY OFF-SITE RUNOFF THAT ENTERS THE PROPERTY, AND DUE TO THE PROPERTY LOWEST POINT BEING THE SOUTHWEST CORNER; WATER CANNOT BE RELEASED INTO CENTRAL BOULEVARD WITHOUT PUMPING. THE PROPOSED DESIGN COLLECTS ALL RUNOFF FROM LOTS 1 AND 2 INTO TWO DETENTION PONDS AS SHOWN. THE WATER WILL THEN BE PUMPED TO A DISCHARGE POINT IN THE CURB AT CENTRAL AVENUE. THE PONDS HAVE BEEN DESIGNED TO ACCOMMODATE A 100 YEAR-24 HOUR STORM AND THE PUMP SPECIFIED WILL DRAIN THAT VOLUME OVER A 24HR PERIOD. IN THE EVENT OF PUMP MALFUNCTION, WATER WILL BACKUP INTO THE PARKING LOT. THE PAD FOR THE NEW BUILDING HAS BEEN ELEVATED SO THAT IN THE EVENT OF WATER PONDING INTO THE PARKING AREAS, THE IS MINIMAL TO NO CHANCE FOR DAMAGE TO THE BUILDING. THE SITE IS NOT WITHIN THE 100-YEAR FLOOD PLAIN.

<del></del>	EXISTING CONTOUR
<del></del> 55 <del></del>	NEW CONTOUR
	DRAINAGE BASIN BOUNDARY
	SWALE - DIRECTION OF FLOW
TC	TOP OF CURB
FL	FLOW LINE
FF	FINISH FLOOR
RD	ROOF DRAIN
55.00	NEW SPOT ELEVATION
(55.00)	EXISTING SPOT ELEVATION

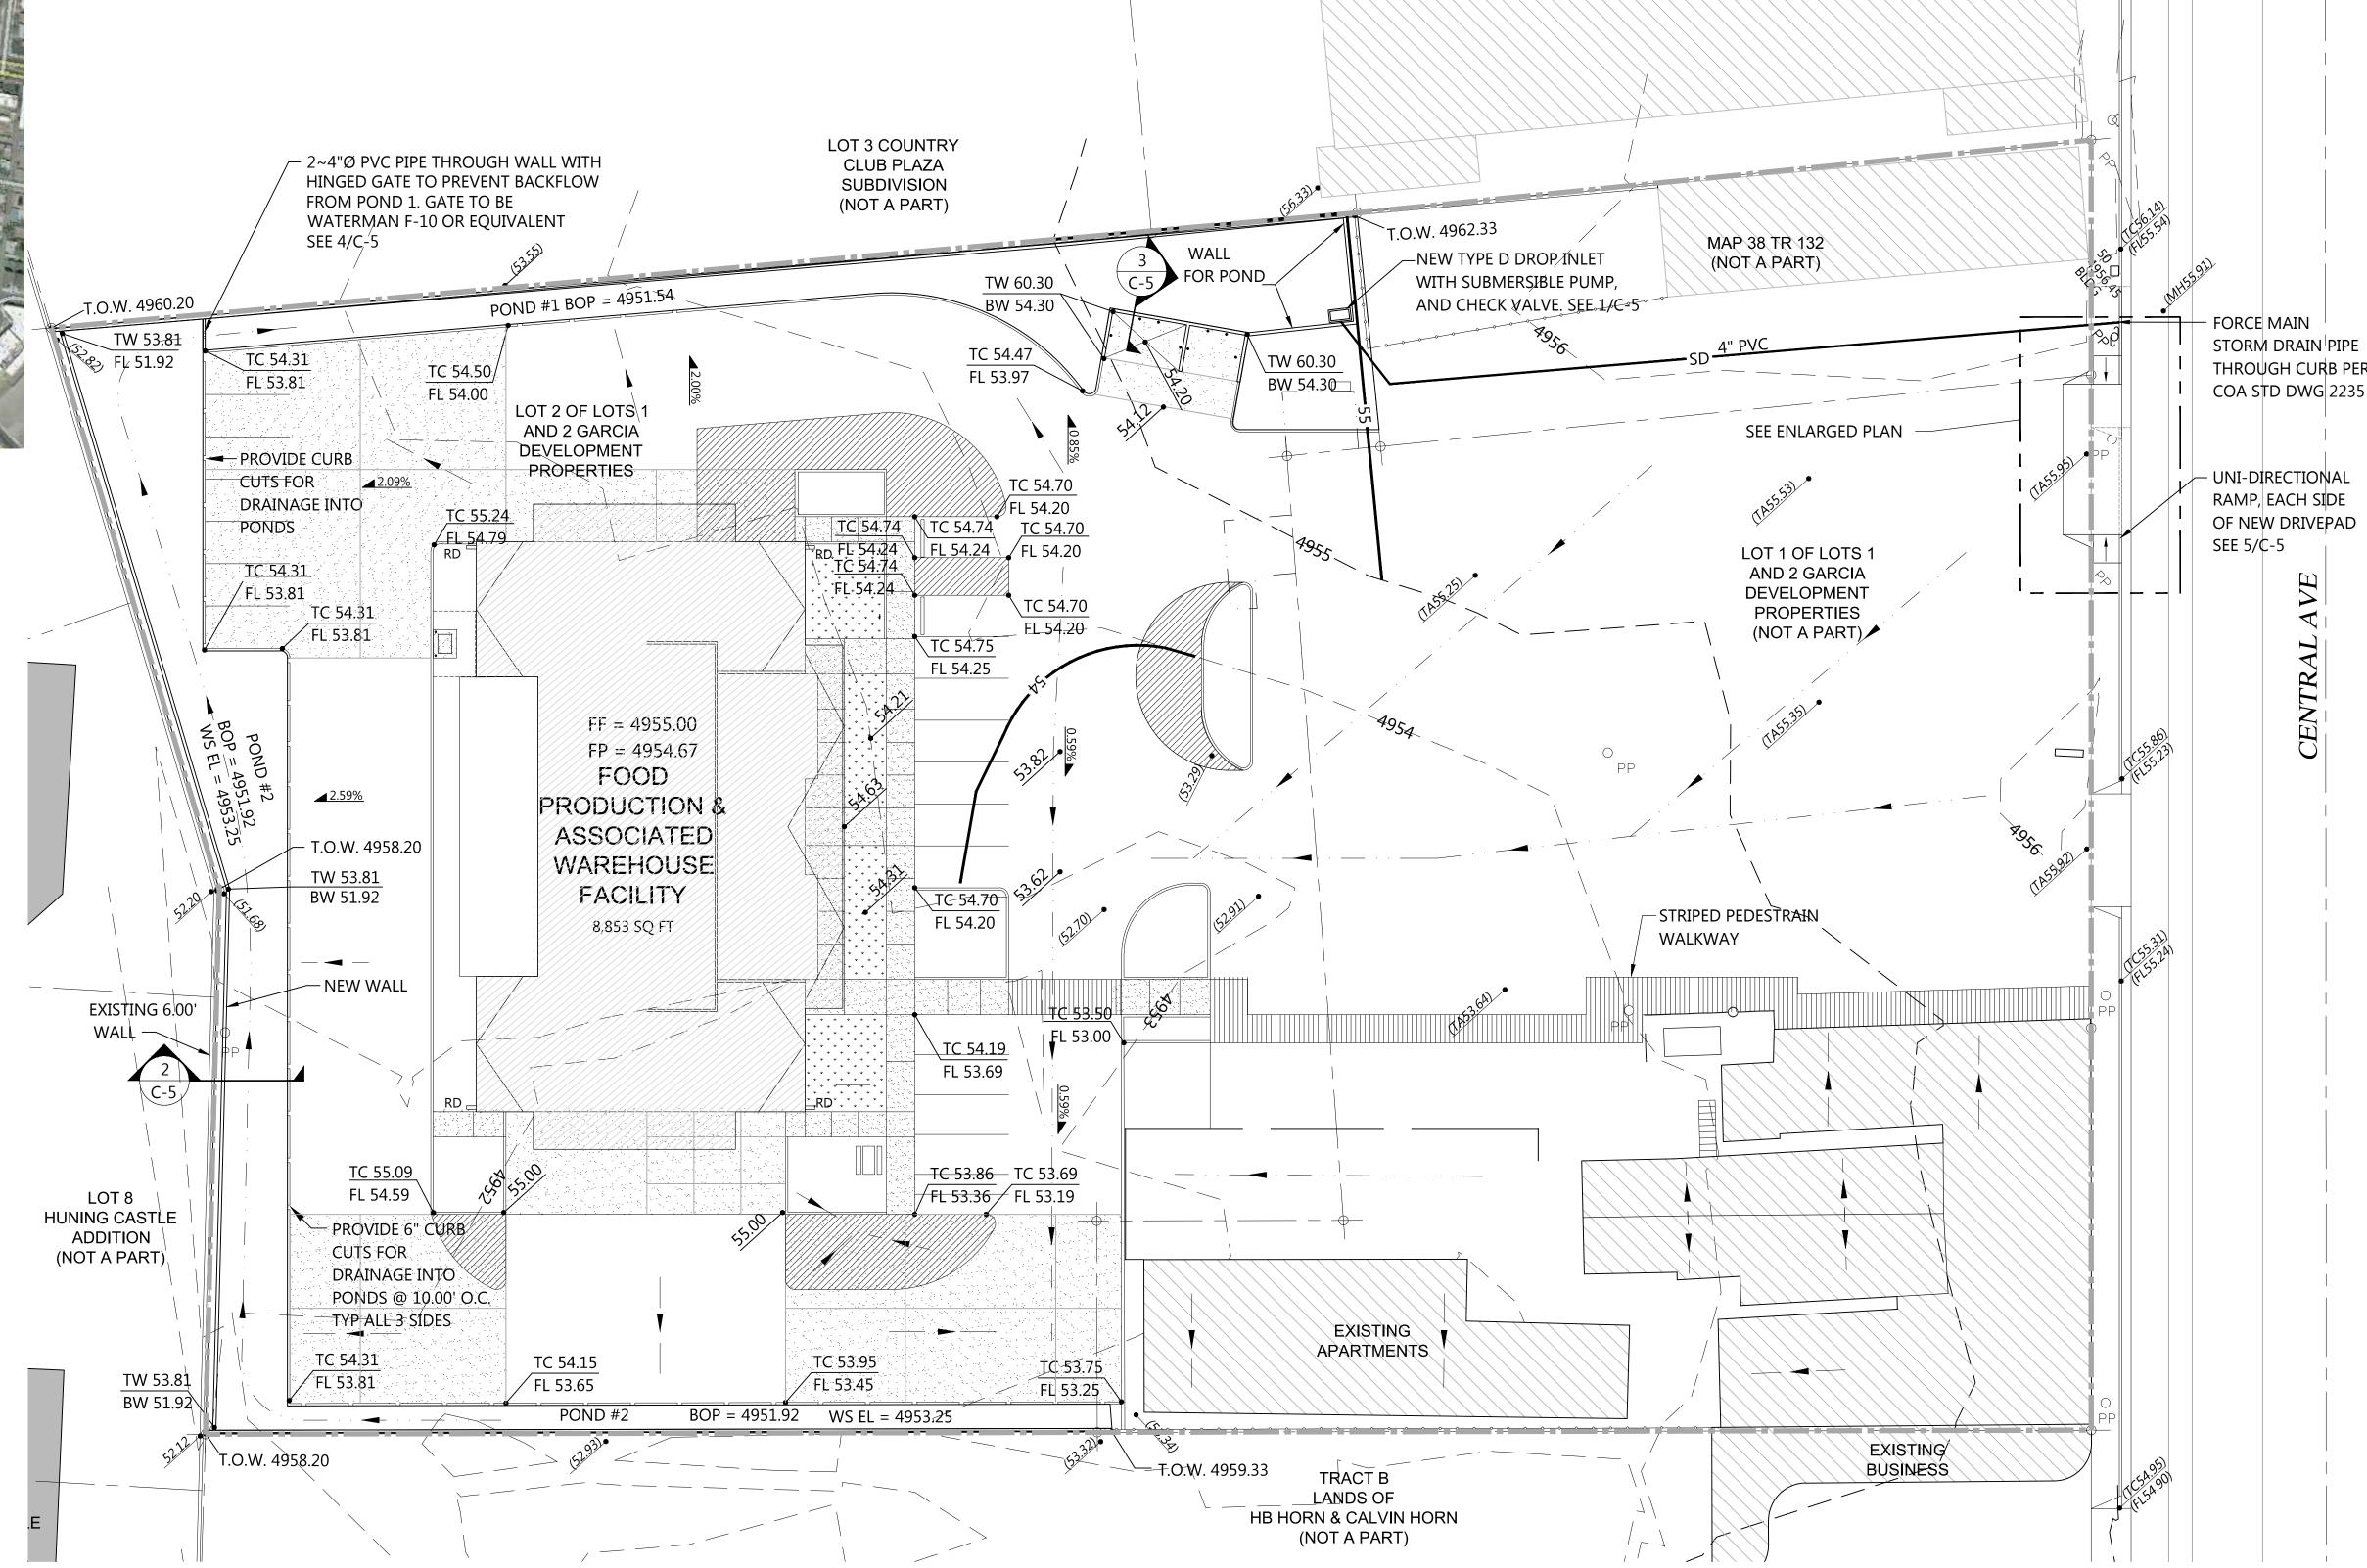

# GRADING AND DRAINAGE PLAN

SCALE: 1" = 20'

### Site Notes

QTY: 1


- OIL/WATER SEPARATOR TO BE INSTALLED IN TRASH ENCLOSURE PRIOR TO CONNECTION TO SANITARY SEWER.
- 2. IN THE EVENT OF PUMP FAILURE, WATER WILL BACK UP INTO PARKING LOT.

### Sump Pump Information

FLYGT - MODEL NS3127 WITH 464 IMPELLER PORTABLE CONFIGURATION PUMP ON A STAND WITH 4" DISCHARGE POWER REQUIREMENTS: 7.5HP 230/1/60 PROVIDE BACK UP POWER GENERATOR IN EVENT OF POWER FAILURE


ENLARGED PLAN

SCALE: 1" = 20'

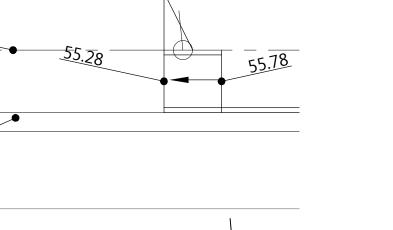

*55.95* 



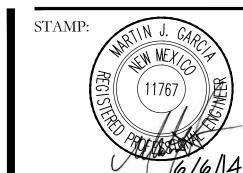

ENGINEER:



JOB No:

FILE NAME:

DWG NAME: C1 GarciaGrading

ISSUE DATE: August 29, 2012


RE: DATE DESCRIPTION

TITLE:

GRADING AND DRAINAGE PLAN

**PRODUCTION** 

SHEET:

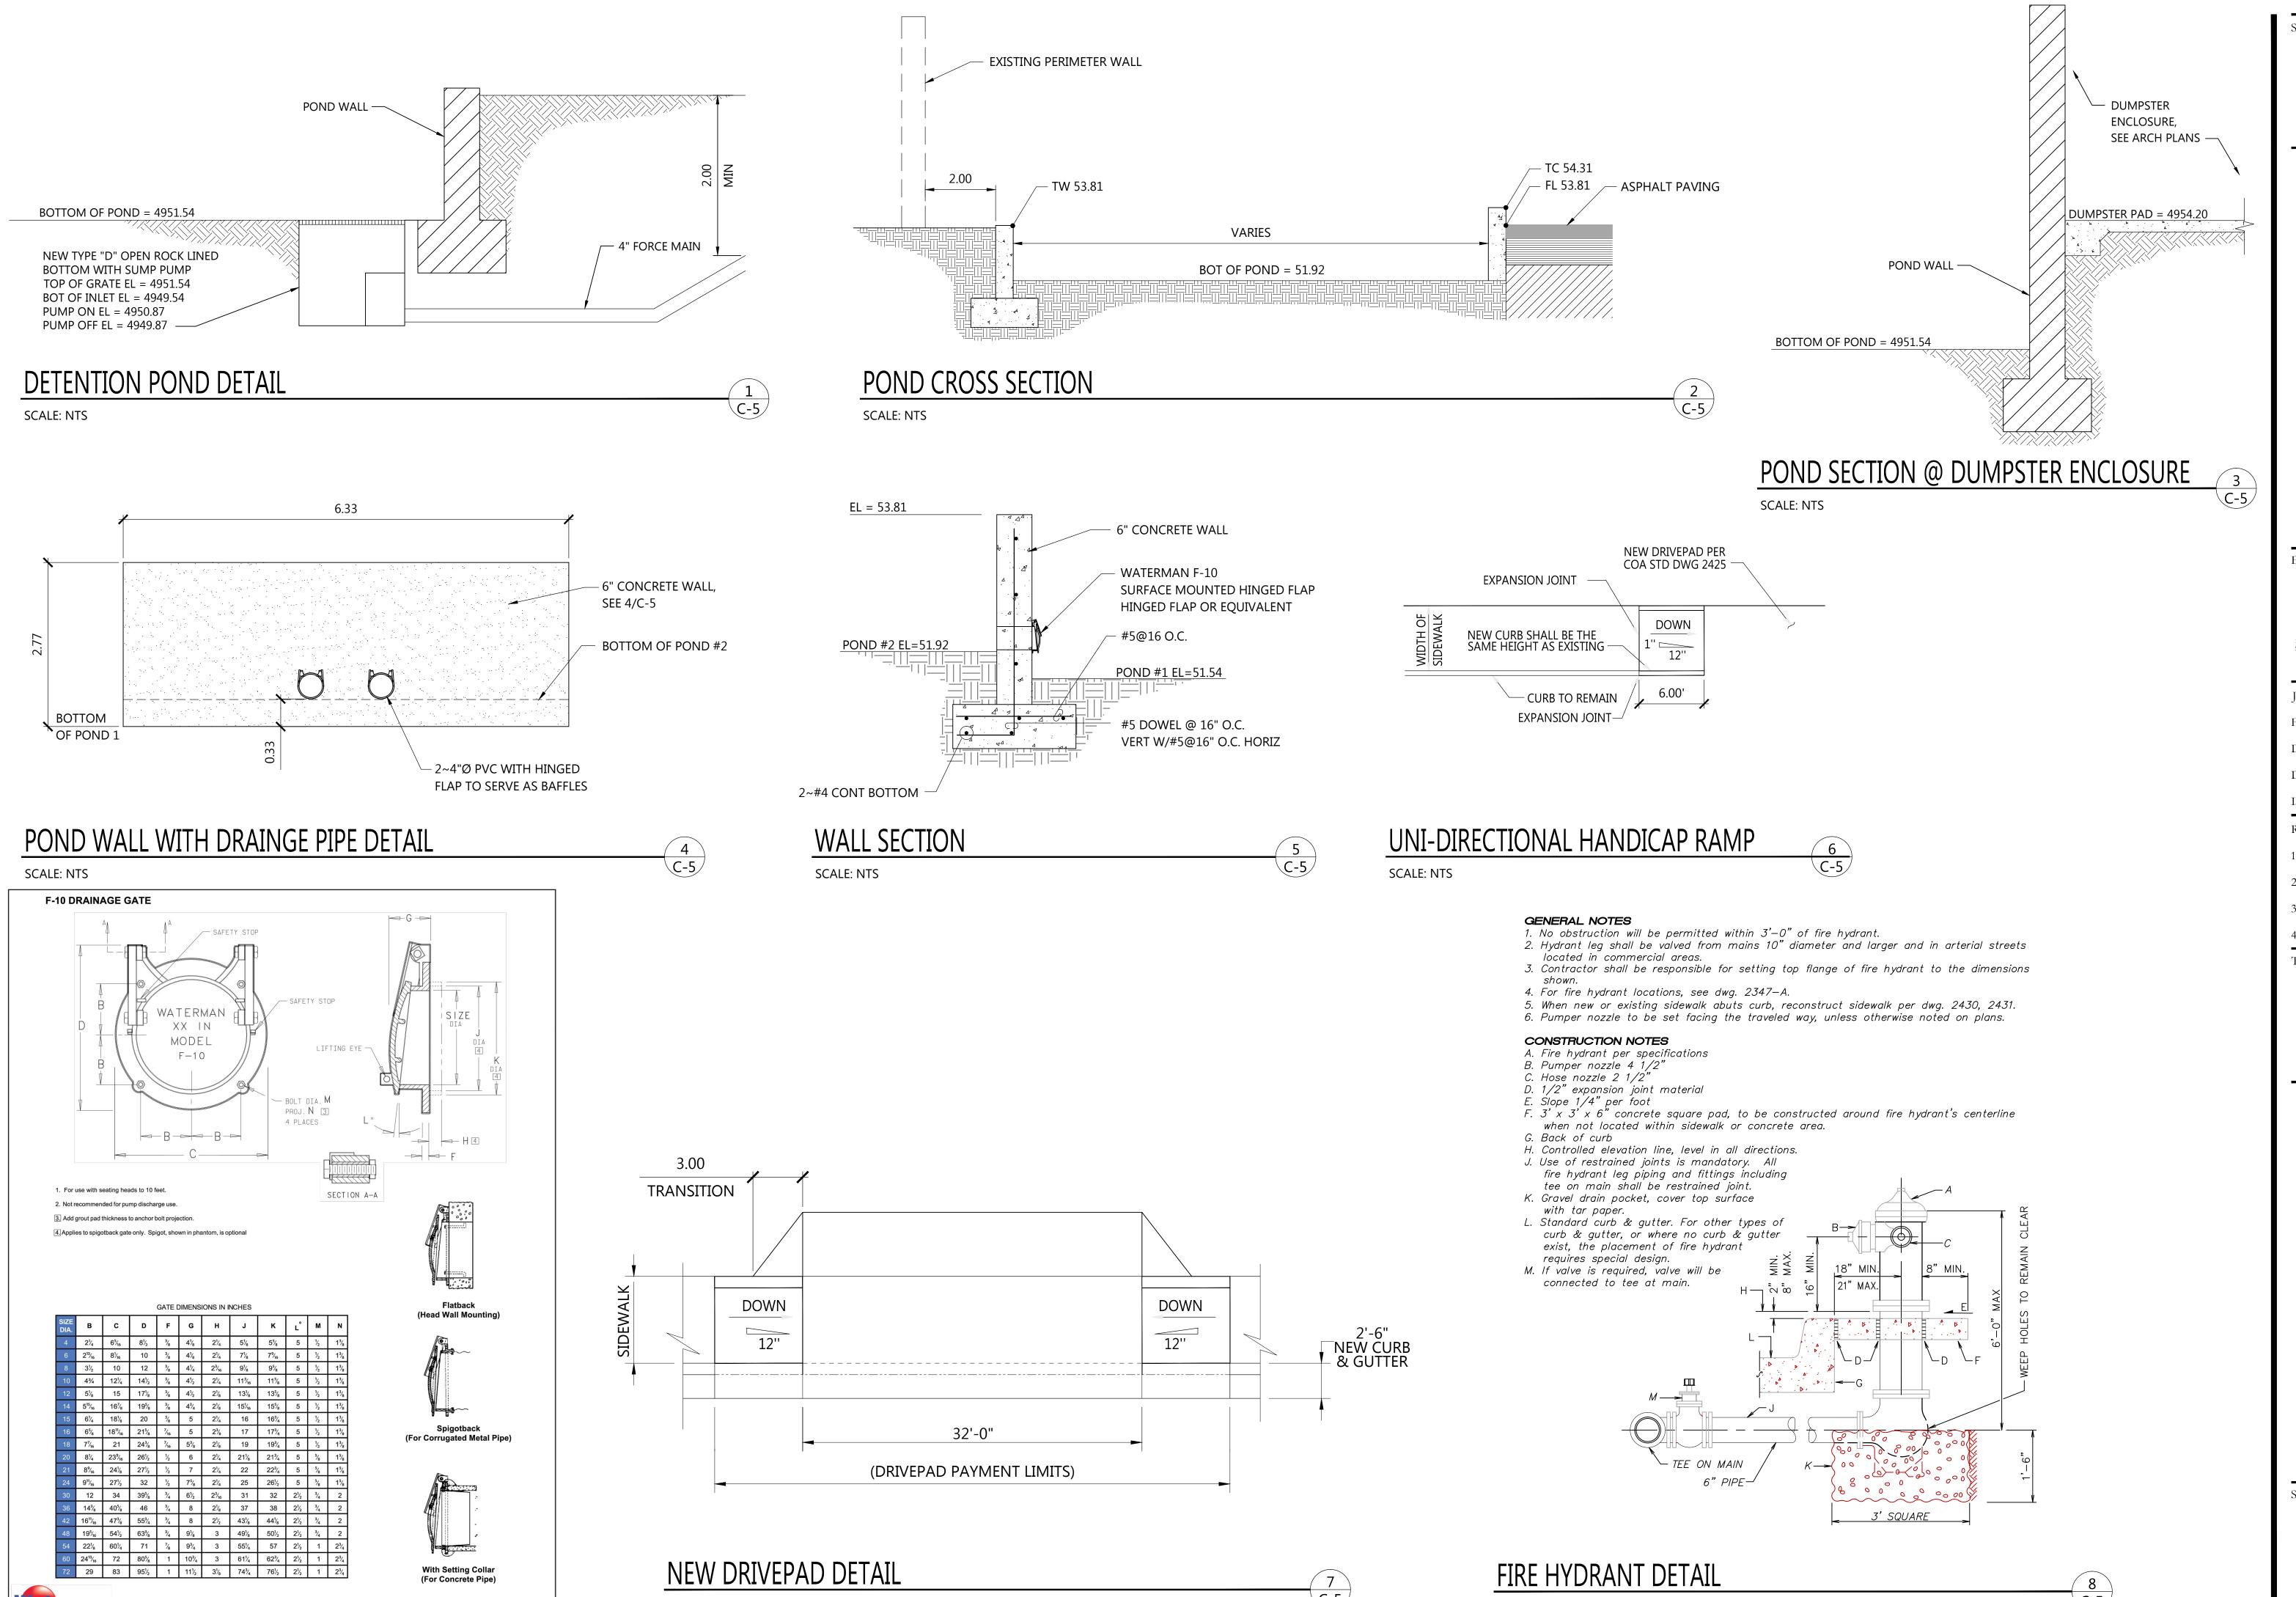

SCALE: NTS

SCALE: NTS

STAMP: 11767 11767 11767 6/6/14

J·S·**ROGERS** ARCHITECTS P·C· 821 Mountain Road NW, Albuquerque, NM 87102 phone: (505) 247-1168 fax: (505) 247-0262

ENGINEER:



JOB No:

FILE NAME:

DWG NAME: C5 GARCIADET

NAWN D1:

ISSUE DATE: August 29, 2012

RE: DATE DESCRIPTION

1.

2.

3.

TITLE:

SITE DETAILS

AREHOUSE SW

D PRODUCTION & WARE 1736 Central Avenue, SW

SHEET:

C- $\xi$