CITY OF ALBUQUERQUE

Planning Department Alan Varela, Director



Mayor Timothy M. Keller

August 27, 2024

Shawn Biazar, P.E. SBS Construction and Engineering, LLC 7632 William Moyers Avenue, NE Albuquerque, NM 87114

RE: 2105 New York SW Grading and Drainage Plan Engineer's Stamp Date: 8-3-2024 Hydrology File: J13D223

Dear Mr. Biazar,

Based upon the information provided in your submittal received 08/09/2024, the Grading & Drainage Plan is approved for Building Permit and Grading Permit. Please attach a copy of this approved plan in the construction sets for Building Permit processing along with a copy of this letter.

PO Box 1293

Once the grading is complete, a pad certification will be required prior to release of Building Permit. Please attach a copy of this approved plan in the construction sets for Building Permit processing along with a copy of this letter and the pad certification approval letter.

Albuquerque

PRIOR TO CERTIFICATE OF OCCUPANCY:

 NM 87103
Engineer's Certification, per the DPM Part 6-14 (F): Engineer's Certification Checklist For Non-Subdivision is required.

www.cabq.gov

If you have any questions, please contact me at 505-924-3314 or amontoya@cabq.gov.

Sincerely,

anthe Mart

Anthony Montoya, Jr., P.E. Senior Engineer, Hydrology Planning Department, Development Review Services

	Planning Department		
	nent & Building Services Division		
DRAINAGE ANI	O TRANSPORTATION INFORMA	TION SHEET (REV 6/2018)	
Project Title: 2105 NEW YORK AVE., SW	Building Permit #:	Hydrology File #:	
DRB#:			
Legal Description: Southery 74' of Lot 3, Bl			
City Address: 2105 NEW YOURK, SW			
Applicant: SBS CONSTRUCTION AND ENC	GINEEING, LLC	Contact: SHAWN BIAZAR	
Address:7632 William Moyers Avenue, NE, AL	BUQUERQUE, NM 87114		
Phone#: (505) 804-5013	_Fax#: (505) 897-4996	E-mail: AECLLC@AOL.COM	
Other Contact:		Contact:	
Address:			
Phone#:		E-mail:	
TYPE OF DEVELOPMENT: PLAT	(# of lots) X RESIDENCE	DRB SITE ADMIN SITE	
	-Y No		
IS THIS A RESUBMITTAL? Yes			
DEPARTMENT TRANSPORTATION	<u>X</u> HYDROLOGY/DRAINAGE	3	
Check all that Apply:	TYPE OF APPRO	VAL/ACCEPTANCE SOUGHT:	
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ENGINEER/ARCHITECT CERTIFICATIO	CERTIFICAT	E OF OCCUPANCY	
PAD CERTIFICATION			
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Location

Southerly 74' of Lot 3, Block 4, Tracttion and City Electric, addition, is located at 2105 New York ave., SW, containing 0.0861 acre. See attached portion of Vicinity Map J-13-Z for exact location.

Purpose

The purpose of this drainage report is to present a grading and drainage solution for +/- 1680 SF of new house/patio and 440 SF of new driveway on this lot.

Existing Drainage Conditions

There was existing house on this site that was removed. There are existing block walls and fence around the property. The site is within FEMA MAP 35001C0331H and does not fall within a 100 year floodplain. This lot is very flat and drains from south to north to New York ave., SW. No offsite runoff enters this site.

Proposed Conditions and On-Site Drainage Management Plan

Under the proposed conditions and existing conditions are the same. The runoff will drain into the proposed ponds and eventually drain into New York ave., SW. We are proposing a new +/- 1680 sf building including the covered patio/porch with a 440 sf of new drive way. This will not increase our site flow. The total site impervious area consist of 2,120 sf for the Fisrt Flush. We are proposing to pond the 90th Percentile/First Flush requirement which is is 0.42 inches times the impervious area. Total retention volume provided within pond A and B is 97.30 cf which exceeds the ponding volume requirement for First Flush7420 sf ponding requirement

IMPERVIOUS AREA = 2,120.00 SF FIRST FLUSH VOL. REQI. = 0.42" x 2,120.00 / 12 = 74.20 CF

POND CALCULATION

TOTAL POND AREA PROVIDED = PONDING CALCULATIONS:

POND A: AREA @ TOP = 204.10, AREA @ BOTTOM = 127.10 POND VOLUME = (204.10+127.10/2*0.50' = 82.80 CF)

POND b: AREA @ TOP = 45.00, AREA @ BOTTOM = 13.00 POND VOLUME = (45.00+13.00/2*0.50' = 14.50 CF)

TOTAL POND VOLUME PROVIDED = (82.80+14.50) = 97.30 CF

VOLUME CALCULATIONS FOR 10 DAY STORM

BASIN AREA (SF) AREA (AC) AREA (MI²) ON-SITE 3,750.00 0.0861 0.007375

E = EA(AA) + EB(AB) + EC(AC) + ED(AD)AA + AB + AC + AD

V-360 = E (AA + AB + AC + AD)


EA = 0.62EB = 0.80EC = 1.03ED = 2.33

P-60 = 1.78P-360 = 2.29P-1440 = 2.59P-10 Day = 3.62

EXISTING/PROPOSED CONDITIONS

AD = 56.00% E =	1.6490 IN
$\mathbf{E} =$	1.6490 IN

V-360 =	0.0122 AC-FT
AD =	0.0482 AC
V-10 DAY =	0.0175 AC-FT
V DAY =	762.13 CF

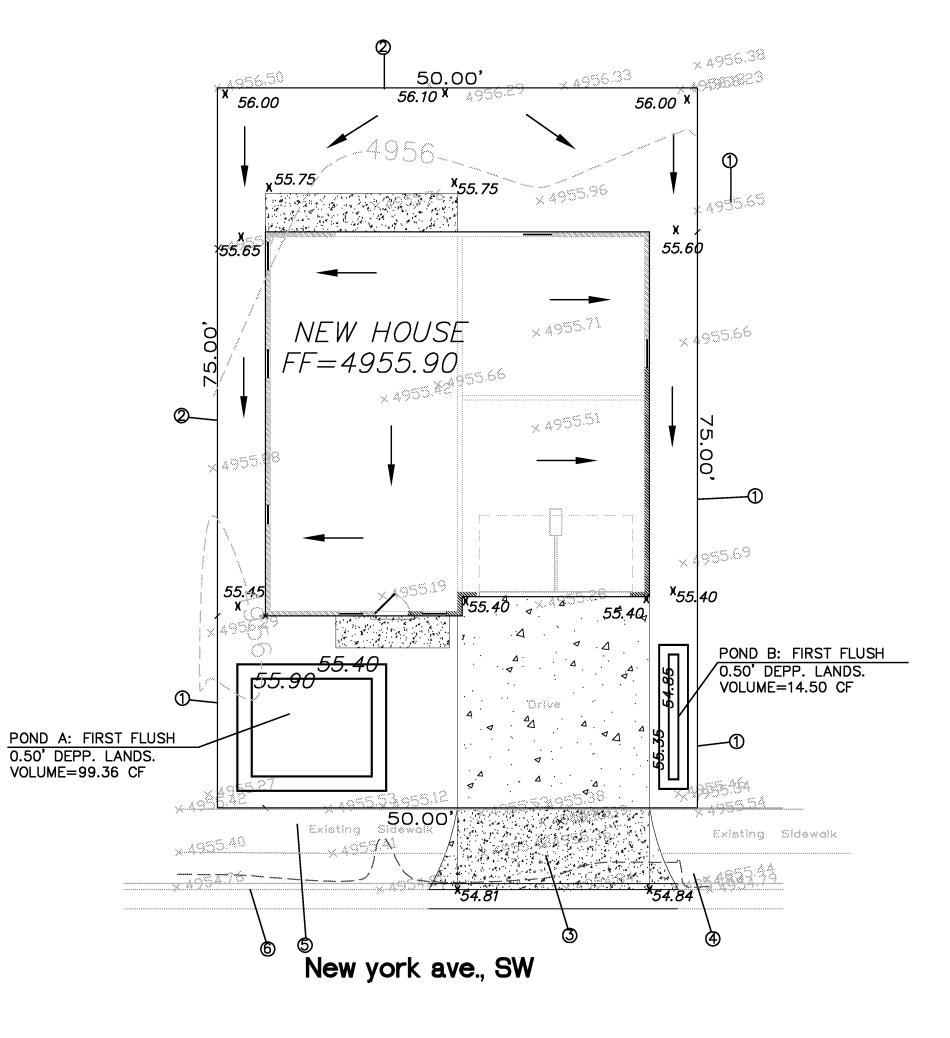

NOTICE TO CONTRACTORS

1. AN EXCAVATION/CONSTRUCTION PERMIT WILL BE REQUIRED BEFORE BEGINNING ANY WORK WITHIN BERNALILLO COUNTY RIGHT-OF-WAY.


2. ALL WORK DETAILED ON THESE PLANS TO BE PERFORMED, EXCEPT AS OTHERWISE STATED OR PROVIDED HEREON, SHALL BE CONSTRUCTED IN ACCORDANCE WITH BERNALILLO COUNTY STANDARD SPECIFICATIONS FOR PUBLIC WORKS CONSTRUCTION.

3. TWO WORKING DAYS PRIOR TO ANY EXCAVATION, CONTRACTOR MUST CONTACT LINE LOCATING SERVICE, 765-1234, FOR LOCATION OF EXISTING UTILITIES.

4. PRIOR TO CONSTRUCTION, THE CONTRACTOR SHALL EXCAVATE AND VERIFY THE HORIZONTAL AND VERTICAL LOCATIONS OF ALL CONSTRUCTIONS. SHOULD A CONFLICT EXIST, THE CONTRACTOR SHALL NOTIFY THE ENGINEER SO THAT THE CONFLICT CAN BE RESOLVED WITH A MINIMUM AMOUNT OF DELAY.

5. BACKFILL COMPACTION SHALL BE ACCORDING TO TRAFFIC/STREET USE. 6. MAINTENANCE OF THESE FACILITIES SHALL BE THE RESPONSIBILITY OF THE OWNER OF THE PROPERTY SERVED.

7. WORK ON ARTERIAL STREETS SHALL BE PERFORMED ON A 24-HOUR BASIS.

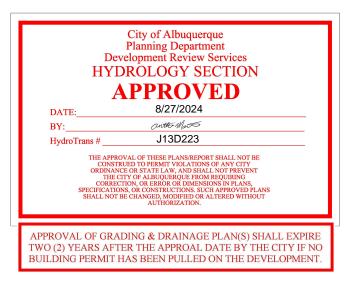

KEY NOTES:

- 1. EXISTING BLOCK WALL.
- 2. EXISTING FENCE.
- 3. NEW DRIVE WAY PER COA. STD
- 4. SAW CUT, REMOVE EXISTING DRIVEWAY. INSTALL STANDARD CURB & GUTTER AND SIDEWALK PER COA. STD. DWG 2415A AND 2430.

5. EXISTING SIDEWALK.

6. EXISTING CURB & GUTTER.

A SP-80-380 SP-80-380 SP-80-380 SF 82-115 366 MEHAIN LECTRIC R-1A 46 NEW YORK SP-99-66 R-1A C SP-99-66 R-1A C SP-99-66 R-1A C SP-99-66 R-1A C SP-99-66 C SP-99-66 C SP-99-66 C SP-80-380 SF 82-115 SF 82-15 SF 82-15 SF 82-15 SF 82-15 SF 82-15 SF 82-15 S	CENTER SP-96-241 CENTR MX-M 366	AL 160 160 160 160 160 160 160 160	
LEGAL DESCRIPTION:			
SOUTHERY 74' OF LOT 3,	BLOCK 4, TRACTIC	N PARK AND CITY	ELECT.

CONTAINING: 3,750.00 SF (0.0861 ACRE)

BENCHMARK

ADDITION.

CITY BNCHMARK 14_J113, ELEVATION OF 4957.34 FEET ABOVE SEA LEVEL FEMA MAP

THIS SITE IS LOCATED WITH FEMA MAP # 35001C0331H.

GENERAL NOTES:

- 1: CONTOUR INTERVAL IS HALF (1.00) FOOT.
- 2: UTILITIES SHOWN HEREON ARE IN THEIR APPROXIMATE LOCATION BASED ONLY ON ABOVE GROUND EVIDENCE FOUND IN THE FIELD AND AS-BUIL INFORMATION PROVIDED BY THE CLIENT. UTILITIES SHOWN HEREON, WHETHER INDICATED AS ABANDONED OR NOT, SHALL BE VERIFIED BY OTHERS FOR EXACT LOCATION AND/ OR DEPTH PRIOR TO EXCAVATION OR DESIGN CON-SIDERATIONS.
- 3: THIS IS <u>NOT</u> A BOUNDARY SURVEY, BEARINGS ARE ASSUMED, DISTANCES AND FOUND PROPERTY CORNERS ARE FOR <u>INFORMATIONAL</u> PURPOSES ONLY.
- 4: SLOPES ARE AT 3:1 MAXIMUM.
- 5: ADD 4900.0 TO ALL PROPOSED SPOT ELEVATIONS.

LEGEND

<u> </u>	EXISTING CONTOUR (MAJOR) EXISTING CONTOUR (MINOR)
X <i>89.13</i> X 5029.16	BOUNDARY LINE PROPOSED SPOT ELEVATION EXISTING GRADE
× 5075.65 FL	EXISTING FLOWLINE ELEVATION
	PROPOSED RETAINING WALL
BC=41.30	BOTTOM OF CHANEL
TF=42.00 TRW=45.12	TOP OF FOOTING TOP OF RETAINING WALL
HP	HIGH POINT
42.40 -42.45	AS-BUILT GRADES
69.77 ×	AS-BUILT SPOT ELEVATIONS





REZA AFAGHPOUR P.E. #11814

SBS CONSTRUCTION AND ENGINEERING, LLC 10431 4TH STREET., NW

ALBUQUERQUE, NEW MEXICO 87114 (505) 804-5013 EMAIL: AECLLC@AOL.COM

GRA	APF	HIC	SCALE
10	5	0	10
SCALE: 1"=10'			

LAST REVISION:

2105 NEW YORK AVE., SW
· · · · · · · · · · · · · · · · · · ·
GRADING AND DRAINAGE PLAN

	DRAWING:	DRAWN BY:	DATE:	SHEET #
	202418-GD.DWG	SH-B	7-31-2024	l
2-2-2018				