


INLET PROTECTION REQUIREMETS

SANDBAGS:


- SANDBAGS SHALL CONSIST OF A WOVEN POLYPROPYLENE FABRIC SEWN TOGETHER WITH DOUBLE STITCHING.
- OVERALL SIZE OF THE SANDBAG SHALL BE AT LEAST 14 X 26 INCHES.
- THE GEOTEXTILE SHALL BE MnDOT TYPE I (PERMEABLE FABRICS) OR EQUIVALENT.
- NO GAPS SHALL BE PLACED BETWEEN SANDBAGS.

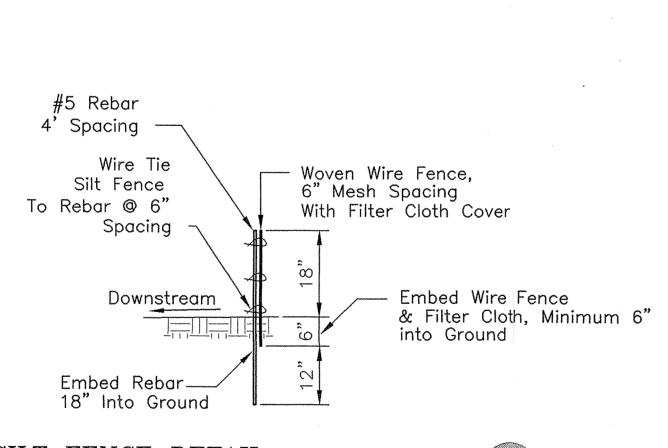

SILT FENCE DETAIL

SCALE: 1/2" = 1'-0'

AL

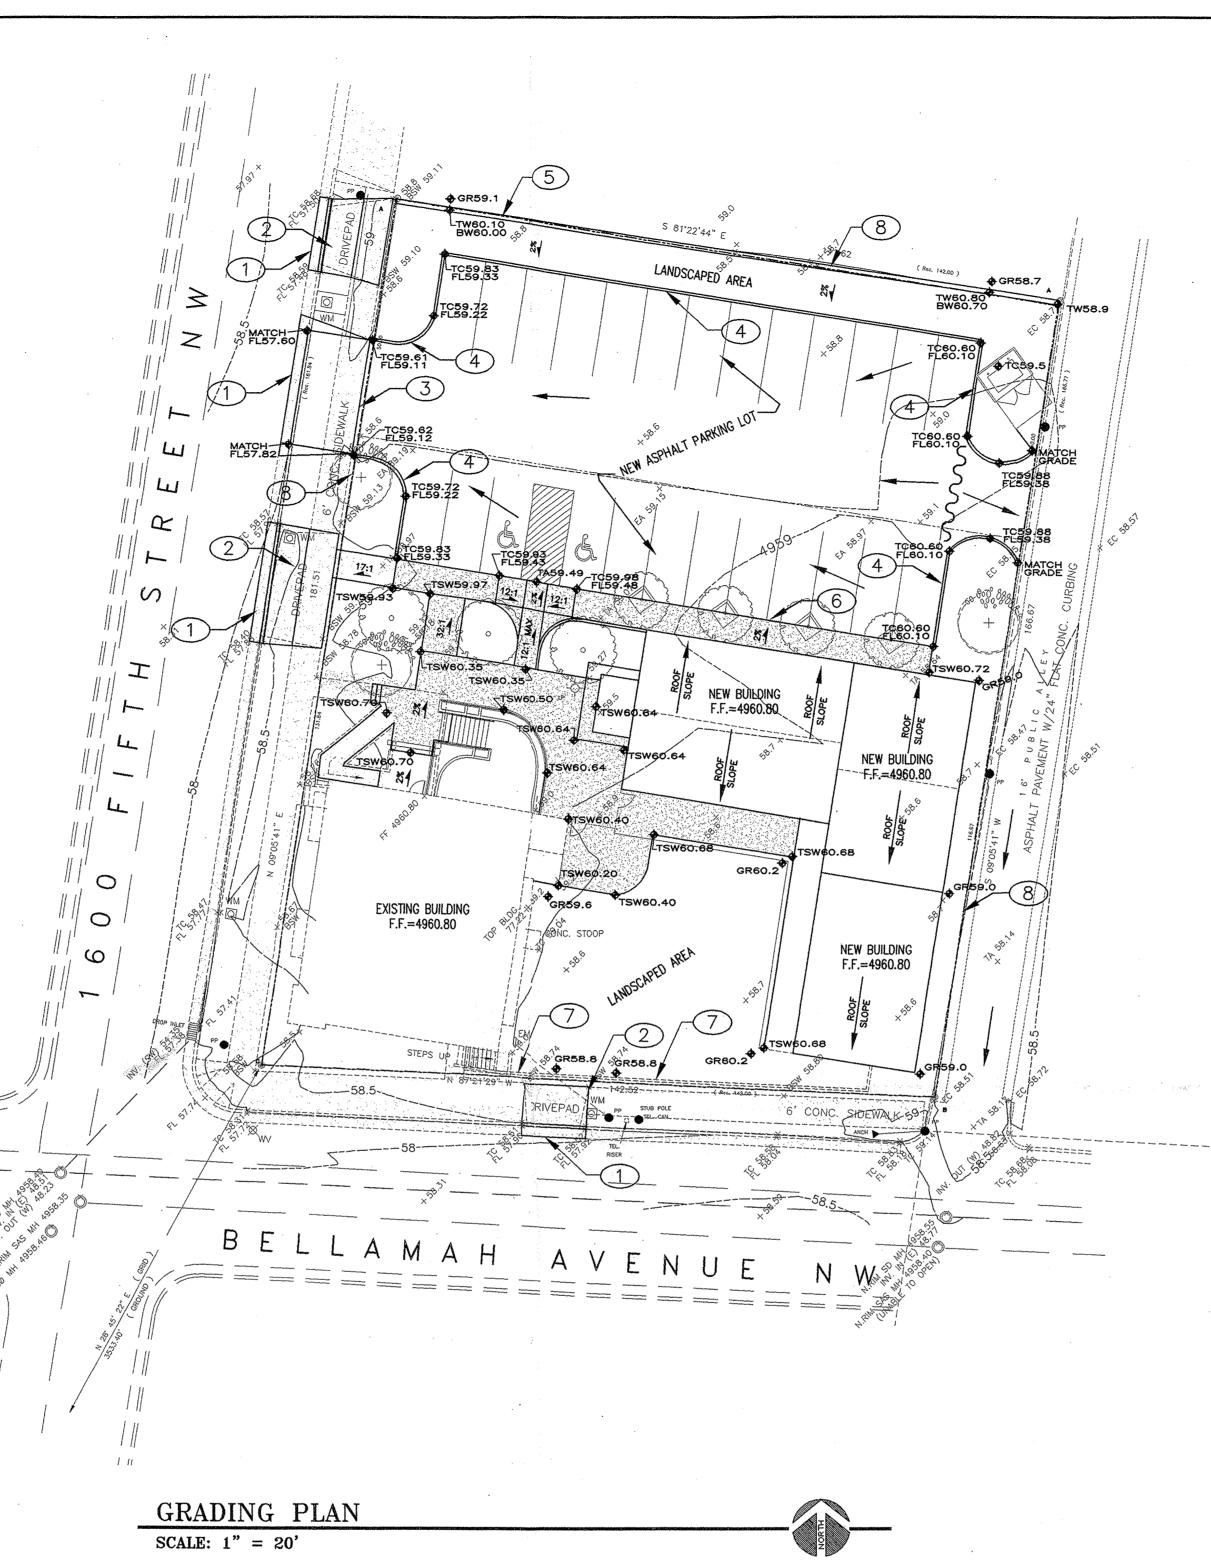


DRAINAGE SWALE


CONSTRUCTION NOTES:

- 1) APPROXIMATE LIMITS OF CURB AND GUTTER REMOVAL AND REPLACEMENT LIMITS, RECONSTRUCT PER CITY STD. DWG. 2415A WITH STANDARD CURB AND GUTTER.
- 2 REMOVE EXISTING DRIVEWAY AND CONSTRUCT SIDEWALK PER CITY STD. DWG. 2430.
- 3 REMOVE EXISTING SIDEWALK AND CONSTRUCT DRIVEWAY PER CITY STD. DWG. 2425.
- 4 CONSTRUCT HEADER CURB PER CITY STD. DWG. 2415B.
- 5 CONSTRUCT 1' HIGH TO 2' HIGH RETAINING WALL (SEE STRUCTURAL DRAWINGS).
- (6) CONSTRUCT SIDEWALK PER CITY STD. DWG. 2430.
- 7 TURN BLOCK AT GRADE EVERY 8 FEET HORIZONTALLY TO ALLOW DRAINAGE FLOWS FROM SITE TO EXIT INTO BELLAMAH AVENUE NW.
- 8 PROVIDE SILT FENCE PER DETAIL SHOWN ON THIS SHEET ALONG PERIMETER OF ENTIRE CONSTRUCTION SITE, CONTRACTOR SHALL MAINTAIN SILT FENCE THROUGHOUT CONSTRUCTION UNTIL SUCH TIME THAT FINAL INSPECTION PERFORMED BY CITY OF ALBUQUERQUE OR PERMANENT STABILIZATION HAS BEEN ESTABLISHED.
- 9 EXISTING INLET TO BE PROTECTED FROM SEDIMENT, SEE DETAIL THIS SHEET.


UTILITY PRECAUTIONS

THE CONTRACTOR SHALL INFORM ITSELF OF THE LOCATION OF ANY UTILITY LINE, PIPELINE, OR UNDERGROUND UTILITY LINE IN OR NEAR THE AREA OF THE WORK IN ADVANCE OF AND DURING EXCAVATION WORK. THE CONTRACTOR IS FULLY RESPONSIBLE FOR ANY AND ALL DAMAGE CAUSED BY ITS FAILURE TO LOCATE, DENTIFY AND PRESERVE ANY AND ALL EXISTING UTILITIES, PIPELINES, AND UNDERGROUND UTILITY LINES. IN PLANNING AND CONDUCTING EXCAVATION, THE CONTRACTOR SHALL COMPLY WITH STATE STATUTES, MUNICIPAL AND LOCAL ORDINANCES, RULES AND REGULATIONS, IF ANY, PERTAINING TO THE LOCATION OF THESE LINES AND FACILITIES.

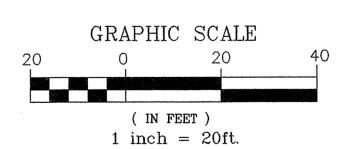

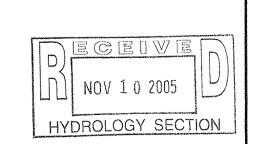

DATE/REVISIONS:

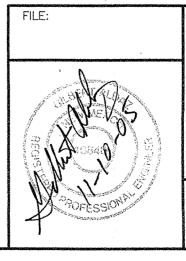

DRAINAGE AND GRADING PLAN FOR

QUAKER BUILDING

at 1600 FIFTH STREET NW

ALBUQUERQUE, NEW MEXICO

Applied Engineering & Suveying, Inc.

1605 BLAIR DRIVE NE

ALBUQUERQUE, NEW MEXICO 87112 PH: (505)237-1456

SHEET NUMBER: