
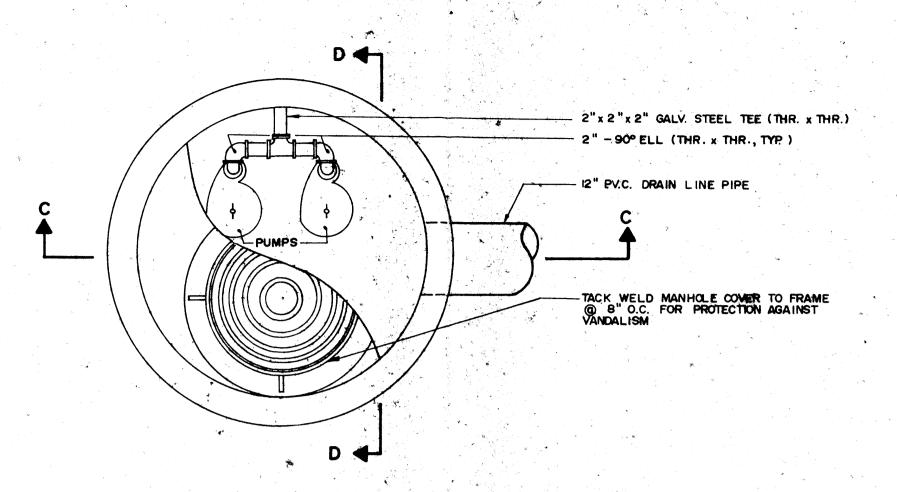


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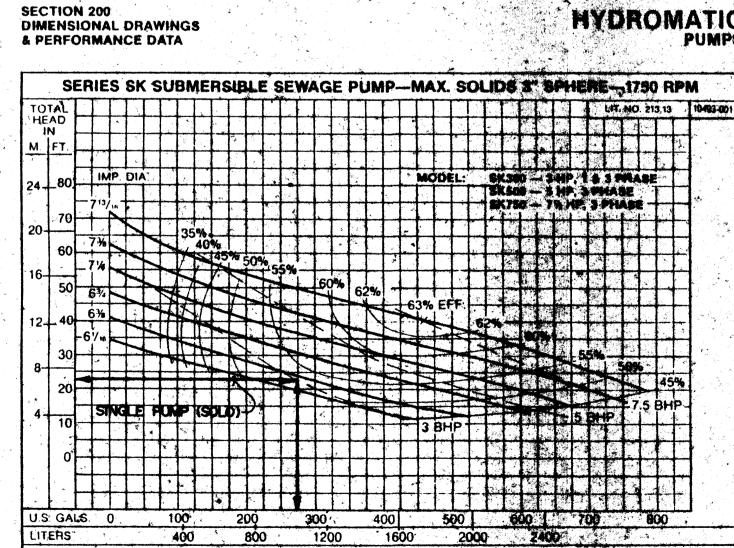


MANHOLE PLAN

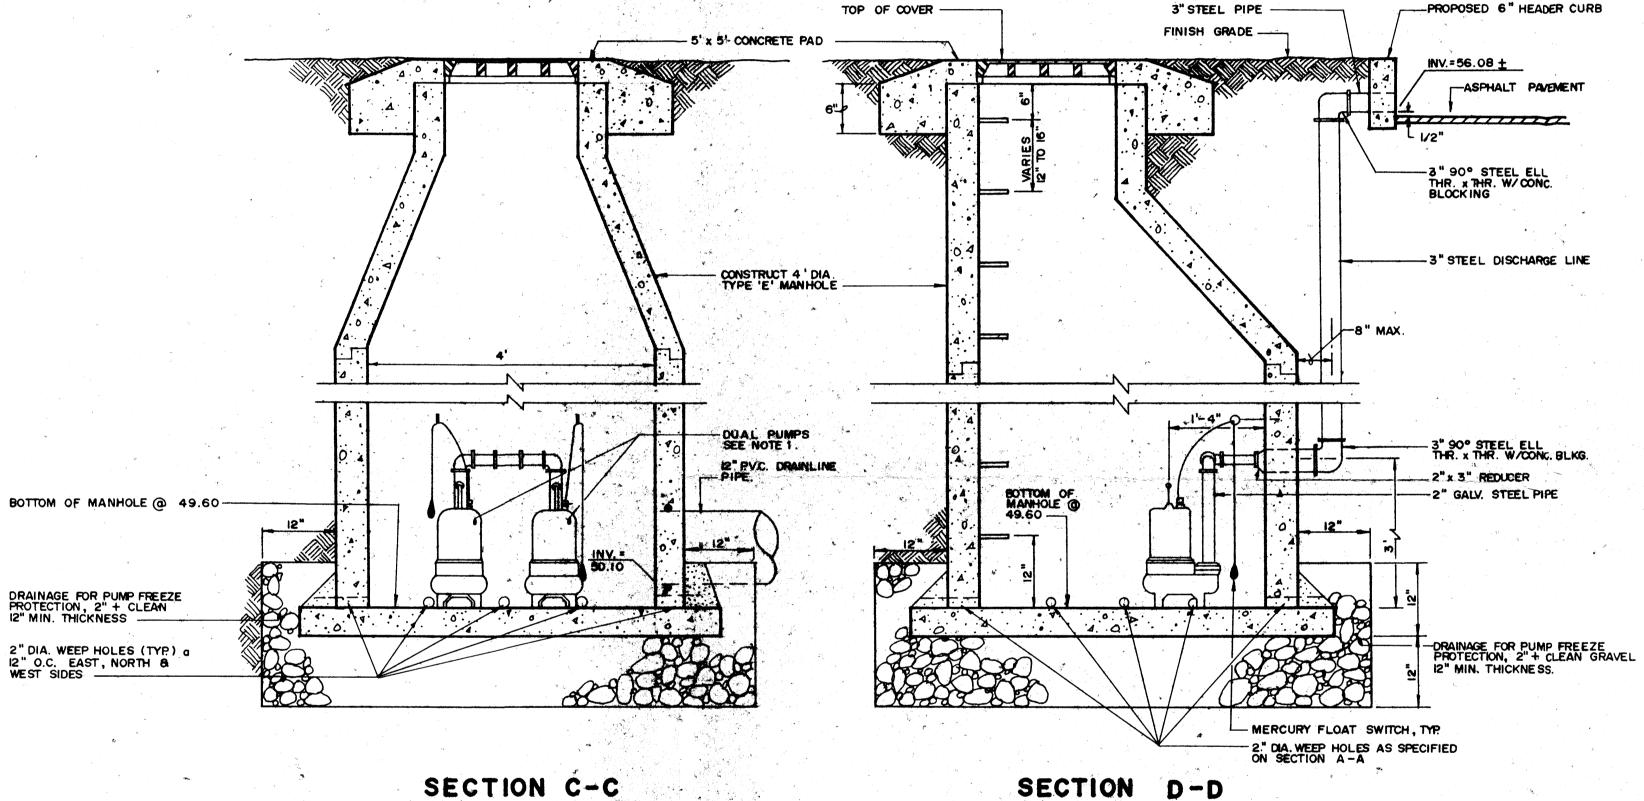

SECTION C-C SCALE : 3/4" = 1'-0"


HYDROMATIC



SCALE: 3/4" = 1'-0"

VARIES FROM 0'-0" TO 16'-0" ± PROPOSED ASPHALT PAVEMENT AS PER ARCHITECTURAL PLANS EXISTING RAIL ROAD 6" SUBGRADE COMPACTED - @ 95% A.S.T.M. D-1557.

> SECTION B-B SCALE: | " = 4 '

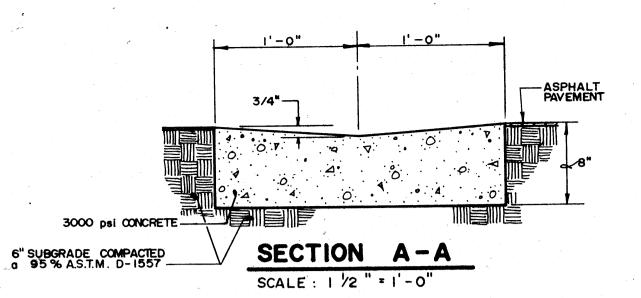

PUMP CALCULATIONS

- Estimated Discharge Rate 200 GPM
 - Elevation: 56.26 49.60 7'
 Friction (3" pips)
 Type of Pips: Steel
 Design C Value: 100
 Chart C Value: 100
 No correction Required
 Hp = 21.4 ft/160 ft

Length of Pipe - 6'

Equivalent Length of Pipe: Sudden Enlargement = 2' 90' Ell = 2 x 8' = 16'

Total Equivalent Length of 4" pipe = 486'+ H_{F2"} = (21.4/100)(22) = 5'

C. Friction (2" pipe)
Type of Pipe: Steel
Design C Value: 100
Chart C Value: 100
No correction Required
Hp = 110 ft/100 ft

Langth of Pipe = 3'

Equivalent Length of Pipe: 90' Ell = 2' k 5 = 10'

Equivalent tength of pipe Hp = 10 (110/160) = 11

E Hr - H2 + H2 50 + H2 30 - 70 + 51 + 111 = 231


3. Pump Curve Interpretation

0 H_T = 23' Q = 255 GPM .

Q = 255 GPM (1 cf/7.48 gallon) (1 min/60sec) = 0.6 cfs Combined capacity of pumps is approximately 1.2 cfs

Reference: Cameron Hydraulic Data, lith Edition Ingersoll-Rand Company, Woodcliff Lake, NJ 1970, PP-27, 32, 34, and

- 1. Install two HYDRO-O-MATIC submersible pumps, Model SK300. 3 Hp motor, or approved equal. Pump installation shall include three mercury float switches with controls set for "LEAD", "LAG" and "ALTERNATE" modes of operation.
- Refer to Electrical Plans for location of pump control box, installation of electrical cable/conduit and pump/control one-line diagrams.
- 3. Installation of the mercury float switches shall be at levels providing optimum pumping time without excessive pump cycling.
- 4. Manhole shall be constructed as per City of Albuquerque Standard Drawing No. 2102 with flat bottom.

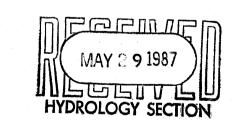




NO. DATE BY REVISIONS DESIGNED BY: L.P.U. 870311 ORAWN BY: S.G.H. 811 DALLAS, N.E. - ALBUQUERQUE NEW MEXICO - 87110 3 · 87 APPROVED J.G.M.


PUMP DETAILS

PINE SPRINGS


SHEET 2 OF 2

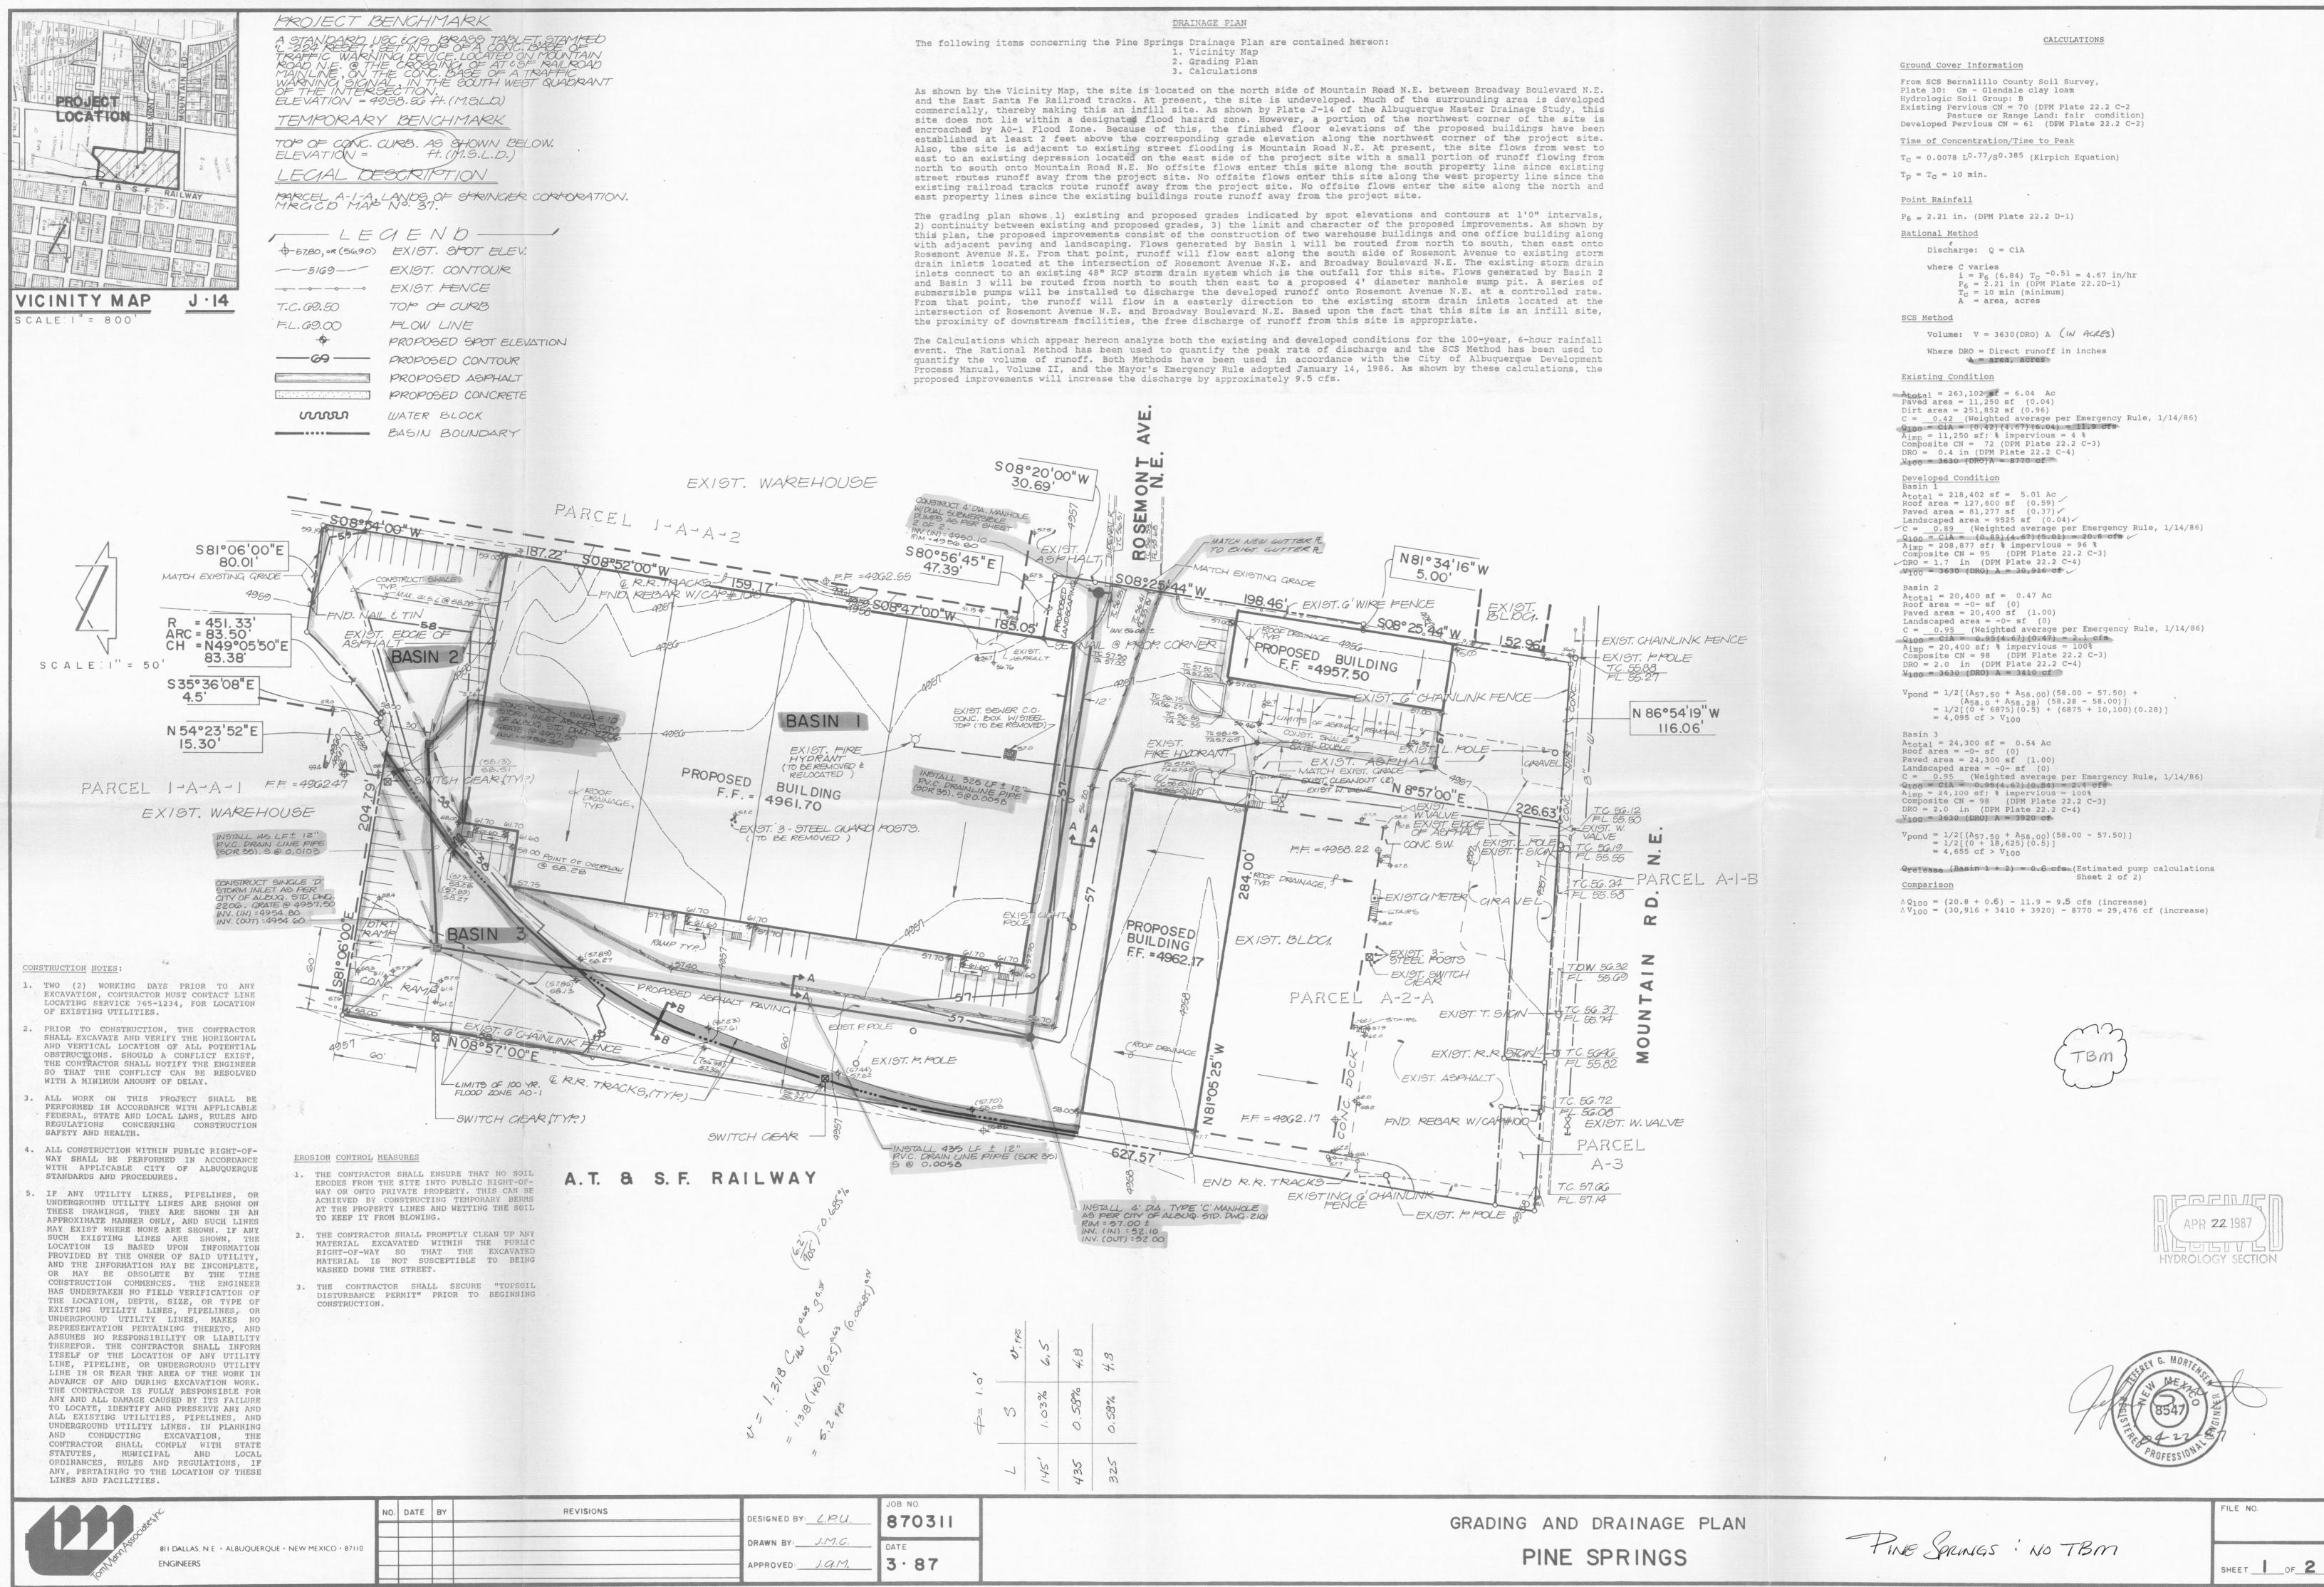

N692

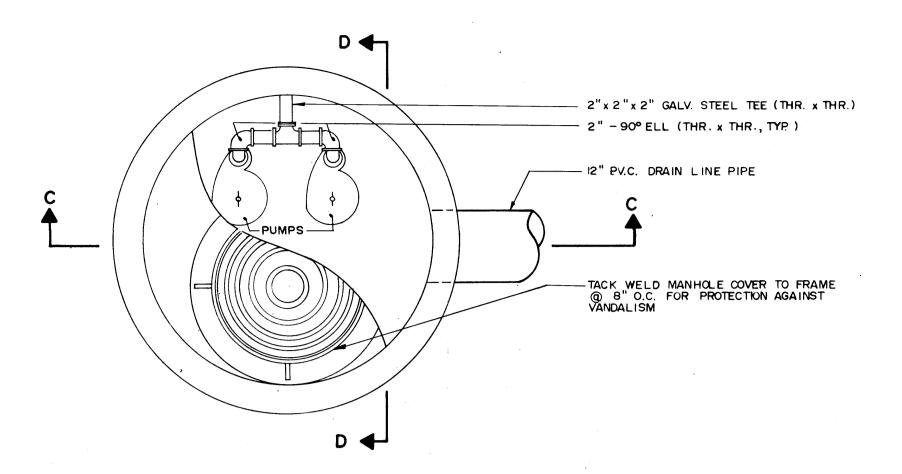

MANHOLE PLAN

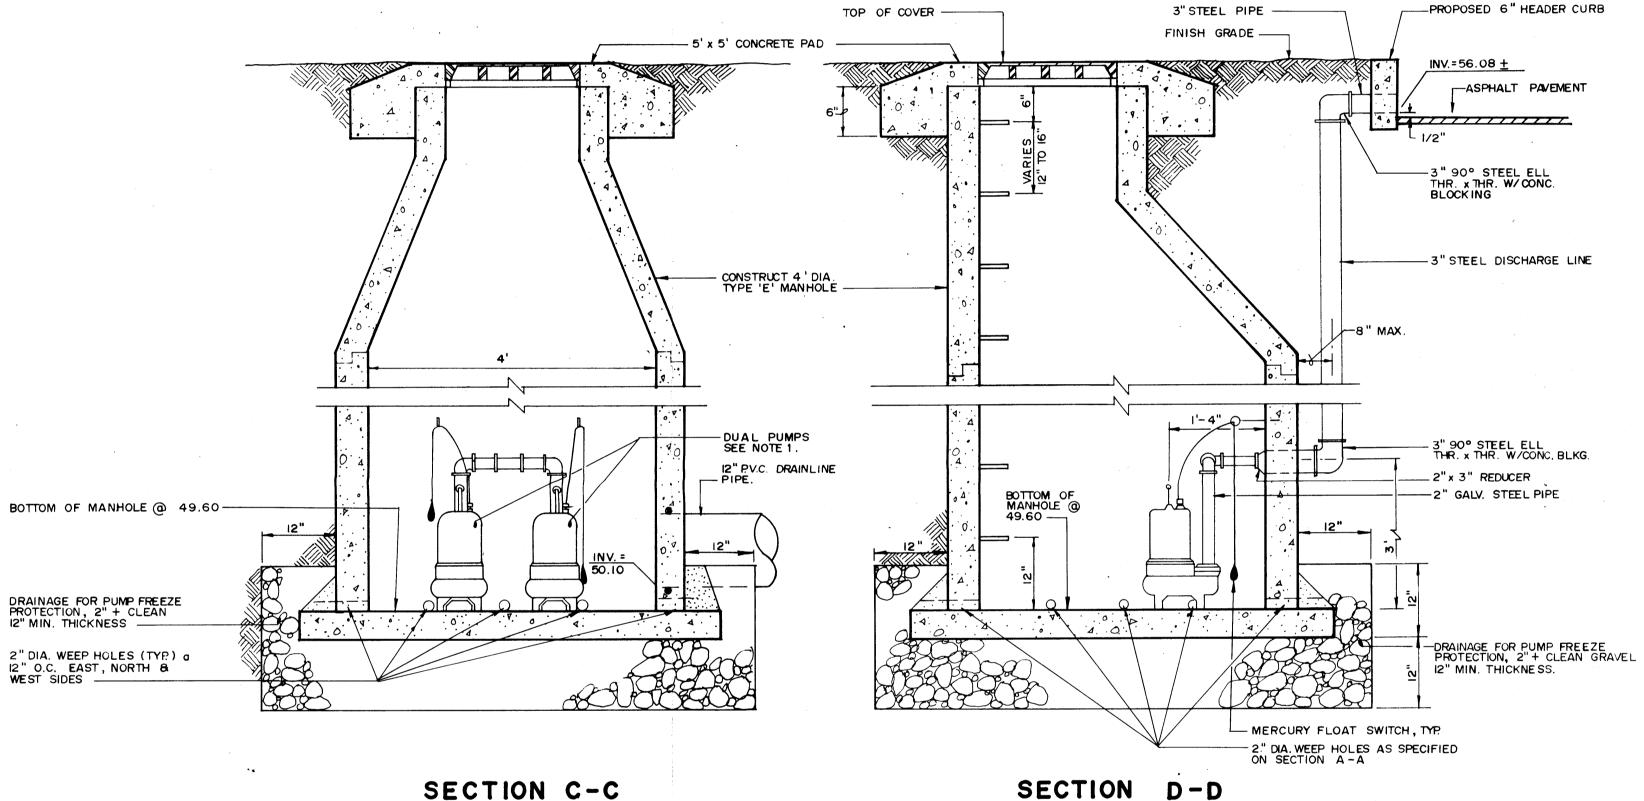


SECTION C-C SCALE: 3/4"=1'-0"

DIMENSIONAL DRAWINGS

HYDROMATIC

SCALE: 3/4" = 1'-0"

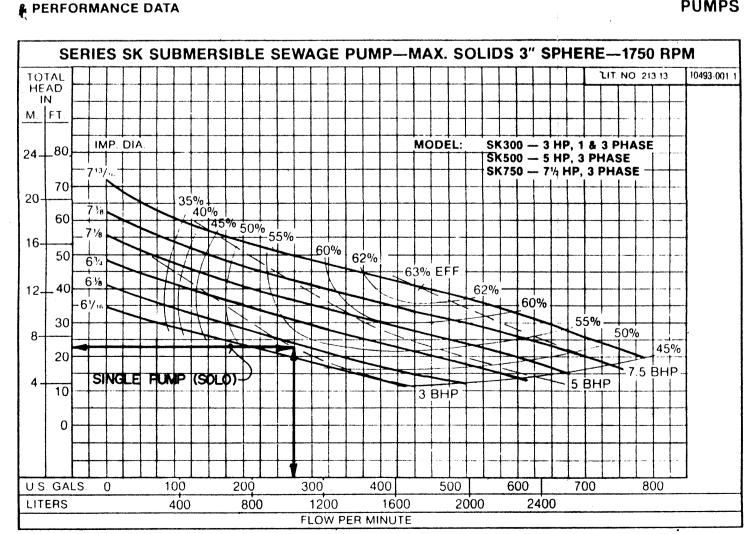

EXISTING RAIL ROAD
TRACK

O'-O" TO 16'-O" ±

PROPOSED ASPHALT PAVEMENT
AS PER ARCHITECTURAL PLANS

HEIGHT VARIES FROM
O'-O" TO 1.07'

6" SUBGRADE COMPACTED
@ 95% A.S.T.M. D-1557.

SECTION B-B

3/4"

ASPHALT PAVEMENT

3/4"

3000 psi CONCRETE

SUBGRADE COMPACTED
95 % A.S.T.M. D-1557

SCALE: 1 /2 " = 1 - 0"

PUMP CALCULATIONS

- Estimated Discharge Rate 200 GPM
 Head Loss
- A. Elevation: 56.23 49.60 = 7'
 B. Friction (3" pipe)
 Type of Pipe: Steel
 Design C Value: 100
 Chart C Value: 100
 No correction Required
 H_F = 21.4 ft/100 ft

Length of Pipe = 6'

Equivalent Length of Pipe: Sudden Enlargement = 2' 90° Ell = 2 x 8' = 16'

Total Equivalent Length of 4" pipe = $486' \pm H_{F2"} = (21.4/100)(22) = 5'$

C. Friction (2" pipe)
Type of Pipe: Steel
Design C Value: 100
Chart C Value: 100
No correction Required
H_F = 110 ft/100 ft

Length of Pipe = 3'

Equivalent Length of Pipe: 90° Ell = 2' x 5 = 10'

Equivalent Length of pipe $H_F = 10 (110/100) = 11'$

D. Total

 $\theta H_T = H_Z + H_{F,3} + H_{F,2} = 7' + 5' + 11' = 23'$

3. Pump Curve Interpretation

 $0 H_{\rm T} = 23' Q = 255 GPM$

Q = 255 GPM (1 cf/7.48 gallon) (1 min/60sec) = 0.6 cfs Combined capacity of pumps is approximately 1.2 cfs

Reference: Cameron Hydraulic Data, 14th Edition Ingersoll-Rand Company, Woodcliff Lake, NJ 1970, PP-27, 32, 34, and 48.

NOTI

- 1. Install two HYDRO-O-MATIC submersible pumps, Model SK300. 3 Hp motor, or approved equal. Pump installation shall include three mercury float switches with controls set for "LEAD", "LAG" and "ALTERNATE" modes of operation.
- Refer to Electrical Plans for location of pump control box, installation of electrical cable/conduit and pump/control one-line diagrams.
- Installation of the mercury float switches shall be at levels providing optimum pumping time without excessive pump cycling.
- 4. Manhole shall be constructed as per City of Albuquerque Standard Drawing No. 2102 with flat bottom.



NO. DATE BY REVISIONS

DESIGNED BY L.P.U. 870311

DRAWN BY: S.G.H.

APPROVED: J.G.M.

DATE

APPROVED: J.G.M.


APPROVED: J.G.M.

PUMP DETAILS

PINE SPRINGS

SHEET 2 OF 2

FILE NO.

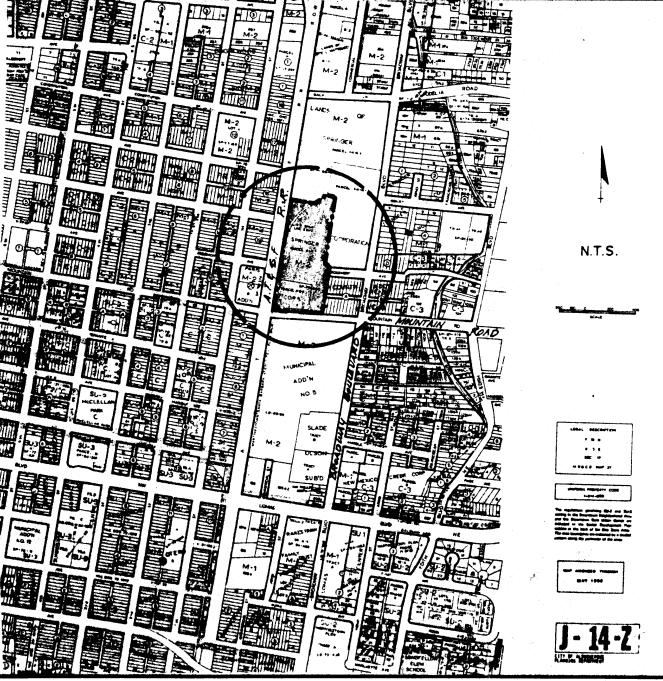

ICINITY MAP

SURDIVISION DATA
Case No. ALA 9/-85
Zone Atlas Index No. 5-14
Gross Subdivision Acreage 2.3/63
Total No. of Lots Created 2
Total Nileage of Full-Width Streets Created
Date of Survey April 199/

<u>DISCLOSURE STATEMENT</u> - The purpose of this plat is to create Two (2) new tracts from Four (4) existing tracts and to dedicate additional road right of way.

NOTES

- 1) All property corners identified as "set" are set with 1/2" rebar/cap stamped "L.S. 6446", unless otherwise noted.
- 2) Basis of bearings per Summary Replat showing Parcels "A-1-A", "A-1-B", & "A-2-A" of LANDS OF SPRINGER CORPORATION filed on January 11, 1980 in Volume C16, folio 47.
- 3) Plat show all easements of record.
- 4) Rotate all bearings clockwise 0° 09'24" to obtain N.M. State Plane Grid, Central Zone.

BERNALILLO COUNTY TREASURER'S OFFICE:

LEGAL DESCRIPTION AND FREE CONSENT

The undersigned owner(s) of the land hereon shown do hereby consent to the Replat of the land shown hereon:

A certain tract of land being and comprising Parcels A-1-A, A-1-B, and A-2-A, as shown and designated on the Summary Replat showing parcels "A-1-A", "A-1-B", and "A-2-A" of LANDS OF SPRINGER CORPORATION within N.R.G.C.D. Map No. 37, as the same is shown and designated on said replat thereof, filed in the office of the County Clerk of Bernalillo County, New Mexico on January 11, 1980 in Volume C16; folio 47, TOGETHER WITH, Parcel A-3, as shown and designated on the Summary Plat showing Parcels "A-1", "A-2", and "A-3" of LANDS OF SPRINGER CORPORATION situate within M.R.G.C.D. Map No. 37, as the same is shown and designated on said plat thereof, filed in the office of the County Clerk of Bernalillo County, New Mexico on September 21, 1977 in Volume D8, Folio 16, and being more particularly described as follows:

Beginning at the Southeast corner of said tract herein described, being the same point as the Southeast corner of said Parcel A-1-A, and also being a point on the original North right of way line of MOUNTAIN ROAD N.E.; thence, from said point of beginning, N. 86° 54'17" W., 401.46 feet along said original North right of way line to the Southwest corner of said tract herein described, being the point intersecting said North right of way line with the East right of way line of the A.T. & S.F Railroad; thence, N. 08° 57'00"E., along said East right of way line, 883.13 feet to the Northwest corner of said tract herein described; thence, leaving said East right of way line, S. 81° 06'00" E., 204.79 feet to an angle point; thence, N. 54° 23'52" E., 15.30 feet to an angle point; thence, 5. 35 36'08" E., 4.50 feet to a point on a curve; thence Northeasterly, along a curve to the left through a central angle of 10° 36'01" having a radius of 451.33 feet and an arc length of 83.50 feet (chord=N. 49° 05'50" E., 83.38') to a point of non-tangency; thence, S. 81° 06'00" E., 80.01 feet to the Northeast corner of said tract herein described; thence 5, 08° 54'00" W., 187.22 feet to an angle point; thence S. 08° 52'00" W., 159.17 feet to an angle point; thence, S. 08° 47'00" W., 185.05 feet to an angle point; thence 8. 80° 56'45" E., 47.39 feet to an angle point; thence, 5. OBP 20'00" W., 30.69 feet to an angle point, being a point on the North right of way line of ROBEMONT AVENUE N.E.; thence, B. OB. 25'44" W., leaving said North right of way line, 198.46 feet to an angle point; thence N. 81* 34'16" W., 5.00 feet to an angle point; thence 8. 00° 25'44" W., 152.76 feet to the Southeast corner of said tract herein described, being the point of beginning and containing an area of 7.6094 acres, more or less (331466.41 square feet, more or less). Legal description prepared by Franklin E. Wilson, N.M.P.S. 6446.

And is with the free consent and in accordance with the desires of the undersigned owner(s) and proprietor(s) thereof, and hereby dedicate additional road right of way as shown hereon.

1St laust by Mayer at, a	sent 4/25/91
Owner(s)	Date
ACKNOWLEDGEMENT	
STATE OF New MEXICO	
COUNTY OF BERNALIUO	
The foregoing instrument was acknown of APRIL , 1901, By: MAX . TSF TRUST, OWNER,	wledged before me this 2574 SMITH, ALENT FOR
My Commission Expires: /- 26-94	Notary Public
King Inc by A) wta Backel Sec	4-30-91
Owner(s)	Date
ACKNOWLEDGEMENT	
STATE OF NEW MEXICO	
COUNTY OF BERNAULO 3 SS.	
The foregoing instrument was acknown	wledged before me this 307
KIMO (A)C A M.M. CAN BAN BYICK! SAN CARD AND AND AND	REALECHI SEABETANIA
My Commission Expires: 1-2 C.OU	Notary Public

A PLAT OF
PARCELS A-1-A-1 AND A-2-A-1
LANDS OF SPRINGER CORPORATION

LYING SITUATE WITHIN SECTION OF SPRINGER

T. 10 N., R. 3 E., N.M.P.M.,
ALBUQUERQUE COUNTY, NEW MEXICO
APRIL 1991

CITY/COUNTY APPROVALS:


Property Management	Date
my cui.	
City Surveyor	Date
City Water Resources	Date
City Engineer	Date
A.M.A.F.C.A.	Date
Traffic Engineer	Date
Parks and Recreation	Date
City Planning Director	Date

SURVEYOR'S CERTIFICATION

I, Franklin E. Wilson, a registered Professional Land
Surveyor under the laws of the State of New Mexico, do
hereby certify that this plantages prepared by me or under
my supervision, meeta the limit requirements of
monumentation and survey of the libequerque Subdivision
Ordinance, and that it is true and correct to the best
of my knowledge and selies the

SOUTHWEST SURVEYING CO., INC.
333 Lomas Blvd., N.E., Albuquerque, New Mexico 87102
(505) 247 4444

SHEET 1 OF 2

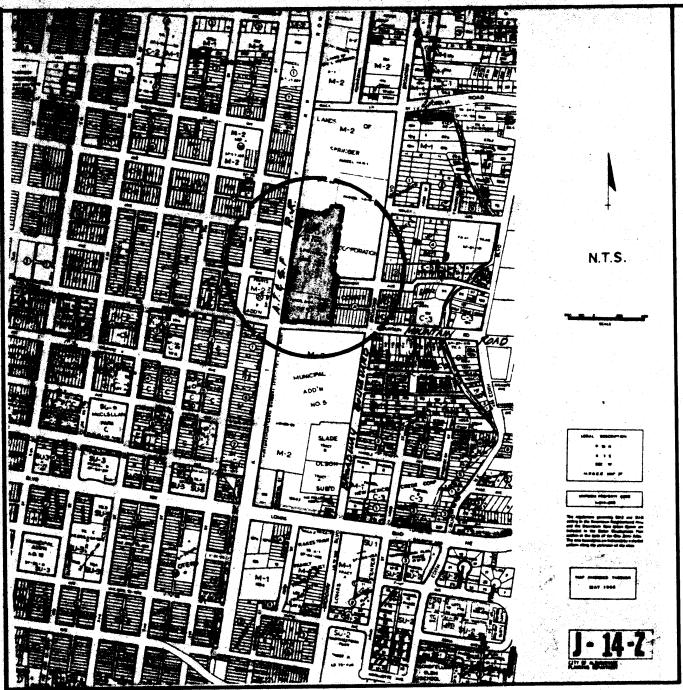

VICINITY MAP

Case No. ALA 9/-85

Some Atlas Index No. 5-14

Gross Subdivision Acreage 7.3/63

Total No. of Lots Created 2

Total Nileage of Pull-Width Streets Created Date of Survey April 199/

<u>DISCLOSURE STATEMENT</u> - The purpose of this plat is to create Two (2) new tracts from Four (4) existing tracts and to dedicate additional road right of way.

NOTES

- 1) All property corners identified as "set" are set with 1/2" rebar/cap stamped "L.S. 6446", unless otherwise noted.
- 2) Basis of bearings per Summary Replat showing Parcels "A-1-A", "A-1-B", & "A-2-A" of LANDS OF SPRINGER CORPORATION filed on January 11, 1980 in Volume C16, folio 47.
- Plat show all easements of record.

 Rotate all bearings clockwise 0° 09'24" to obtain N.M. State
 Plane Grid, Central Zone.

Prior to development, City of Albuquerque Water and Sanitary Sewer Service to A-1-A-1 must be verified and coordinated with the Public Works Department, City of Albuquerque, via a request for a water and sanitary sewer availability statement.

THIS IS TO CERTIFY THAT TAXES ARE CURRENT AND PAID ON UPC#:
PROPERTY OWNER OF RECORD:

BERNALILLO COUNTY TREASURER'S OFFICE:

DRB-91-85

LEGAL DESCRIPTION AND FREE CONSENT

The undersigned owner(s) of the land hereon shown do hereby consent to the Replat of the land shown hereon:

A certain tract of land being and comprising Parcels A-1-A, A-I-B, and A-2-A, as shown and designated on the Summary Replat showing parcels "A-1-A", "A-1-B", and "A-2-A" of LANDS OF SPRINBER CORPORATION within M.R.G.C.D. Map No. 37, as the same is shown and designated on said replat thereof, filed in the office of the County Clerk of Bernalillo County, New Mexico on January 11, 1980 in Volume Cló; folio 47, TOGETHER WITH, Parcel A-3, as shown and designated on the Summary Plat showing Parcels "A-1", "A-2", and "A-3" of LANDS OF SPRINGER CORPORATION situate within M.R.G.C.D. Map No. 37, as the same is shown and designated on said plat thereof, filed in the office of the County Clerk of Bernalillo County, New Mexico on September 21, 1977 in Volume DB, Folio 16, and being more particularly described as follows:

Beginning at the Southeast corner of said tract herein described, being the same point as the Southeast corner of said Parcel A-1-A, and also being a point on the original North right of way line of MOUNTAIN ROAD N.E.; thence, from said point of beginning, N. 86° 54'17" W., 401.46 feet along said original North right of way line to the Southwest corner of said tract herein described, being the point intersecting said North right of way line with the East right of way line of the A.T. & S.F Railroad; thence, N. 08° 57'00"E., along said East right of way line, 883.13 feet to the Northwest corner of said tract herein described; thence, leaving said East right of way line, S. 81° 06'00" E., 204.79 feet to an angle point; thence, N. 54° 23'52" E., 15.30 feet to an angle point; thence, 5. 35° 36'08" E., 4.50 feet to a point on a curve; thence Northeasterly, along a curve to the left through a central angle of 10° 36'01" having a radius of 451.33 feet and an arc length of 83.50 feet (chord=N. 49° 05'50" E., 83.38') to a point of non-tangency; thence, 5. 81° 06'00" E., 80.01 feet to the Northeast corner of said tract herein described; thence 5. 08" 54'00" W., 187.22 feet to an angle point; thence S. 08º 52'00" W., 159.17 feet to an angle point; thence, S. 08º 47'00" W., 185.05 feet to an angle point; thence 8. 80° 56'45" E., 47.39 feet to an angle point; thence, S. 98 20'00" W., 30.69 feet to an angle point, being a point on the North right of way line of ROSEMONT AVENUE N.E.; thence, B. 08. 25'44" W., leaving said North right of way line, 178.46 feet to an angle point; thence N. 81* 34'16" H., 5.00 feet to an angle point; thence 8. 08° 25'44" W., 152.76 feet to the Southeast corner of said tract herein described, being the point of beginning and containing an area of 7.6094 acres, more or less (331466.41 square feet, more or less). Legal description prepared by Franklin E. Wilson, N.M.P.S. 6446.

And is with the free consent and in accordance with the desires of the undersigned owner(s) and proprietor(s) thereof, and hereby dedicate additional road right of way as shown hereon.

TSF Taust by Maxwell ,	Agent 4/25/91 Date
Owner(s)	Date
ACKNOWLEDGEMENT	
STATE OF NEW MEXICO)	
COUNTY OF BERNALILLO	
The foregoing instrument was acl	knowledged before me this 252
day of APRIL , 1991, By: MA. TSF TRUST, OWNER.	SMITH, HEENT FOR
My Commission Expires:/-25-94	Come J. Sawyer.
	Notary Public
Kins Inc by Auta Breliel - Sec	4-30-91
Owner(s)	Date
ACKNOWLEDGEMENT STATE OF NEW MEXICO	
) ss.	
COUNTY OF BERNALUO	
The foregoing instrument was ac	knowledged before me this 30'3
day of APRIL , 1991, By: Viero	R J ROMCHECH! DECKEIRRY OF
Kimo, A.C., A N.M. CORPORATION, FOR AND M. My Commission Expires:	Thereof J. Dawey

A PLAT OF
PARCELS A-1-A-1 AND A-2-A-1
LANDS OF SPRINGER CORPORATION
LYING SITUATE WITHIN SECTION 17,
T. 10 N., R. 3 E., N.M.P.M.,
ALBUQUERQUE COUNTY, NEW MEXICO
APRIL 1991

CITY/COUNTY APPROVALS:

JUL I O 1991

Property Management	Date
west clut.	252071
City Surveyor	Date
City Water Resources	Date
City Engineer	Date
A.M.A.F.C.A.	Date
Traffic Engineer	, Date
Parks and Recreation	Date
City Planning Director	Date

SURVEYOR'S CERTIFICATION	
I, Franklin E. Wilson, a reg	istered Professional Jan
Surveyor under the laws of the	State of New Mexico d
hereby certify that this plantal	as prepared by me or unde
my supervision, meeta	allian requirements o
Ordinance, and that he he for	A Albaquerque Subdivisio
Ordinance, and that is is true of my knowledge and seller 646	and worrect to the bes

Franklin E. Wilson, N.E., S. No. 846

SOUTHWEST SURVEYING CO., INC.

333 Lomas Blvd., N.E., Albuquerque, New Mexico 87102

(505) 247 4444

SHEET 1 OF 2